

DSA Stamp

Architect




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Lincoln Middle School HVAC Replacement Project
Lincoln Middle School
1501 California Avenue
Santa Monica, California 90403

Rev	Date	Issue
1	11.27.19	50% CD's

Date: 11.27.2019
Scale: As Shown
Drawn By: DH, RM
Checked By: RI

Architect / Engineer Stamp

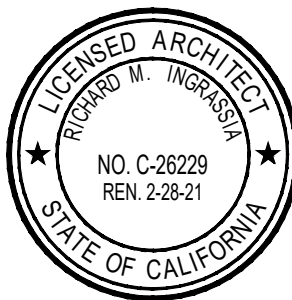

Consultants

Sheet Title

Cover Sheet

Sheet Number

G001



SANTA MONICA - MALIBU UNIFIED SCHOOL DISTRICT

Santa Monica - Malibu Unified School District

Lincoln Middle School HVAC Replacement Project

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1501 California Avenue
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50% Construction Documents
11.27.2019

GENERAL NOTES

1. **VARIANCES BETWEEN ACTUAL CONDITIONS AND DRAWINGS**
- A. THE OWNER OR THE OWNERS DESIGNATED REPRESENTATIVE, AND THE OWNERS CONSULTANTS WILL ASSUME NO RESPONSIBILITY FOR VARIANCES BETWEEN ACTUAL EXISTING CONDITIONS AND CONDITIONS DEPICTED AS EXISTING ON THE DRAWINGS.
- B. THE CONTRACTOR SHALL INSPECT THE SITE AND THE BUILDINGS, AND SHALL VERIFY TO HIS OWN SATISFACTION THE CONDITIONS SHOWN ON THE DRAWINGS, WHICH MATERIALLY AFFECT THE WORK. THE OWNER WILL NOT CONSIDER REQUESTS FROM THE CONTRACTOR FOR ADDITIONAL CHARGES DUE TO SAID MINOR DISCREPANCIES.
- C. THE CONTRACTOR SHALL ASSUME THAT THERE MAY BE MINOR DIFFERENCES BETWEEN ACTUAL FIELD CONDITIONS AND CONDITIONS DEPICTED AS EXISTING ON THE DRAWINGS. THE OWNER WILL NOT CONSIDER REQUESTS FROM THE CONTRACTOR FOR ADDITIONAL CHARGES DUE TO SAID MINOR DISCREPANCIES.
- D. IF THE CONTRACTOR ENCOUNTERS MAJOR DIFFERENCES BETWEEN ACTUAL FIELD CONDITIONS AND CONDITIONS DEPICTED AS EXISTING ON THE DRAWINGS, THE CONTRACTOR SHALL STOP WORK IN THE AFFECTED AREA, AND SHALL IMMEDIATELY NOTIFY THE OWNER OR OWNERS DESIGNATED REPRESENTATIVE OF SAID DIFFERENCES. THE OWNER OR OWNERS DESIGNATED REPRESENTATIVE WILL PROVIDE INSTRUCTIONS FOR PROCEEDING IN THE AFFECTED AREA. THE CONTRACTOR SHALL PROCEED WITH ALL OTHER WORK ITEMS AS REQUIRED BY THE CONTRACT DOCUMENTS.
2. **INTENT OF THE DRAWINGS**
- A. THE CONTRACTOR SHALL VISIT THE SITE AND EXAMINE THE CONDITIONS THEREON, AND THOROUGHLY ACQUAINT HIMSELF WITH OBSTACLES AND ADVANTAGES FOR PERFORMING THE WORK. THE CONTRACTOR SHALL REVIEW THE DRAWINGS AND SPECIFICATIONS, AS THERE ARE REQUIREMENTS SHOWN THEREIN THAT SIGNIFICANTLY AFFECT THE SCOPE OF THE WORK. NO ADDITIONAL CHARGES WILL BE CONSIDERED FOR WORK CAUSED BY THE CONTRACTORS UNFAMILIARITY WITH THE SITE, AND THE DRAWINGS AND SPECIFICATIONS, OR FAILURE OF THE OWNER OR THE OWNERS DESIGNATED REPRESENTATIVE OR OWNERS CONSULTANTS TO ELUCLARATE THE CORRECT SCOPE OF WORK, AS REQUIRED BY THE CONTRACT DOCUMENTS, IN THE SCOPE OF WORK NOTES.
- B. THE INTENT OF THESE DRAWINGS AND SPECIFICATIONS IS THAT THE WORK OF THE ALTERATION, REHABILITATION OR RECONSTRUCTION IS TO BE IN ACCORDANCE WITH TITLE 24, CCR, SHOULD ANY EXISTING CONDITIONS, SUCH AS DETERIORATION OR NON-CONFORMING CONSTRUCTION BE DISCOVERED WHICH IS NOT COVERED BY THE CONTRACT DOCUMENTS WHEREIN THE FINISHED WORK WILL NOT COMPLY WITH TITLE 24, CCR, A CONSTRUCTION CHANGE DOCUMENT (CCD), OR A SEPARATE SET OF PLANS AND SPECIFICATIONS, DETAILING AND SPECIFYING THE REQUIRED WORK SHALL BE SUBMITTED TO AND APPROVED BY DSAS BEFORE PROCEEDING WITH THE WORK. (SECTION 4-317(C), PART 1, TITLE 24, CCR)
3. **GENERIC NAMES**
- THE DRAWINGS IDENTIFY MATERIALS BY GENERIC NAME, UNLESS PREFACED WITH 'BASIS OF DESIGN'. FOR A DESCRIPTION OF APPROVED MATERIALS AND INSTALLATION PROCEDURES SEE THE SPECIFICATIONS.
4. **FINISHES**
- UNLESS OTHERWISE NOTED ON THE DRAWINGS OR IN THE SPECIFICATIONS, THE SELECTION OF COLORS AND TEXTURES FOR FINISH MATERIALS SHALL BE PROVIDED BY THE ARCHITECT PRIOR TO EXECUTION OF THE WORK.
5. **PROJECT COORDINATION**
- SEE THE GENERAL CONDITIONS, THE SUPPLEMENTARY CONDITIONS AND DIVISION 1 OF THE SPECIFICATIONS FOR SPECIFIC REQUIREMENTS RELATED TO PROJECT COORDINATION.
6. **CODES AND REGULATIONS**
- ALL CONSTRUCTION SHALL FULLY COMPLY WITH THE LOCAL BUILDING CODES AND REGULATIONS. ALL WORK SHALL ALSO CONFORM TO TITLE 24, 2016 CALIFORNIA CODE OF REGULATIONS (CCR).
7. **PERMITS**
- A. THE CONTRACTOR SHALL OBTAIN AND PAY FOR ALL PERMITS REQUIRED BY GOVERNING AUTHORITIES FOR THE COMPLETION OF THE WORK. THE FEES, CHARGES OR OTHER COSTS PAID BY THE CONTRACTOR FOR SAID PERMITS WILL BE REIMBURSED TO THE CONTRACTOR BY THE OWNER IN THE AMOUNTS SO PAID.
- B. THE CONTRACTOR SHALL ACQUIRE ALL NOTICES AND LICENSES REQUIRED FOR THE COMPLETION OF THE WORK. THE COST OF THESE NOTICES AND LICENSES IS INCIDENTAL TO OTHER ITEMS OF WORK AND NO ADDITIONAL PAYMENT WILL BE MADE FOR COSTS INCURRED BY OBTAINING NOTICES AND LICENSES OR IN CONFORMING TO THE REQUIREMENTS THEREOF.
- C. TRENCHES OR EXCAVATIONS 5 FEET OR MORE IN DEPTH INTO WHICH A PERSON IS REQUIRED TO DESCEND, REQUIRE A SEPARATE PERMIT FROM THE STATE OF CALIFORNIA, DIVISION OF INDUSTRIAL SAFETY.
- D. PRIOR TO THE ISSUANCE OF A BUILDING PERMIT, THE CONTRACTOR SHALL HAVE EVIDENCE OF CURRENT WORKMANS COMPENSATION INSURANCE COVERAGE.
8. **GENERAL CONDITIONS**
- THE GENERAL CONDITIONS AND ANY SUPPLEMENTAL CONDITIONS WHICH MAY BE ATTACHED OR INCLUDED AS PART OF OWNER - CONTRACTOR AGREEMENT ARE A PART OF THESE CONTRACT DOCUMENTS.

9. **THE SPECIFICATIONS**
- SPECIFICATIONS, WHICH ARE BOUND SEPARATELY, ARE PART OF THE CONTRACT. REFERENCE TO SECTIONS OF THE SPECIFICATIONS IN THE NOTES DESCRIBING THE SCOPE OF WORK ARE INTENDED AS A GUIDE ONLY AND TO ASSIST THE CONTRACTOR IN UNDERSTANDING THE COMPLETE SCOPE OF WORK.
10. **BIDDING**
- ALL CONTRACTORS, SUB OR GENERAL, BIDDING OR CONSTRUCTING ANY PORTION OF THIS PROJECT, SHALL BE HELD TO BE RESPONSIBLE TO REVIEW AND UNDERSTAND ALL OTHER DRAWINGS AND SPECIFICATIONS, WHICH FORM A PART OF THESE CONSTRUCTION DOCUMENTS INCLUDING, BUT NOT LIMITED TO, ARCHITECTURAL, GENERAL NOTES, CIVIL, LANDSCAPE, STRUCTURAL, MECHANICAL, PLUMBING, ELECTRICAL AND EQUIPMENT PLANS AS MAY APPLY TO SAID TRADE BIDDING.
11. **VERIFICATION**
- THE CONTRACTOR SHALL VERIFY ALL SIZES OR PREPARATORY WORK FOR EQUIPMENT OF OTHERS AND SHALL COORDINATE THE WORK ON THIS CONTRACT WITH ALL WORK FURNISHED BY OTHERS.
12. **DISCREPANCIES**
- A. THE CONTRACTOR SHALL VERIFY ALL DIMENSIONS, ELEVATIONS AND ALL EXISTING CONDITIONS AT THE SITE BEFORE COMMENCING WORK, AND REPORT ANY DISCREPANCIES TO THE ARCHITECT PRIOR TO THE START OF WORK.
- B. IF ANY ERRORS OR OMISSION APPEAR IN THE CONTRACT DOCUMENTS, THE CONTRACTOR SHALL NOTIFY THE ARCHITECT IN WRITING OF SUCH ERRORS OR OMISSIONS. IF THE CONTRACTOR FAILS TO GIVE SUCH NOTICE IMMEDIATELY, HE WILL BE HELD RESPONSIBLE FOR THE RESULTS OF SUCH ERRORS OR OMISSIONS AND FOR THE COST OF RECTIFYING SAME.
- C. IN CASE OF DISCREPANCIES BETWEEN ARCHITECTURAL AND CONSULTANT DRAWINGS, THE ARCHITECT WILL DETERMINE THE CORRECT INTENT OF THE WORK.
- D. SHOULD THE DRAWINGS IN THEMSELVES OR WITH THE SPECIFICATIONS OR SHOULD THE SPECIFICATIONS IN THEMSELVES DISAGREE, THE HIGHER QUALITY AND / OR GREATER QUANTITY OF WORK OR MATERIAL SHALL BE ESTIMATED UPON, AND UNLESS OTHERWISE CLARIFIED IN WRITING BY THE ARCHITECT, SHALL BE FURNISH AND INSTALLED.

13. **DESIGN INTENT**
- THE CONTRACTOR SHALL NOT DEVIATE FROM THE DESIGN INTENT AND CONSTRUCTION DETAILS WITHOUT OBTAINING PRIOR APPROVAL FROM THE OWNER AND THE ARCHITECT.
14. **DETAILS**
- DETAILS ARE NOT INTENDED TO SHOW METHOD AND MANNER OF ACCOMPLISHING THE WORK. MINOR MODIFICATIONS MAY BE REQUIRED TO SUIT THE JOB DIMENSIONS OR CONDITIONS AND SHALL BE INCLUDED AS PART OF THE WORK.
15. **DIMENSIONS**
- DIMENSIONS ARE TO FACE OF STUD (FOS), FACE OF CONCRETE (FOC) OR FACE OF MASONRY (FOM) UNLESS NOTED OTHERWISE. DIMENSIONS AS SHOWN TAKE PRECEDENCE OVER ANY CONDITIONS GRAPHICALLY SHOWN ON THE DRAWINGS. DO NOT SCALE THE DRAWINGS. WHEN IN DOUBT, ASK THE ARCHITECT FOR A CLARIFICATION.

16. **DEFINITIONS**
- "TYPICAL" MEANS ALL, EXCEPT AS SPECIFICALLY NOTED. "SIMILAR" MEANS THERE ARE SLIGHT VARIATIONS AMONG CONDITIONS WHERE THE DETAIL OCCURS.
17. **DAMAGE AND THEFT**
- ANY WORK OR MATERIALS OF ONE TRADE DAMAGED BY ANOTHER TRADE BECOMES THE RESPONSIBILITY OF THE OFFENDING TRADE. THE DAMAGED WORK SHALL BE REPAIRED OR REPLACED BY THE ORIGINAL INSTALLER AND THE COSTS BORN E BY THE OFFENDER. ANY MATERIALS STOLEN FROM THE PREMISES OR DAMAGED BEFORE OR AFTER INSTALLATION SHALL BE REPLACED BY CONTRACTOR AT NO ADDITIONAL COST TO THE OWNER. THE CONTRACTOR SHALL TAKE ALL NECESSARY PRECAUTIONS SUCH AS BARRICADES, GUARDS, ETC., AS REQUIRED TO PREVENT DAMAGE AND THEFT. SPECIAL CARE SHALL BE TAKEN TO PROTECT WORK IN PLACE, MATERIALS AND EQUIPMENT STORED, ETC., FROM THEFT AND VANDALISM.

18. **PROTECTION OF EXISTING UTILITIES**
- THE CONTRACTOR SHALL MAINTAIN THE UTILITIES TO THE EXISTING BUILDING OR PROVIDE TEMPORARY SERVICE CONNECTIONS AS REQUIRED.
19. **COORDINATION OF TRADES**
- A. GENERAL CONTRACTOR SHALL BE RESPONSIBLE FOR THE TIMELY ARRIVAL OF ALL SPECIFIED FINISH MATERIALS, EQUIPMENT, LIGHT FIXTURES AND OTHER SUCH MATERIALS) TO BE UTILIZED ON THIS PROJECT. THE GENERAL CONTRACTOR SHALL NOTIFY THE ARCHITECT IN WRITING WITHIN 30 DAYS OF THE DATE OF CONTRACT OF THOSE SPECIFIED ITEMS THAT MAY NOT BE READILY AVAILABLE AND OF EQUAL QUANTITY AND DESCRIPTION. IF NOTIFICATION IS NOT RECEIVED BY THE ARCHITECT, THE

- CONTRACTOR SHALL ACCEPT RESPONSIBILITY FOR THE PROPER ORDERING AND FOLLOW UP ON SPECIFIED ITEMS AND SHALL PURSUE WHATEVER MEANS NECESSARY AT NO ADDITIONAL COST TO THE OWNER, TO INSURE AVAILABILITY OF ALL SPECIFIED ITEMS SO AS NOT TO CREATE A HARSHIP ON THE OWNER AND NOT TO DELAY PROGRESS OF THE WORK. NO EXTENSION OF TIME TO THE CONTRACT WILL BE ALLOWED FOR THE CONTRACTORS INABILITY TO SECURE SPECIFIED ITEMS.
- B. CONTRACTOR SHALL PROVIDE AND LOCATE ACCESS PLANS AS REQUIRED AFTER INSTALLATION OF MECHANICAL DUCTS, PLUMBING AND ELECTRICAL WORK. COORDINATE WITH ARCHITECT. CONTRACTOR SHALL PROVIDE A LAYOUT OF ALL ACCESS PANELS TO THE OWNER, OWNERS REPRESENTATIVE AND ARCHITECT FOR REVIEW AND APPROVAL PRIOR TO INSTALLATION OF EQUIPMENT REQUIRING SAID ACCESS PANELS.
- C. WHERE FACTORY FINISHED OR FACTORY PRIMED ITEMS OCCUR, SUCH AS GRILLS, DIFFUSERS, METAL TRIM AND ACCESSORIES, ETC., THEY SHALL BE PAINTED TO MATCH THE ADJACENT SURFACE AS DIRECTED BY THE ARCHITECT.
- D. CONTRACTOR SHALL COORDINATE THE WORK AMONG ALL TRADES RELATING TO THE MOUNTING AND ATTACHMENTS OF ALL EQUIPMENT AS REQUIRED.
- E. CONTRACTOR SHALL PROVIDE AND COORDINATE THE EXACT DIMENSIONS, SIZES AND POSITIONS OF OPENINGS IN SLABS AND WALLS NECESSARY FOR THE INSTALLATION OF THE WORK.
- F. CONTRACTOR SHALL PROVIDE MOUNTING PLATES AS REQUIRED BEHIND ALL WALL-MOUNTED ITEMS SUCH AS HANDRAILS, RESTROOM PARTITIONS, RESTROOM ROOM ACCESSORIES, LIGHT FIXTURES, ETC..

20. **DUST CONTROL AND INTERIOR BARRICADES**
- CONTRACTOR SHALL MAINTAIN CONTINUOUS DUST ABATEMENT PROCEDURES INCLUDING VACUUMING, TRASH REMOVAL AND MATS AT ALL ENTRIES TO THE CONSTRUCTION AREA. PROVIDE EFFECTIVE DUST CONTROL BY MEANS OF FREQUENT SPRINKLING AND WATERING. EXCESSIVE BLOWING OF DUST OR CONCRETE MAY BE PUMPED. THE JOB SITE SHALL BE LEFT CLEAN AND ORDERLY AT THE END OF EACH DAY.
21. **CLEANUP**
- CONTRACTOR SHALL AT ALL TIMES KEEP THE SITE CLEAN AND FREE OF ALL WASTE MATERIAL OR RUBBISH CAUSED BY HIS OPERATIONS. AT THE COMPLETION OF THE WORK, THE CONTRACTOR SHALL REMOVE ALL WASTE MATERIALS AND RUBBISH FROM AND ABOUT THE PROJECT AS WELL AS ALL TOOLS, CONSTRUCTION EQUIPMENT, MACHINERY AND SURPLUS MATERIALS.
22. CHANGES TO THE APPROVED DRAWINGS AND SPECIFICATIONS SHALL BE MADE BY AN ADDENDUM OR CONSTRUCTION CHANGE DOCUMENT (CCD) APPROVED BY DSA, AS REQUIRED BY SECTION 4-338, PART 1, TITLE 24, CCR. SEE DSA IR 46
23. A PROJECT INSPECTOR EMPLOYED BY THE DISTRICT (OWNER) AND APPROVED BY THE DIVISION OF THE STATE ARCHITECT SHALL HAVE CLASS 3 CERTIFICATION AND PROVIDE CONTINUOUS INSPECTION OF WORK. THE DUTIES OF THE INSPECTOR ARE DEFINED IN SECTION 4-342, PART 1, TITLE 24, CCR.
24. NEW WORK SHALL CONFORM TO THE REQUIREMENTS OF THE EXISTING CONSTRUCTION TYPE.
25. NOT USED
26. DRINKING WATER WELL SHALL COMPLY WITH ALL LOCAL HEALTH DEPARTMENT REQUIREMENTS.
27. AN INSPECTOR WHO IS SPECIALLY QUALIFIED IN CONCRETE WORK WILL BE REQUIRED FOR THIS PROJECT.
28. DO NOT ALTER OR REMOVE ANY EXISTING SHEAR WALLS OR BEARING WALLS UNLESS SO IDENTIFIED ON THE DRAWINGS AND APPROPRIATE DETAILS ARE PROVIDED AND APPROVED BY D.S.A.
29. GRADING PLANS, DRAINAGE IMPROVEMENTS, ROAD AND ACCESS REQUIREMENTS AND ENVIRONMENTAL HEALTH CONSIDERATIONS SHALL COMPLY WITH ALL LOCAL ORDINANCES.
30. FOR FIRE SAFETY DURING DEMOLITION AND CONSTRUCTION COMPLY WITH CFC CHAPTER 14
31. ALL WORK SHALL CONFORM TO 2016 EDITION, TITLE 24, CALIFORNIA CODE OF REGULATIONS (CCR)
32. A DSA ACCEPTED TESTING LABORATORY DIRECTLY EMPLOYED BY THE SCHOOL BOARD SHALL CONDUCT ALL THE REQUIRED TESTS AND INSPECTIONS FOR THE PROJECT.
33. SHOULD ANY EXISTING CONDITIONS SUCH AS DETERIORATION OF NON-COMPLYING CONSTRUCTION BE DISCOVERED WHICH IS NOT COVERED BY THE DSA APPROVED DOCUMENTS WHEREIN THE FINISHED WORK WILL NOT COMPLY WITH TITLE 24, CALIFORNIA CODE OF REGULATIONS, AND SPECIFICATIONS, DETAILING AND SPECIFYING THE REQUIRED REPAIR WORK SHALL BE SUBMITTED TO AND APPROVED BY DSA BEFORE PROCEEDING WITH THE REPAIR WORK.

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Lincoln Middle School HVAC Replacement Project
Lincoln Middle School
1501 California Avenue
Santa Monica, California 90403

Rev	Date	Issue
1	11.27.19	50% CD's

Date: 11.27.2019
Scale: As Shown
Drawn By: DH, RM
Checked By: RL

Architect / Engineer Stamp



Consultants

Sheet Title
Code Analysis
Site Plan

Sheet Number


G201

WASHINGTON AVENUE

14TH STREET

16TH STREET

CALIFORNIA AVENUE

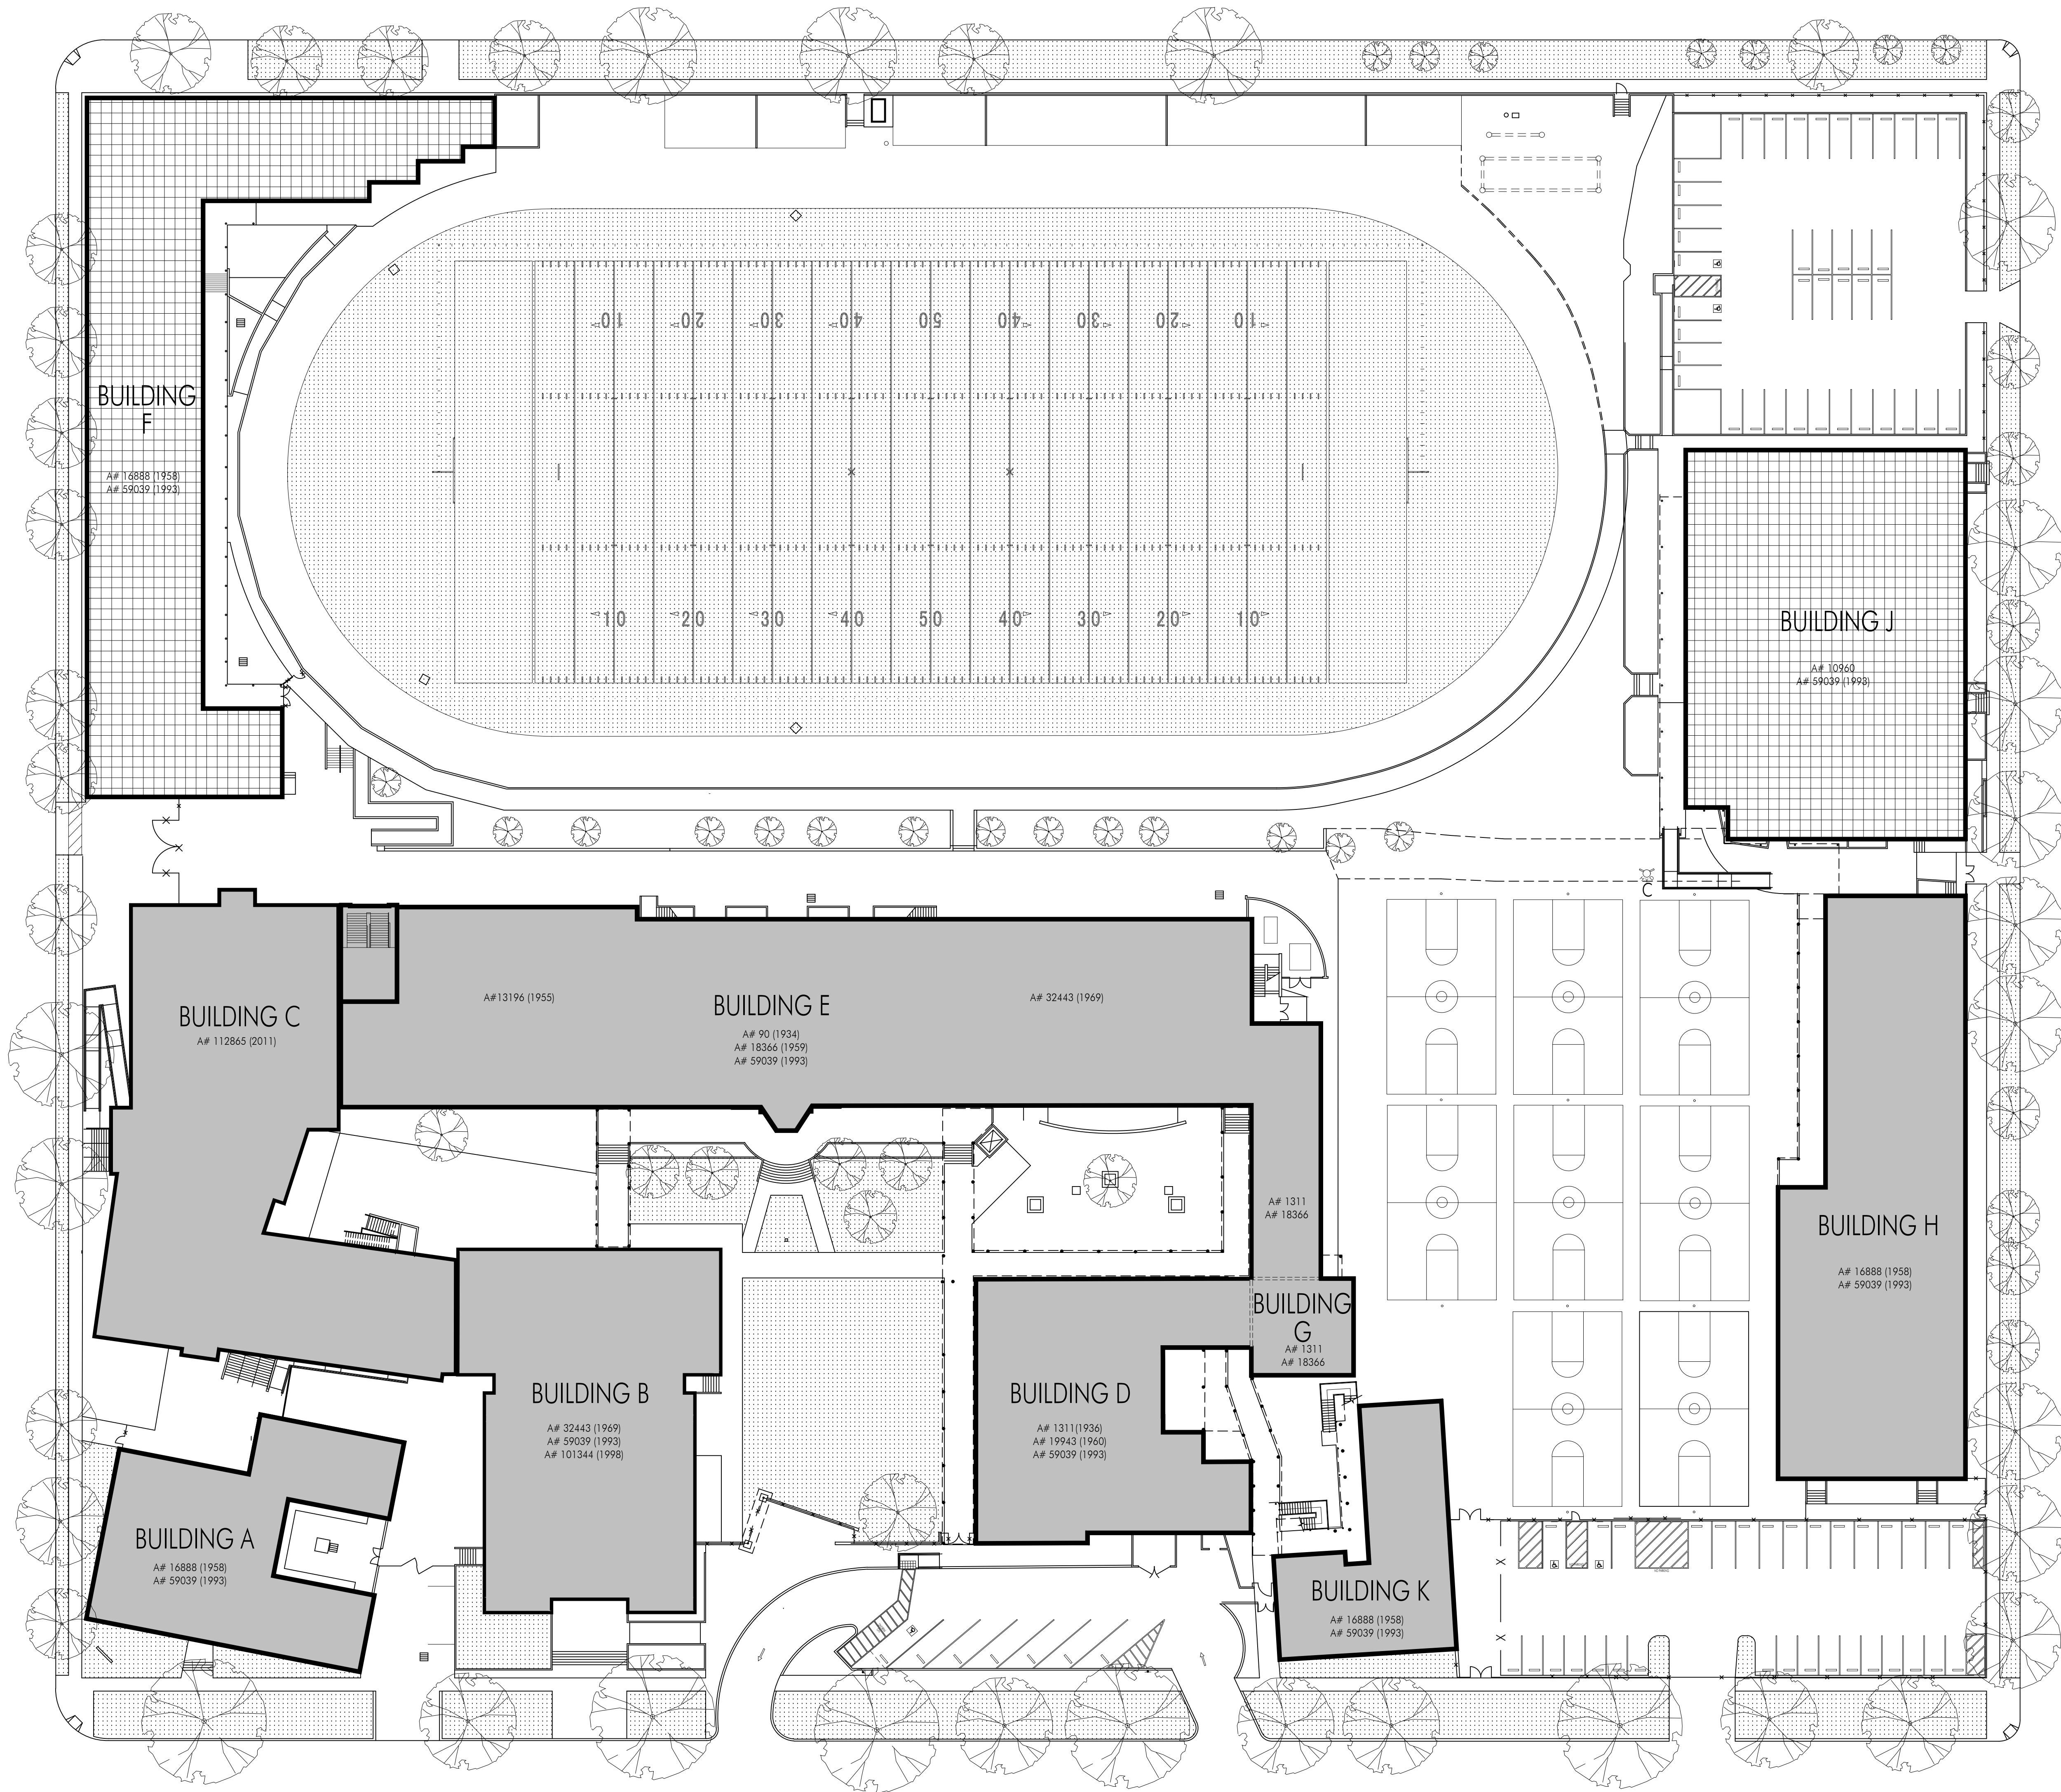

CODE ANALYSIS

Building	Name	Occupancy	Construction Type	Sprinklered	DSA Application # (Original, Most Recent)
A					16888, 59039
B					32443, 101344
C					112865
D	Cafeteria	A-3	VA	NO	1311, 59039
E					90, 59039
F					16888, 59039
G	Classroom	E	VA	NO	1311, 18366
H					1688, 59039
K	Classroom	E	VA	NO	1688, 59039
CHILD DEVELOPMENT CENTER (CDC)					24259

NOTE: THIS IS ONLY A REFERENCE TO THE EXISTING CONDITION, VERIFIED BY THE ARCHITECT. THIS IS NOT A JUSTIFICATION OF IT PRE CBC 2016. IT IS NOT REVIEWED FOR IT.

SCALE: 1" = 30'-0"



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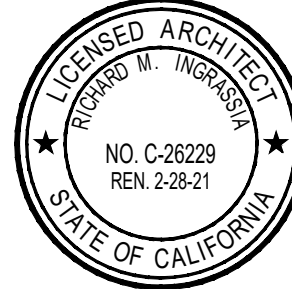
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Sheet Title

Overall Site Plan

Sheet Number


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WASHINGTON AVENUE


14TH STREET

16TH STREET


CALIFORNIA AVENUE

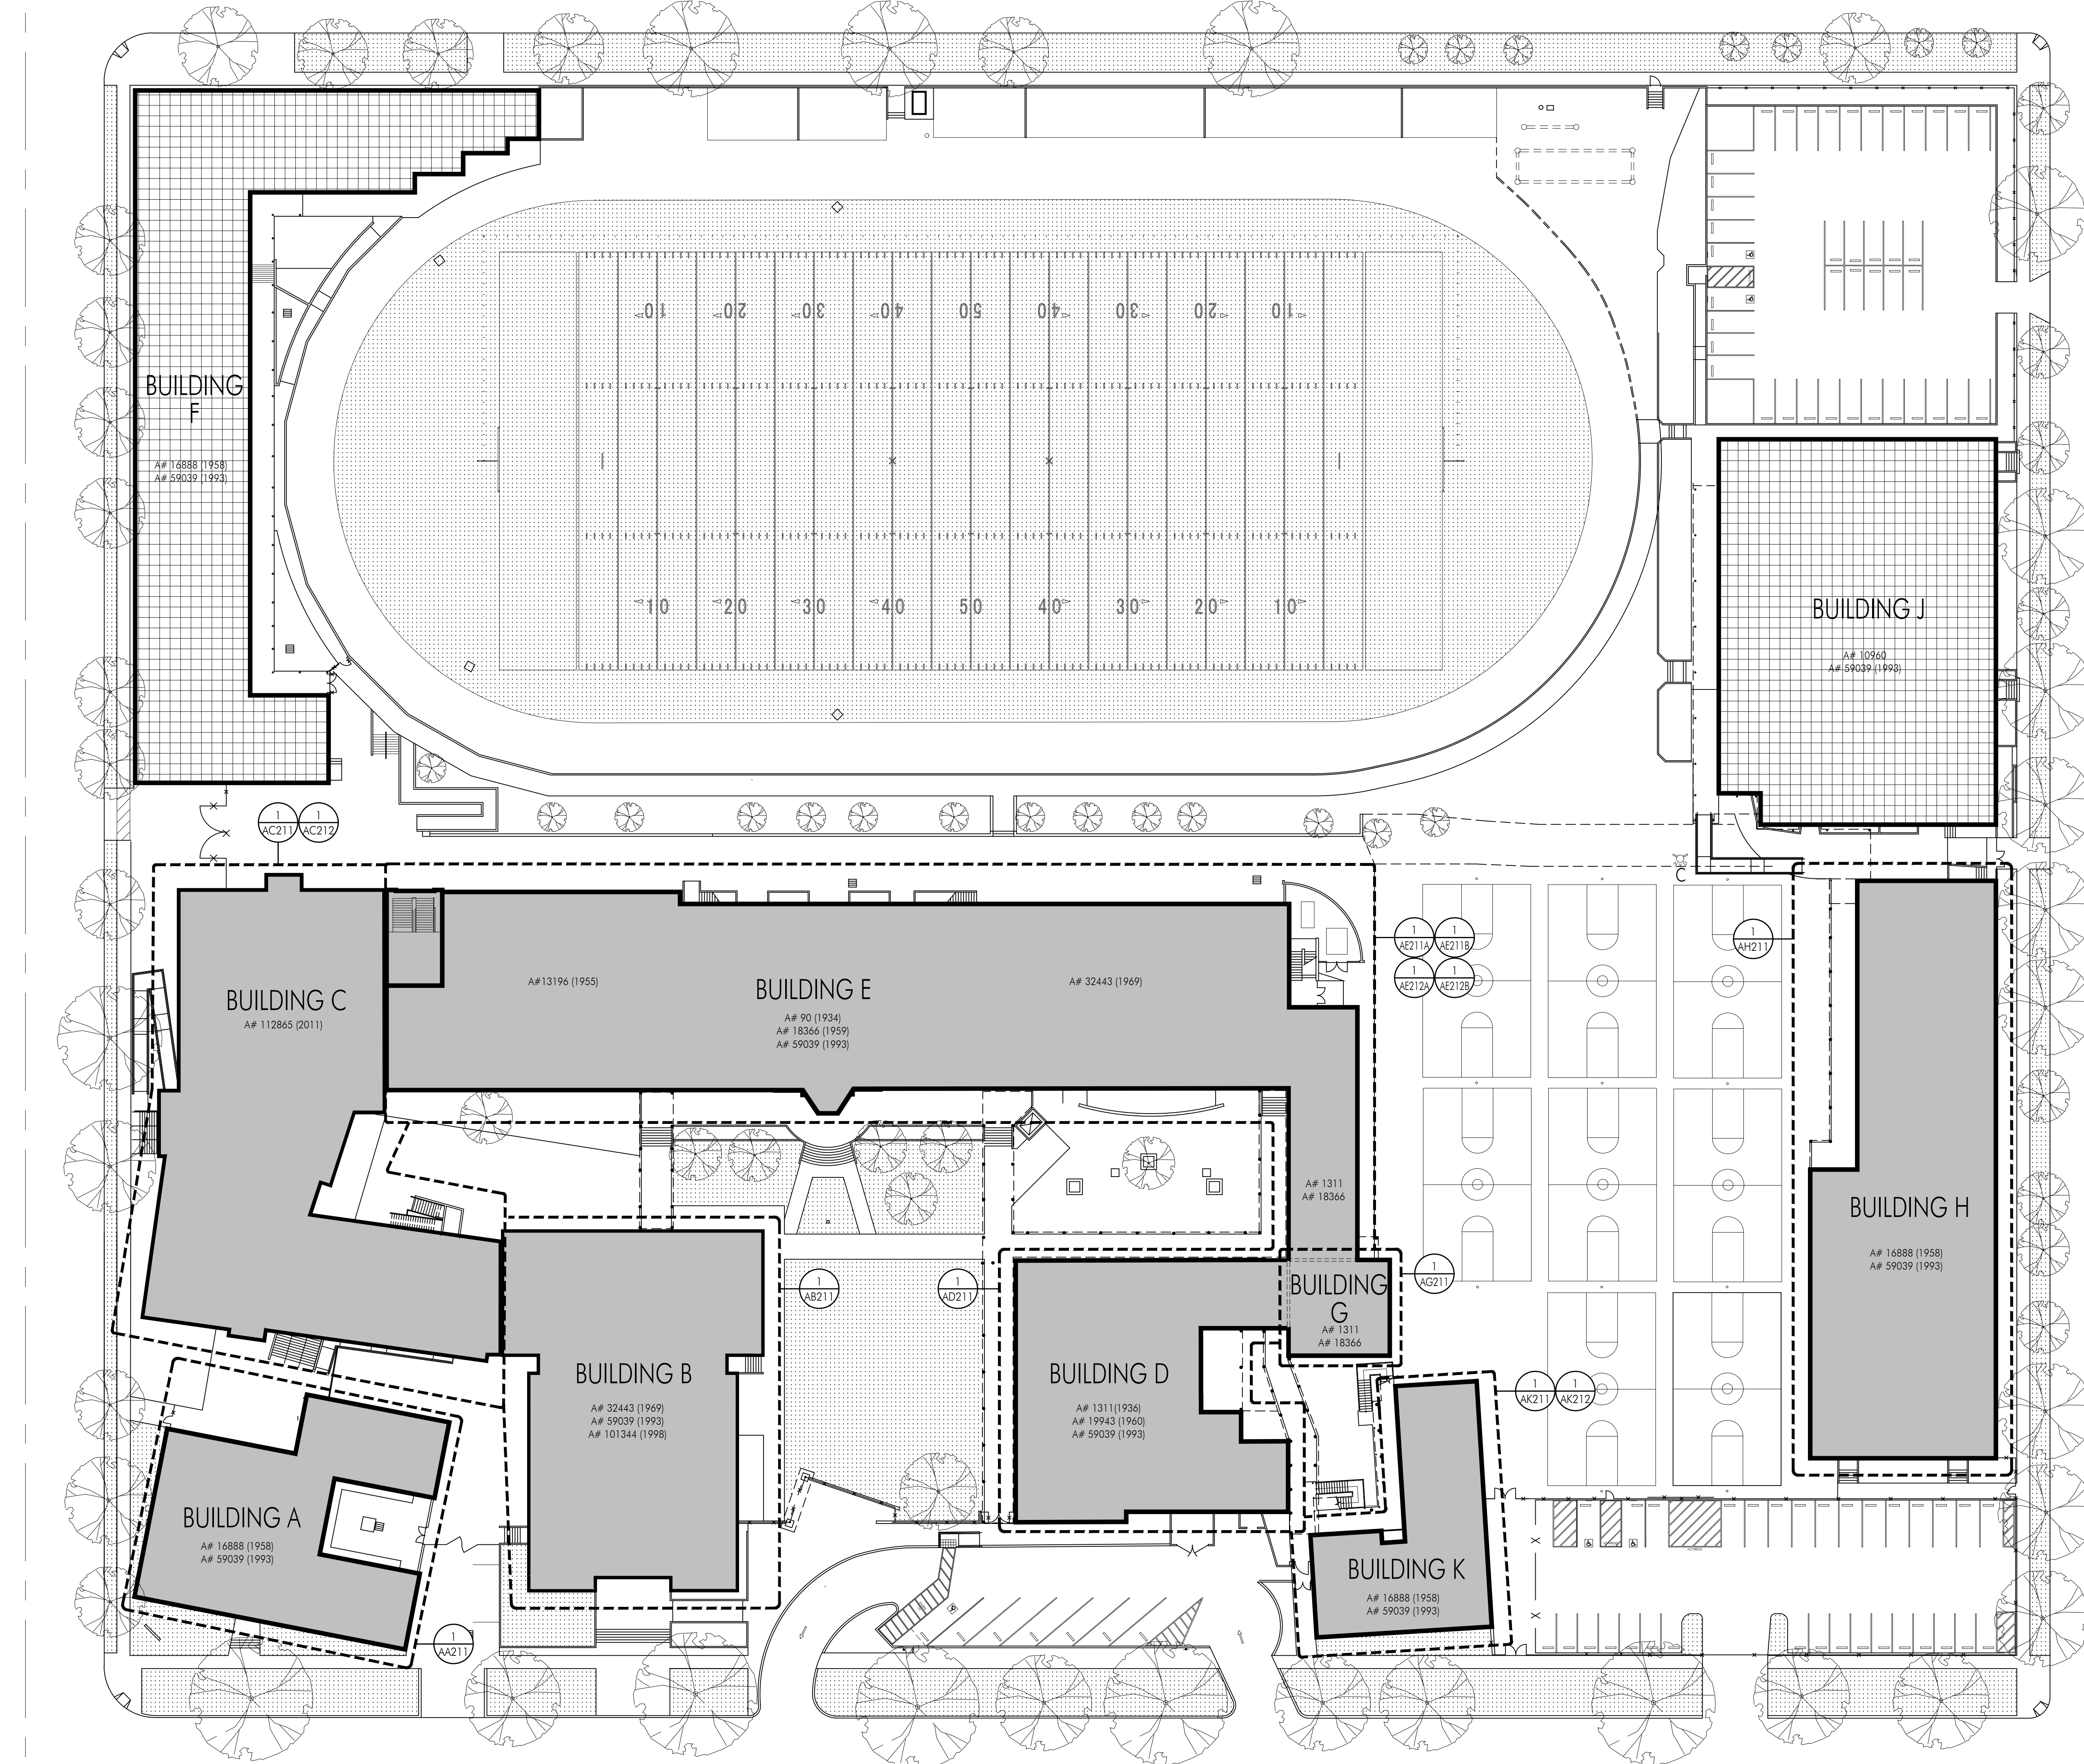

Plot Date: 11/27/2019 12:14:01 PM User: Rudy Monica G:\Projects\School District\Santa Monica MLUSD\SMMLUSD - LVS HVAC\SMMLUSD LVS Drawings\01 Architectural\SMMLUSD-LVS-A4201.dwg Login: Rudy Monica Last Save By: dhamilton Last Save: 11/27/2019 12:14:01 PM

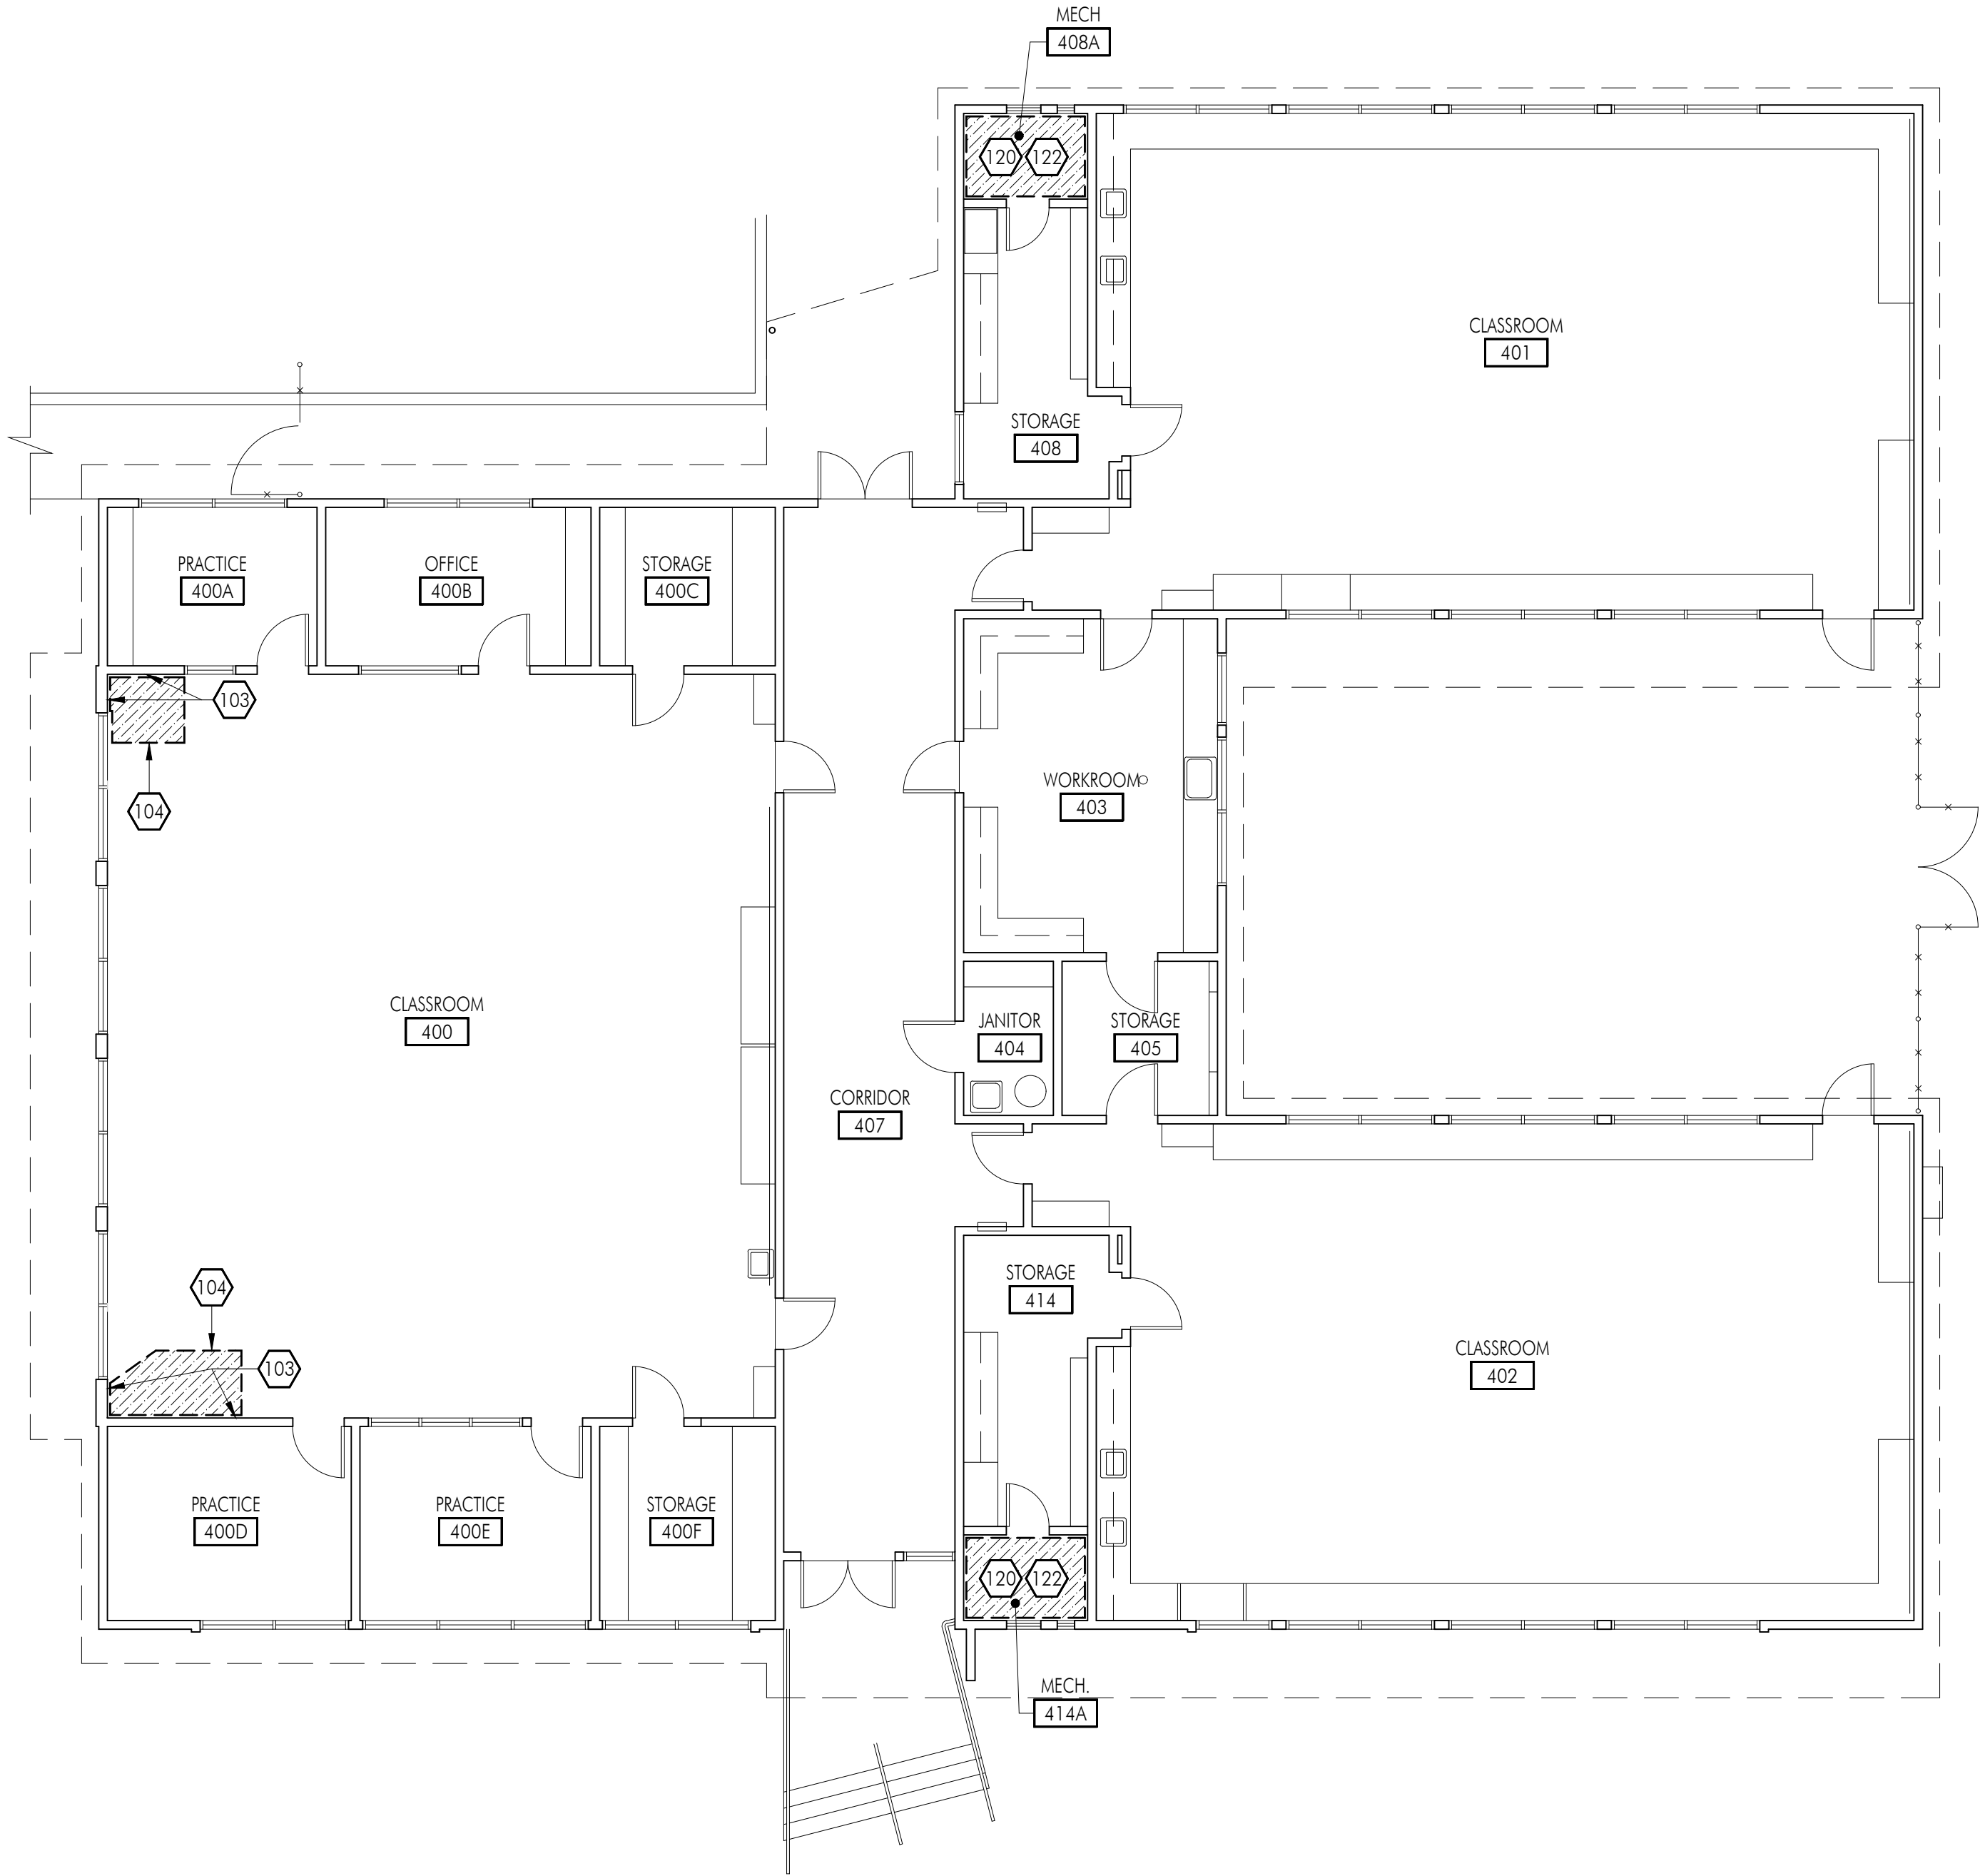

SCALE: 1/8"=1'-0"

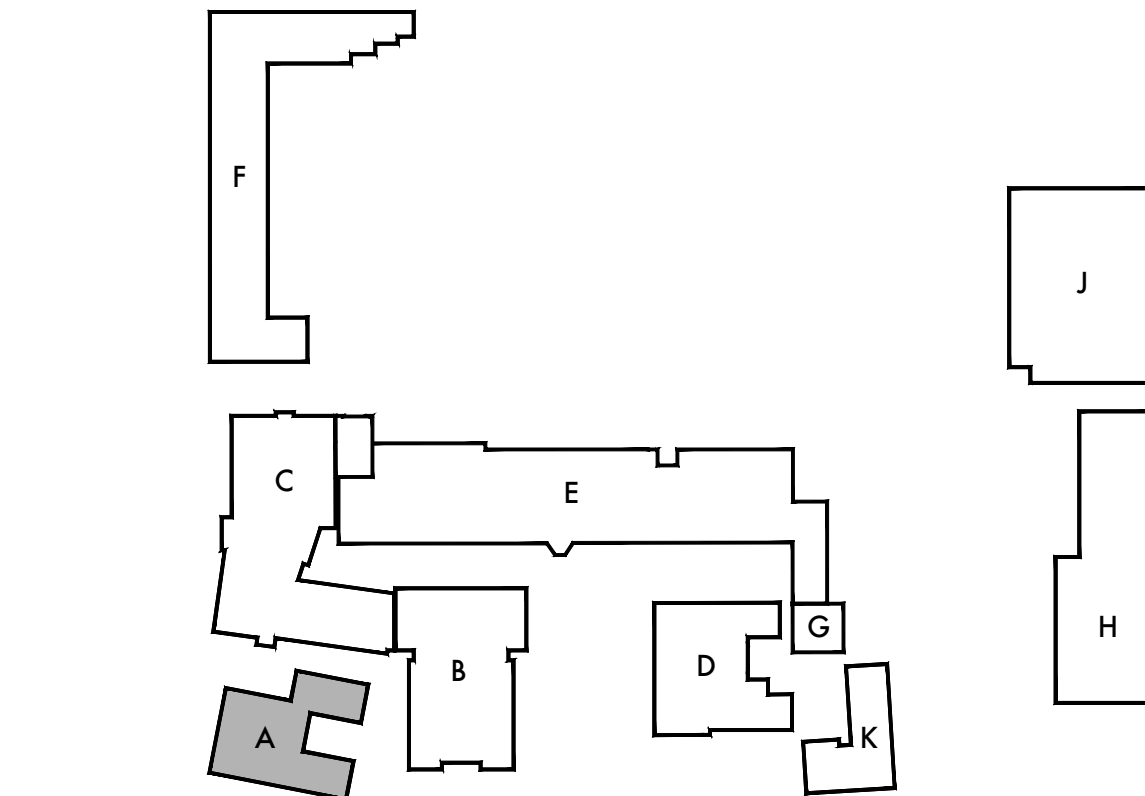

KEY PLAN

DEMOLITION FLOOR PLAN LEGEND

SYMBOL	DESCRIPTION
	(E) STUD WALL OR PARTITION TO REMAIN.
	(E) STUD WALL OR PARTITION TO BE REMOVED.
	(E) DOOR TO REMAIN. SAND, CLEAN AND PATCH DOOR IN PREPARATION FOR NEW FINISHES.
	REMOVE EXISTING DOOR AND APPURTENANCES. PROTECT EXISTING FRAME IN PLACE U.N.O. CLEAN AND PATCH FRAME IN PREPARATION FOR NEW FINISHES AND DOOR HARDWARE.

DEMOLITION KEYNOTES

NO.	DESCRIPTION
103	REMOVE EXISTING INTERIOR WALL FINISHES (INCLUDING BUT NOT LIMITED TO [SINGULARLY OR IN ANY COMBINATION] PLASTER, GYPSUM BOARD, ACOUSTIC TILE, TACKABLE SURFACE ETC.) DOWN TO STUDS (OR STRUCTURE AS OCCURS) IN PREPARATION FOR INSTALLATION OF NEW WALL FINISHES. PROTECT ADJACENT UNAFFECTED FINISHES, PATCH AND REPAIR AT REMOVAL AND PREPARE ADJACENT SURFACES FOR NEW WORK.
104	REMOVE PORTION OF EXISTING FLOOR AS REQUIRED FOR INSTALLATION OF NEW MECHANICAL CLOSET FRAMING AND EQUIPMENT. PATCH AND REPAIR AT REMOVAL AND PREPARE ADJACENT SURFACES FOR NEW WORK.
120	REMOVE EXISTING MECHANICAL EQUIPMENT AND APPURTENANCES. SEE MECHANICAL, ELECTRICAL AND PLUMBING DRAWINGS FOR ADDITIONAL INFORMATION.
122	PROTECT EXISTING DUCT IN PLACE TO BE REUSED. SEE MECHANICAL FOR ADDITIONAL INFORMATION.

FLOOR PLAN GENERAL NOTES

- REMOVE EXISTING GYPSUM BOARD, TILE AND BACKER BOARD OR PLASTER TO ACCOMMODATE REMOVAL AND REPLACEMENT OF PIPING, ELECTRICAL AND FOR THE INSTALLATION OF SUPPORT BLOCKING AND MECHANICAL EQUIPMENT. PATCH BACK TO MATCH ADJACENT SURFACE.
- REFER TO MECHANICAL, PLUMBING, ELECTRICAL AND FIRE ALARM DRAWINGS FOR ADDITIONAL SCOPE OF WORK IN EACH ROOM.
- ALL WALLS SHALL BE FULL HEIGHT TO THE ROOF DECK UNLESS NOTED OTHERWISE, AND SHALL BE CLOSED AND SEALED PER WALL TYPE AND AS DETAILED ON A711.
- UNSCHEDULED CUTTING, REMOVING OR TRIMMING OF EXISTING CONCRETE, MASONRY OR WOOD FRAMED WALLS IS NOT PERMITTED, UNLESS NOTED OTHERWISE ALL DOORS SHALL BE FITTED WITHIN EXISTING WALL OPENINGS WITHOUT ENLARGING OR TRIMMING HEAD OR JAMBS.

APPL. No. A 00-123456

DSA Stamp

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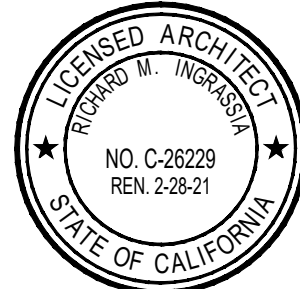


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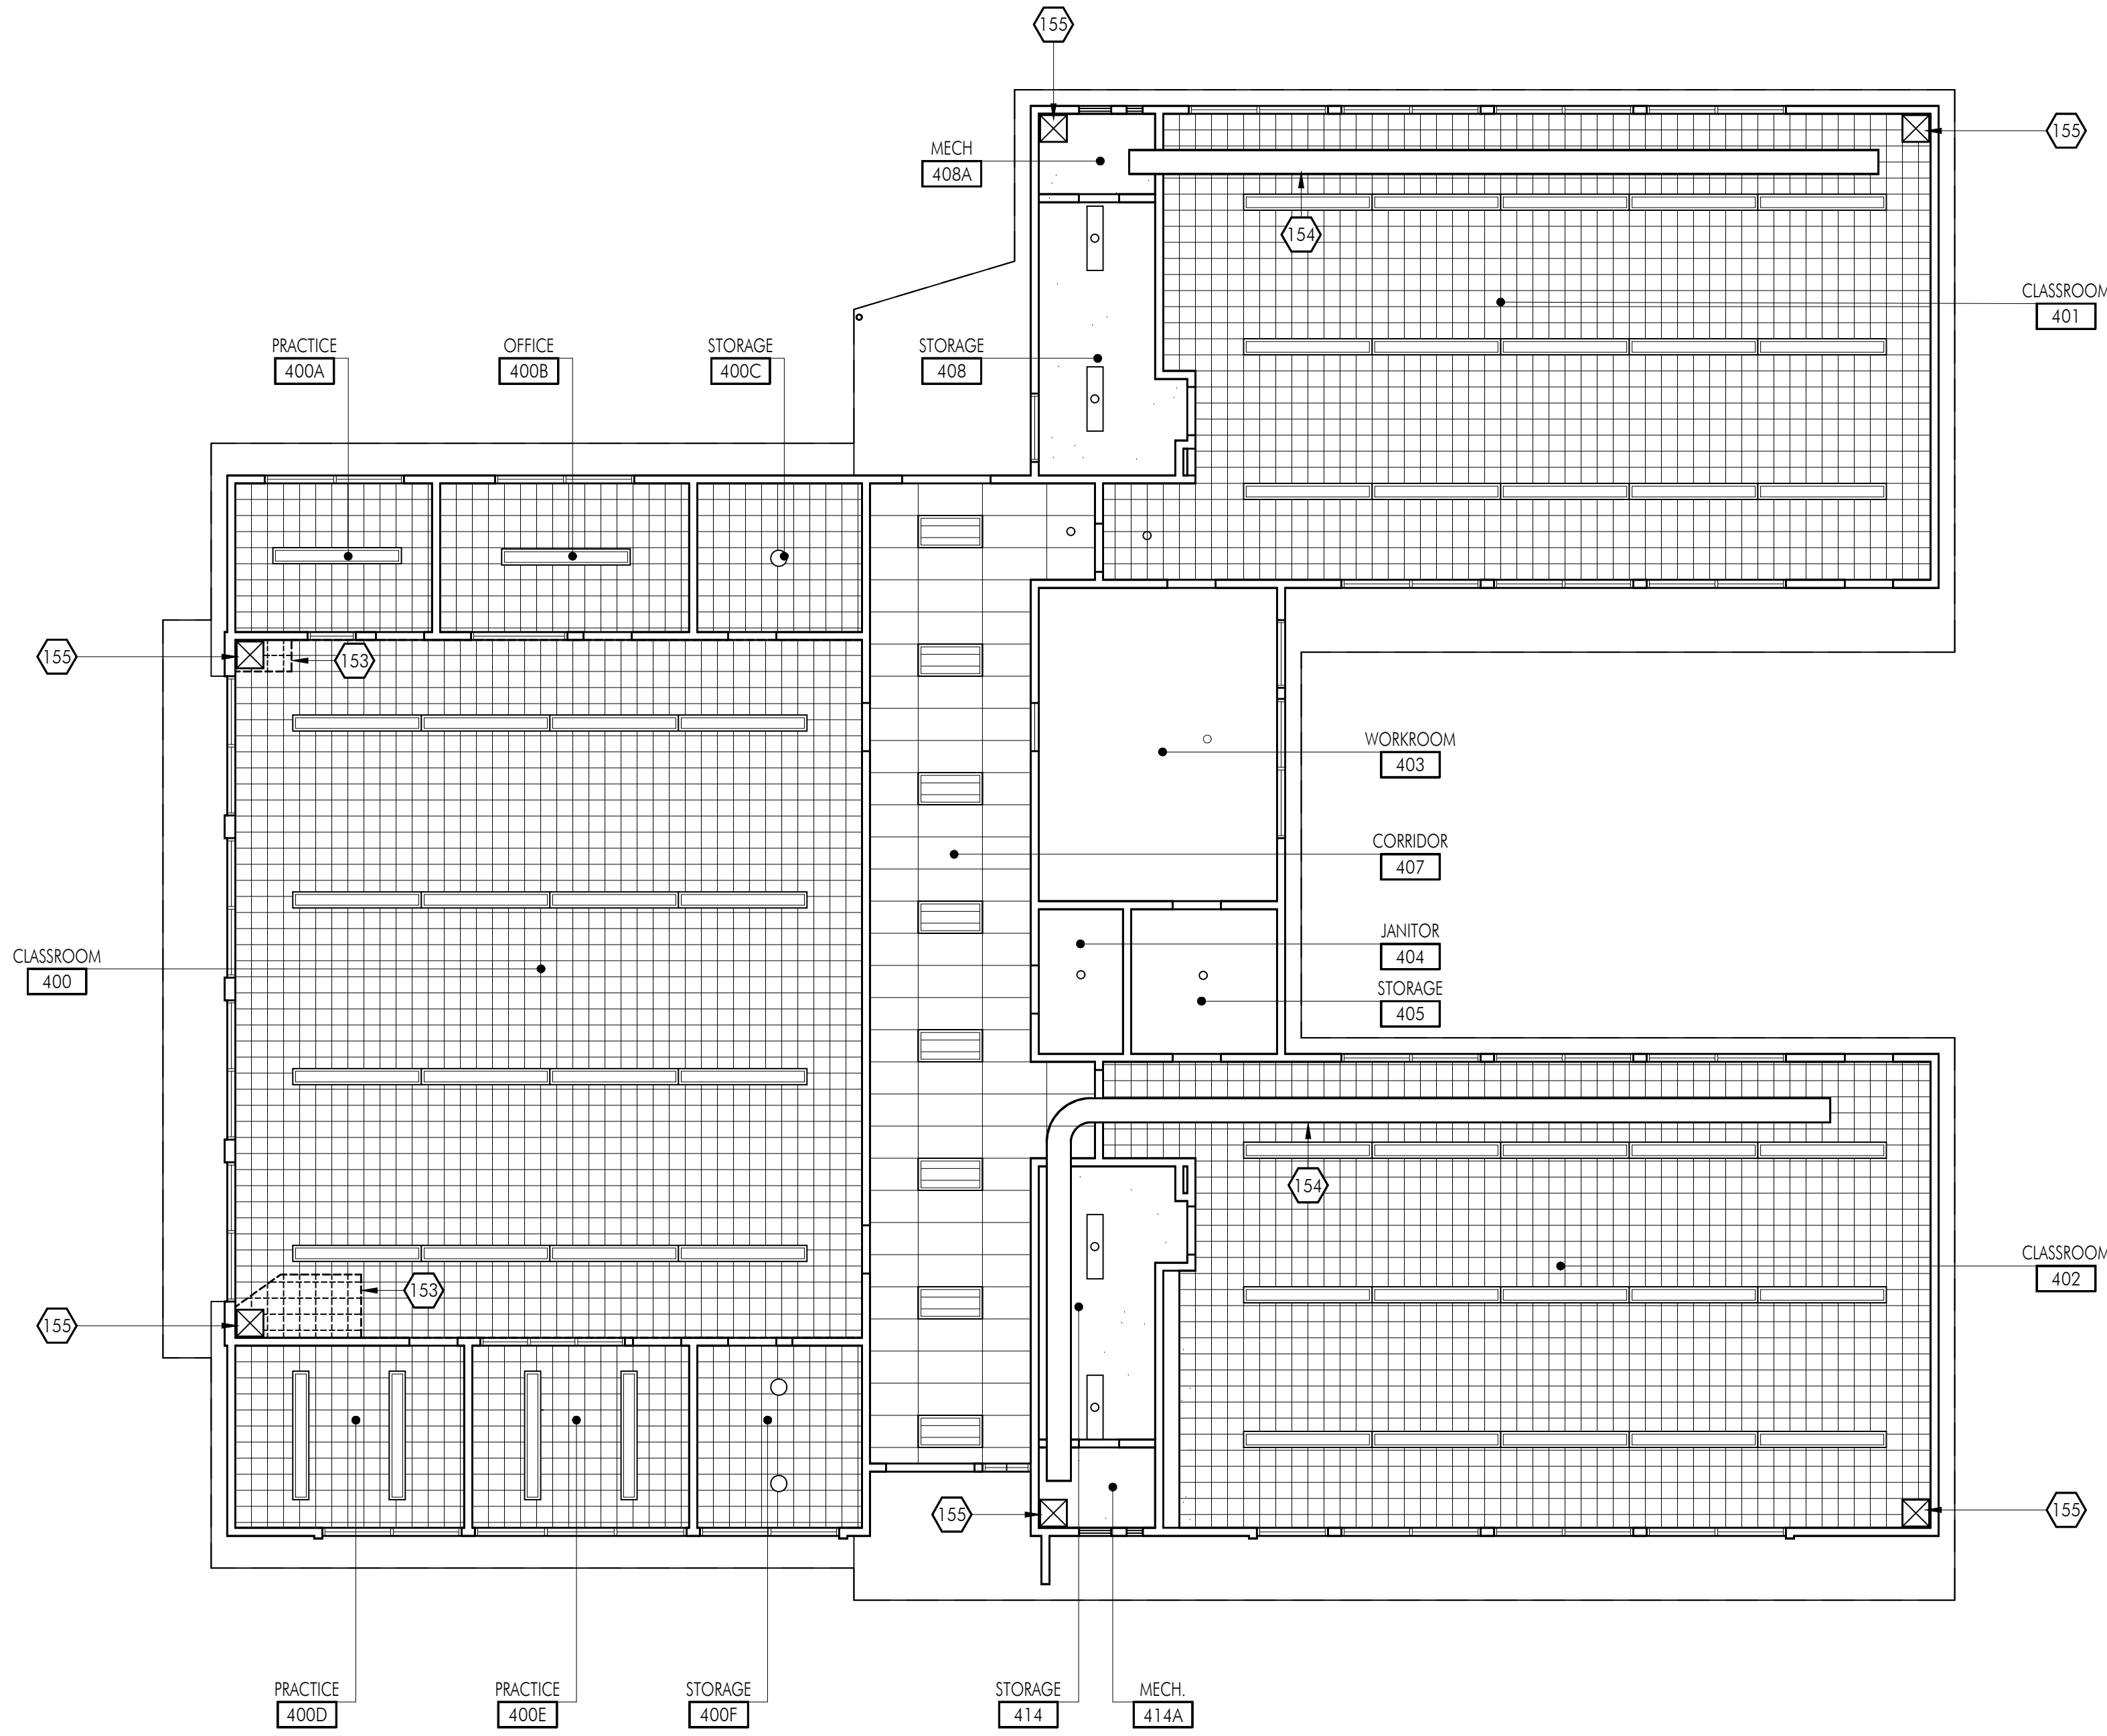


Consultants

Sheet Title
Building 'A'
Demolition Floor Plan

Sheet Number

AA201



FLOOR PLAN GENERAL NOTES

1. REMOVE EXISTING GYPSUM BOARD, TILE AND BACKER BOARD OR PLASTER TO ACCOMMODATE REMOVAL AND REPLACEMENT OF PIPING, ELECTRICAL AND FOR THE INSTALLATION OF SUPPORT BLOCKING AND MECHANICAL EQUIPMENT. PATCH BACK TO MATCH ADJACENT SURFACE.
2. REFER TO MECHANICAL, PLUMBING, ELECTRICAL AND FIRE ALARM DRAWINGS FOR ADDITIONAL SCOPE OF WORK IN EACH ROOM.
3. ALL WALLS SHALL BE FULL HEIGHT TO THE ROOF DECK UNLESS NOTED OTHERWISE, AND SHALL BE CLOSED AND SEALED PER WALL TYPE AND AS DETAILED ON A711.
4. UNSCHEDULED CUTTING, REMOVING OR TRIMMING OF EXISTING CONCRETE, MASONRY OR WOOD FRAMED WALLS IS NOT PERMITTED, UNLESS NOTED OTHERWISE ALL DOORS SHALL BE FITTED WITHIN EXISTING WALL OPENINGS WITHOUT ENLARGING OR TRIMMING HEAD OR JAMBS.

DEMOLITION KEYNOTES


NO.	DESCRIPTION
(153)	REMOVE PORTION OF (E) CEILING AS REQUIRED FOR INSTALLATION OF NEW MECHANICAL CLOSET, MECHANICAL EQUIPMENT AND ALL ASSOCIATED DUCTWORK AND APPURTENANCES. PATCH REPAIR AND PAINT AT ALL REMOVALS TO MATCH EXISTING ADJACENT FINISHES AND IN PREPARATION FOR NEW WORK.
(154)	EXISTING MECHANICAL DUCT TO REMAIN, PROTECT IN PLACE TO BE REUSED AND CONNECT TO NEW EQUIPMENT. SEE MECHANICAL FOR ADDITIONAL INFORMATION.
(155)	MECHANICAL DUCT PENETRATION AT EXISTING ROOF. SEE MECHANICAL AND DETAIL X/A831 FOR ADDITIONAL INFORMATION.

DEMOLITION FLOOR PLAN LEGEND

SYMBOL	DESCRIPTION
	(E) STUD WALL OR PARTITION TO REMAIN.
	(E) STUD WALL OR PARTITION TO BE REMOVED.
	EXISTING SUSPENDED T-BAR CEILING SYSTEM TO REMAIN, UNLESS NOTED OTHERWISE.
	EXISTING GLUE ON ACOUSTIC TILE TO REMAIN, UNLESS NOTED OTHERWISE.
	REMOVE EXISTING LIGHT AND APPURTENANCES. SEE ELECTRICAL FOR MORE INFORMATION
	EXISTING LIGHT FIXTURE TO REMAIN. SEE ELECTRICAL FOR MORE INFORMATION



SCALE: 1/8"=1'-0"

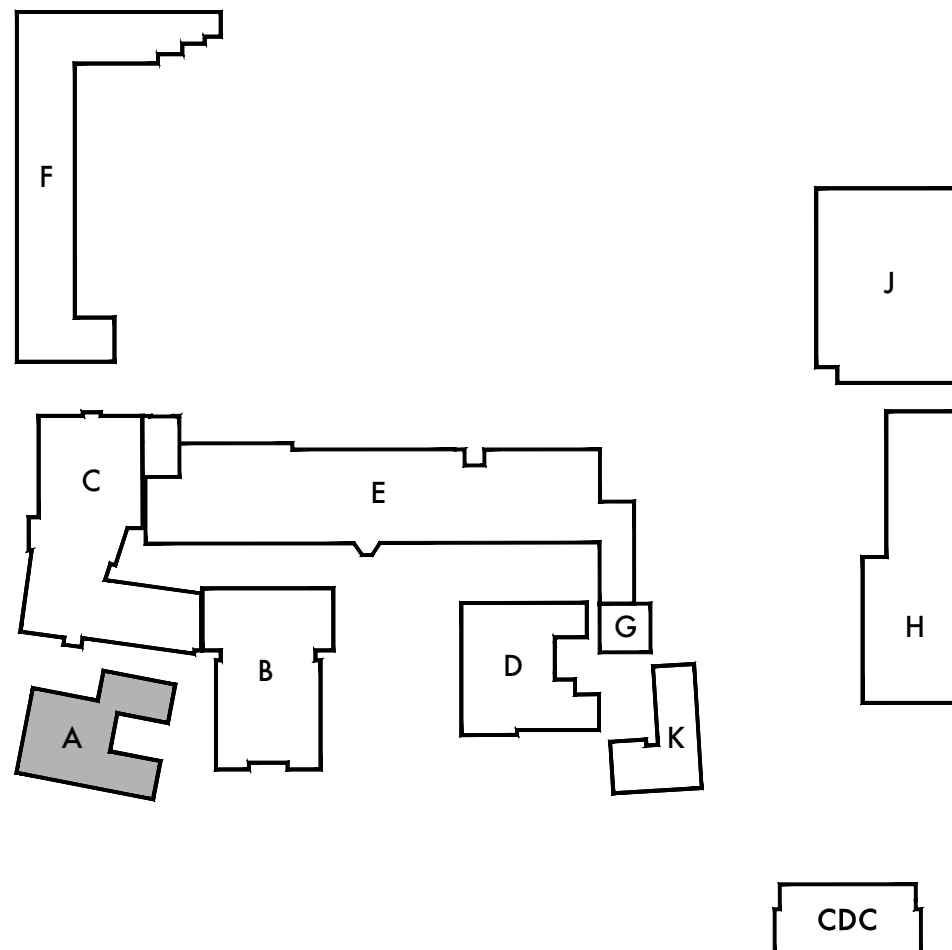

KEY PLAN

DSA Stamp

Architect




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Lincoln Middle School HVAC Replacement Project
Lincoln Middle School
1501 California Avenue
Santa Monica, California 90403

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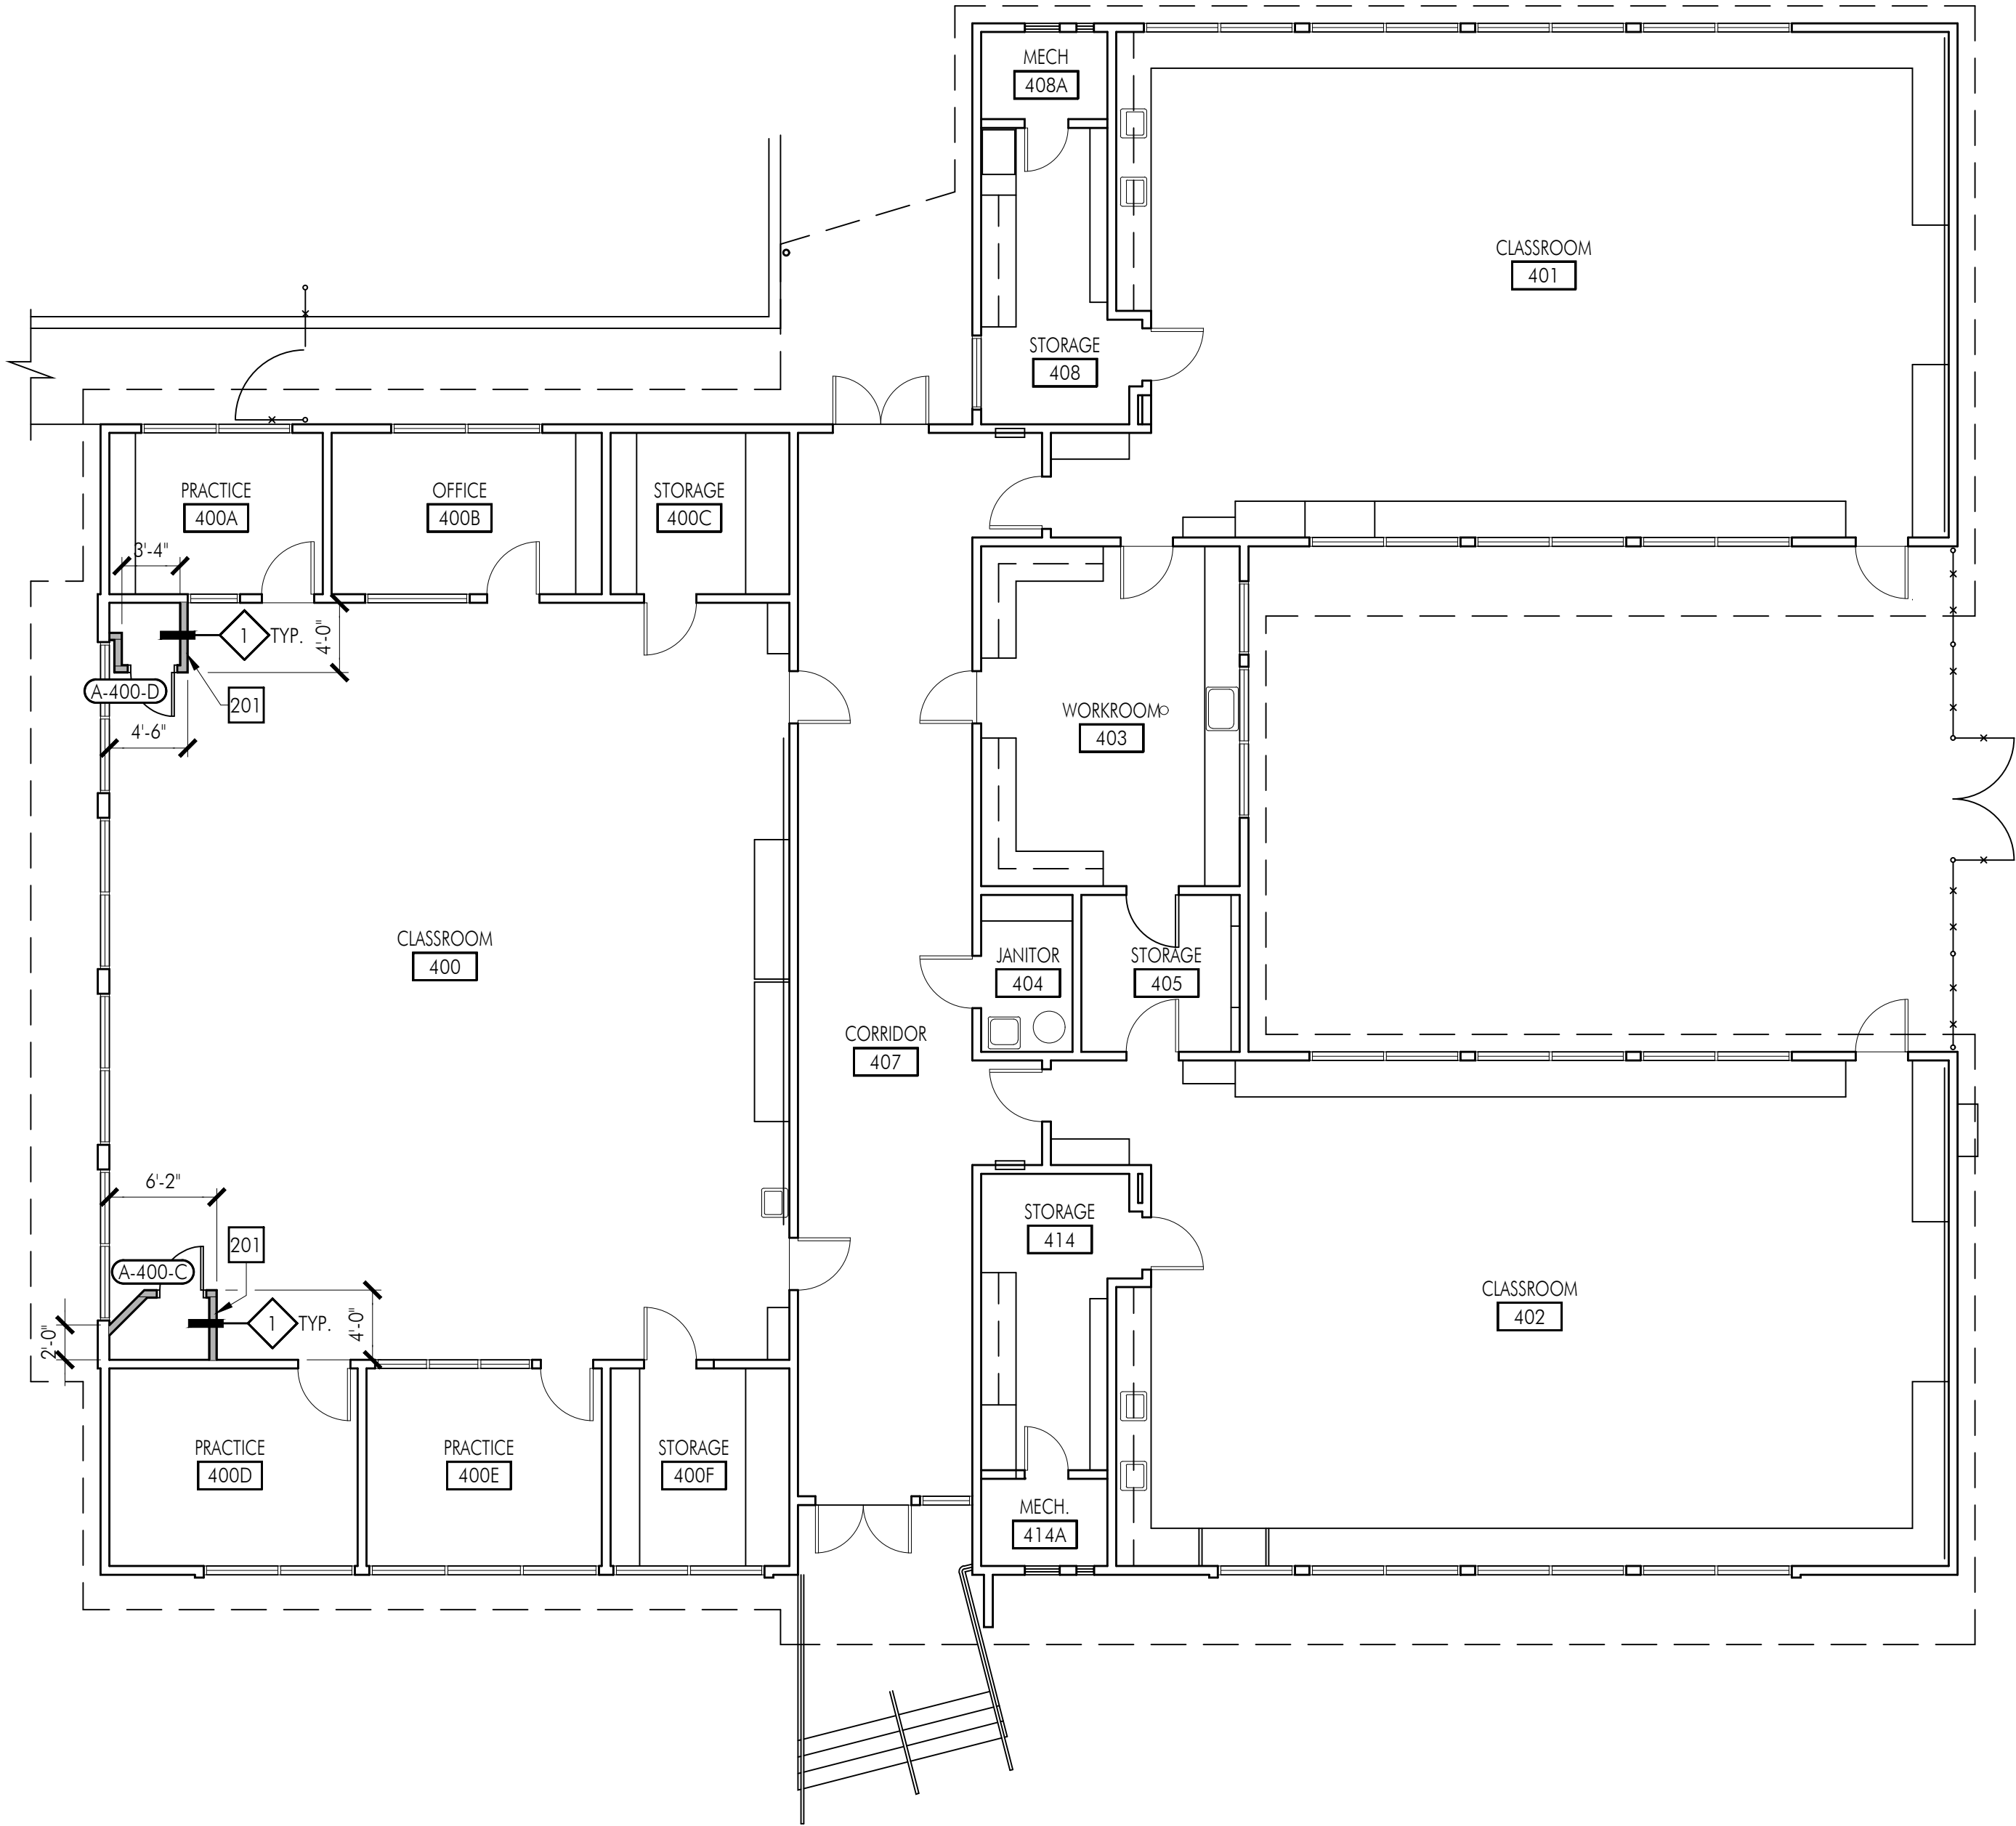


Consultants

Sheet Title
Building 'A'
Demolition Reflected
Ceiling Plan

Sheet Number

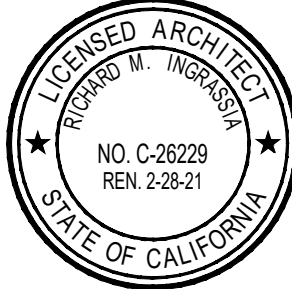AA202



FLOOR PLAN GENERAL NOTES

1. REMOVE EXISTING GYPSUM BOARD, TILE AND BACKER BOARD OR PLASTER TO ACCOMMODATE REMOVAL AND REPLACEMENT OF PIPING, ELECTRICAL AND FOR THE INSTALLATION OF SUPPORT BLOCKING AND MECHANICAL EQUIPMENT. PATCH BACK TO MATCH ADJACENT SURFACE.
2. REFER TO MECHANICAL, PLUMBING, ELECTRICAL AND FIRE ALARM DRAWINGS FOR ADDITIONAL SCOPE OF WORK IN EACH ROOM.
3. ALL WALLS SHALL BE FULL HEIGHT TO THE ROOF DECK UNLESS NOTED OTHERWISE, AND SHALL BE CLOSED AND SEALED PER WALL TYPE AND AS DETAILED ON A711.
4. UNSCHEDULED CUTTING, REMOVING OR TRIMMING OF EXISTING CONCRETE, MASONRY OR WOOD FRAMED WALLS IS NOT PERMITTED, UNLESS NOTED OTHERWISE ALL DOORS SHALL BE FITTED WITHIN EXISTING WALL OPENINGS WITHOUT ENLARGING OR TRIMMING HEAD OR JAMBS.

KEYNOTES


NO.	DESCRIPTION
201	MECHANICAL CLOSET SEE WALL TYPE AS REFERENCED AND PLAN FOR DIMENSIONS. SEE MECHANICAL DRAWINGS FOR MORE INFORMATION.
220	MECHANICAL CONDENSER UNIT ON CONCRETE PAD. PROVIDE CONCRETE PAD AS REQUIRED FOR NUMBER OF CONDENSER UNITS AT EACH LOCATION. SEE MECHANICAL AND DETAIL X/A811 FOR ADDITIONAL INFORMATION.

FLOOR PLAN LEGEND

SYMBOL	DESCRIPTION
	(E) WOOD STUD WALL OR PARTITION TO REMAIN.
	METAL STUD WALL ASSEMBLY. REFER TO WALL TYPE AND TYPICAL DETAILS ON A711 FOR MORE INFORMATION.
	NEW DOOR AND FRAME. SEE DOOR SCHEDULE ON A611 FOR MORE INFORMATION.
	WALL TYPE. SEE A711 FOR MORE INFORMATION.



KEY PLAN

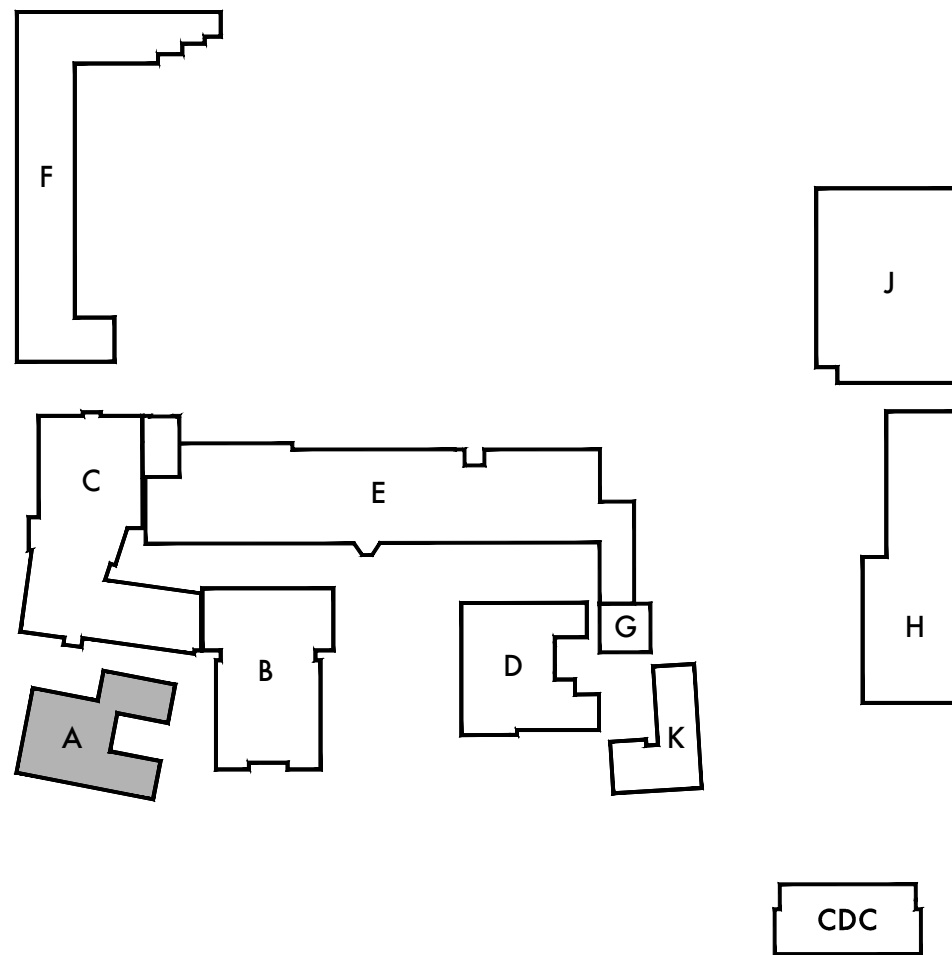

DSA Stamp

Architect




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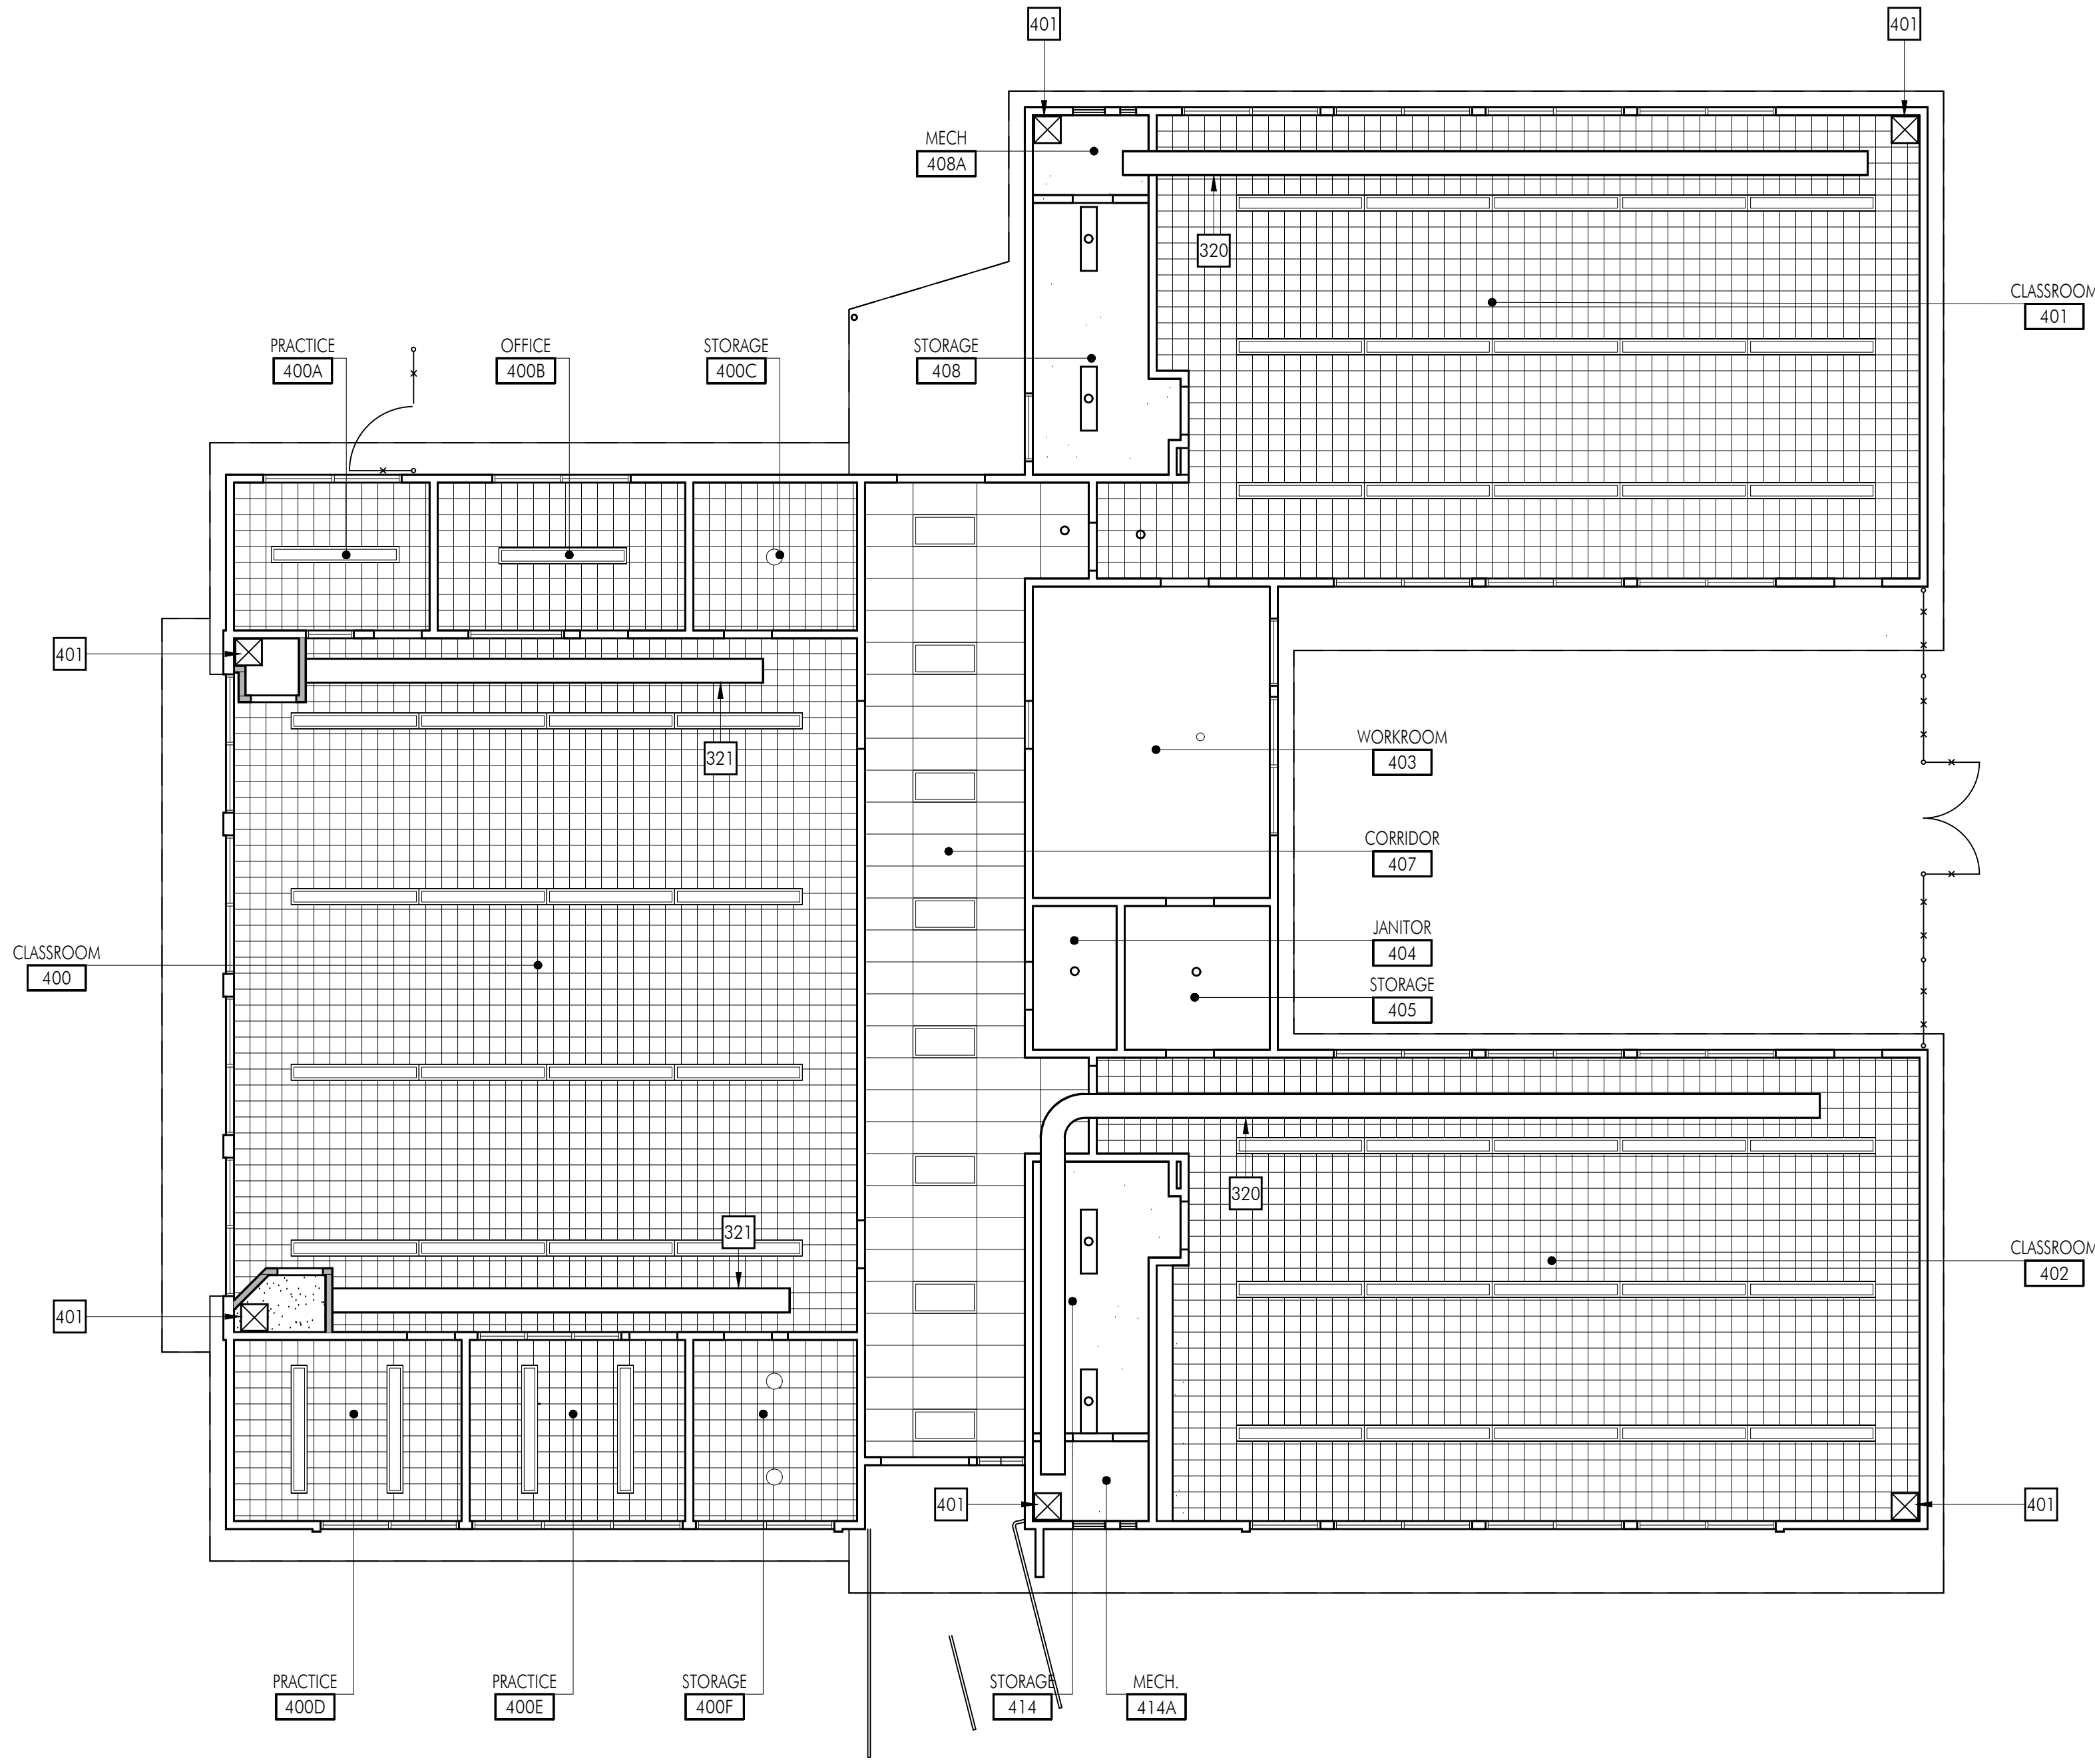
Consultants

Sheet Title
Building 'A' Floor Plan

Sheet Number

AA211

1 REFLECTED CEILING PLAN

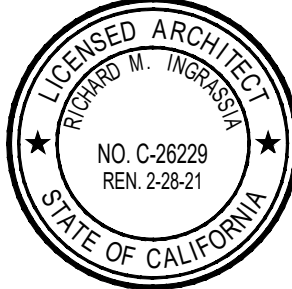

SCALE: 1/8"=1'-0"

FLOOR PLAN GENERAL NOTES

1. REMOVE EXISTING GYPSUM BOARD, TILE AND BACKER BOARD OR PLASTER TO ACCOMMODATE REMOVAL AND REPLACEMENT OF PIPING, ELECTRICAL AND FOR THE INSTALLATION OF SUPPORT BLOCKING AND MECHANICAL EQUIPMENT. PATCH BACK TO MATCH ADJACENT SURFACE.
2. REFER TO MECHANICAL, PLUMBING, ELECTRICAL AND FIRE ALARM DRAWINGS FOR ADDITIONAL SCOPE OF WORK IN EACH ROOM.
3. ALL WALLS SHALL BE FULL HEIGHT TO THE ROOF DECK UNLESS NOTED OTHERWISE, AND SHALL BE CLOSED AND SEALED PER WALL TYPE AND AS DETAILED ON A711.
4. UNSCHEDULED CUTTING, REMOVING OR TRIMMING OF EXISTING CONCRETE, MASONRY OR WOOD FRAMED WALLS IS NOT PERMITTED, UNLESS NOTED OTHERWISE ALL DOORS SHALL BE FITTED WITHIN EXISTING WALL OPENINGS WITHOUT ENLARGING OR TRIMMING HEAD OR JAMBS.

KEYNOTES

NO.	DESCRIPTION
320	EXISTING MECHANICAL DUCT TO REMAIN, PROTECT IN PLACE TO BE REUSED AND CONNECT TO NEW EQUIPMENT. SEE MECHANICAL FOR ADDITIONAL INFORMATION.
321	EXPOSED DUCT. SEE MECHANICAL FOR MORE INFORMATION.
401	MECHANICAL DUCT PENETRATION AT EXISTING ROOF. SEE MECHANICAL AND DETAIL X/A831 FOR ADDITIONAL INFORMATION.

FLOOR PLAN LEGEND

SYMBOL	DESCRIPTION
	(E) WOOD STUD WALL OR PARTITION TO REMAIN.
	METAL STUD WALL ASSEMBLY. REFER TO WALL TYPE AND TYPICAL DETAILS ON A711 FOR MORE INFORMATION.
	EXISTING SUSPENDED T-BAR CEILING SYSTEM TO REMAIN, UNLESS NOTED OTHERWISE.
	EXISTING GLUE ON ACOUSTIC TILE TO REMAIN, UNLESS NOTED OTHERWISE.
	EXISTING LIGHT FIXTURE TO REMAIN. SEE ELECTRICAL FOR MORE INFORMATION.
	RELOCATED LIGHT FIXTURE. SEE ELECTRICAL FOR MORE INFORMATION.
	FRAMED GYPSUM BOARD CEILING SEE XXXX FOR ADDITIONAL INFORMATION AND REFERENCED DETAIL ON PLAN FOR SOFFIT CONDITIONS AS OCCURS. PAINT P-1
	AIR SUPPLY REGISTER
	RETURN AIR GRILLE
	EXHAUST GRILLE

APPL. No. A 00-123456

DSA Stamp

Architect




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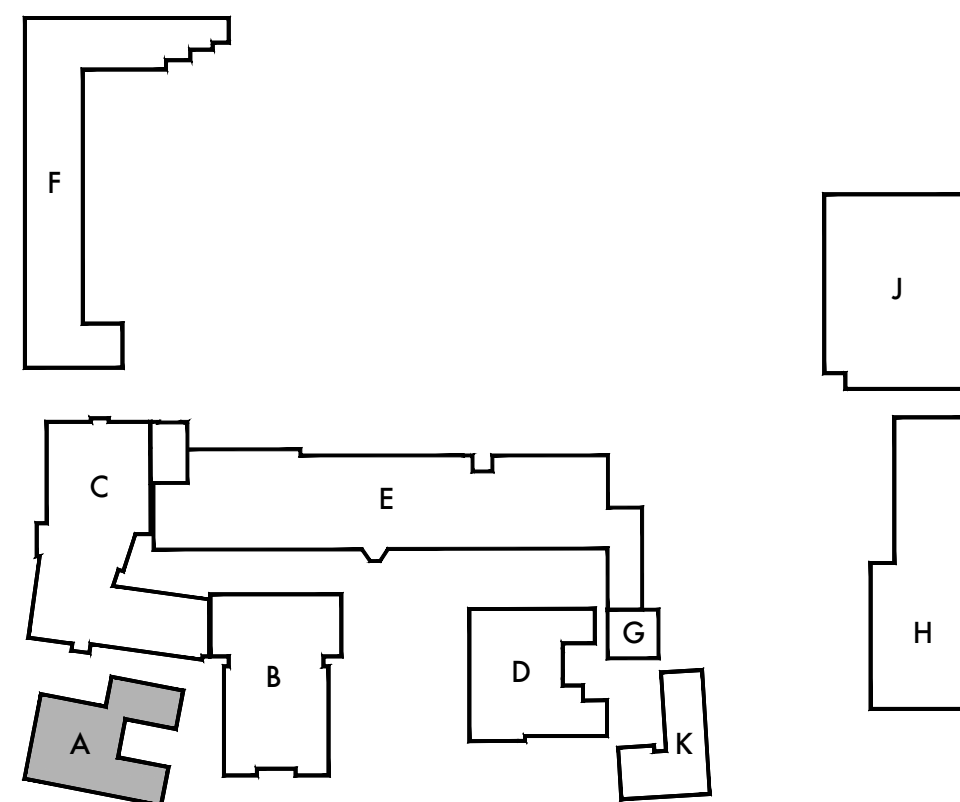
Consultants

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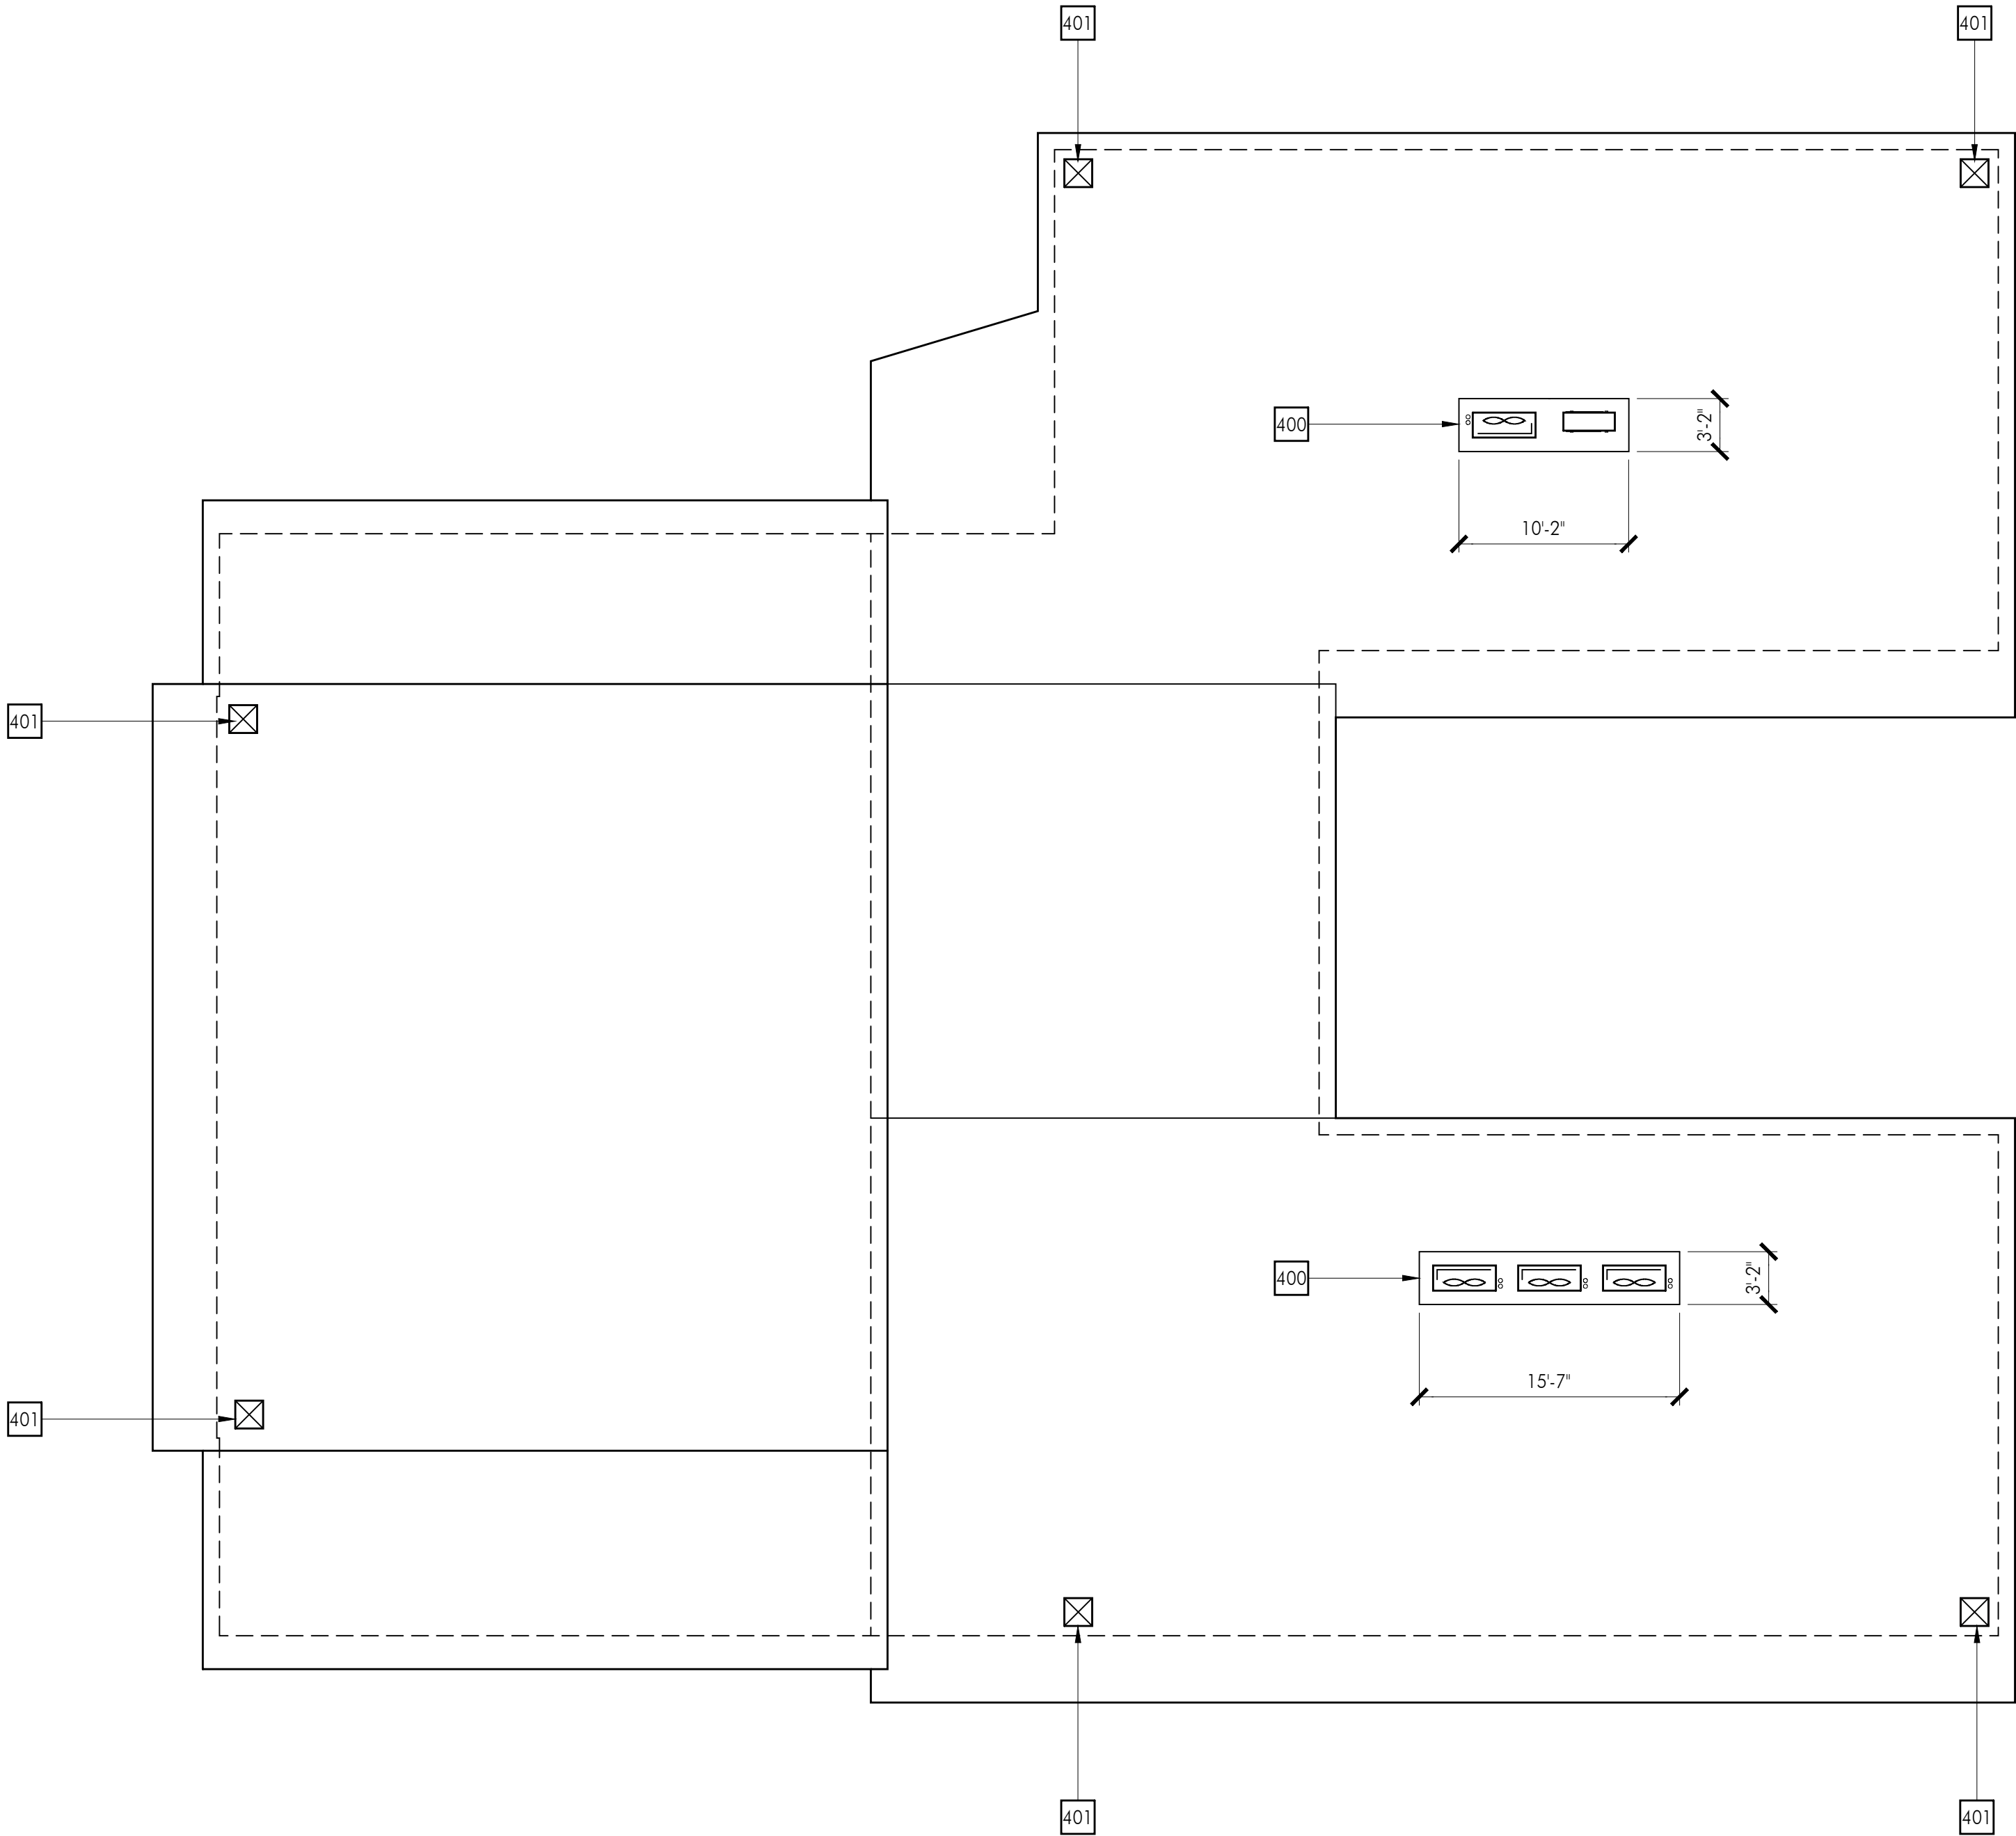
Building 'A' Reflected Ceiling Plan

Sheet Number

AA231

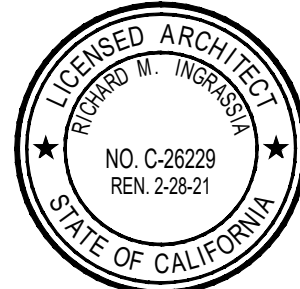

KEY PLAN



FLOOR PLAN GENERAL NOTES

1. REMOVE EXISTING GYPSUM BOARD, TILE AND BACKER BOARD OR PLASTER TO ACCOMMODATE REMOVAL AND REPLACEMENT OF PIPING, ELECTRICAL AND FOR THE INSTALLATION OF SUPPORT BLOCKING AND MECHANICAL EQUIPMENT. PATCH BACK TO MATCH ADJACENT SURFACE.
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4. UNSCHEDULED CUTTING, REMOVING OR TRIMMING OF EXISTING CONCRETE, MASONRY OR WOOD FRAMED WALLS IS NOT PERMITTED, UNLESS NOTED OTHERWISE ALL DOORS SHALL BE FITTED WITHIN EXISTING WALL OPENINGS WITHOUT ENLARGING OR TRIMMING HEAD OR JAMBS.

KEYNOTES

NO.	DESCRIPTION
400	ROOF MOUNTED MECHANICAL CONDENSER UNIT ON WOOD PAD. SEE PLAN FOR ROUGH DIMENSIONS, ADJUST PAD SIZE FOR NUMBER OF CONDENSERS AND REQUIRED CLEARANCES. SEE MECHANICAL AND DETAIL X/A831 FOR ADDITIONAL INFORMATION.
401	MECHANICAL DUCT PENETRATION AT EXISTING ROOF. SEE MECHANICAL AND DETAIL X/A831 FOR ADDITIONAL INFORMATION.

APPL. No. A 00-123456

DSA Stamp

Architect




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Lincoln Middle School
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Santa Monica, California 90403

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Sheet Title
Building 'A' Roof Plan


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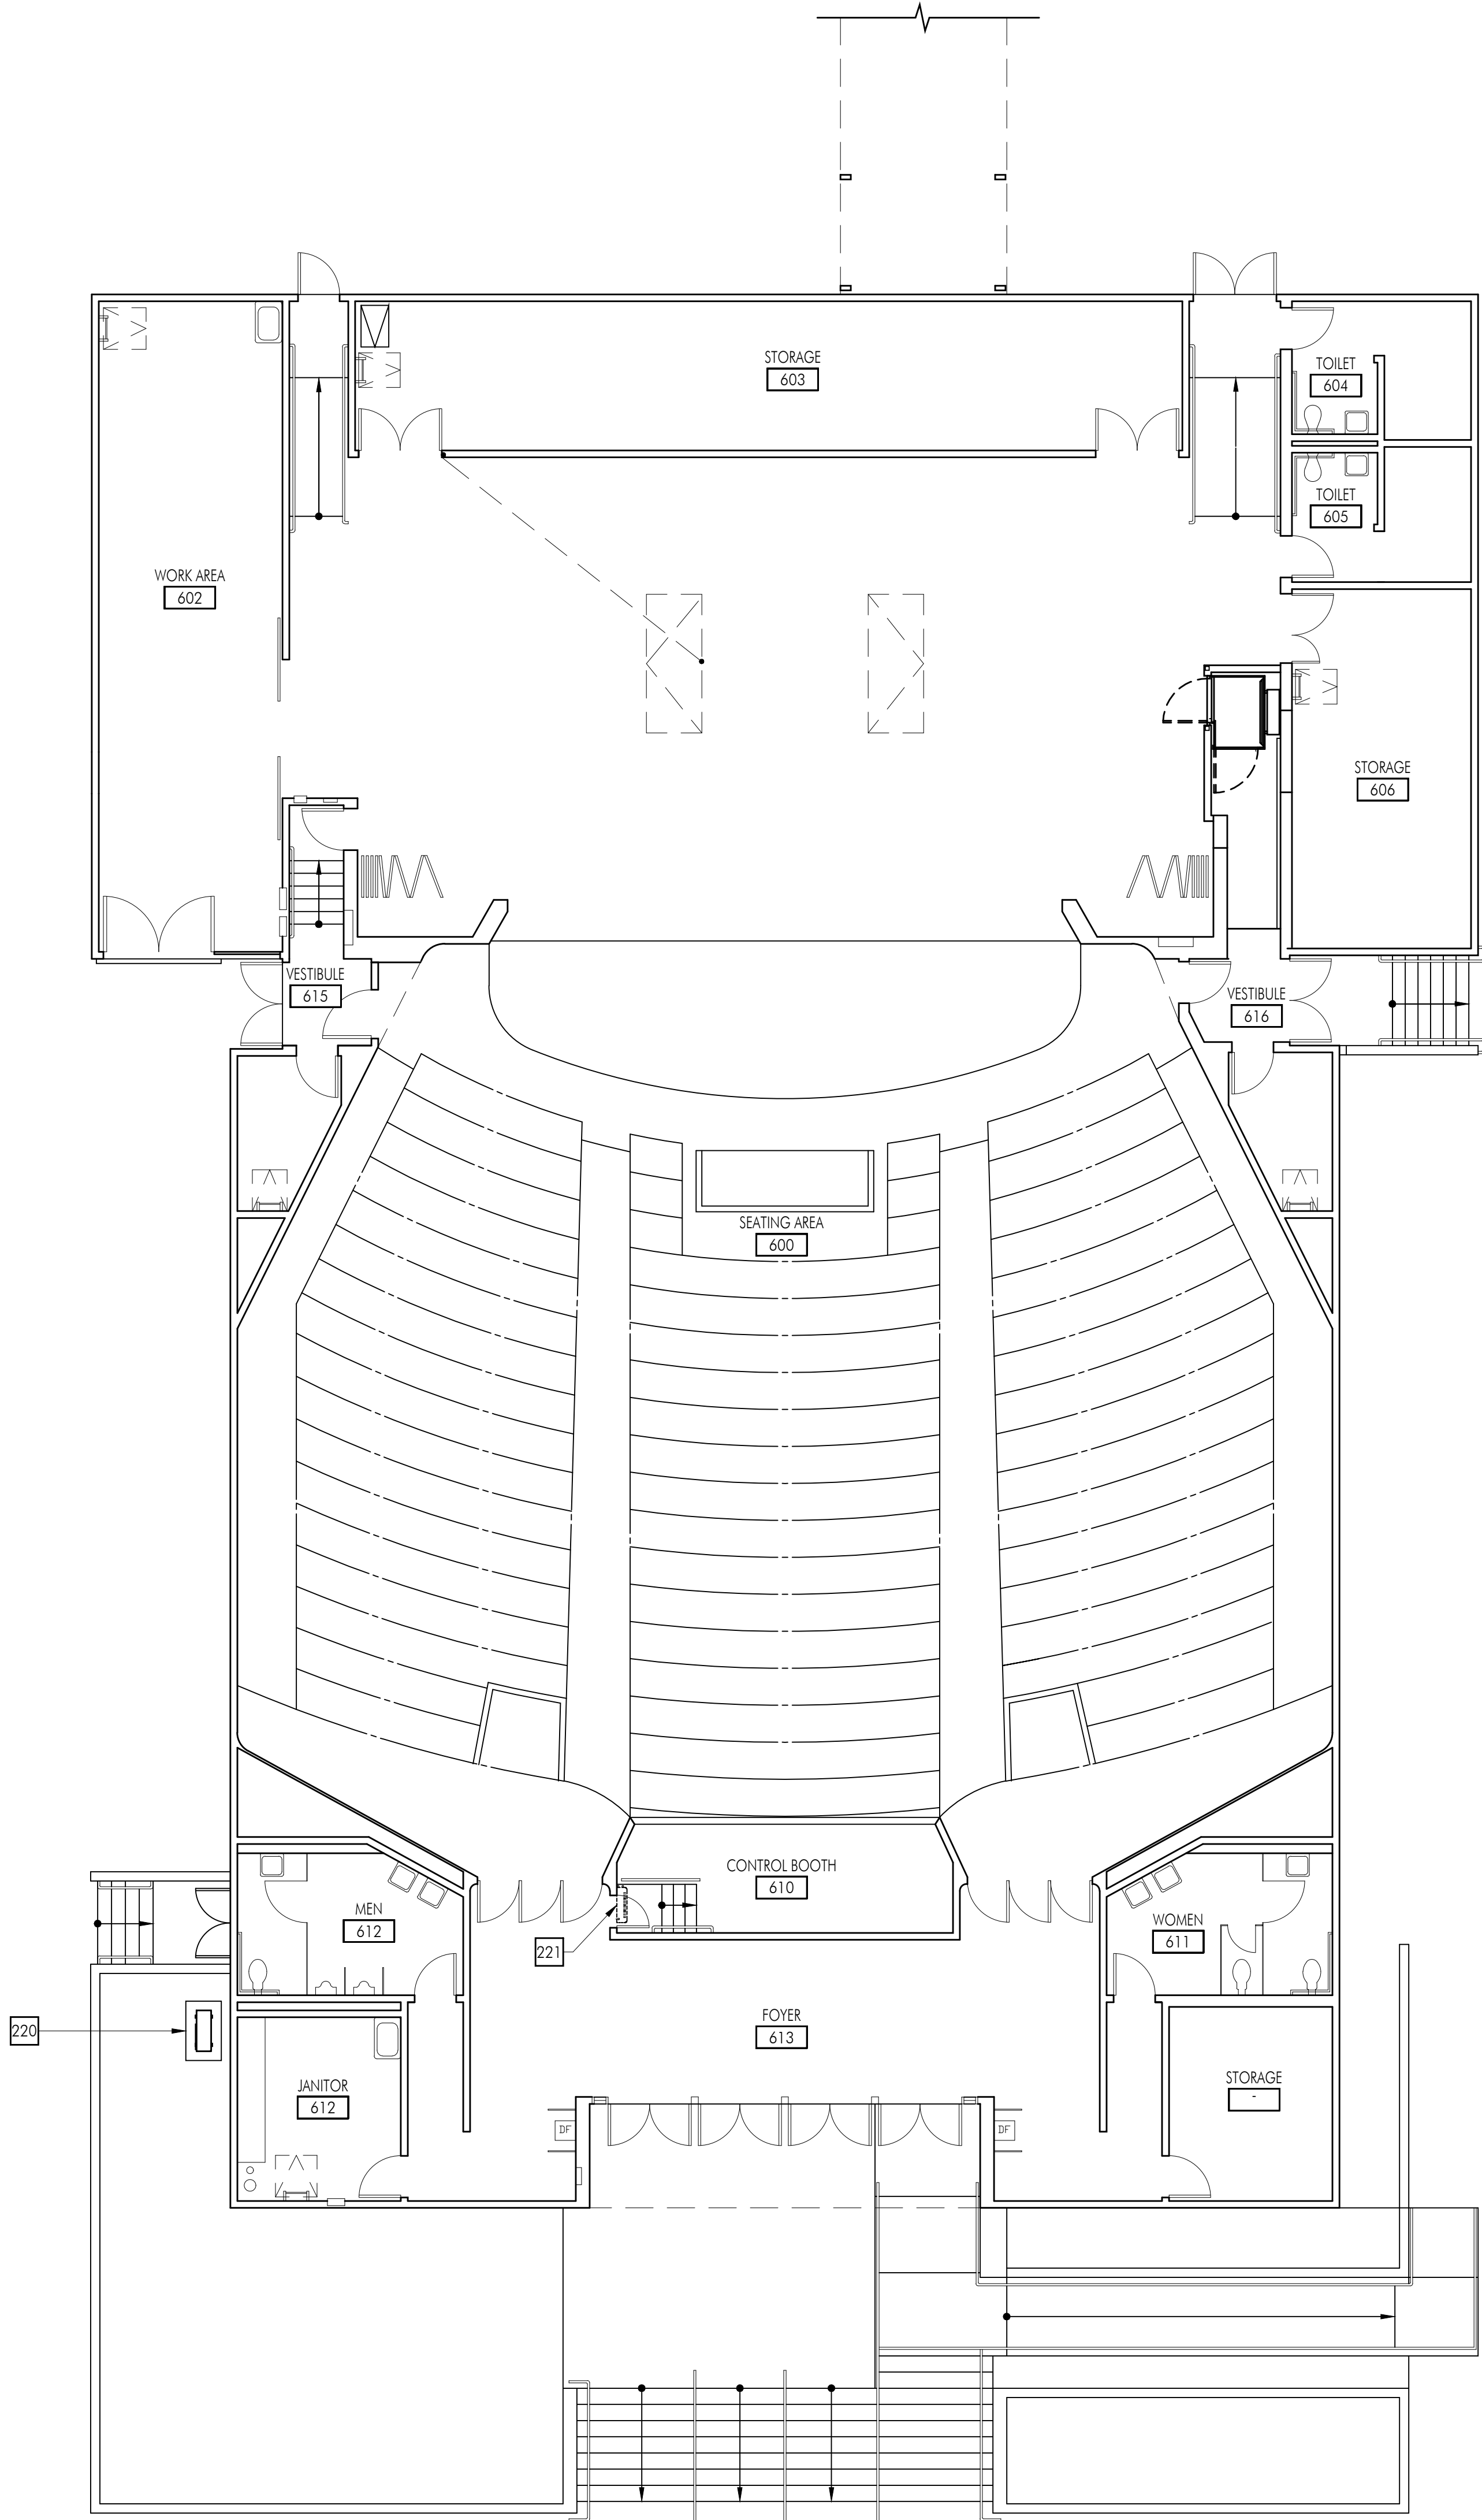
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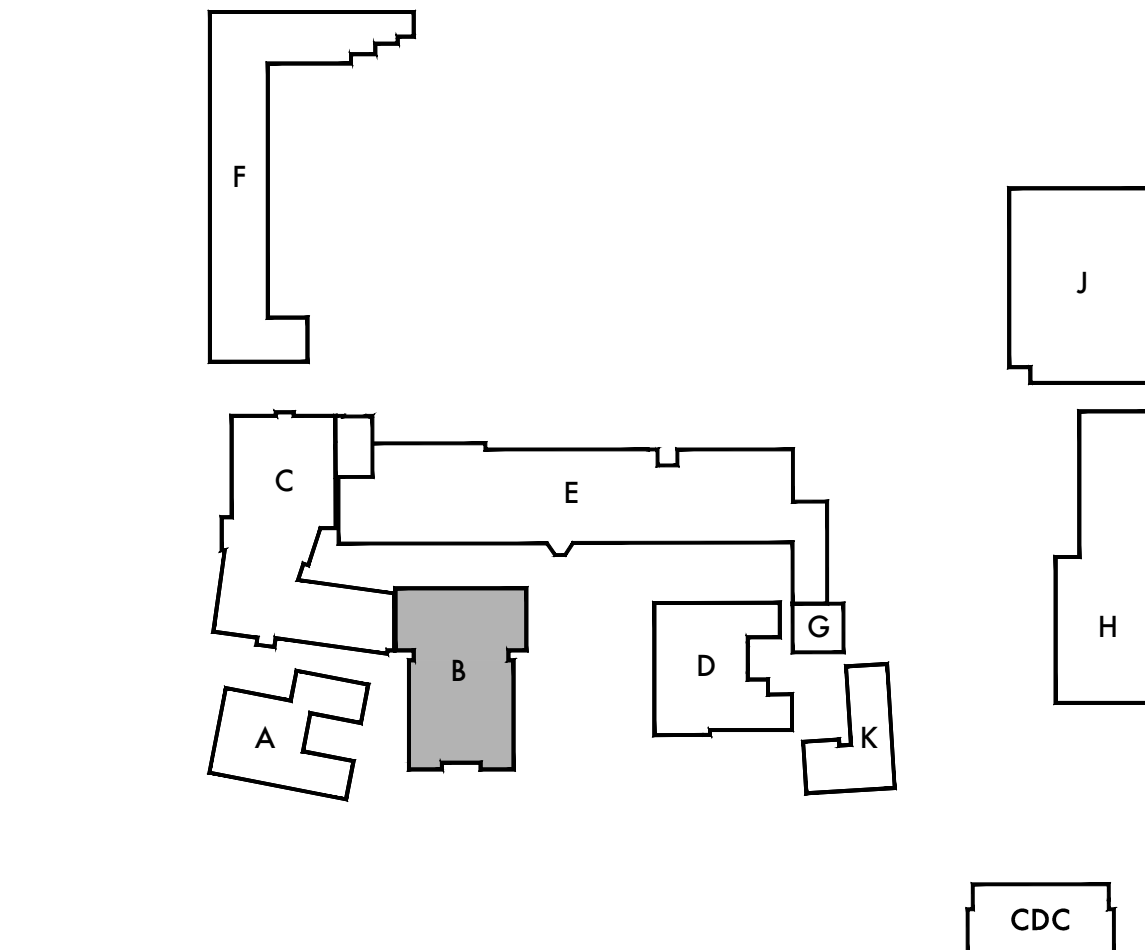
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KEY PLAN



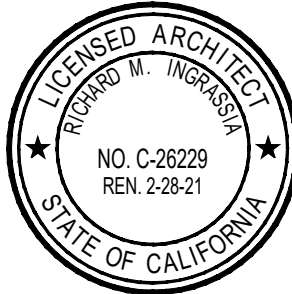

SCALE: 1/8"=1'-0"

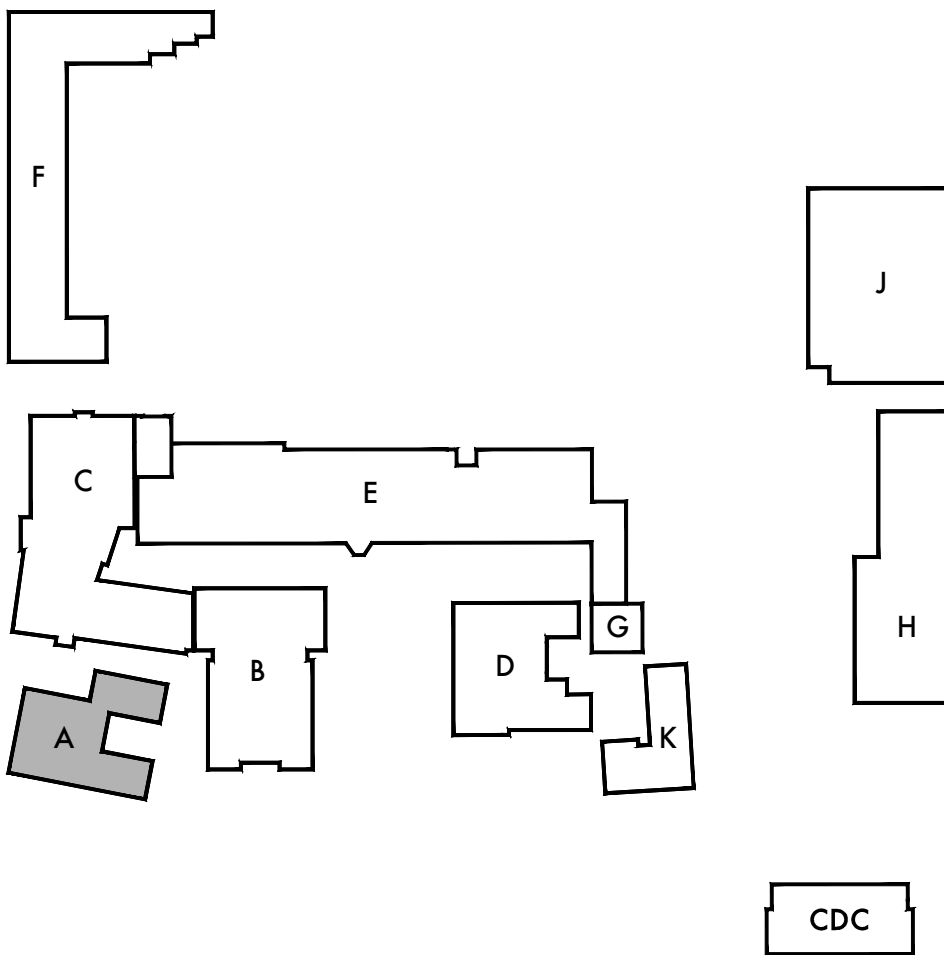

KEY PLAN

FLOOR PLAN GENERAL NOTES

1. REMOVE EXISTING GYPSUM BOARD, TILE AND BACKER BOARD OR PLASTER TO ACCOMMODATE REMOVAL AND REPLACEMENT OF PIPING, ELECTRICAL AND FOR THE INSTALLATION OF SUPPORT BLOCKING AND MECHANICAL EQUIPMENT. PATCH BACK TO MATCH ADJACENT SURFACE.
2. REFER TO MECHANICAL, PLUMBING, ELECTRICAL AND FIRE ALARM DRAWINGS FOR ADDITIONAL SCOPE OF WORK IN EACH ROOM.
3. ALL WALLS SHALL BE FULL HEIGHT TO THE ROOF DECK UNLESS NOTED OTHERWISE, AND SHALL BE CLOSED AND SEALED PER WALL TYPE AND AS DETAILED ON A711.
4. UNSCHEDULED CUTTING, REMOVING OR TRIMMING OF EXISTING CONCRETE, MASONRY OR WOOD FRAMED WALLS IS NOT PERMITTED, UNLESS NOTED OTHERWISE ALL DOORS SHALL BE FITTED WITHIN EXISTING WALL OPENINGS WITHOUT ENLARGING OR TRIMMING HEAD OR JAMBS.

KEYNOTES

NO.	DESCRIPTION
220	MECHANICAL CONDENSER UNIT ON CONCRETE PAD. PROVIDE CONCRETE PAD AS REQUIRED FOR NUMBER OF CONDENSER UNITS AT EACH LOCATION. SEE MECHANICAL AND DETAIL X/A811 FOR ADDITIONAL INFORMATION.
221	MECHANICAL EQUIPMENT. SEE MECHANICAL AND ELECTRICAL FOR ADDITIONAL INFORMATION
222	MECHANICAL REGISTER AT +10'-6" ABOVE FINISH FLOOR. SEE MECHANICAL AND ELECTRICAL FOR ADDITIONAL INFORMATION. (REVIEW LOCATION IN THE FIELD WITH ARCHITECT PRIOR TO COMPLETING WORK)

FLOOR PLAN LEGEND

SYMBOL	DESCRIPTION
	(E) WOOD STUD WALL OR PARTITION TO REMAIN.
	METAL STUD WALL ASSEMBLY. REFER TO WALL TYPE AND TYPICAL DETAILS ON A711 FOR MORE INFORMATION
	NEW DOOR AND FRAME. SEE DOOR SCHEDULE ON A611 FOR MORE INFORMATION
	WALL TYPE. SEE A711 FOR MORE INFORMATION.

APPL. No. A 00-123456

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Architect




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Lincoln Middle School
1501 California Avenue
Santa Monica, California 90403

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Sheet Title

Building 'B' Floor Plan

Sheet Number

AB211

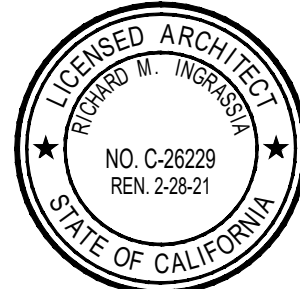
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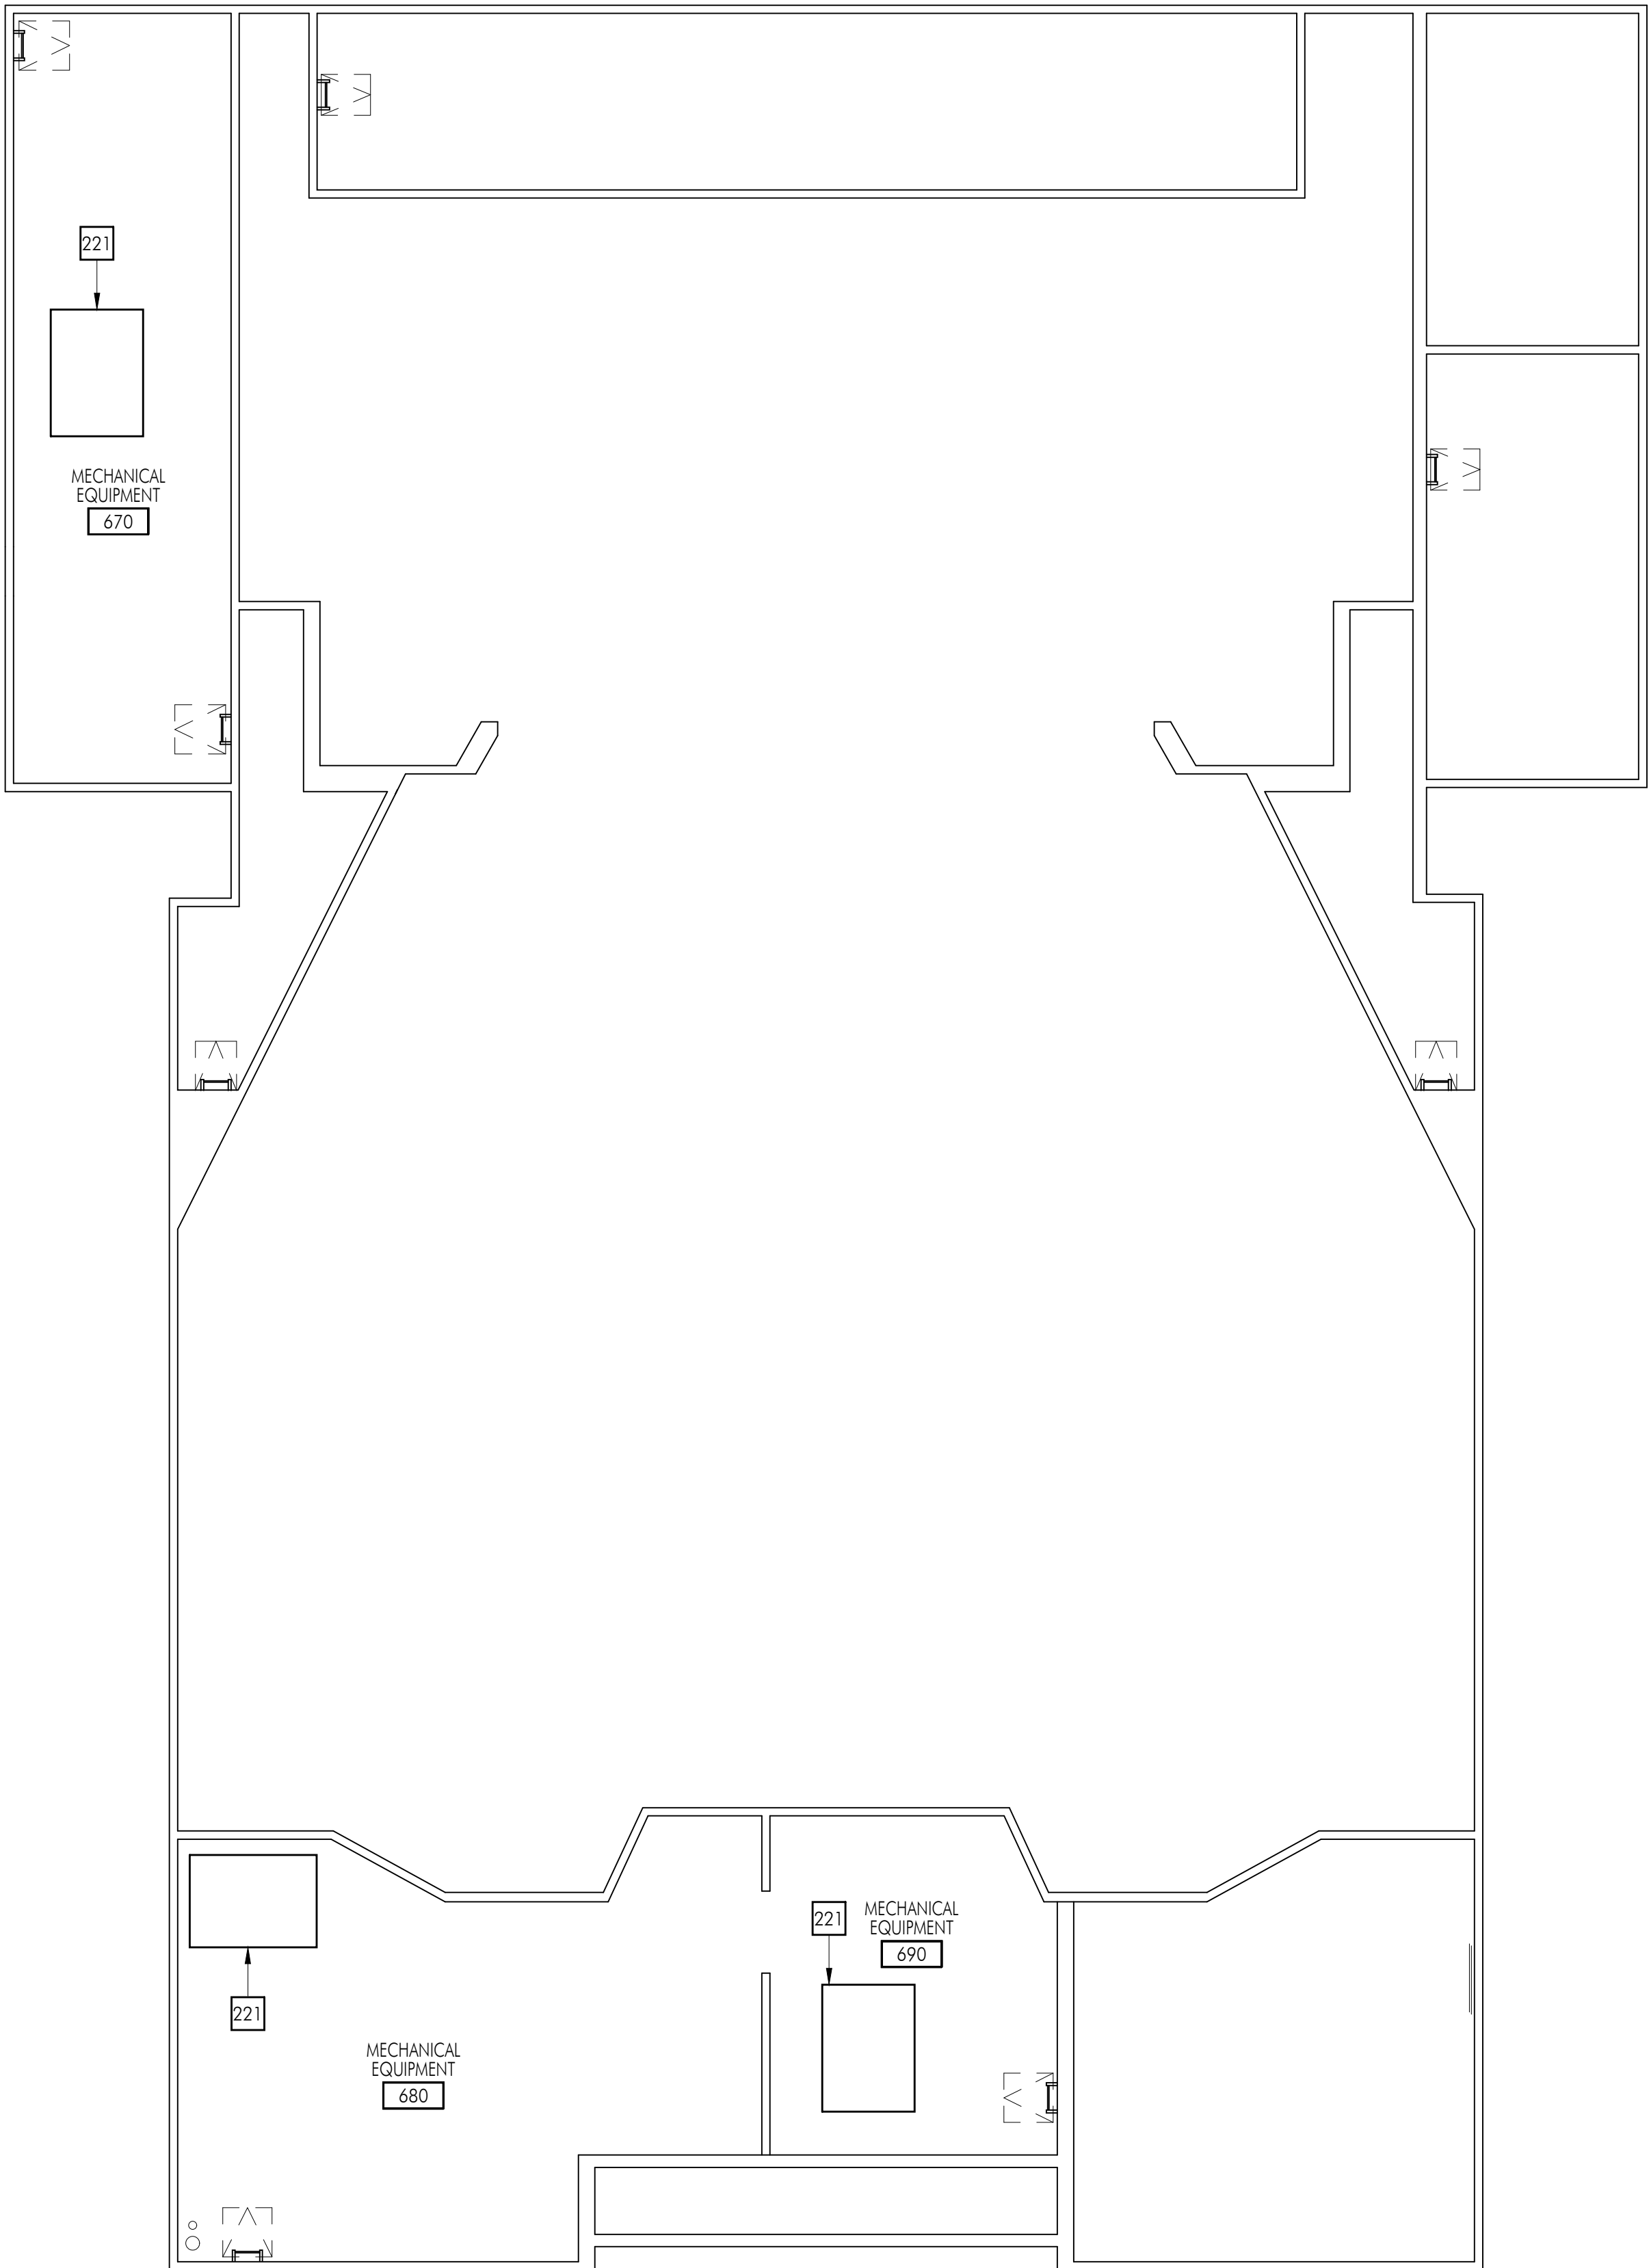
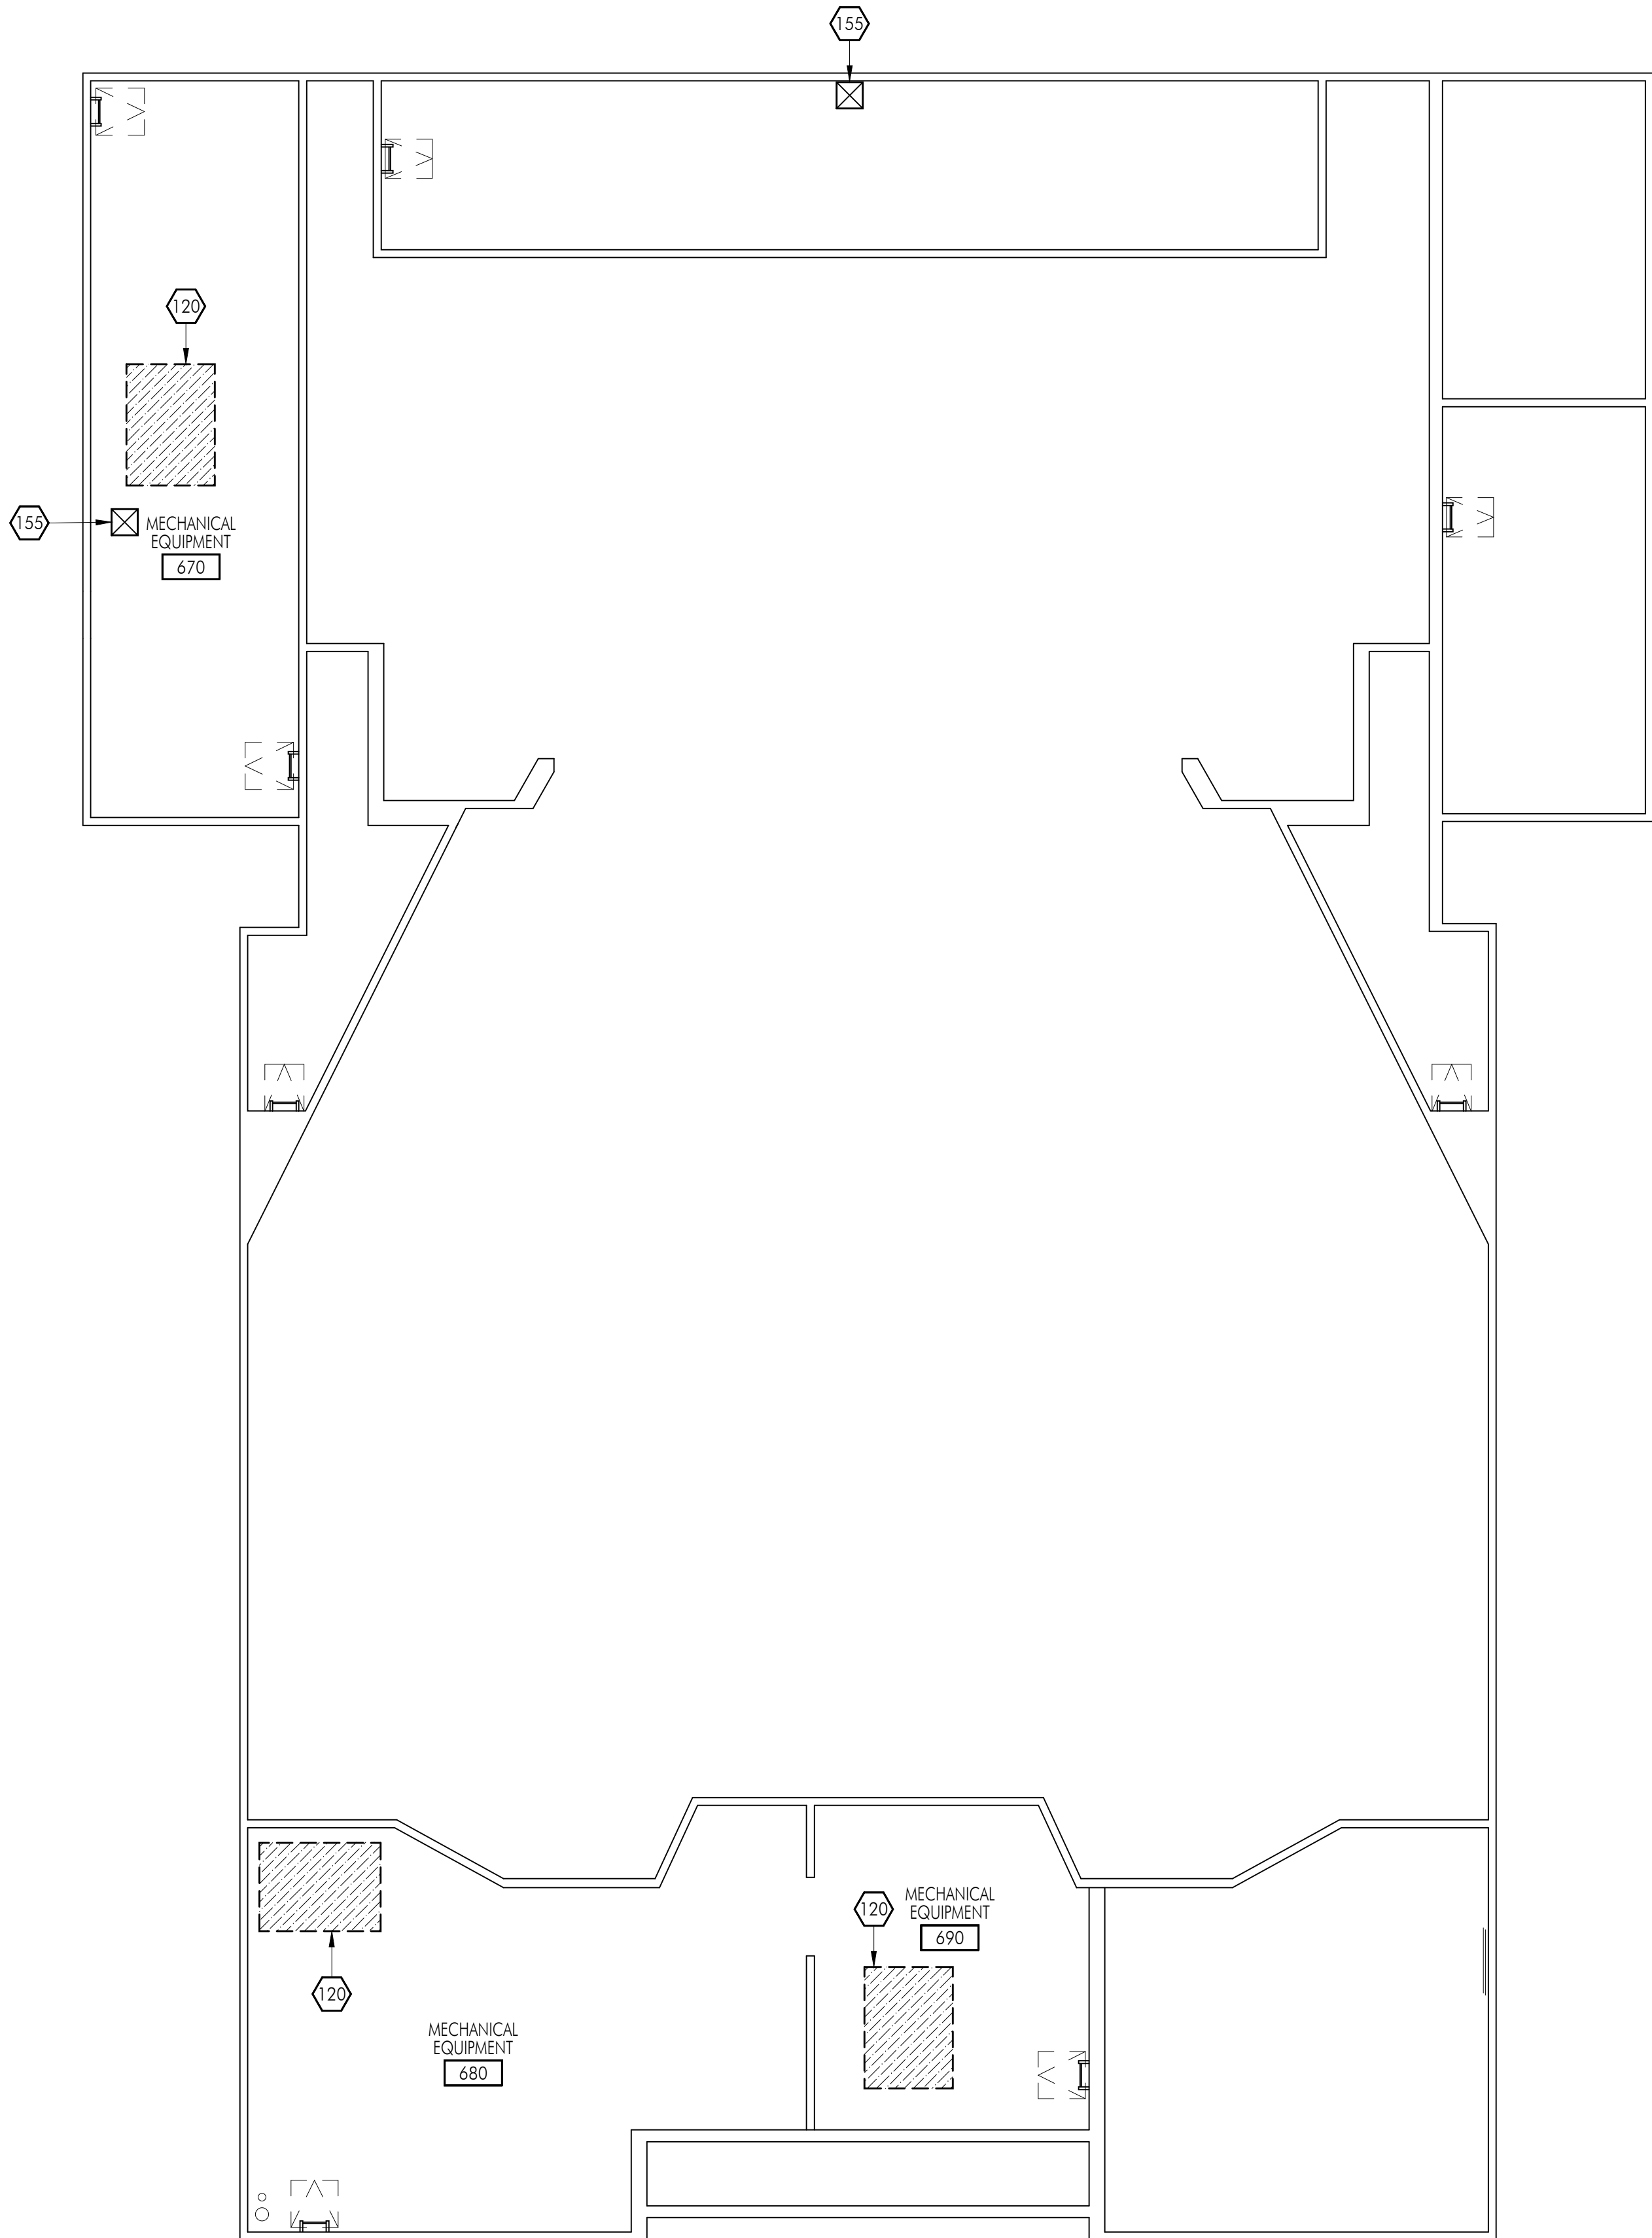
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SCALE: 1/8"=1'-0"



KEY PLAN



FLOOR PLAN GENERAL NOTES

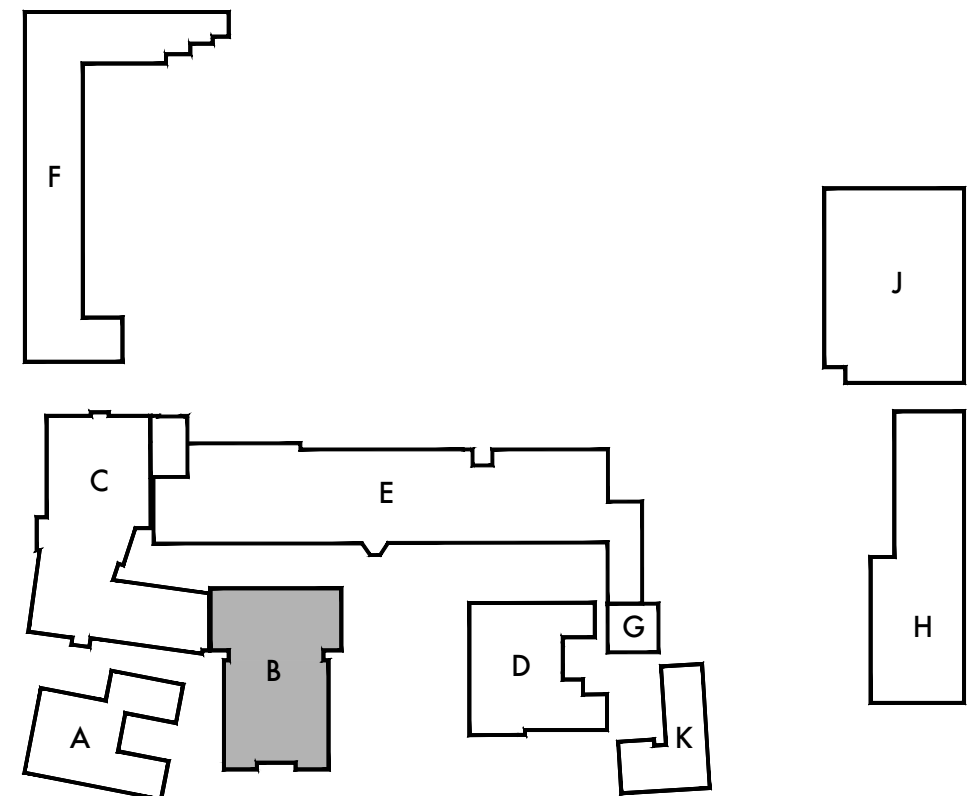1. REMOVE EXISTING GYPSUM BOARD, TILE AND BACKER BOARD OR PLASTER TO ACCOMMODATE REMOVAL AND REPLACEMENT OF PIPING, ELECTRICAL AND FOR THE INSTALLATION OF SUPPORT BLOCKING AND MECHANICAL EQUIPMENT. PATCH BACK TO MATCH ADJACENT SURFACE.
2. REFER TO MECHANICAL, PLUMBING, ELECTRICAL AND FIRE ALARM DRAWINGS FOR ADDITIONAL SCOPE OF WORK IN EACH ROOM.
3. ALL WALLS SHALL BE FULL HEIGHT TO THE ROOF DECK UNLESS NOTED OTHERWISE, AND SHALL BE CLOSED AND SEALED PER WALL TYPE AND AS DETAILED ON A711.
4. UNSCHEDULED CUTTING, REMOVING OR TRIMMING OF EXISTING CONCRETE, MASONRY OR WOOD FRAMED WALLS IS NOT PERMITTED, UNLESS NOTED OTHERWISE ALL DOORS SHALL BE FITTED WITHIN EXISTING WALL OPENINGS WITHOUT ENLARGING OR TRIMMING HEAD OR JAMBS.

DEMOLITION KEYNOTES

NO.	DESCRIPTION
120	REMOVE EXISTING MECHANICAL EQUIPMENT AND APPURTENANCES. SEE MECHANICAL, ELECTRICAL AND PLUMBING DRAWINGS FOR ADDITIONAL INFORMATION.
155	MECHANICAL DUCT PENETRATION AT EXISTING ROOF. SEE MECHANICAL AND DETAIL X/A831 FOR ADDITIONAL INFORMATION.

KEYNOTES

NO.	DESCRIPTION
221	MECHANICAL EQUIPMENT. SEE MECHANICAL AND ELECTRICAL FOR ADDITIONAL INFORMATION.

FLOOR PLAN LEGEND

SYMBOL	DESCRIPTION
	(E) WOOD STUD WALL OR PARTITION TO REMAIN.
	METAL STUD WALL ASSEMBLY. REFER TO WALL TYPE AND TYPICAL DETAILS ON A711 FOR MORE INFORMATION.
	NEW DOOR AND FRAME. SEE DOOR SCHEDULE ON A611 FOR MORE INFORMATION.
	WALL TYPE. SEE A711 FOR MORE INFORMATION.

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Architect




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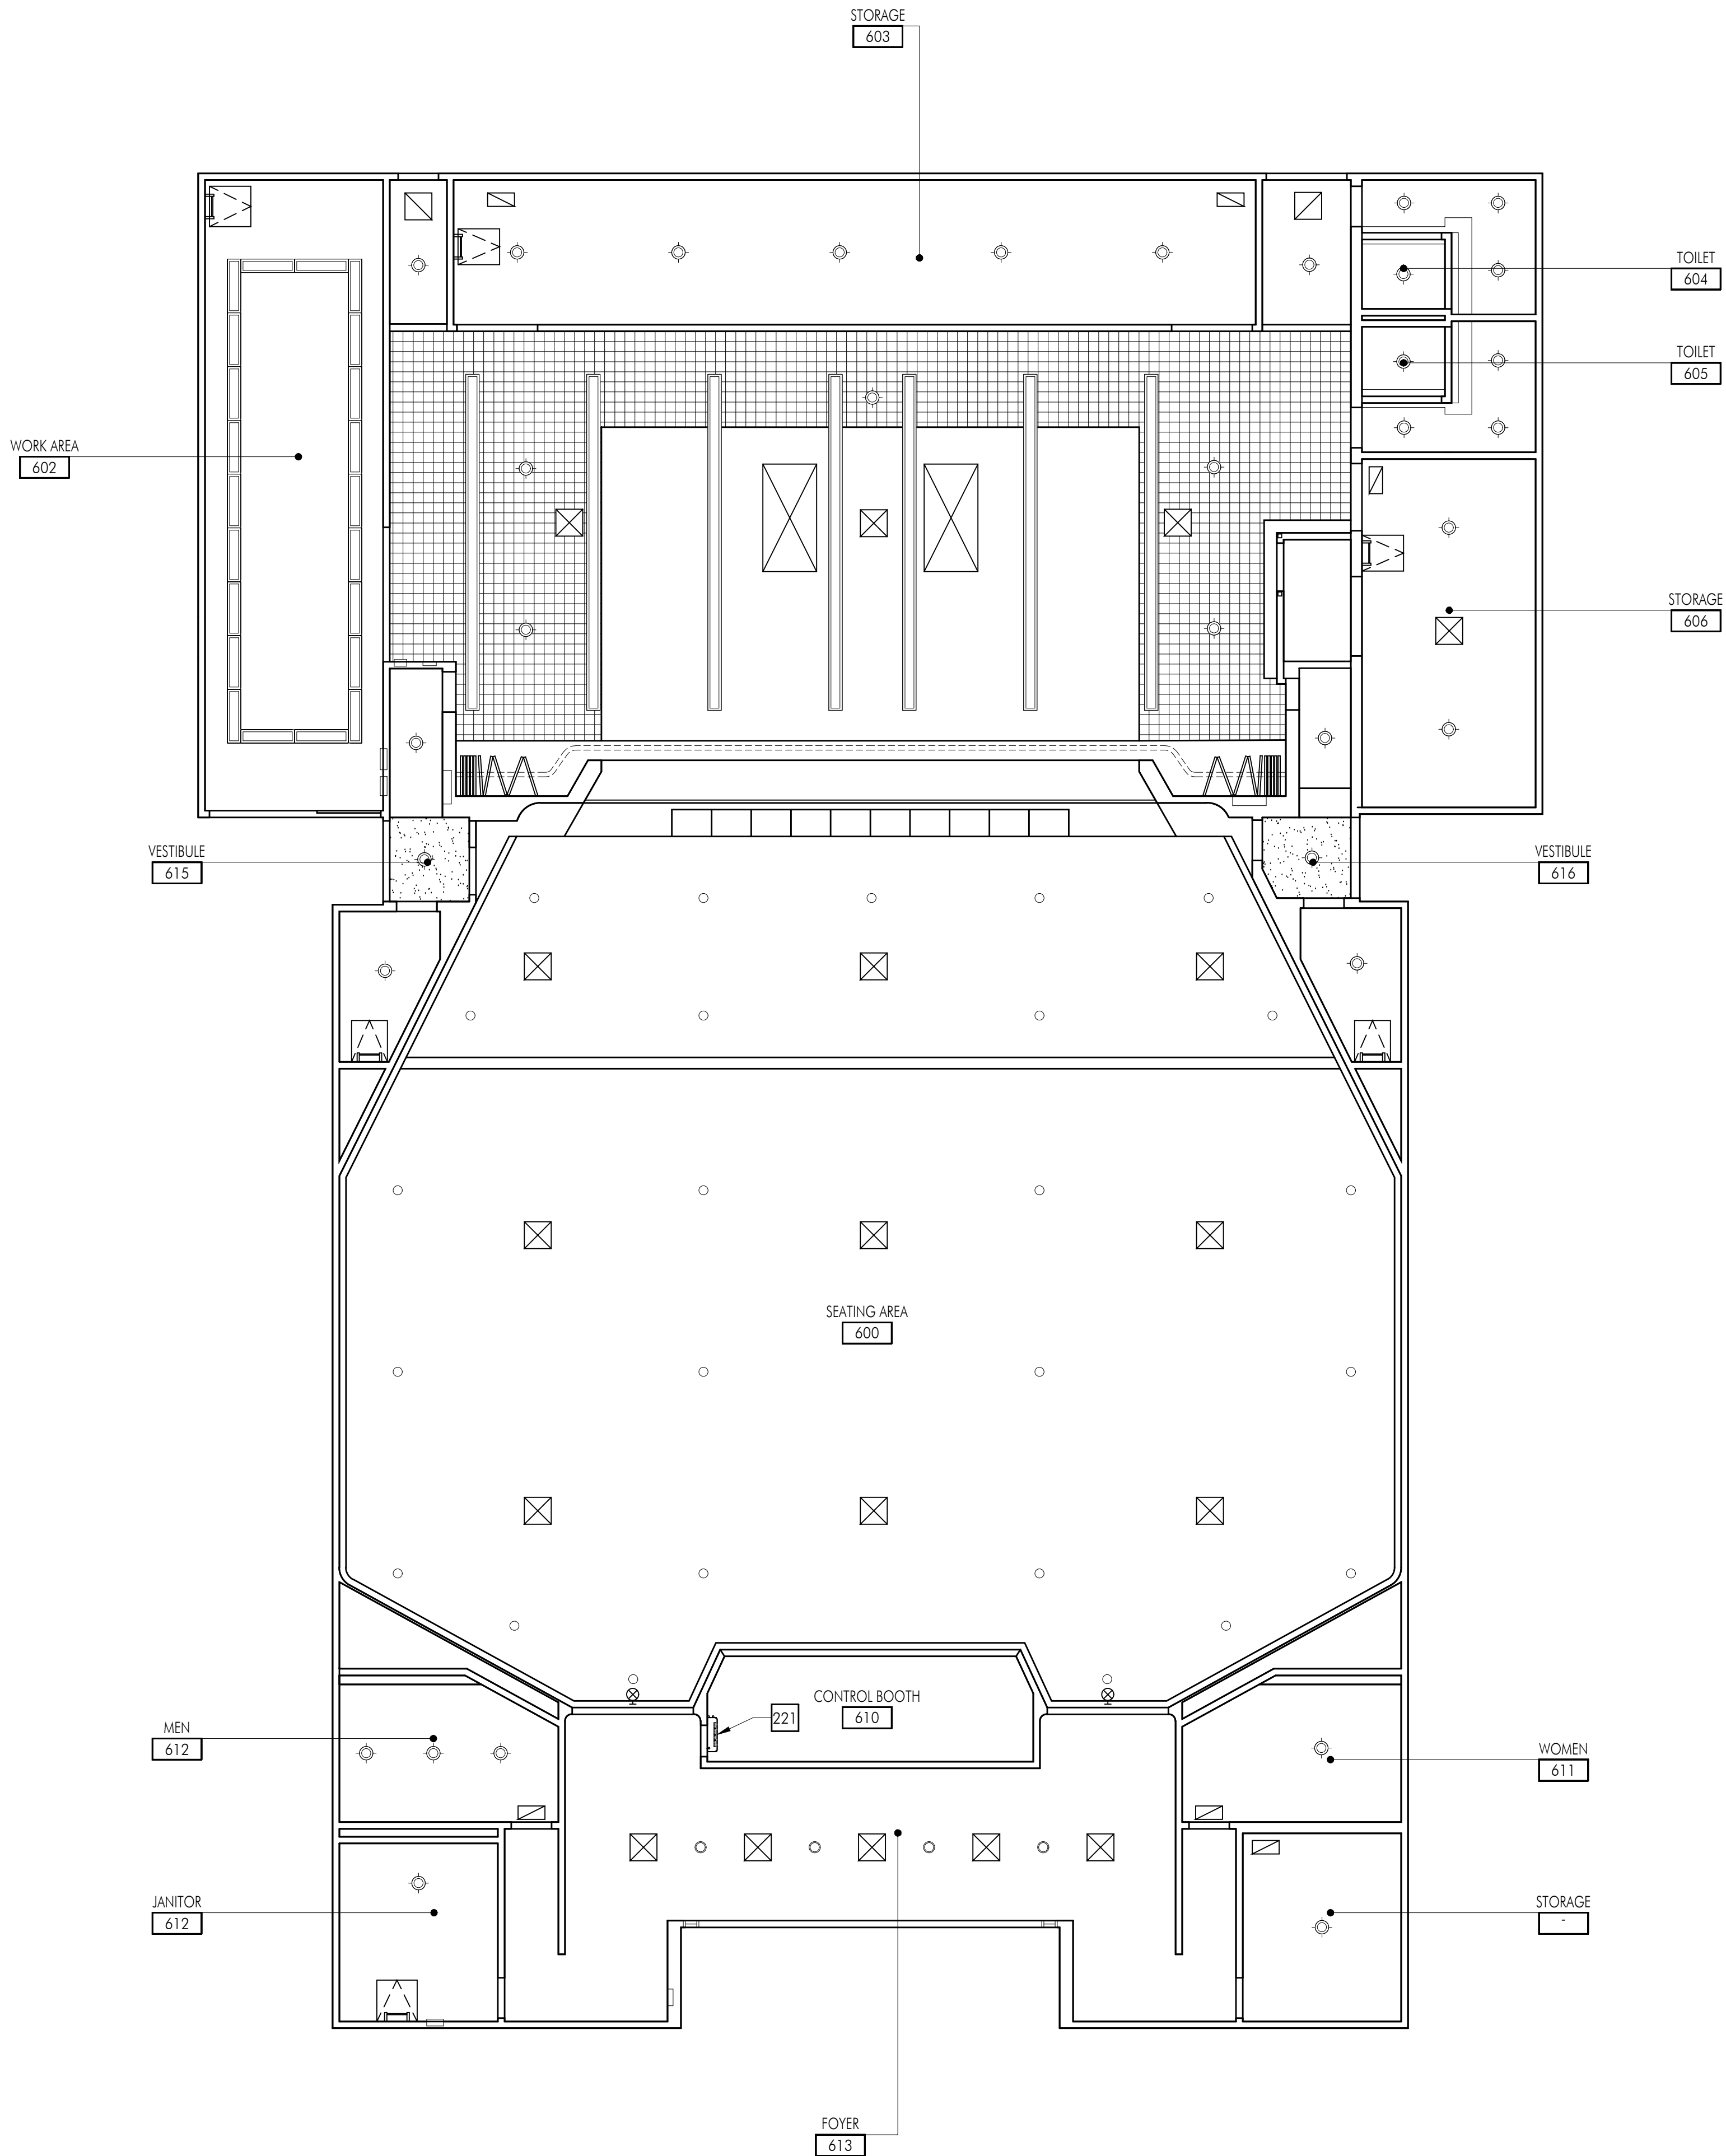
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Sheet Title
Building 'B' Mezzanine
Floor Plan and
Demolition Floor Plan

Sheet Number

AB212

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FLOOR PLAN GENERAL NOTES

1. REMOVE EXISTING GYPSUM BOARD, TILE AND BACKER BOARD OR PLASTER TO ACCOMMODATE REMOVAL AND REPLACEMENT OF PIPING, ELECTRICAL AND FOR THE INSTALLATION OF SUPPORT BLOCKING AND MECHANICAL EQUIPMENT. PATCH BACK TO MATCH ADJACENT SURFACE.
2. REFER TO MECHANICAL, PLUMBING, ELECTRICAL AND FIRE ALARM DRAWINGS FOR ADDITIONAL SCOPE OF WORK IN EACH ROOM.
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KEYNOTES

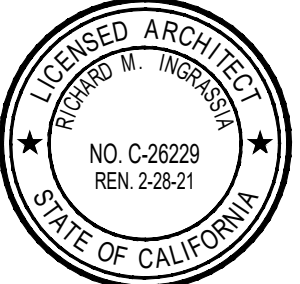NO.	DESCRIPTION
221	MECHANICAL EQUIPMENT. SEE MECHANICAL AND ELECTRICAL FOR ADDITIONAL INFORMATION

FLOOR PLAN LEGEND

SYMBOL	DESCRIPTION
	(E) WOOD STUD WALL OR PARTITION TO REMAIN.
	METAL STUD WALL ASSEMBLY. REFER TO WALL TYPE AND TYPICAL DETAILS ON A711 FOR MORE INFORMATION
	EXISTING SUSPENDED T-BAR CEILING SYSTEM TO REMAIN, UNLESS NOTED OTHERWISE.
	EXISTING GLUE ON ACOUSTIC TILE TO REMAIN, UNLESS NOTED OTHERWISE.
	EXISTING LIGHT FIXTURE TO REMAIN. SEE ELECTRICAL FOR MORE INFORMATION
	RELOCATED LIGHT FIXTURE. SEE ELECTRICAL FOR MORE INFORMATION.
	FRAMED GYPSUM BOARD CEILING SEE XXXX FOR ADDITIONAL INFORMATION AND REFERENCED DETAIL ON PLAN FOR SOFFIT CONDITIONS AS OCCURS. PAINT P-1
	AIR SUPPLY REGISTER
	RETURN AIR GRILLE
	EXHAUST GRILLE

APPL. No. A 00-123456

DSA Stamp

Architect




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Lincoln Middle School HVAC Replacement Project
Lincoln Middle School
1501 California Avenue
Santa Monica, California 90403

Rev	Date	Issue
1	11.27.19	50% CD's

Date: 11.27.2019
Scale: As Shown
Drawn By: DH, RM
Checked By: RI

Architect / Engineer Stamp

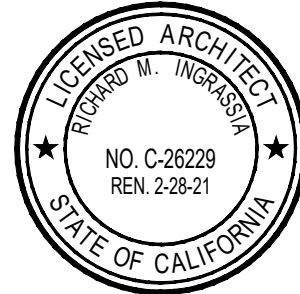

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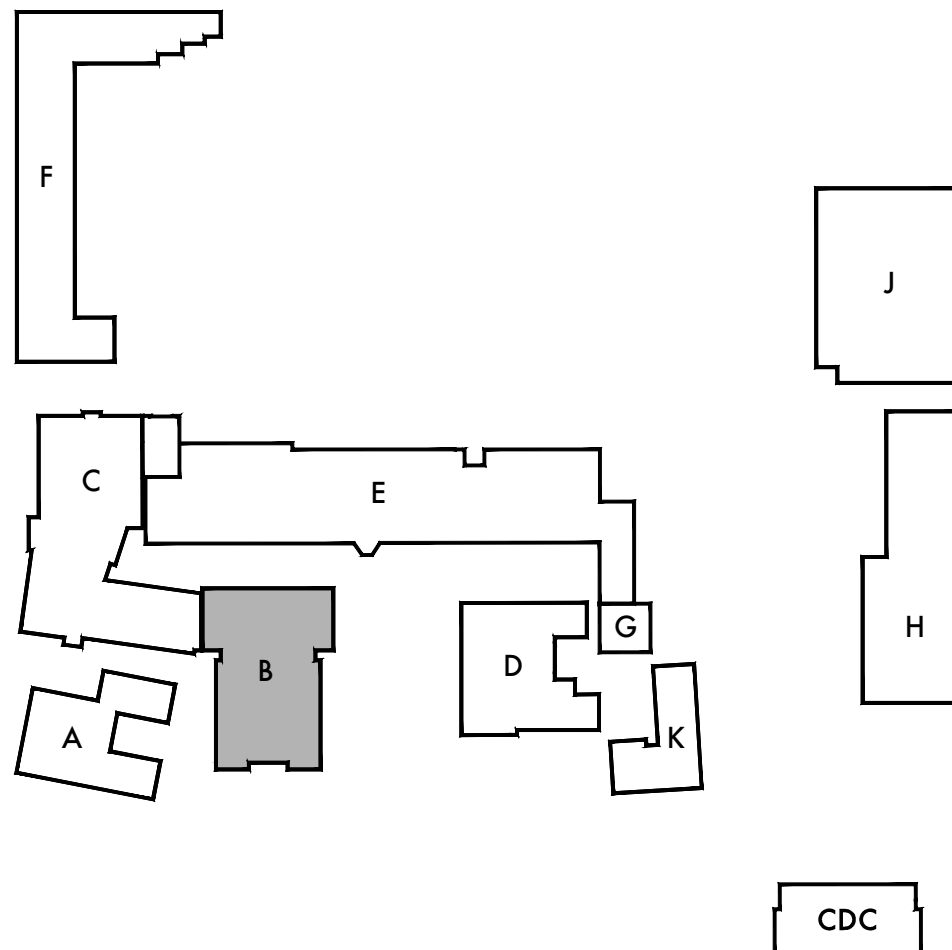
Sheet Title
Building 'B' Reflected Ceiling Plan

Sheet Number

AB231




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KEY PLAN

Plot Date: 11/27/2019 12:14:35 PM User: Rudy Monica G:\Projects\School District\Santa Monica MLSD\SMMLSD - LVS HVAC\SMMLSD LVS Drawings\01 Architectural\SMMLSD-LVS-AC211.dwg Login: Rudy Monica Last Save By: dharrilton Last Save: 11/27/2019 12:14:35 PM

NOTE:
FIRE ALARM WORK ONLY ON LEVEL 1 OF BUILDING C.
SEE ELECTRICAL AND FIRE ALARM DRAWINGS FOR MORE INFORMATION



FLOOR PLAN GENERAL NOTES

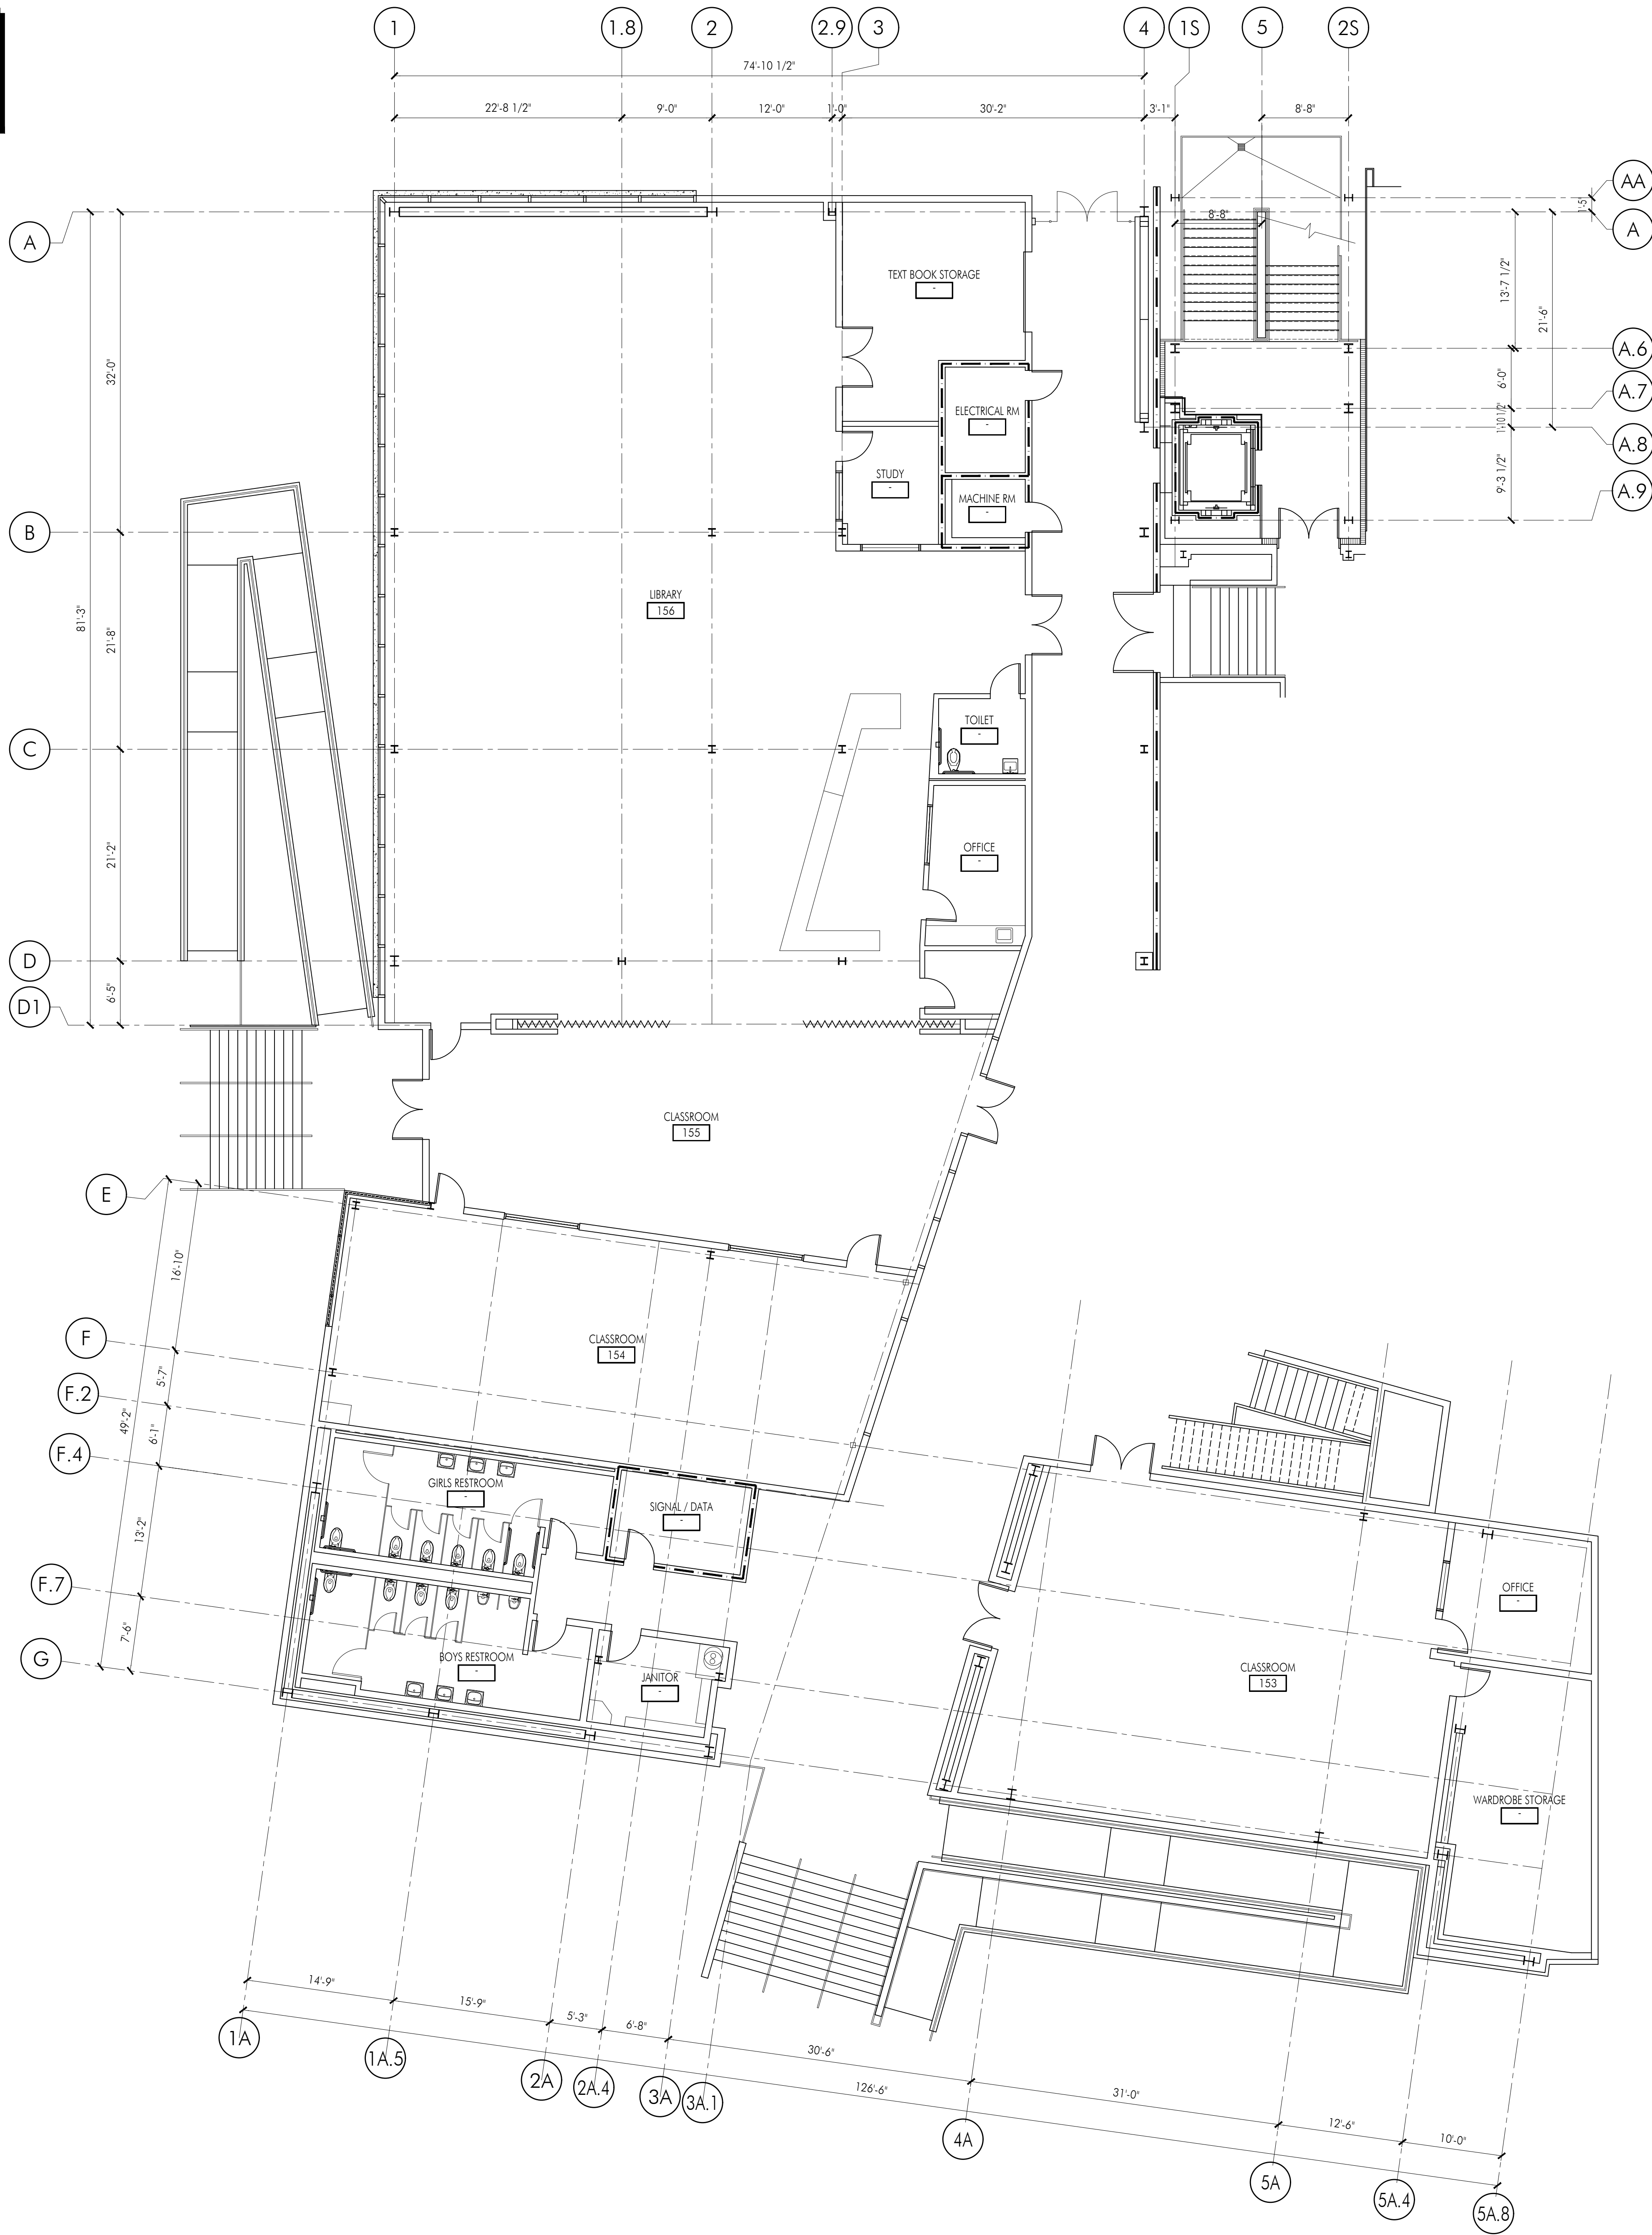1. REMOVE EXISTING GYPSUM BOARD, TILE AND BACKER BOARD OR PLASTER TO ACCOMMODATE REMOVAL AND REPLACEMENT OF PIPING, ELECTRICAL AND FOR THE INSTALLATION OF SUPPORT BLOCKING AND MECHANICAL EQUIPMENT. PATCH BACK TO MATCH ADJACENT SURFACE.
2. REFER TO MECHANICAL, PLUMBING, ELECTRICAL AND FIRE ALARM DRAWINGS FOR ADDITIONAL SCOPE OF WORK IN EACH ROOM.
3. ALL WALLS SHALL BE FULL HEIGHT TO THE ROOF DECK UNLESS NOTED OTHERWISE, AND SHALL BE CLOSED AND SEALED PER WALL TYPE AND AS DETAILED ON A711.
4. UNSCHEDULED CUTTING, REMOVING OR TRIMMING OF EXISTING CONCRETE, MASONRY OR WOOD FRAMED WALLS IS NOT PERMITTED. UNLESS NOTED OTHERWISE ALL DOORS SHALL BE FITTED WITHIN EXISTING WALL OPENINGS WITHOUT ENLARGING OR TRIMMING HEAD OR JAMBS.

APPL. No. A 00-123456

DSA Stamp

Architect



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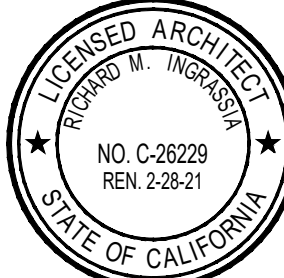
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Lincoln Middle School HVAC Replacement Project
Lincoln Middle School
1501 California Avenue
Santa Monica, California 90403

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Checked By: RL

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Sheet Title


Building 'C1' First
Floor Plan

Sheet Number

AC211




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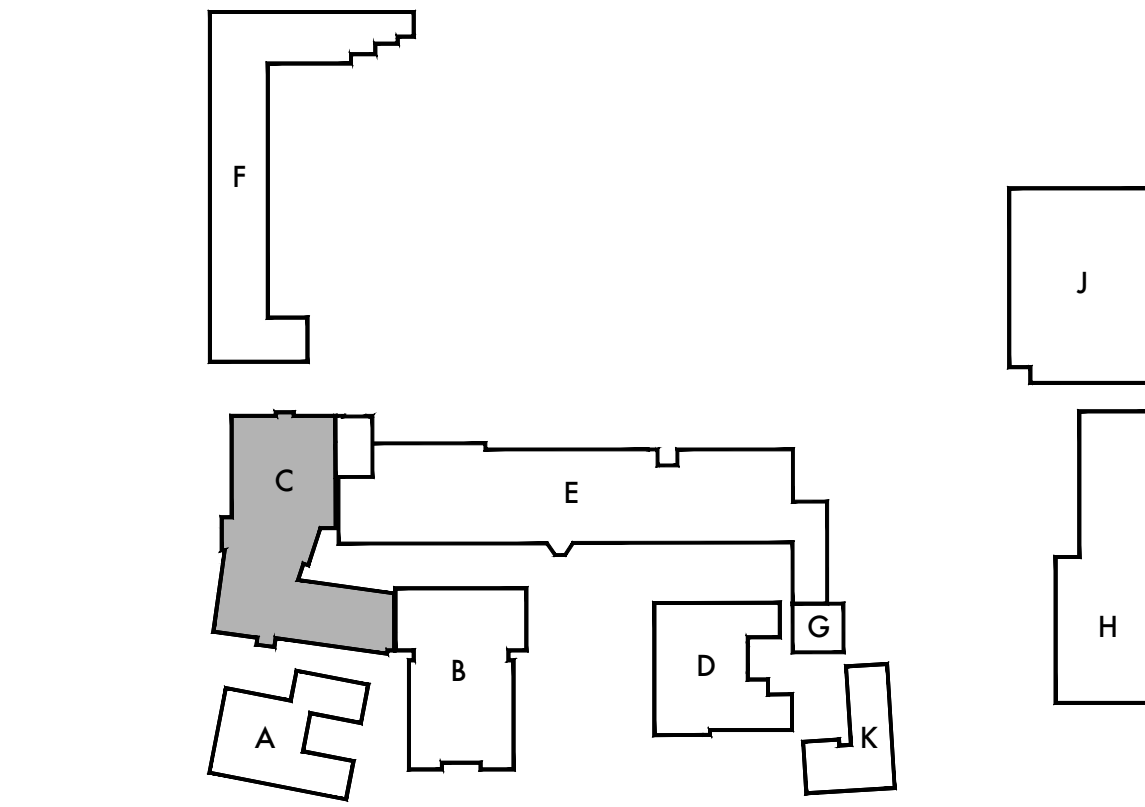


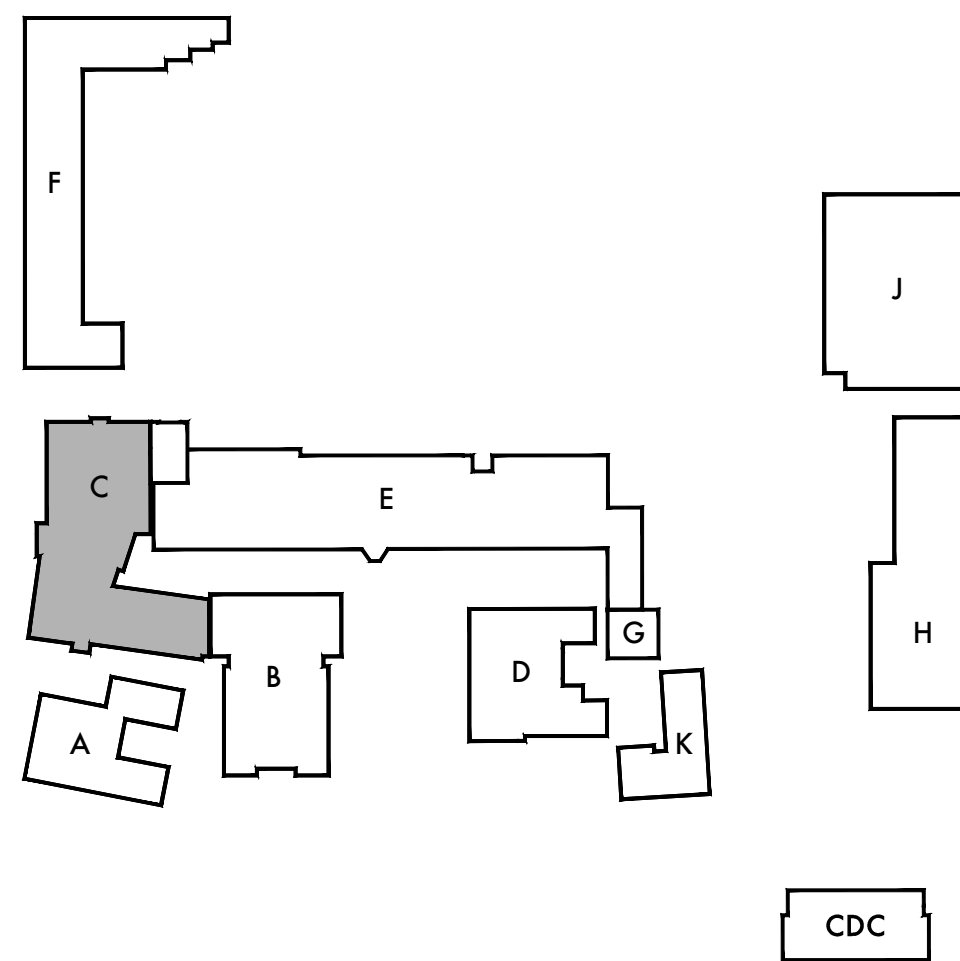KEY PLAN

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SCALE: 1/8"=1'-0"

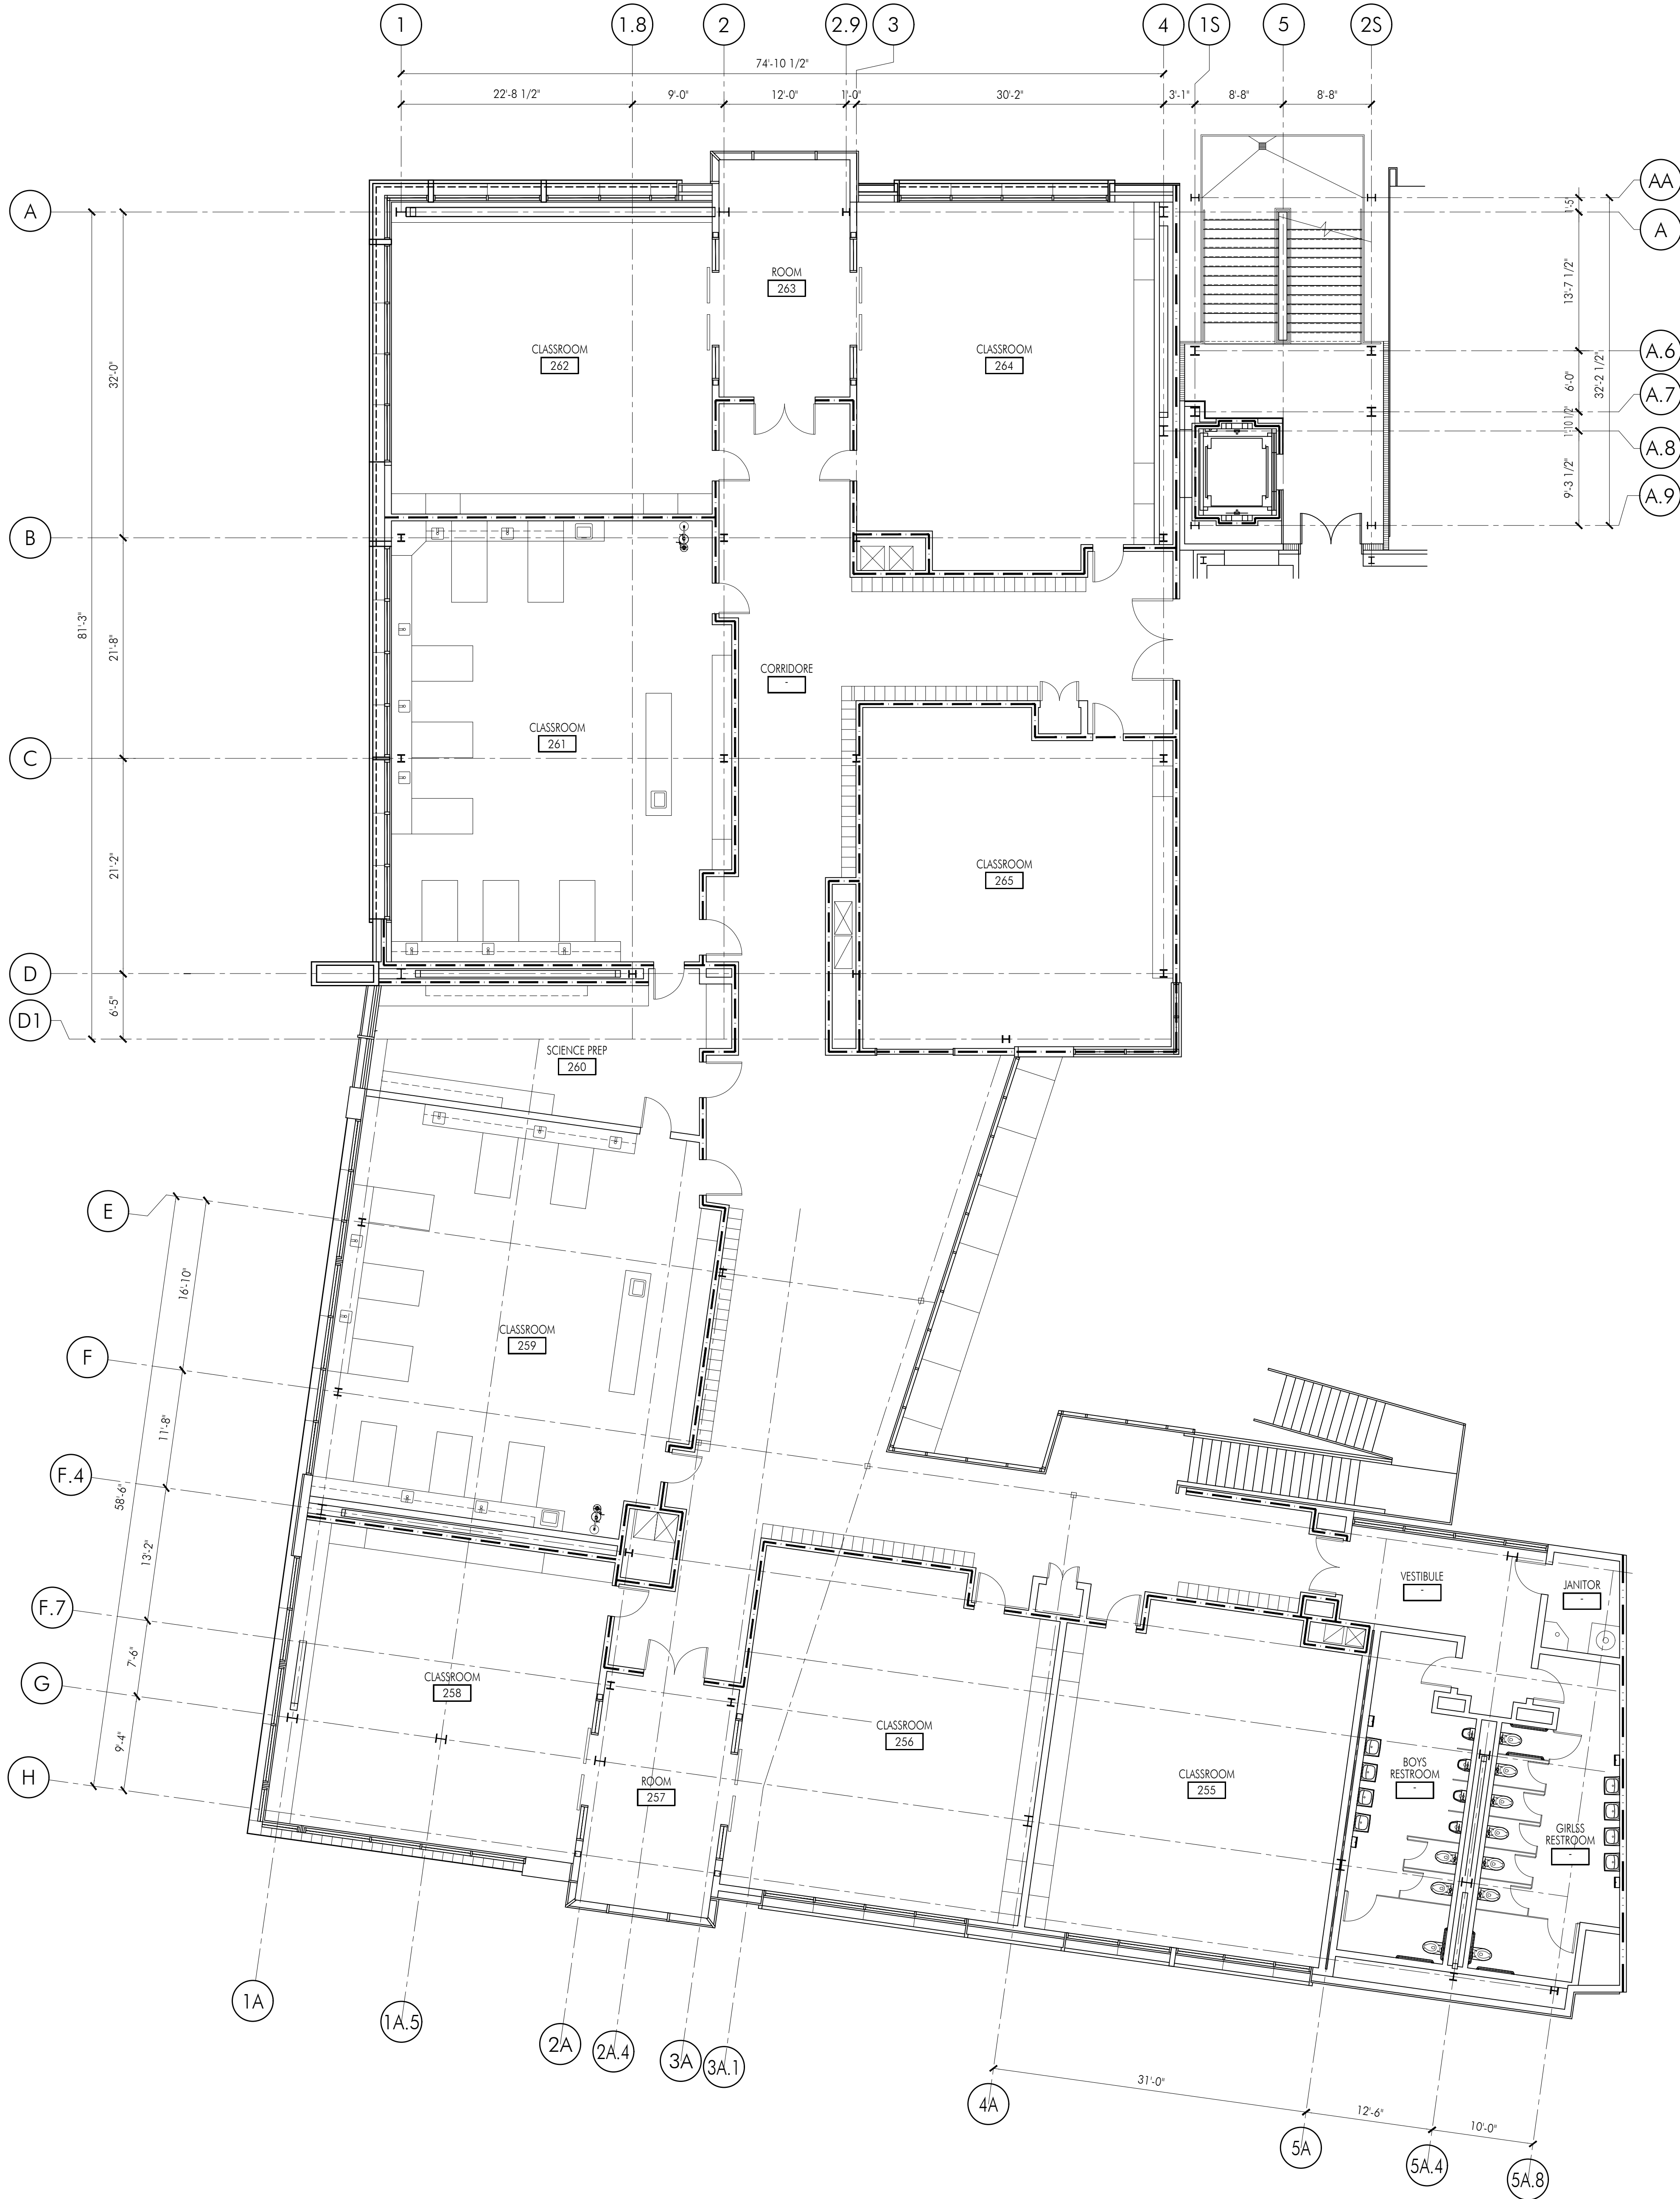

KEY PLAN

FLOOR PLAN GENERAL NOTES

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4. UNSCHEDULED CUTTING, REMOVING OR TRIMMING OF EXISTING CONCRETE, MASONRY OR WOOD FRAMED WALLS IS NOT PERMITTED, UNLESS NOTED OTHERWISE ALL DOORS SHALL BE FITTED WITHIN EXISTING WALL OPENINGS WITHOUT ENLARGING OR TRIMMING HEAD OR JAMBS.

KEYNOTES

NO.	DESCRIPTION
201	MECHANICAL CLOSET SEE WALL TYPE AS REFERENCED AND PLAN FOR DIMENSIONS. SEE MECHANICAL DRAWINGS FOR MORE INFORMATION.
220	MECHANICAL CONDENSER UNIT ON CONCRETE PAD. PROVIDE CONCRETE PAD AS REQUIRED FOR NUMBER OF CONDENSER UNITS AT EACH LOCATION. SEE MECHANICAL AND DETAIL X/A811 FOR ADDITIONAL INFORMATION.
221	MECHANICAL EQUIPMENT. SEE MECHANICAL AND ELECTRICAL FOR ADDITIONAL INFORMATION.
222	MECHANICAL REGISTER AT +10'-6" ABOVE FINISH FLOOR. SEE MECHANICAL AND ELECTRICAL FOR ADDITIONAL INFORMATION. (REVIEW LOCATION IN THE FIELD WITH ARCHITECT PRIOR TO COMPLETING WORK)

FLOOR PLAN LEGEND

SYMBOL	DESCRIPTION
	(E) WOOD STUD WALL OR PARTITION TO REMAIN.
	METAL STUD WALL ASSEMBLY. REFER TO WALL TYPE AND TYPICAL DETAILS ON A711 FOR MORE INFORMATION.
	NEW DOOR AND FRAME. SEE DOOR SCHEDULE ON A611 FOR MORE INFORMATION.
	WALL TYPE. SEE A711 FOR MORE INFORMATION.

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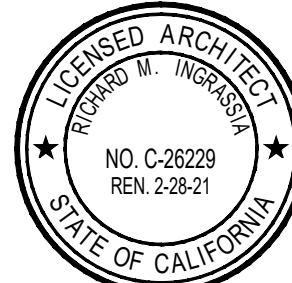
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Lincoln Middle School HVAC Replacement Project
Lincoln Middle School
1501 California Avenue
Santa Monica, California 90403

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Checked By: RI

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Consultants

Sheet Title
Building 'C1' Second
Floor Plan


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AC212

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SCALE: 1/8"=1'-0"



KEY PLAN

FLOOR PLAN GENERAL NOTES
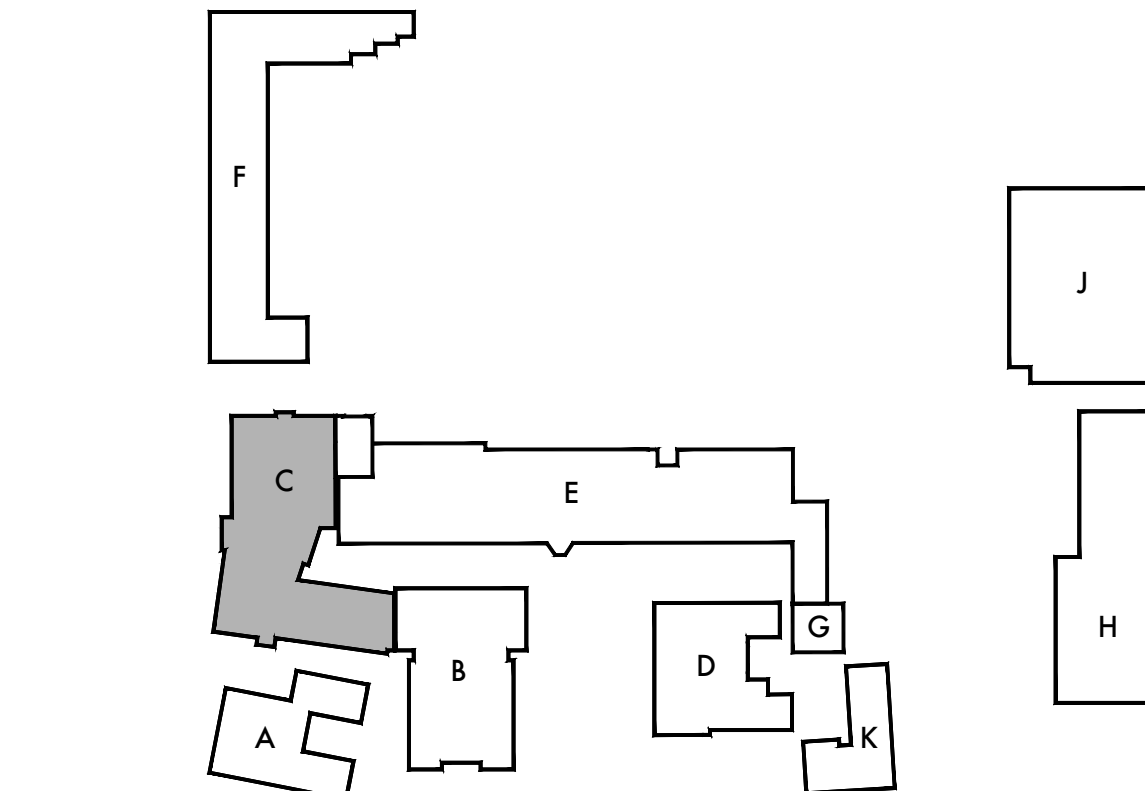
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KEYNOTES

NO.	DESCRIPTION
271	EXPOSED DUCT, SEE MECHANICAL FOR MORE INFORMATION.

APPL. No. A 00-123456

DSA Stamp

Architect



8640 National Boulevard
Culver City, CA 90232
310.204.3400


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Lincoln Middle School HVAC Replacement Project
Lincoln Middle School
1501 California Avenue
Santa Monica, California 90403

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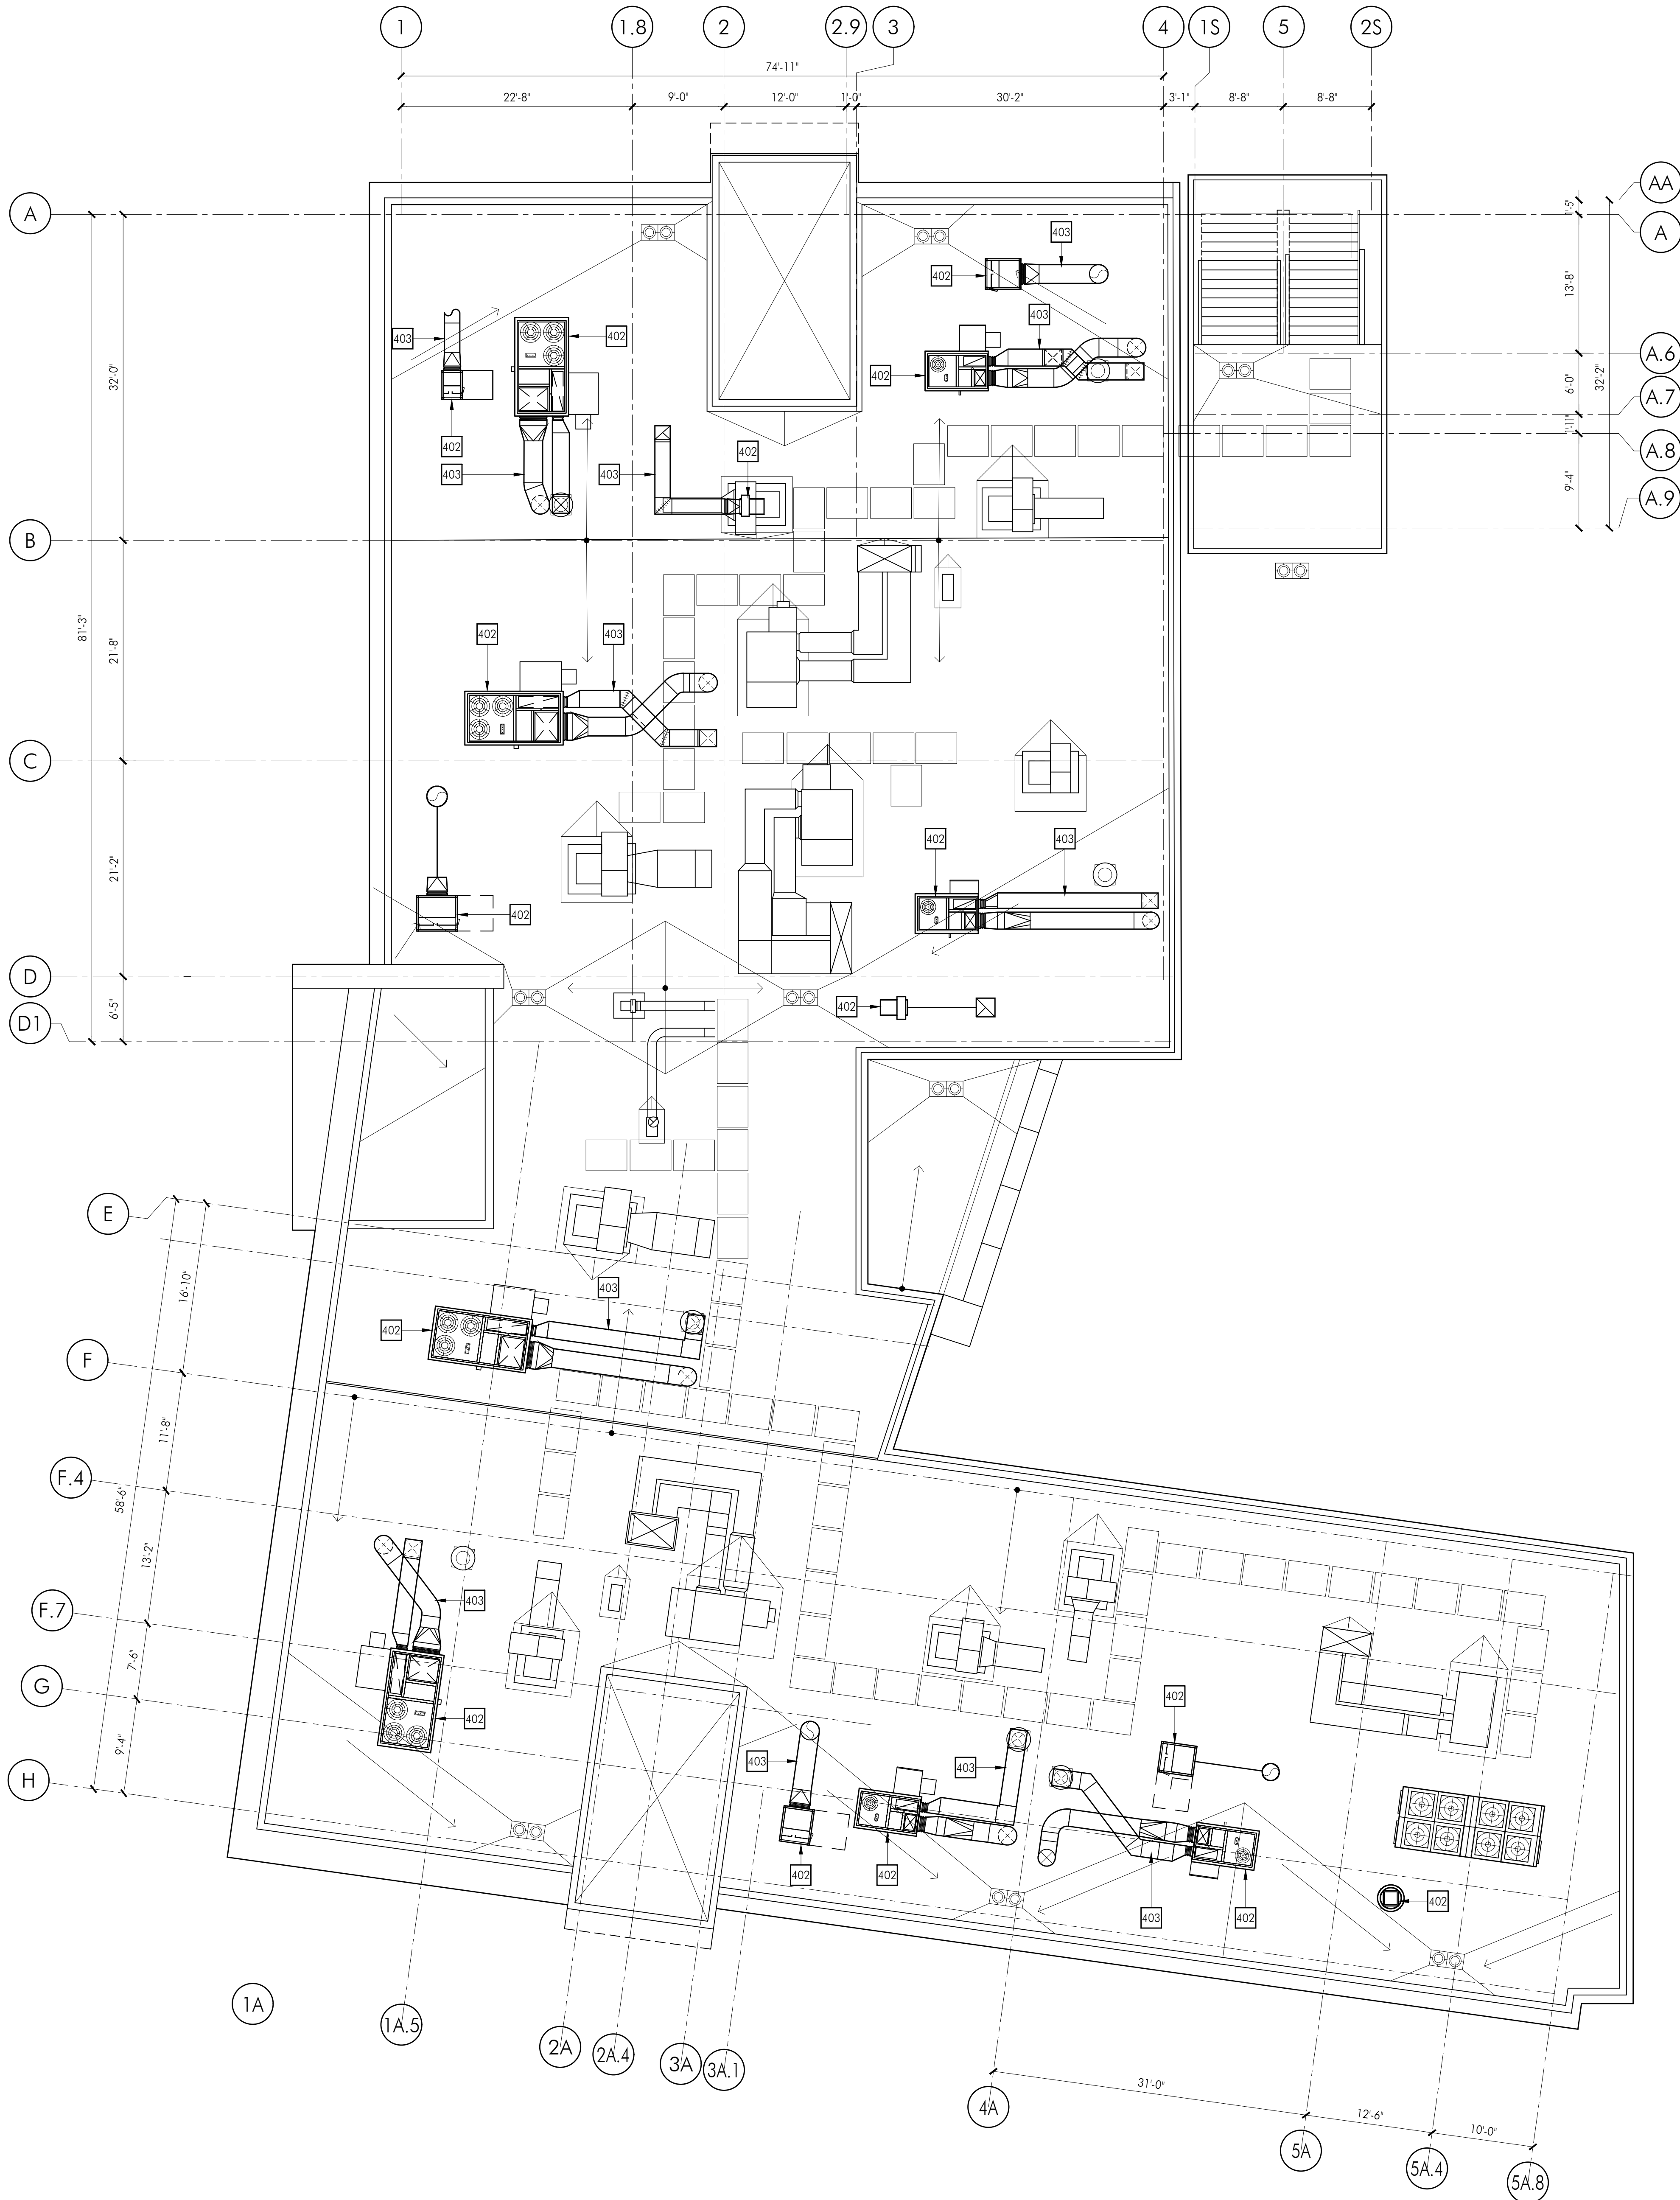
Consultants

Sheet Title
Building 'C1' Second
Floor Reflected
Ceiling Plan

Sheet Number

AC232
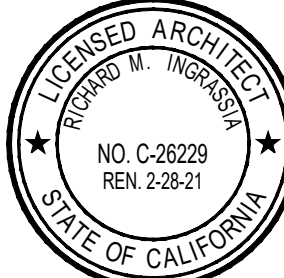
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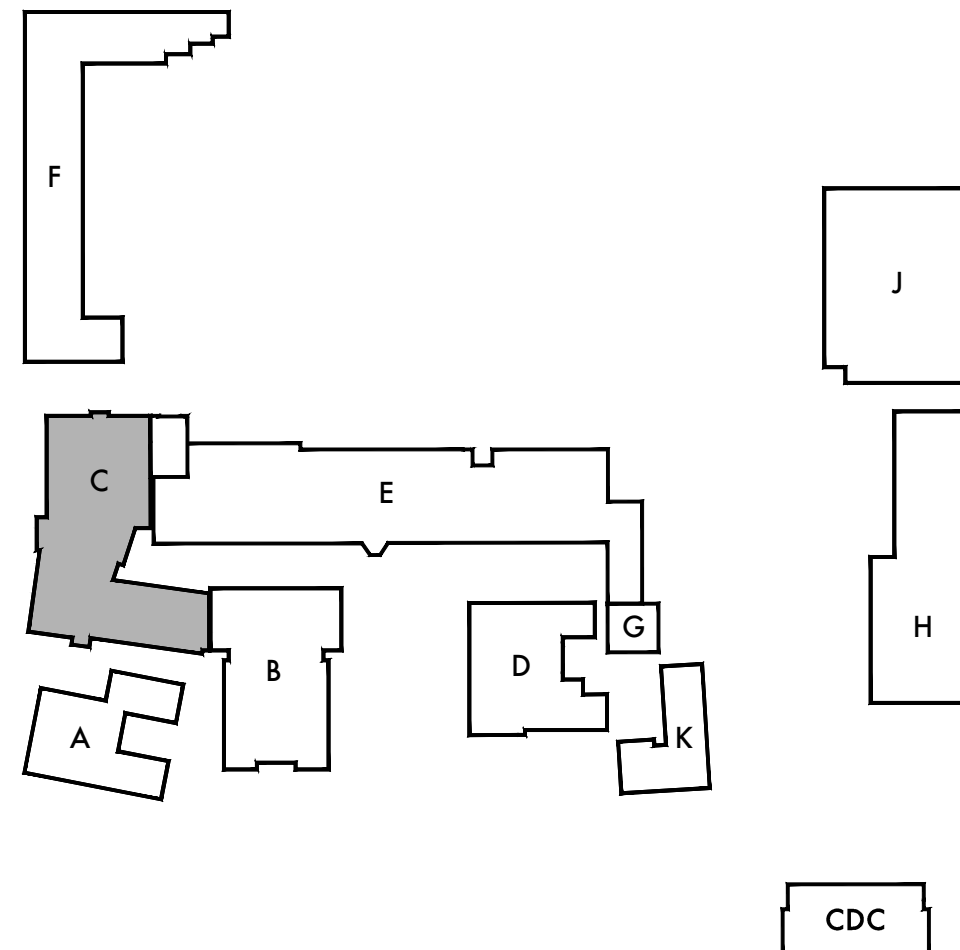


FLOOR PLAN GENERAL NOTES

1. REMOVE EXISTING GYPSUM BOARD, TILE AND BACKER BOARD OR PLASTER TO ACCOMMODATE REMOVAL AND REPLACEMENT OF PIPING, ELECTRICAL AND FOR THE INSTALLATION OF SUPPORT BLOCKING AND MECHANICAL EQUIPMENT. PATCH BACK TO MATCH ADJACENT SURFACE.
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KEYNOTES

NO.	DESCRIPTION
402	ROOF MOUNTED MECHANICAL UNIT. SEE MECHANICAL AND DETAIL X/A831 FOR ADDITIONAL INFORMATION.
403	ROOF MOUNTED MECHANICAL DUCT. SEE MECHANICAL AND DETAIL X/A831 FOR ADDITIONAL INFORMATION.



KEY PLAN

DSA Stamp

Architect




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Lincoln Middle School
1501 California Avenue
Santa Monica, California 90403

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Checked By: RL

Architect / Engineer Stamp



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Sheet Title
Building 'C1' Roof Plan

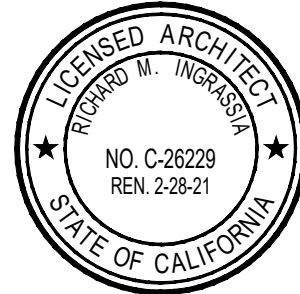
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AC241

1. REMOVE EXISTING GYPSUM BOARD, TILE AND BACKER BOARD OR PLASTER TO ACCOMMODATE REMOVAL AND REPLACEMENT OF PIPING, ELECTRICAL AND FOR THE INSTALLATION OF SUPPORT BRACKETS AND MECHANICAL EQUIPMENT. PATCH BACK TO MATCH ADJACENT SURFACE.
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Architect



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<u>NO.</u>	<u>DESCRIPTION</u>
103	REMOVE EXISTING INTERIOR WALL FINISHES (INCLUDING BUT NOT LIMITED TO [SINGULARLY OR IN ANY COMBINATION] PLASTER, GYPSUM BOARD, ACOUSTIC TILE, TACKABLE SURFACE ETC.) DOWN TO STUDS (OR STRUCTURE AS OCCURS) IN PREPARATION FOR INSTALLATION OF NEW WALL AND FINISHES. PROTECT ADJACENT UNAFFECTED FINISHES, PATCH AND REPAIR AT REMOVAL AND PREPARE ADJACENT SURFACES FOR NEW WORK.
104	REMOVE PORTION OF EXISTING FLOOR AS REQUIRED FOR INSTALLATION OF NEW MECHANICAL CLOSET FRAMING AND EQUIPMENT. PATCH AND REPAIR AT REMOVAL AND PREPARE ADJACENT SURFACES FOR NEW WORK.
105	REMOVE PORTION OF [E] CEILING AS REQUIRED FOR INSTALLATION OF NEW MECHANICAL CLOSET, MECHANICAL EQUIPMENT AND ALL ASSOCIATED DUCTWORK AND APPEARANCES. PATCH REPAIR AND PAINT AT ALL REMOVALS TO MATCH EXISTING ADJACENT FINISHES AND IN PREPARATION FOR NEW WORK.
106	MECHANICAL DUCT PENETRATION AT EXISTING ROOF. SEE MECHANICAL AND DETAIL X/A83.1 FOR ADDITIONAL INFORMATION.

<u>NO.</u>	<u>DESCRIPTION</u>
103	REMOVE EXISTING INTERIOR WALL FINISHES (INCLUDING BUT NOT LIMITED TO [SINGULARLY OR IN ANY COMBINATION] PLASTER, GYPSUM BOARD, ACOUSTIC TILE, TACKABLE SURFACE ETC.) DOWN TO STUDS (OR STRUCTURE AS OCCURS) IN PREPARATION FOR INSTALLATION OF NEW WALL AND FINISHES. PROTECT ADJACENT UNAFFECTED FINISHES, PATCH AND REPAIR AT REMOVAL AND PREPARE ADJACENT SURFACES FOR NEW WORK.
104	REMOVE PORTION OF EXISTING FLOOR AS REQUIRED FOR INSTALLATION OF NEW MECHANICAL CLOSET FRAMING AND EQUIPMENT. PATCH AND REPAIR AT REMOVAL AND PREPARE ADJACENT SURFACES FOR NEW WORK.
105	REMOVE PORTION OF [E] CEILING AS REQUIRED FOR INSTALLATION OF NEW MECHANICAL CLOSET, MECHANICAL EQUIPMENT AND ALL ASSOCIATED DUCTWORK AND APPEARANCES. PATCH REPAIR AND PAINT AT ALL REMOVALS TO MATCH EXISTING ADJACENT FINISHES AND IN PREPARATION FOR NEW WORK.
106	MECHANICAL DUCT PENETRATION AT EXISTING ROOF. SEE MECHANICAL AND DETAIL X/A83.1 FOR ADDITIONAL INFORMATION.

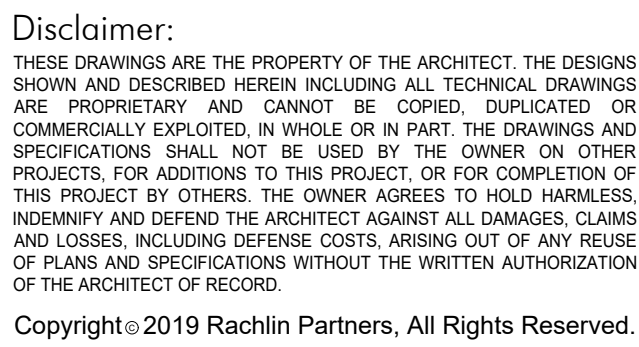

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SCALE: 1/8"=1'-0"




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Lincoln Middle School
1501 California Avenue
Santa Monica, California 90403

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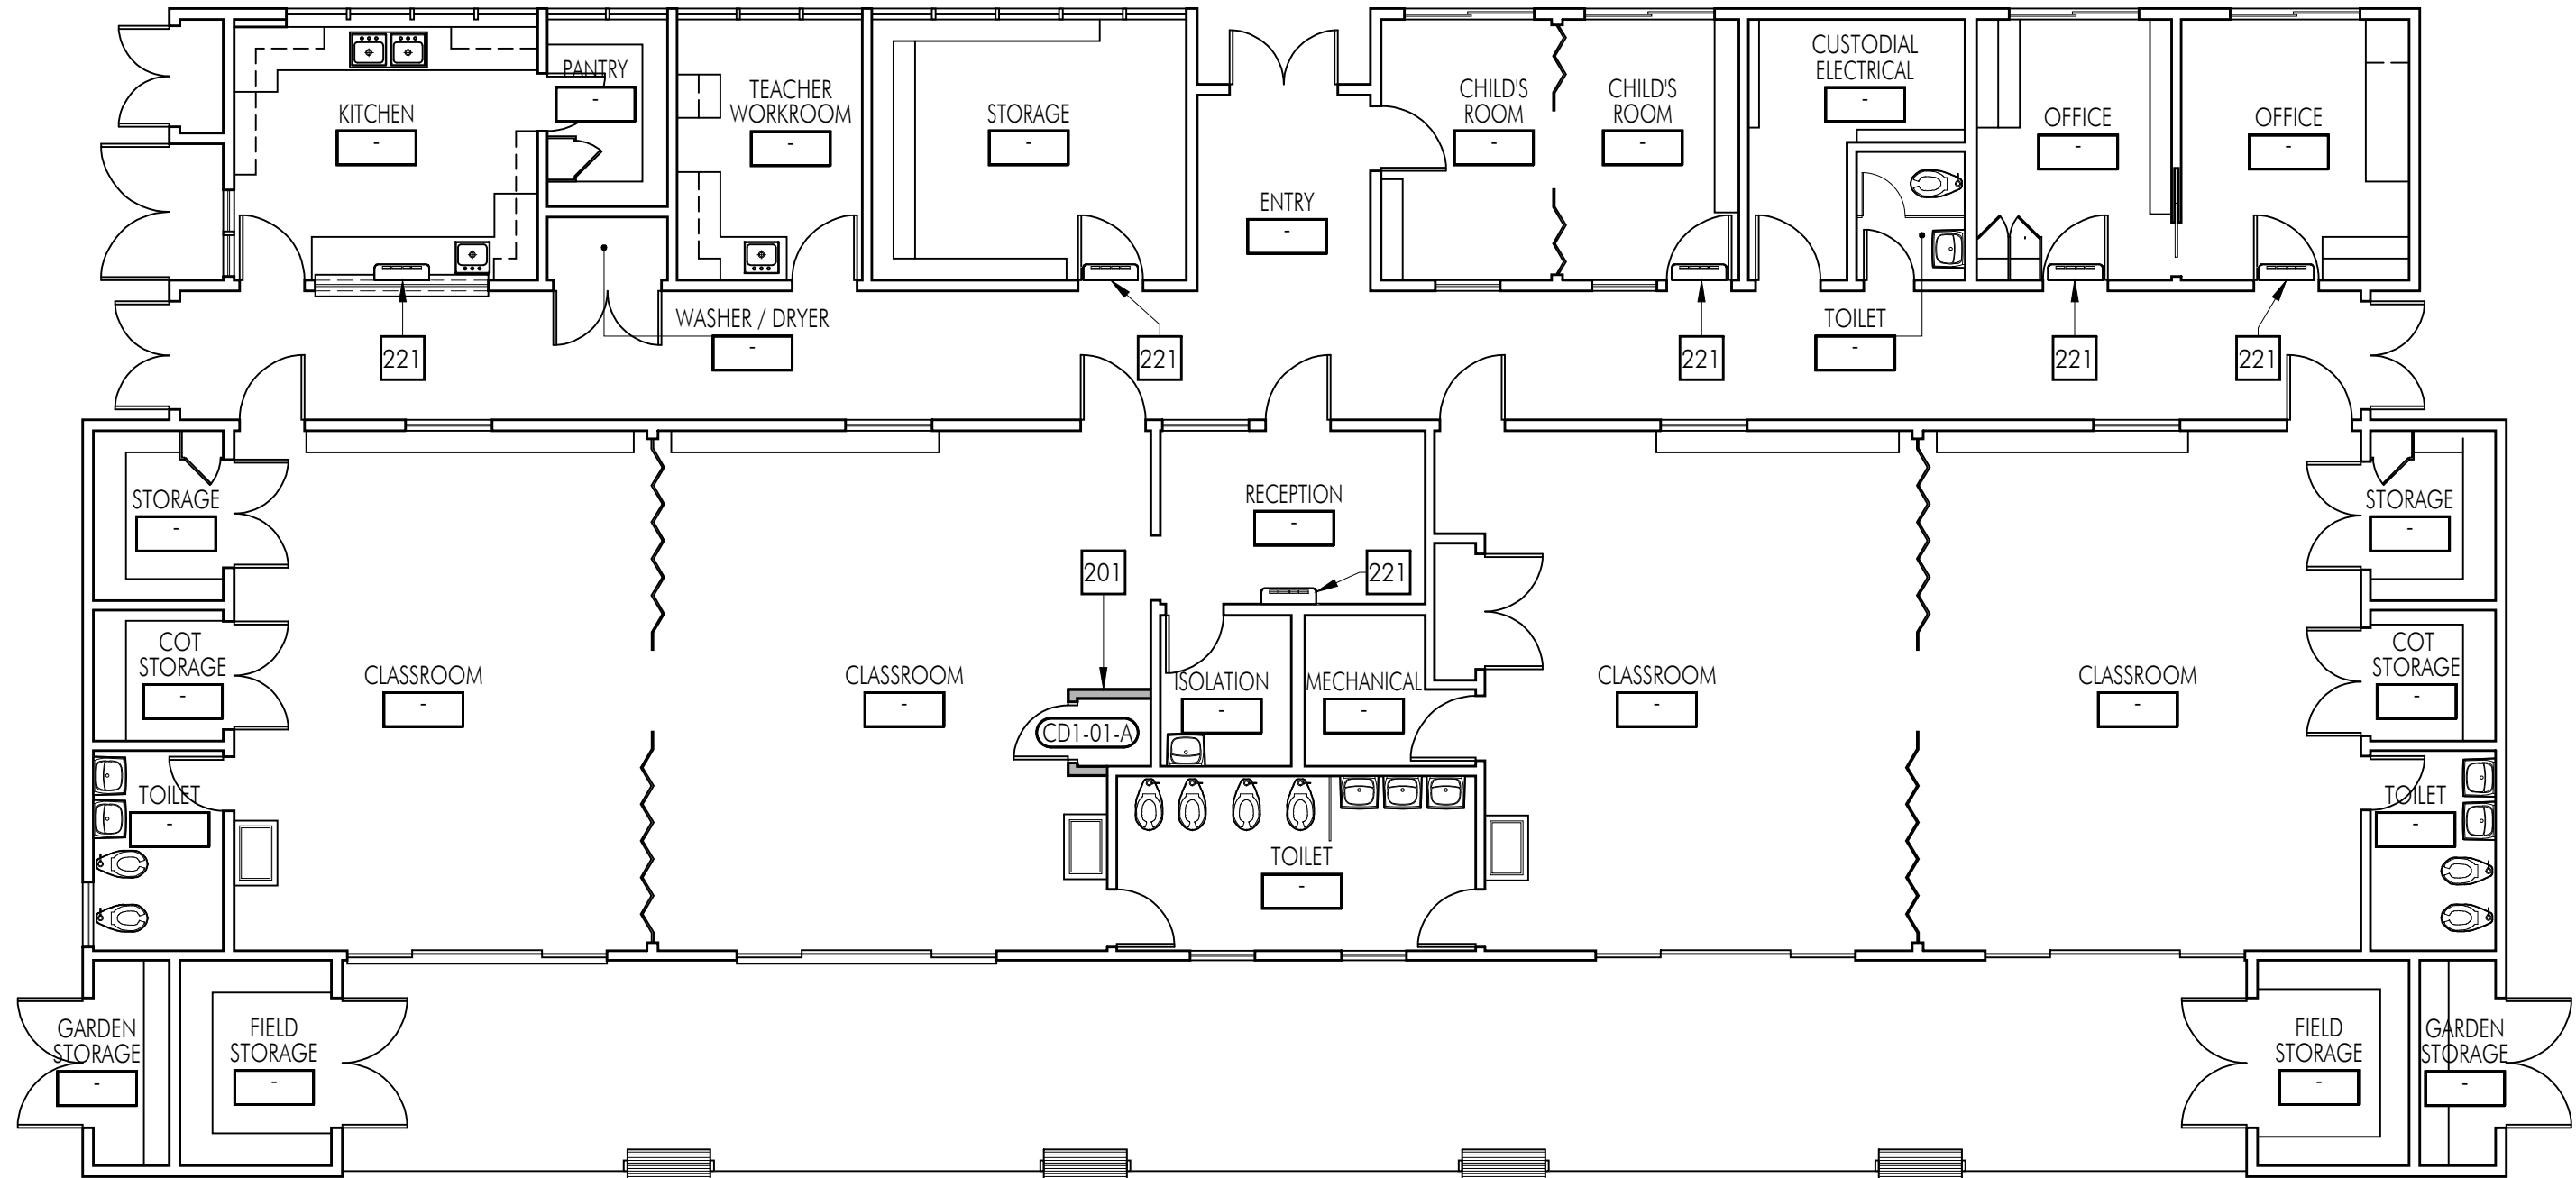
Child Development
Center (CDC)
Demolition Floor and
Reflected Ceiling Plans

Sheet Number


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SCALE: 1/8"=1'-0"

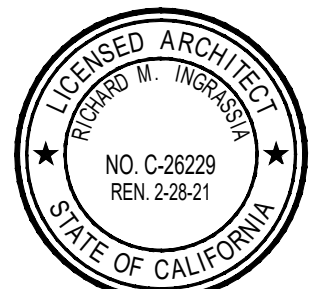

SCALE: 1/8"=1'-0"



FLOOR PLAN GENERAL NOTES
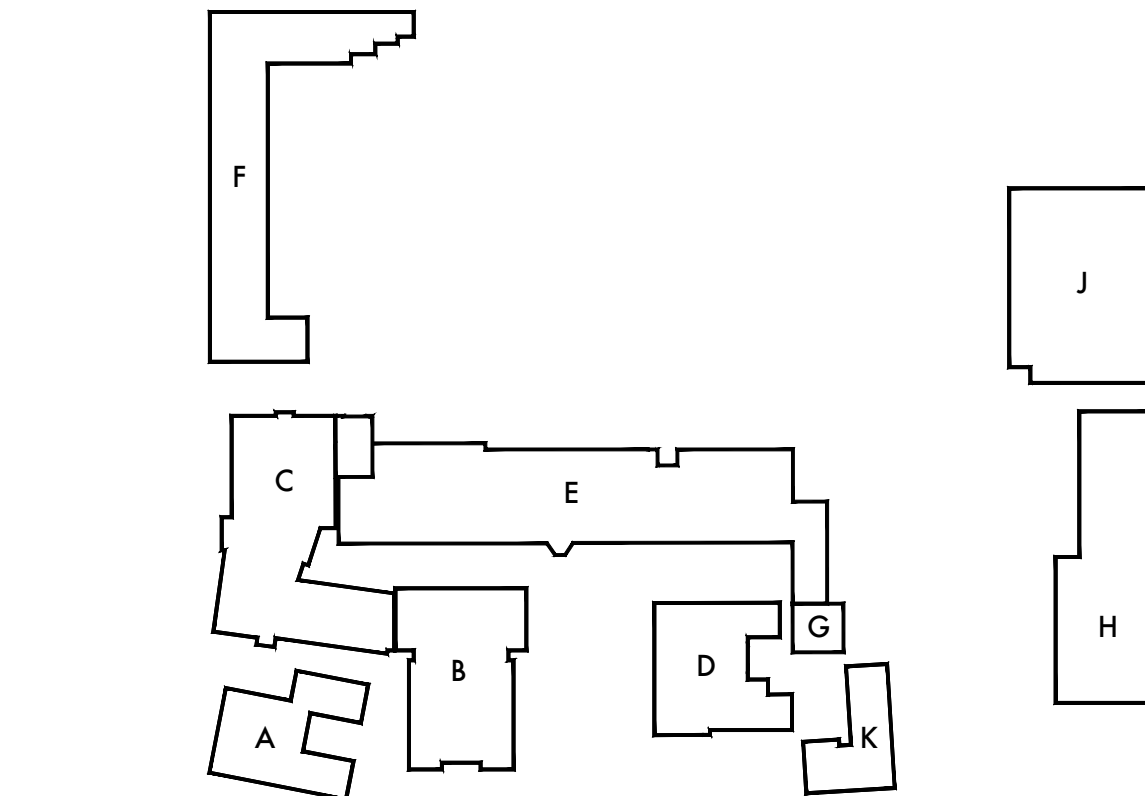
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KEYNOTES

NO.	DESCRIPTION
201	MECHANICAL CLOSET SEE WALL TYPE AS REFERENCED AND PLAN FOR DIMENSIONS. SEE MECHANICAL DRAWINGS FOR MORE INFORMATION.
221	MECHANICAL EQUIPMENT. SEE MECHANICAL AND ELECTRICAL FOR ADDITIONAL INFORMATION.
220	EXISTING MECHANICAL DUCT TO REMAIN, PROTECT IN PLACE TO BE REUSED AND CONNECT TO NEW EQUIPMENT. SEE MECHANICAL FOR ADDITIONAL INFORMATION.
401	MECHANICAL DUCT PENETRATION AT EXISTING ROOF. SEE MECHANICAL AND DETAIL X/A831 FOR ADDITIONAL INFORMATION.

FLOOR PLAN LEGEND

SYMBOL	DESCRIPTION
	(E) WOOD STUD WALL OR PARTITION TO REMAIN.
	METAL STUD WALL ASSEMBLY. REFER TO WALL TYPE AND TYPICAL DETAILS ON A711 FOR MORE INFORMATION.
	NEW DOOR AND FRAME. SEE DOOR SCHEDULE ON A611 FOR MORE INFORMATION.
	WALL TYPE. SEE A711 FOR MORE INFORMATION.

APPL. No. A 00-123456

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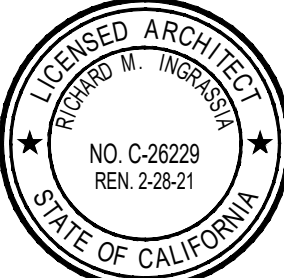
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Lincoln Middle School
1501 California Avenue
Santa Monica, California 90403

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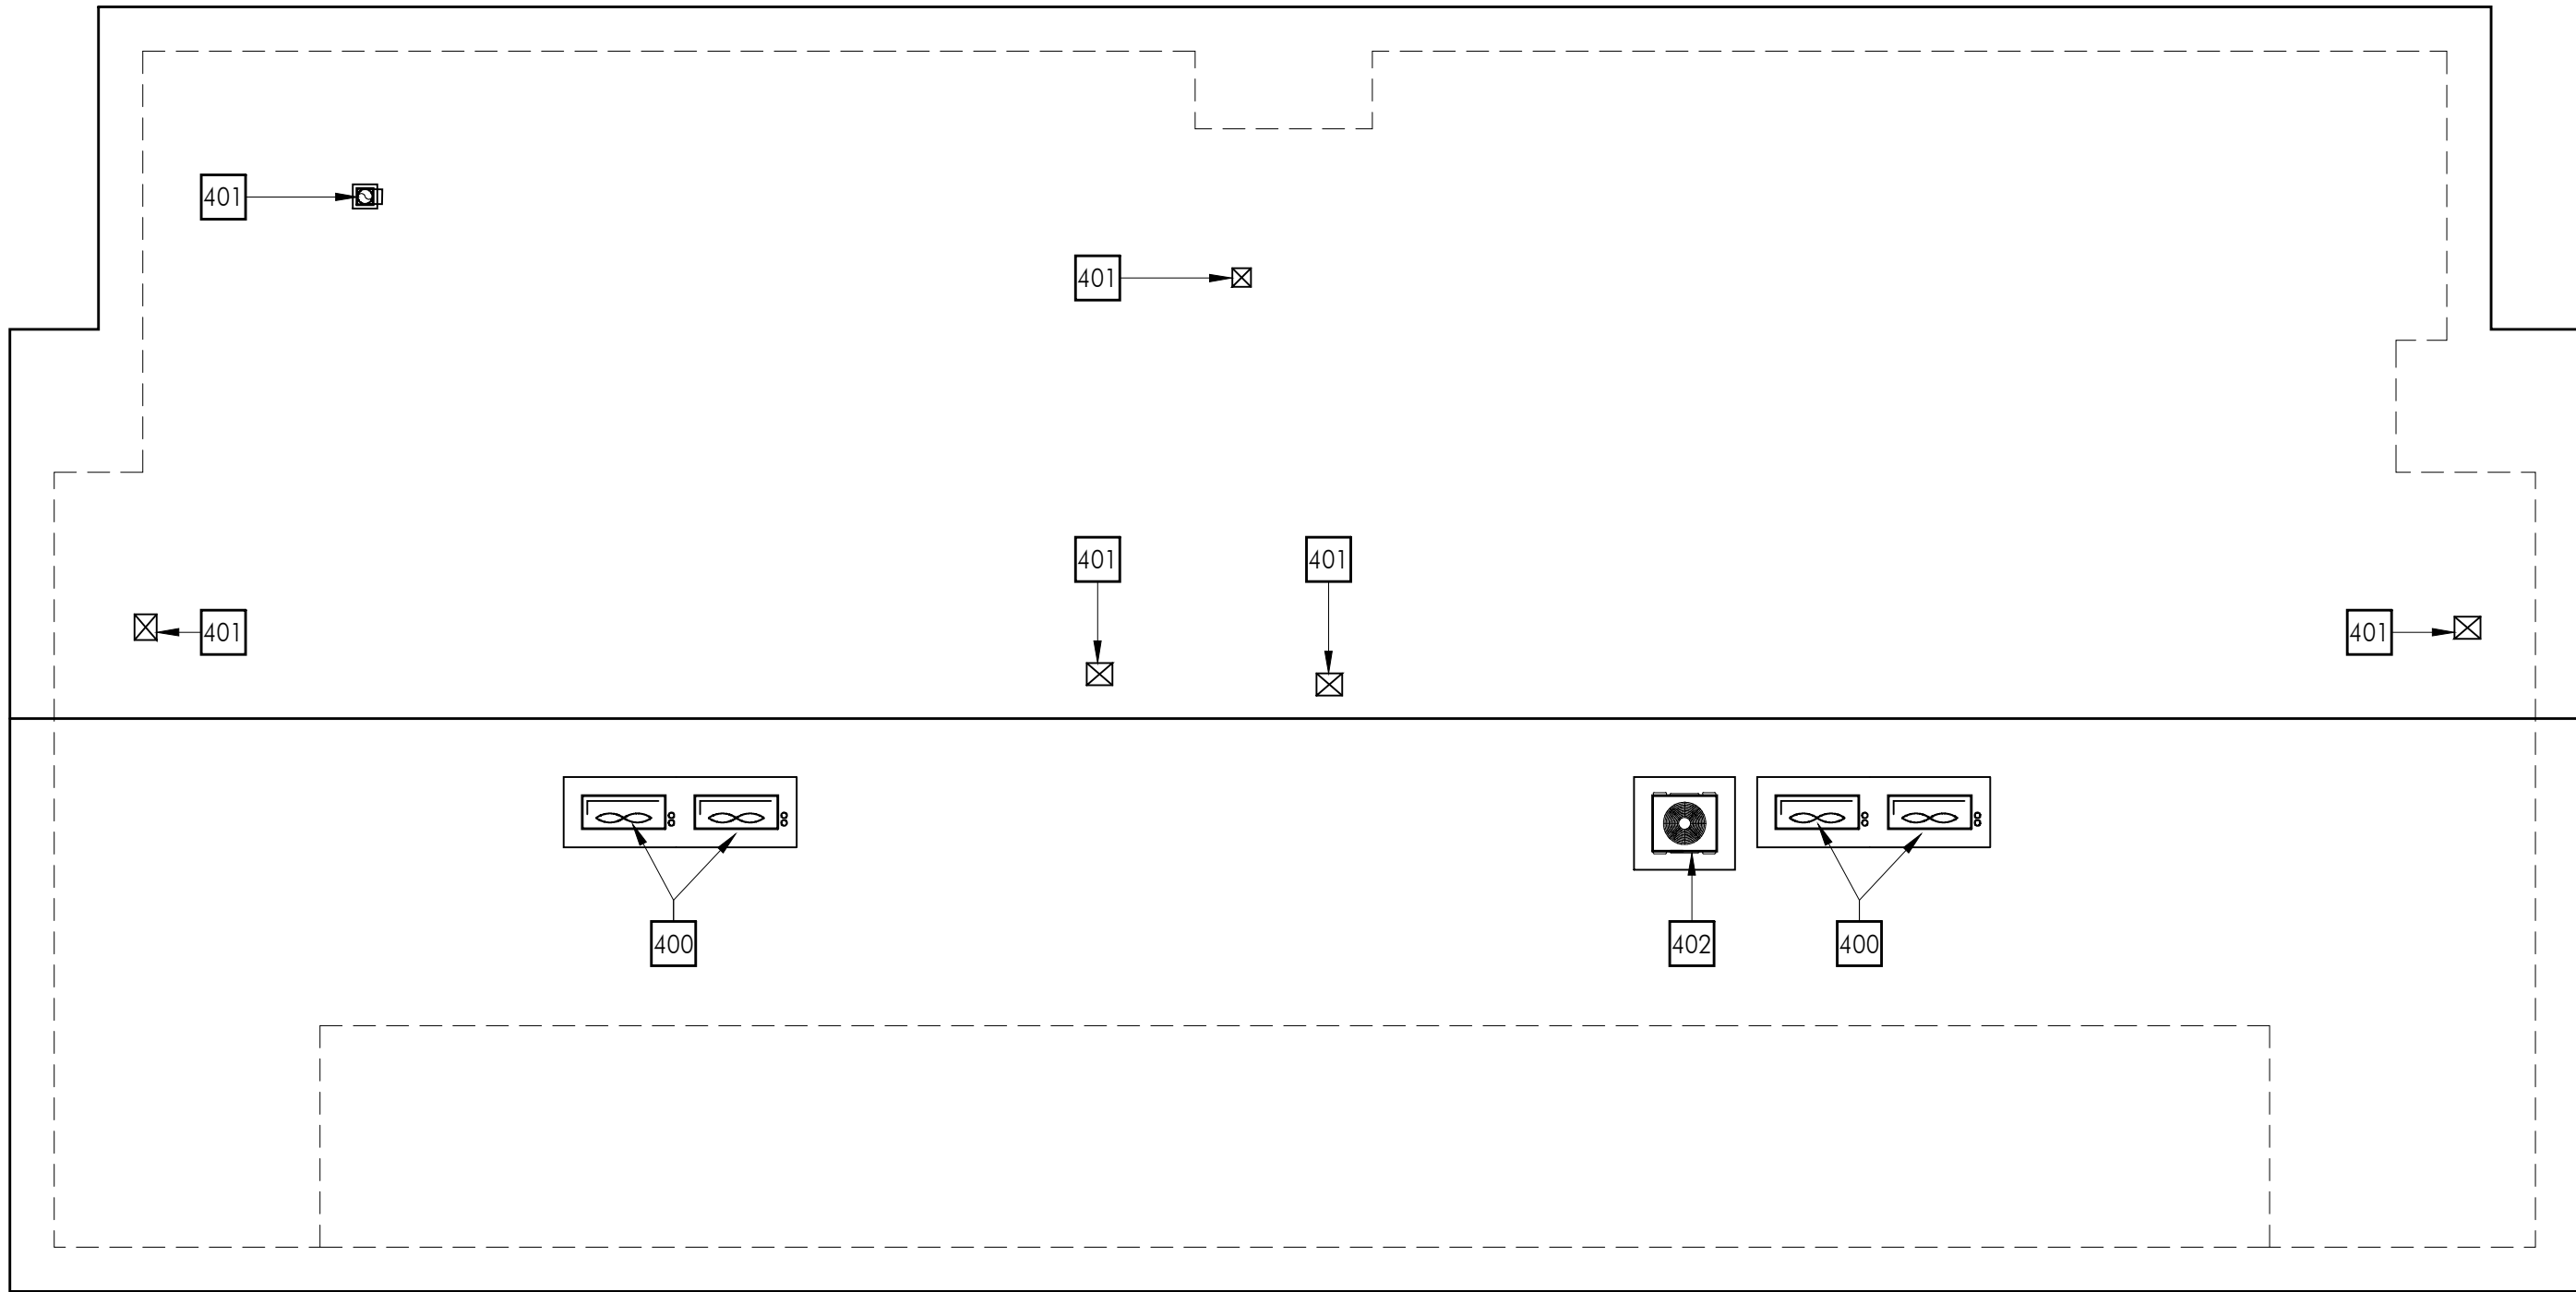
Consultants

Sheet Title
Child Development
Center (CDC)
Floor and Reflected
Ceiling Plans

Sheet Number

ACDC211

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FLOOR PLAN GENERAL NOTES

1. REMOVE EXISTING GYPSUM BOARD, TILE AND BACKER BOARD OR PLASTER TO ACCOMMODATE REMOVAL AND REPLACEMENT OF PIPING, ELECTRICAL AND FOR THE INSTALLATION OF SUPPORT BLOCKING AND MECHANICAL EQUIPMENT. PATCH BACK TO MATCH ADJACENT SURFACE.
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KEYNOTES

NO.	DESCRIPTION
400	ROOF MOUNTED MECHANICAL CONDENSER UNIT ON WOOD PAD. SEE PLAN FOR ROUGH DIMENSIONS, ADJUST PAD SIZE FOR NUMBER OF CONDENSERS AND REQUIRED CLEARANCES. SEE MECHANICAL AND DETAIL X/A831 FOR ADDITIONAL INFORMATION.
401	MECHANICAL DUCT PENETRATION AT EXISTING ROOF. SEE MECHANICAL AND DETAIL X/A831 FOR ADDITIONAL INFORMATION.
402	ROOF MOUNTED MECHANICAL UNIT. SEE MECHANICAL AND DETAIL X/A831 FOR ADDITIONAL INFORMATION.



SCALE: 1/8"=1'-0"

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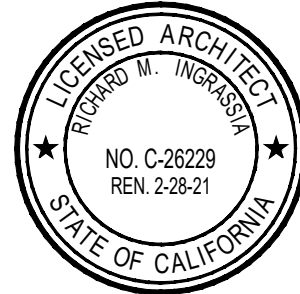
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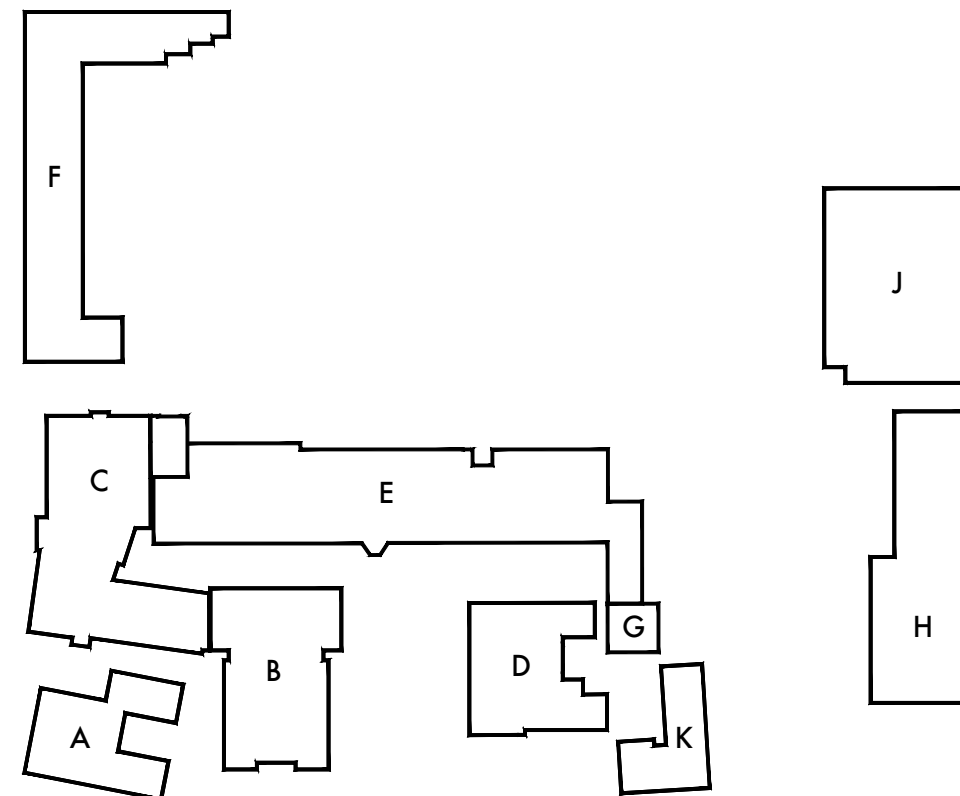
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Checked By: RI

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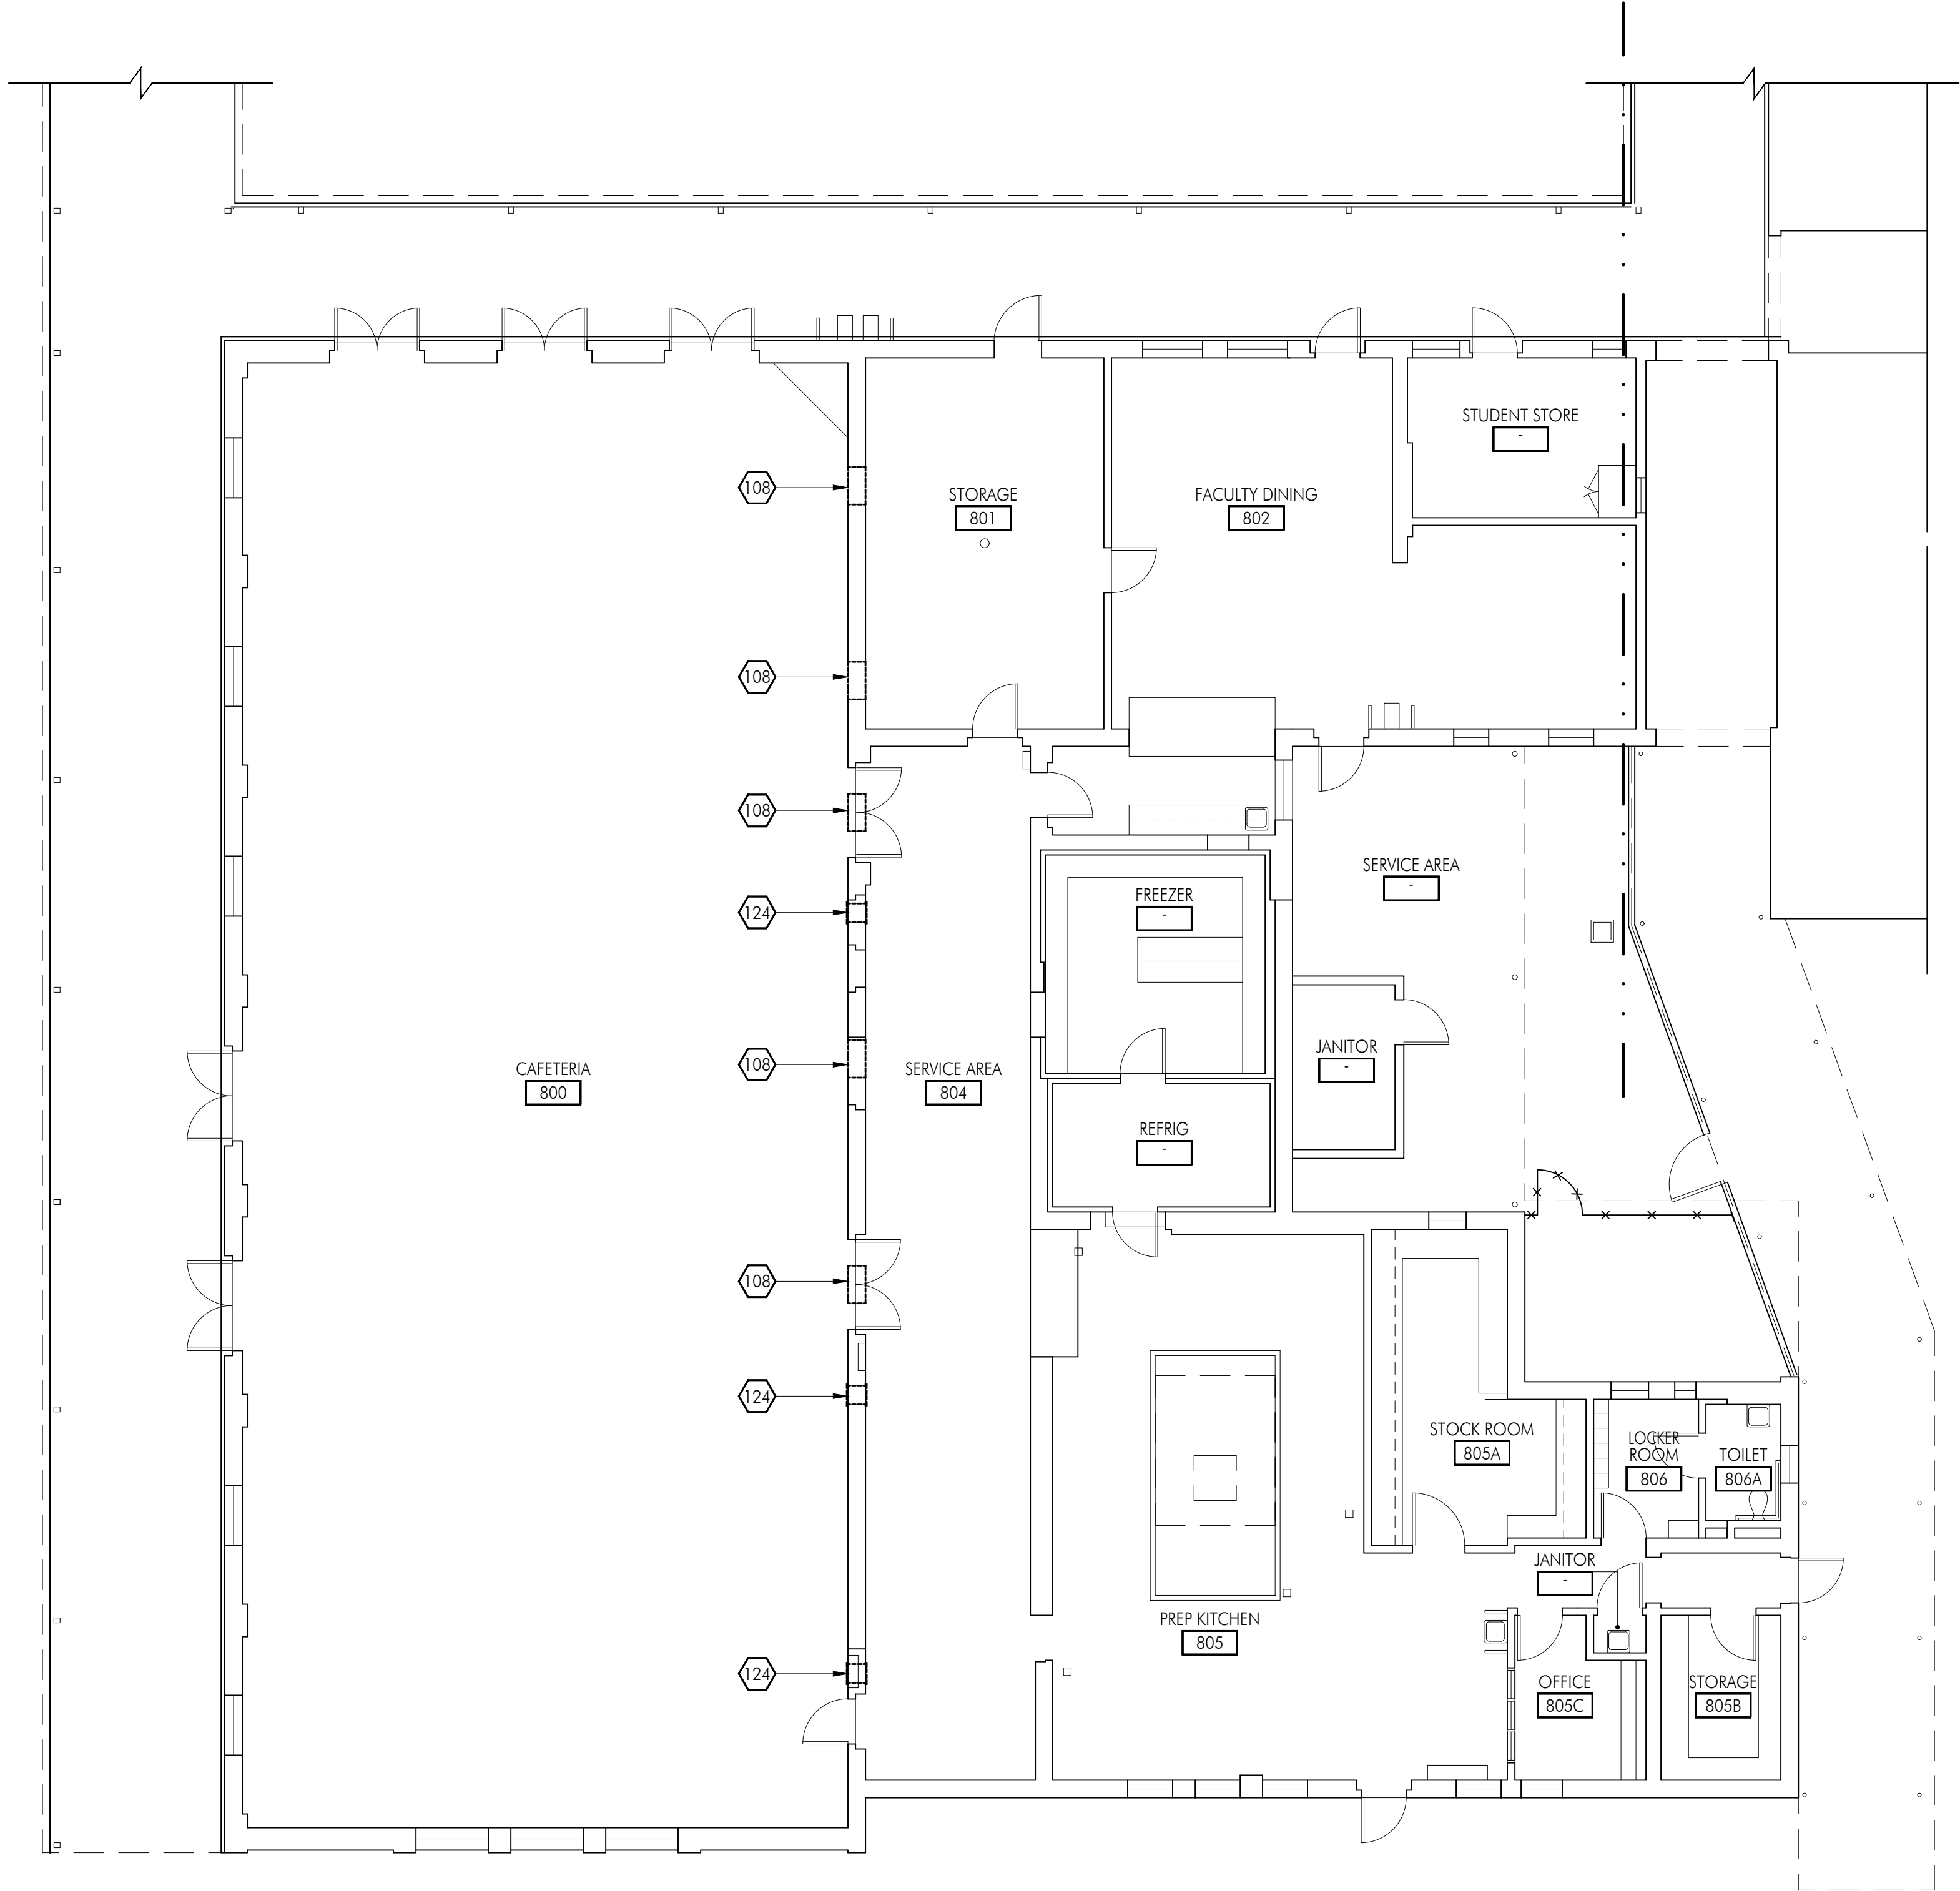
KEY PLAN

Sheet Title


Child Development
Center (CDC) Roof
Plan

Sheet Number

ACDC241



SCALE: 1/8"=1'-0"

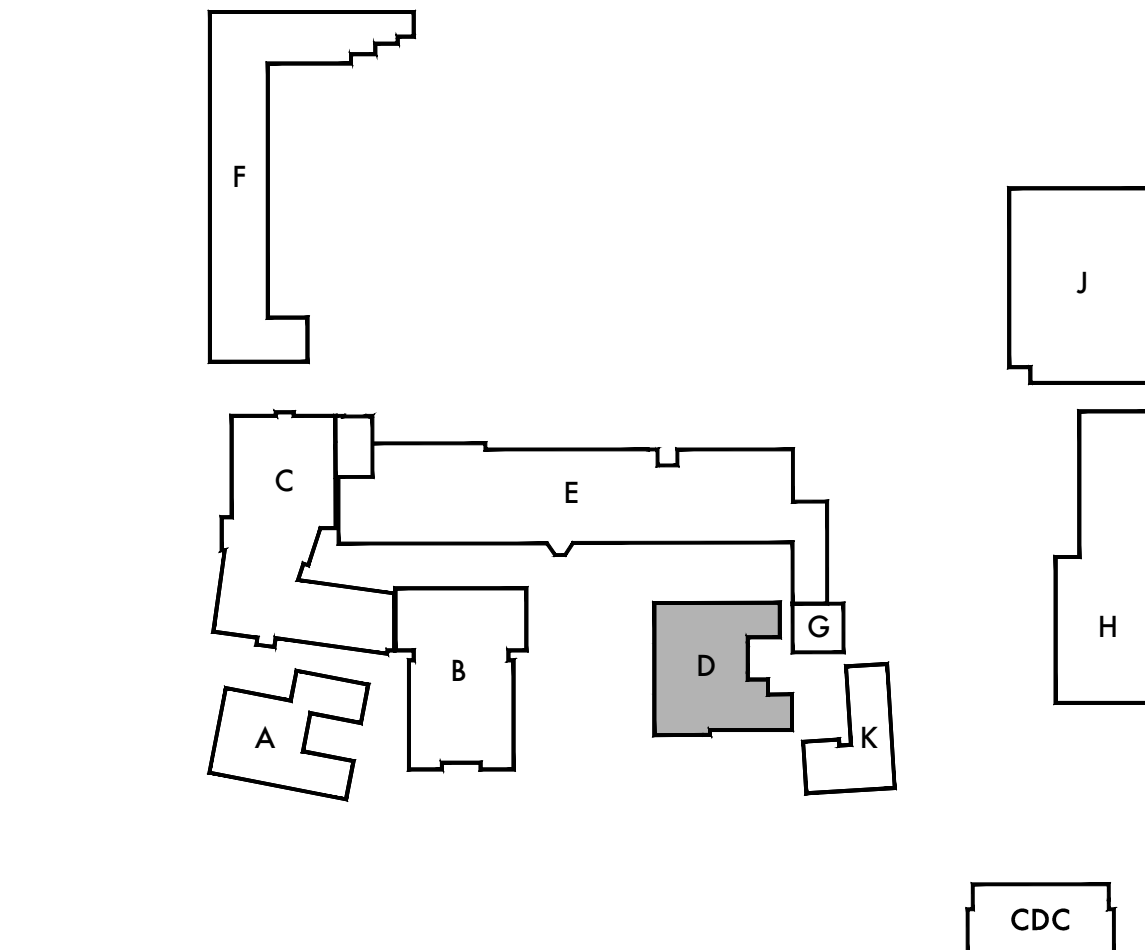

KEY PLAN

FLOOR PLAN GENERAL NOTES

1. REMOVE EXISTING GYPSUM BOARD, TILE AND BACKER BOARD OR PLASTER TO ACCOMMODATE REMOVAL AND REPLACEMENT OF PIPING, ELECTRICAL AND FOR THE INSTALLATION OF SUPPORT BLOCKING AND MECHANICAL EQUIPMENT. PATCH BACK TO MATCH ADJACENT SURFACE.
2. REFER TO MECHANICAL, PLUMBING, ELECTRICAL AND FIRE ALARM DRAWINGS FOR ADDITIONAL SCOPE OF WORK IN EACH ROOM.
3. ALL WALLS SHALL BE FULL HEIGHT TO THE ROOF DECK UNLESS NOTED OTHERWISE, AND SHALL BE CLOSED AND SEALED PER WALL TYPE AND AS DETAILED ON A711.
4. UNSCHEDULED CUTTING, REMOVING OR TRIMMING OF EXISTING CONCRETE, MASONRY OR WOOD FRAMED WALLS IS NOT PERMITTED, UNLESS NOTED OTHERWISE ALL DOORS SHALL BE FITTED WITHIN EXISTING WALL OPENINGS WITHOUT ENLARGING OR TRIMMING HEAD OR JAMBS.

DEMOLITION KEYNOTES

NO.	DESCRIPTION
108	REMOVE INDICATED PORTION OF EXISTING WALL AT AN ELEVATION OF +10'-6" IN PREPARATION FOR NEW DUCT PENETRATION AND MECHANICAL REGISTER. SEE MECHANICAL FOR ADDITIONAL INFORMATION. (REVIEW LOCATION IN THE FIELD WITH ARCHITECT PRIOR TO COMPLETING WORK)
124	REMOVE EXISTING WALL MOUNTED MECHANICAL REGISTER AND ALL ASSOCIATED ITEMS. PREPARE EXISTING OPENING FOR NEW REGISTER AND DUCT AT SAME LOCATION. SEE MECHANICAL FOR ADDITIONAL INFORMATION.

DEMOLITION FLOOR PLAN LEGEND

SYMBOL	DESCRIPTION
	(E) STUD WALL OR PARTITION TO REMAIN.
	(E) STUD WALL OR PARTITION TO BE REMOVED.
	(E) DOOR TO REMAIN. SAND, CLEAN AND PATCH DOOR IN PREPARATION FOR NEW FINISHES.
	REMOVE EXISTING DOOR AND APPURTENANCES. PROTECT EXISTING FRAME IN PLACE U.N.O. CLEAN AND PATCH FRAME IN PREPARATION FOR NEW FINISHES AND DOOR HARDWARE.

APPL. No. A 00-123456

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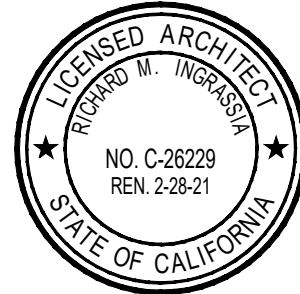
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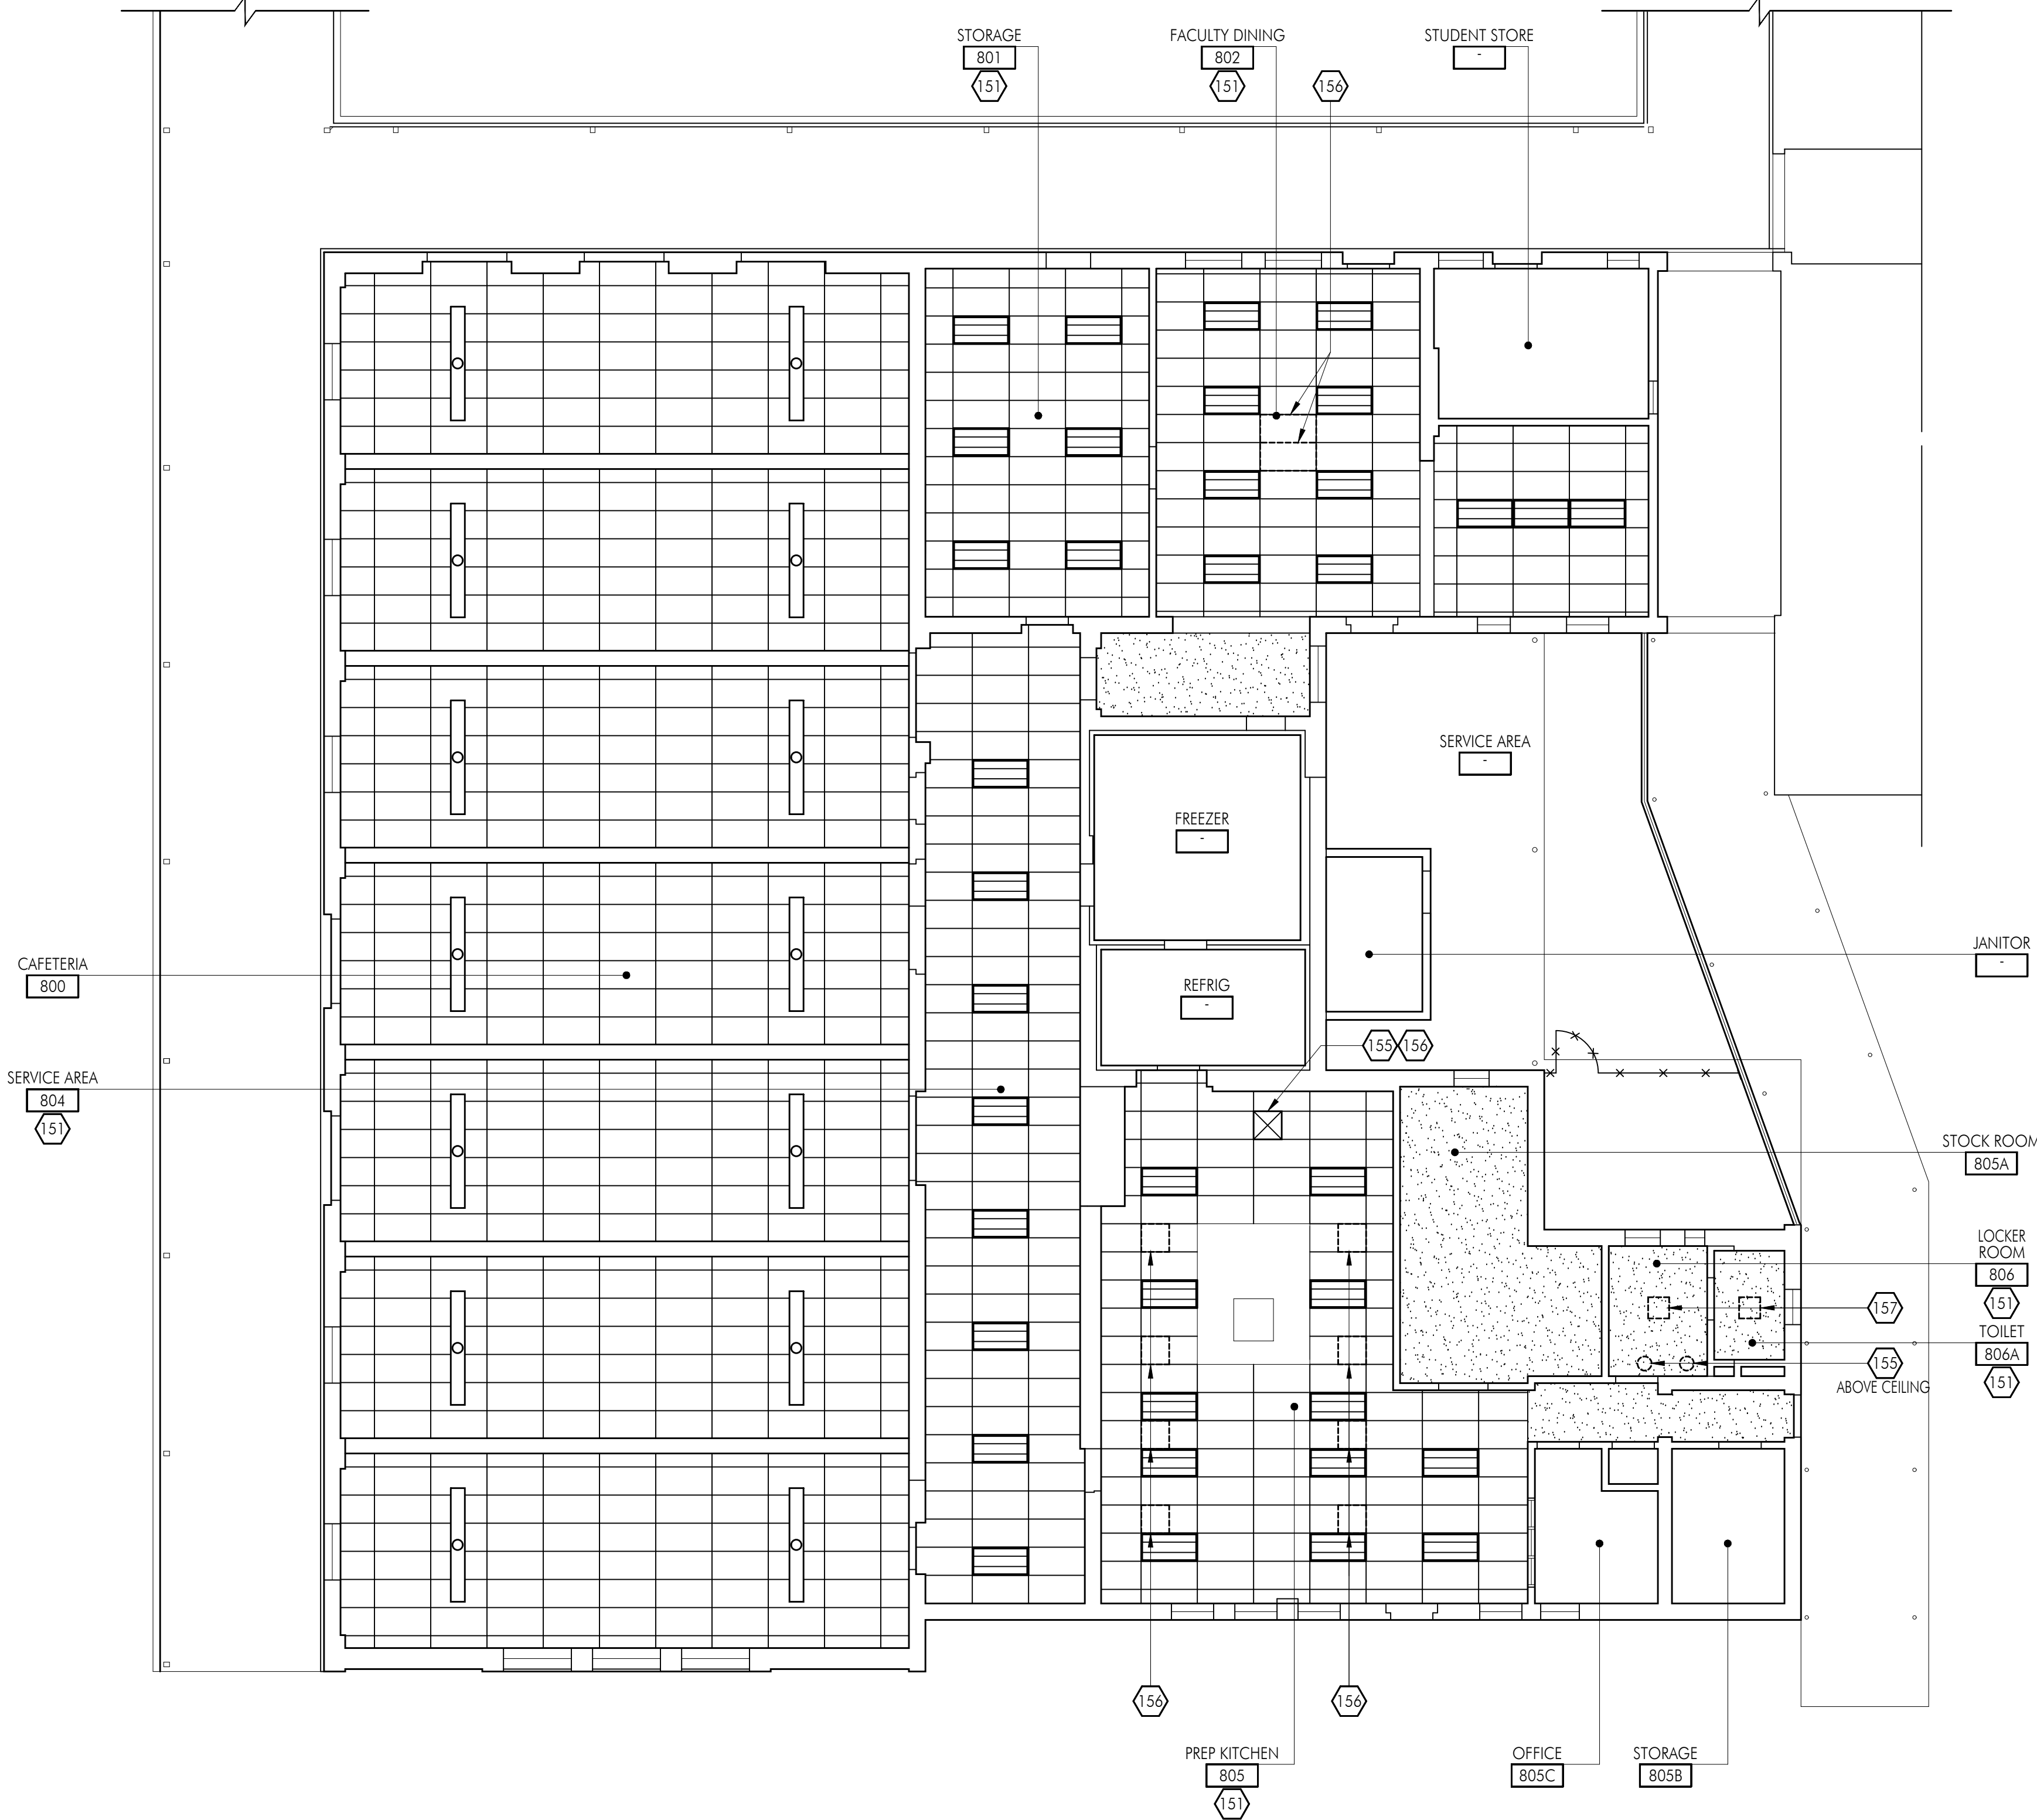


Consultants

Sheet Title
Building 'D'
Demolition Floor Plan

Sheet Number

AD201



FLOOR PLAN GENERAL NOTES


1. REMOVE EXISTING GYPSUM BOARD, TILE AND BACKER BOARD OR PLASTER TO ACCOMMODATE REMOVAL AND REPLACEMENT OF PIPING, ELECTRICAL AND FOR THE INSTALLATION OF SUPPORT BLOCKING AND MECHANICAL EQUIPMENT. PATCH BACK TO MATCH ADJACENT SURFACE.
2. REFER TO MECHANICAL, PLUMBING, ELECTRICAL AND FIRE ALARM DRAWINGS FOR ADDITIONAL SCOPE OF WORK IN EACH ROOM.
3. ALL WALLS SHALL BE FULL HEIGHT TO THE ROOF DECK UNLESS NOTED OTHERWISE, AND SHALL BE CLOSED AND SEALED PER WALL TYPE AND AS DETAILED ON A711.
4. UNSCHEDULED CUTTING, REMOVING OR TRIMMING OF EXISTING CONCRETE, MASONRY OR WOOD FRAMED WALLS IS NOT PERMITTED, UNLESS NOTED OTHERWISE ALL DOORS SHALL BE FITTED WITHIN EXISTING WALL OPENINGS WITHOUT ENLARGING OR TRIMMING HEAD OR JAMBS.

DEMOLITION KEYNOTES

NO.	DESCRIPTION
(15)	REMOVE PORTION OF (E) CEILING AS REQUIRED FOR INSTALLATION OF NEW DUCTWORK, AND UTILITIES AS OCCURS ABOVE CEILING. REPLACE CEILING TILES, PATCH, REPAIR AND PAINT AT ALL REMOVALS TO MATCH EXISTING ADJACENT.
(150)	MECHANICAL DUCT PENETRATION AT EXISTING ROOF. SEE MECHANICAL AND DETAIL X/A831 FOR ADDITIONAL INFORMATION.
(150)	REMOVE PORTION OF (E) CEILING TILES AND SUSPENDED T-BAR SYSTEM IN PREPARATION OF NEW MECHANICAL UNIT, DUCT OR REGISTER. PROTECT EXISTING ADJACENT CEILING AND MODIFY AS REQUIRED FOR TRANSITION TO NEW WORK AND FINISHES. SEE MECHANICAL FOR ADDITIONAL INFORMATION.
(157)	REMOVE PORTION OF (E) GYPSUM BOARD OR PLASTER CEILING IN PREPARATION OF NEW MECHANICAL EQUIPMENT. PROTECT EXISTING ADJACENT CEILING AND MODIFY AS REQUIRED FOR TRANSITION TO NEW WORK AND FINISHES. SEE MECHANICAL FOR ADDITIONAL INFORMATION.

DEMOLITION FLOOR PLAN LEGEND

SYMBOL	DESCRIPTION
	(E) STUD WALL OR PARTITION TO REMAIN.
	(E) STUD WALL OR PARTITION TO BE REMOVED.
	EXISTING SUSPENDED T-BAR CEILING SYSTEM TO REMAIN, UNLESS NOTED OTHERWISE.
	EXISTING GLUE ON ACOUSTIC TILE TO REMAIN, UNLESS NOTED OTHERWISE.
	REMOVE EXISTING LIGHT AND APPURTENANCES. SEE ELECTRICAL FOR MORE INFORMATION.
	EXISTING LIGHT FIXTURE TO REMAIN. SEE ELECTRICAL FOR MORE INFORMATION.

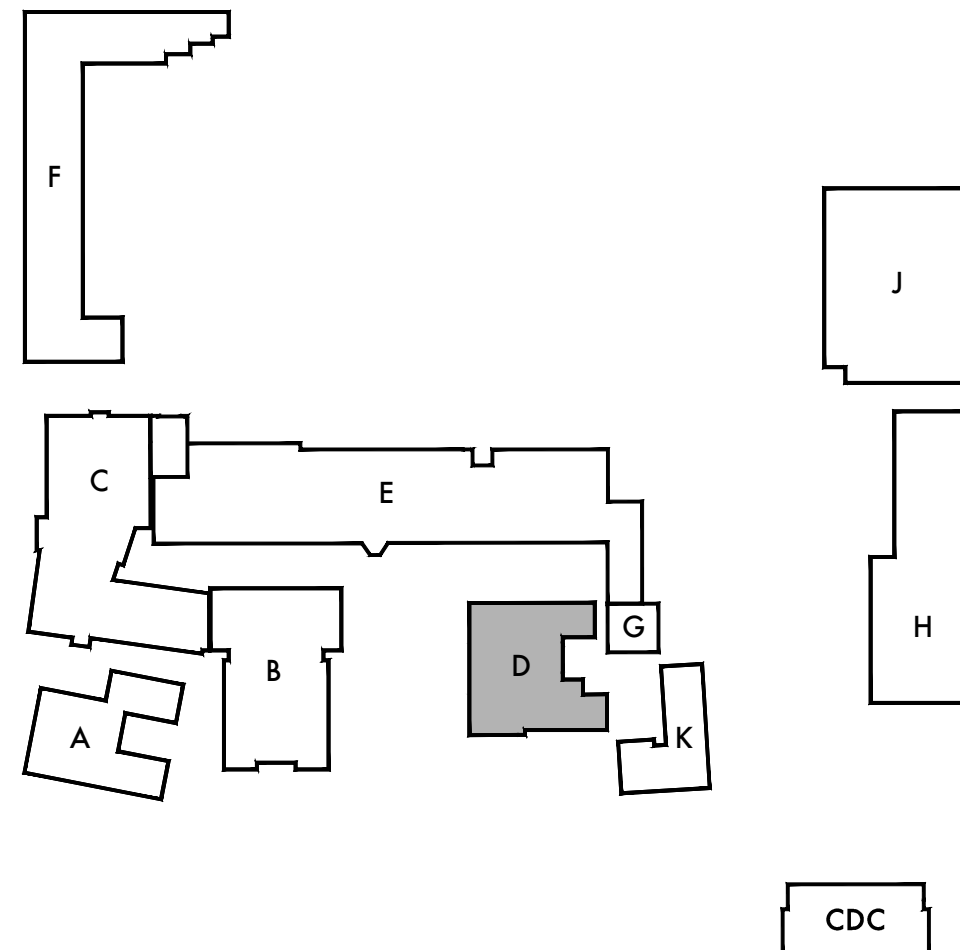

SCALE: 1/8"=1'-0"

DSA Stamp

Architect



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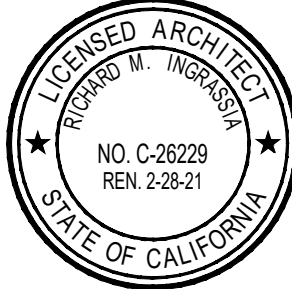
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Lincoln Middle School
1501 California Avenue
Santa Monica, California 90403

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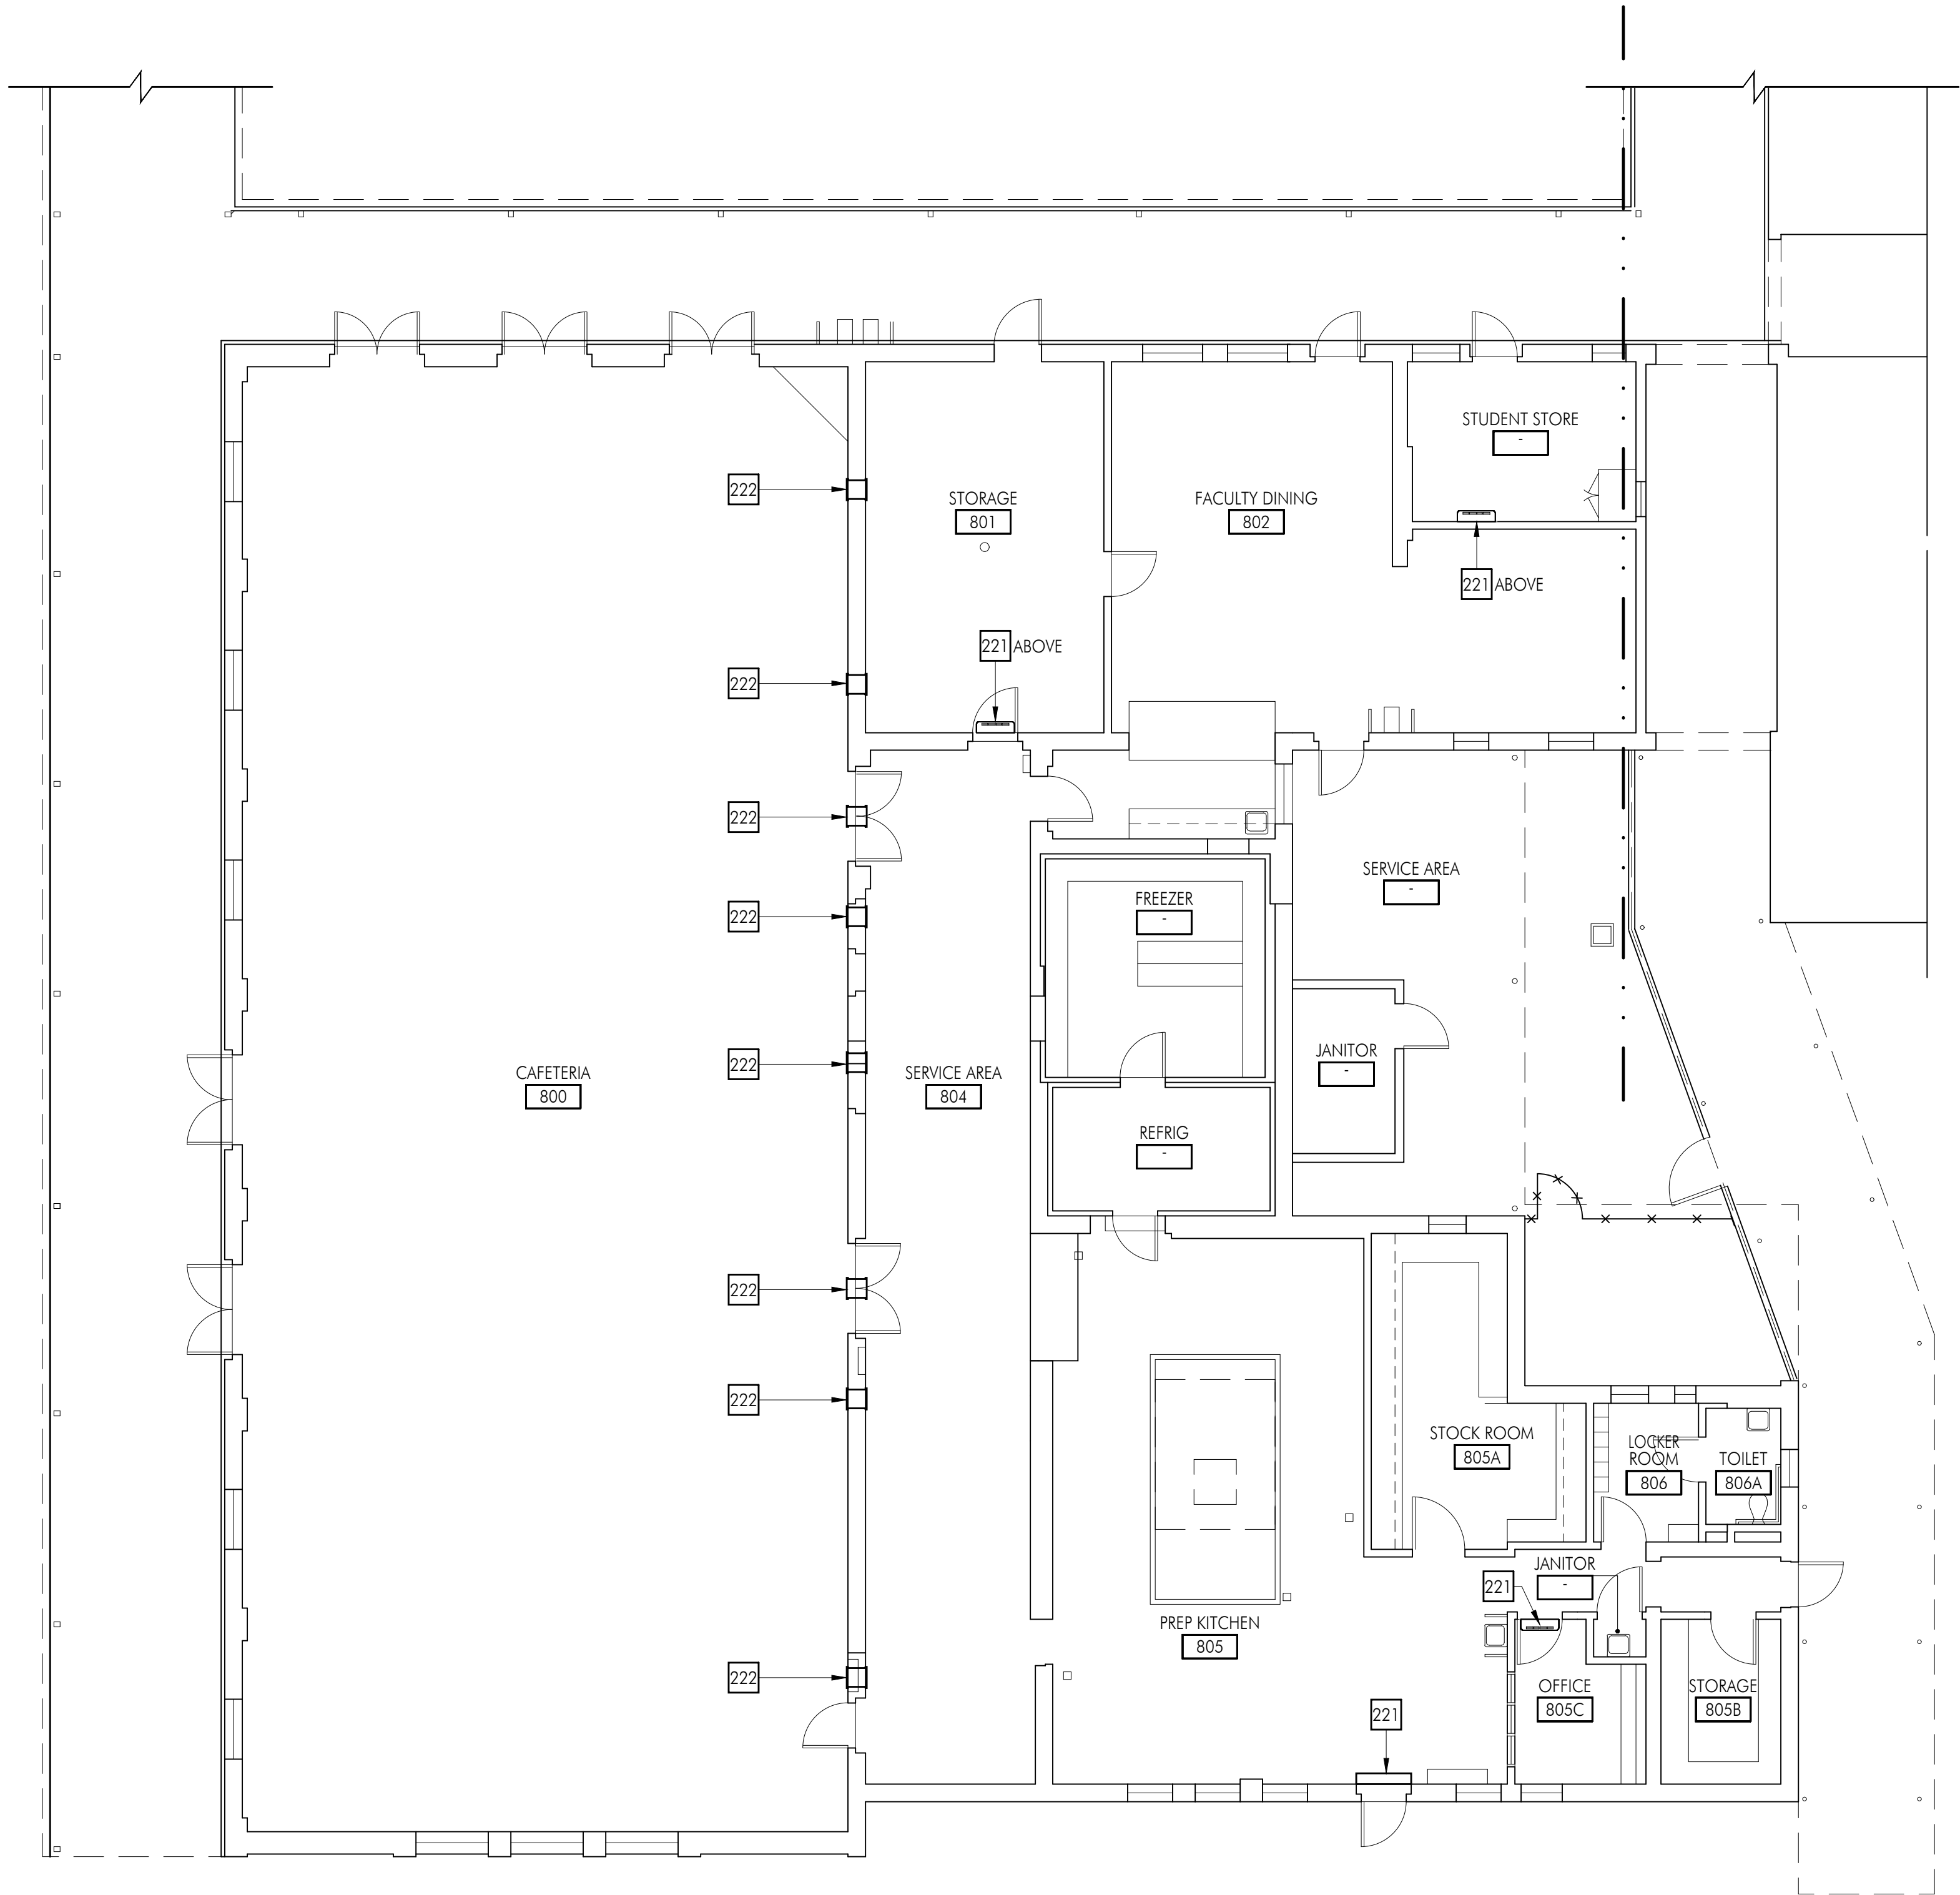


Consultants

Sheet Title
Building 'D'
Demolition Reflected
Ceiling Plan

Sheet Number

AD202



FLOOR PLAN GENERAL NOTES


1. REMOVE EXISTING GYPSUM BOARD, TILE AND BACKER BOARD OR PLASTER TO ACCOMMODATE REMOVAL AND REPLACEMENT OF PIPING, ELECTRICAL AND FOR THE INSTALLATION OF SUPPORT BLOCKING AND MECHANICAL EQUIPMENT. PATCH BACK TO MATCH ADJACENT SURFACE.
2. REFER TO MECHANICAL, PLUMBING, ELECTRICAL AND FIRE ALARM DRAWINGS FOR ADDITIONAL SCOPE OF WORK IN EACH ROOM.
3. ALL WALLS SHALL BE FULL HEIGHT TO THE ROOF DECK UNLESS NOTED OTHERWISE, AND SHALL BE CLOSED AND SEALED PER WALL TYPE AND AS DETAILED ON A711.
4. UNSCHEDULED CUTTING, REMOVING OR TRIMMING OF EXISTING CONCRETE, MASONRY OR WOOD FRAMED WALLS IS NOT PERMITTED, UNLESS NOTED OTHERWISE ALL DOORS SHALL BE FITTED WITHIN EXISTING WALL OPENINGS WITHOUT ENLARGING OR TRIMMING HEAD OR JAMBS.

KEYNOTES

NO.	DESCRIPTION
221	MECHANICAL EQUIPMENT. SEE MECHANICAL AND ELECTRICAL FOR ADDITIONAL INFORMATION
222	MECHANICAL REGISTER AT +10'-6" ABOVE FINISH FLOOR. SEE MECHANICAL AND ELECTRICAL FOR ADDITIONAL INFORMATION. (REVIEW LOCATION IN THE FIELD WITH ARCHITECT PRIOR TO COMPLETING WORK)

FLOOR PLAN LEGEND

SYMBOL	DESCRIPTION
	(E) WOOD STUD WALL OR PARTITION TO REMAIN.
	METAL STUD WALL ASSEMBLY. REFER TO WALL TYPE AND TYPICAL DETAILS ON A711 FOR MORE INFORMATION
	NEW DOOR AND FRAME. SEE DOOR SCHEDULE ON A611 FOR MORE INFORMATION
	WALL TYPE. SEE A711 FOR MORE INFORMATION.

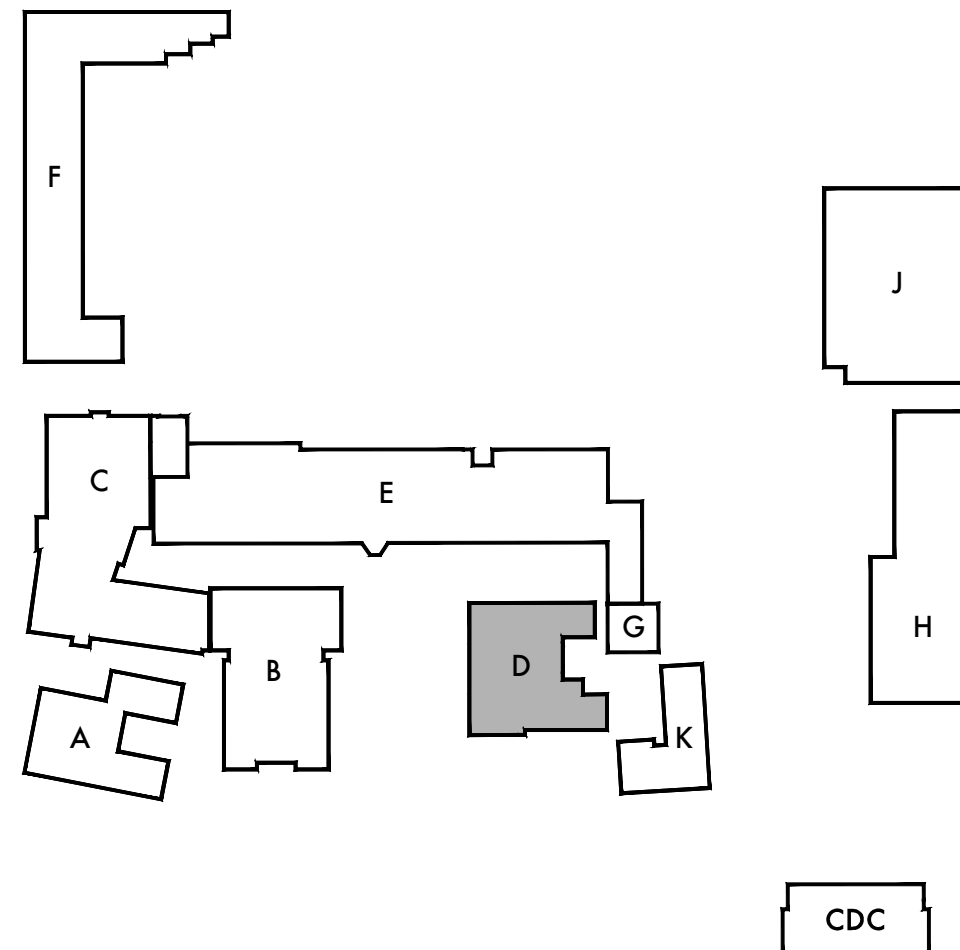

KEY PLAN



SCALE: 1/8"=1'-0"

DSA Stamp

Architect




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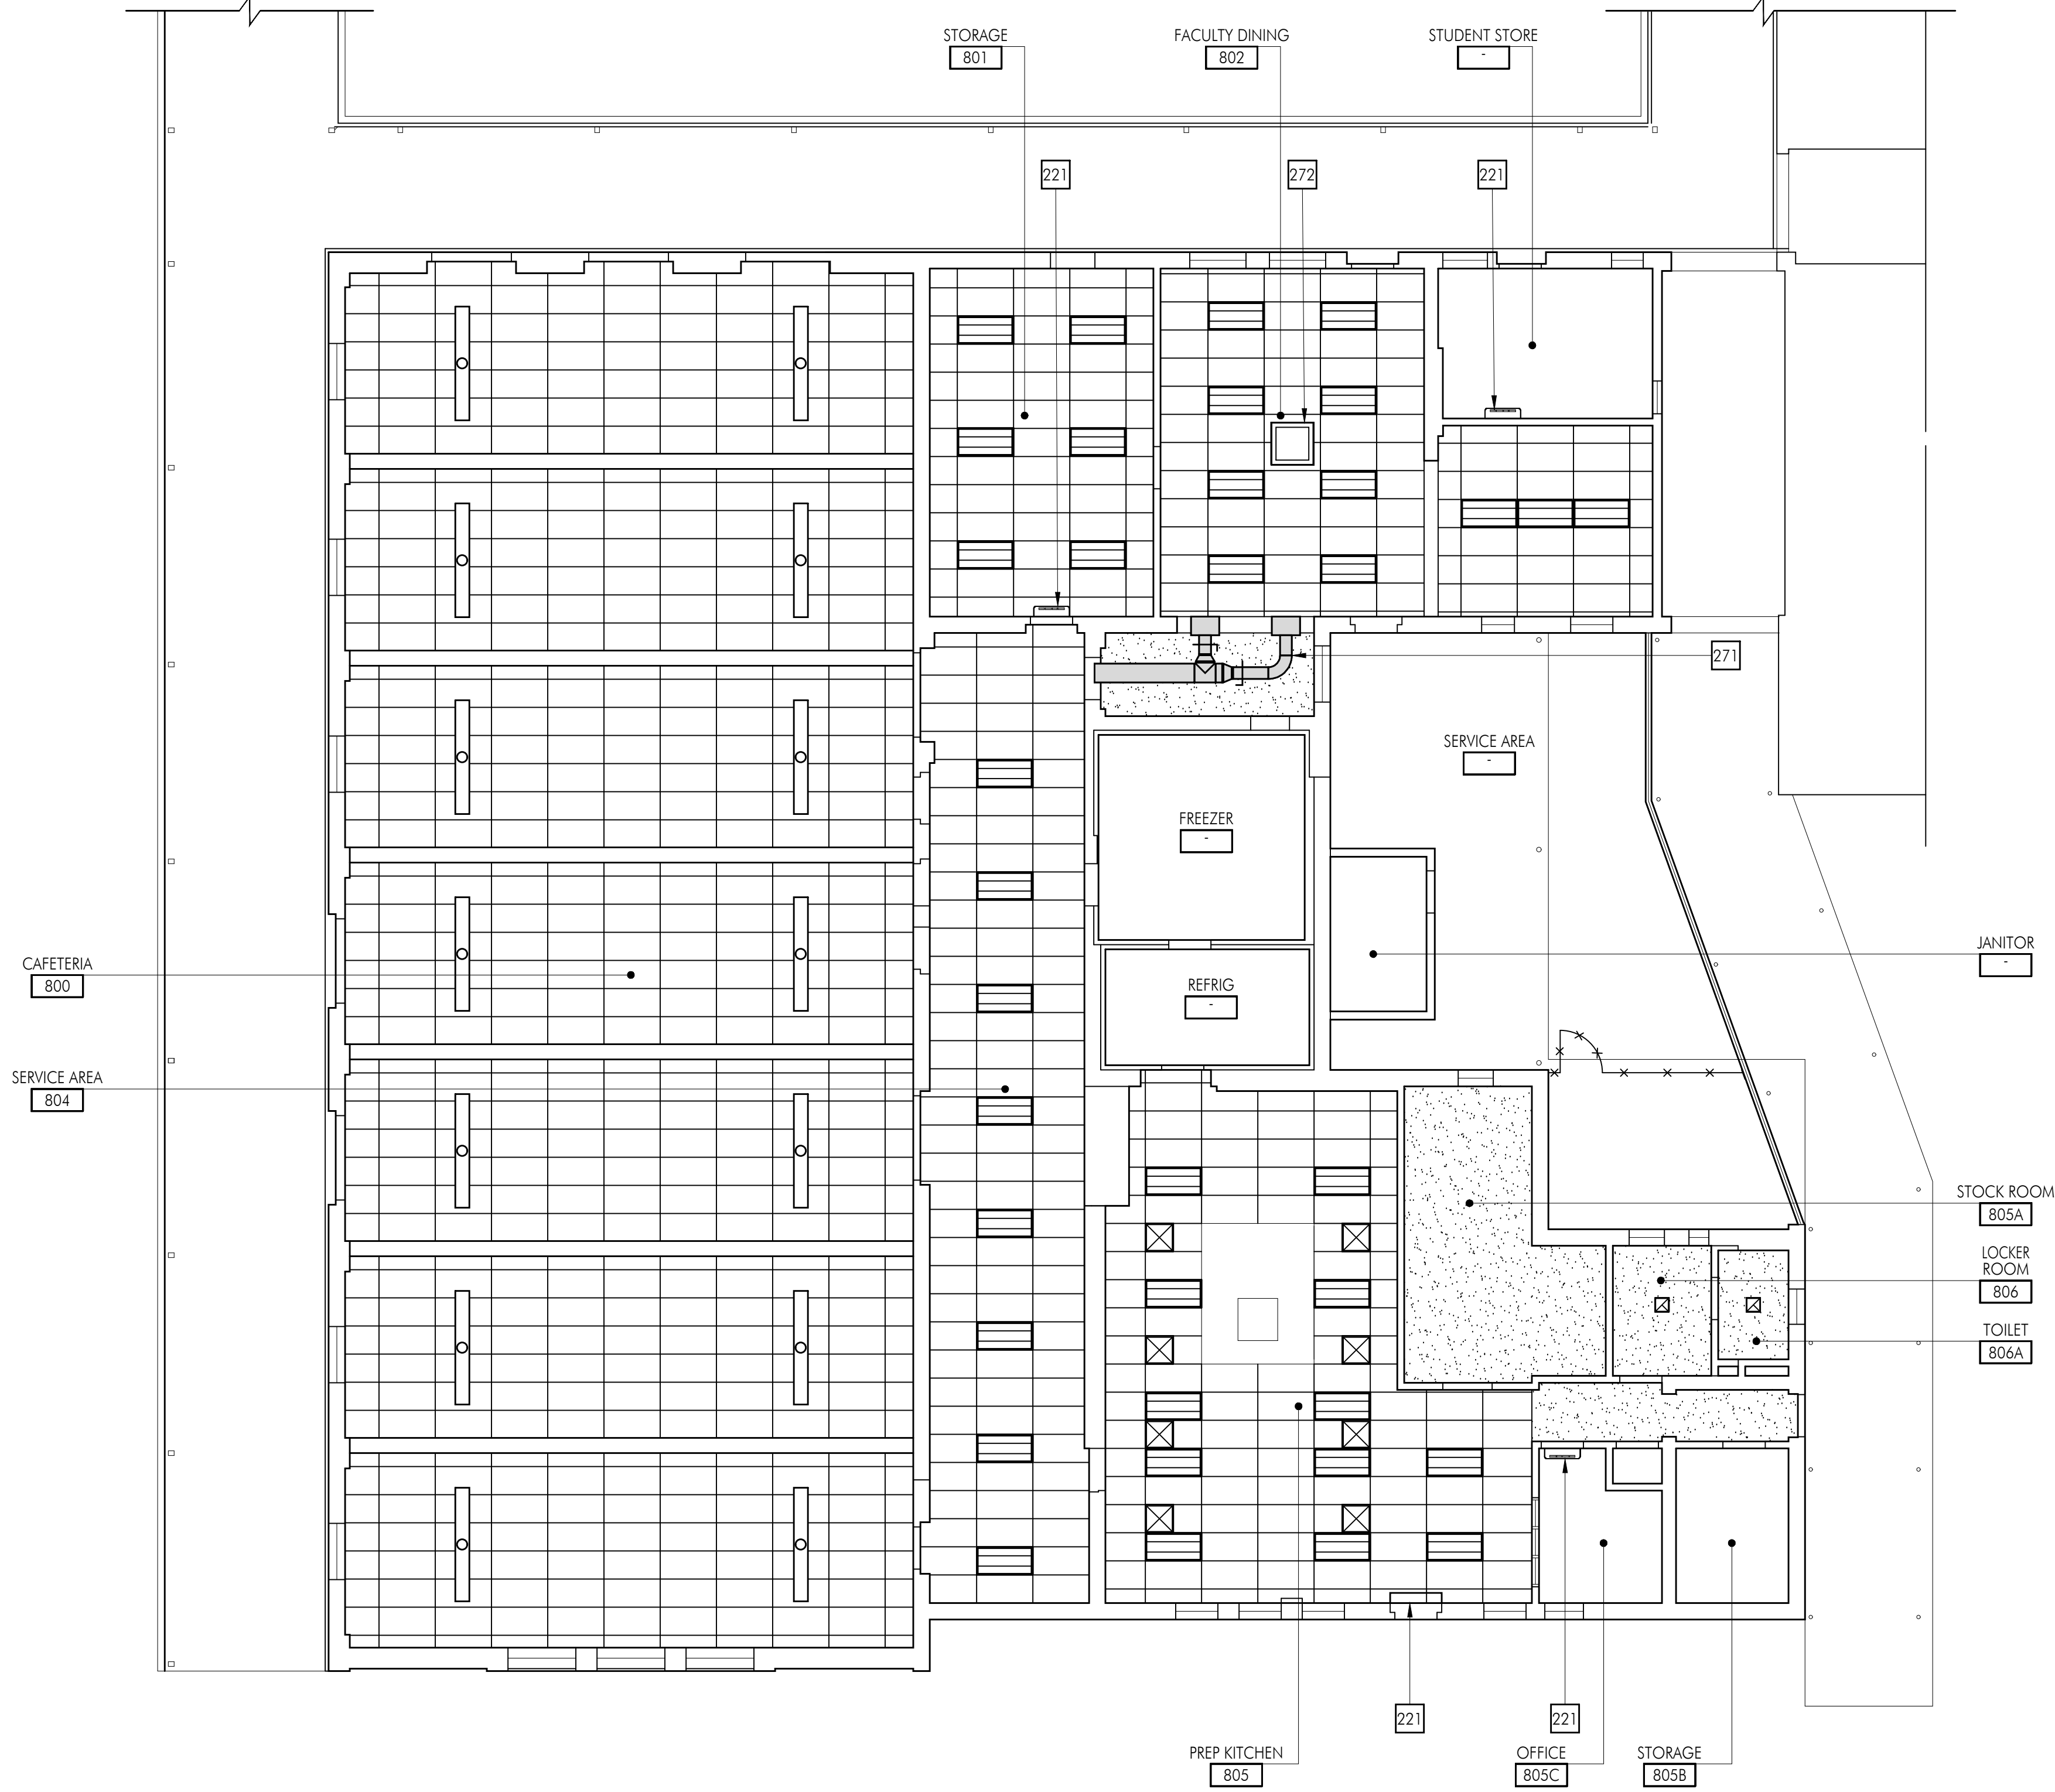


Consultants

Sheet Title
Building 'D' Floor Plan

Sheet Number

AD211

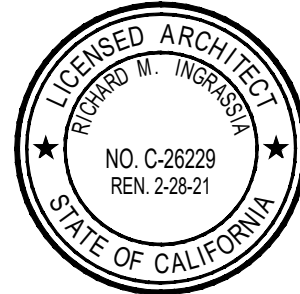

FLOOR PLAN GENERAL NOTES

1. REMOVE EXISTING GYPSUM BOARD, TILE AND BACKER BOARD OR PLASTER TO ACCOMMODATE REMOVAL AND REPLACEMENT OF PIPING, ELECTRICAL AND FOR THE INSTALLATION OF SUPPORT BLOCKING AND MECHANICAL EQUIPMENT. PATCH BACK TO MATCH ADJACENT SURFACE.
2. REFER TO MECHANICAL, PLUMBING, ELECTRICAL AND FIRE ALARM DRAWINGS FOR ADDITIONAL SCOPE OF WORK IN EACH ROOM.
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KEYNOTES


NO.	DESCRIPTION
221	MECHANICAL EQUIPMENT. SEE MECHANICAL AND ELECTRICAL FOR ADDITIONAL INFORMATION.
271	EXPOSED DUCT. SEE MECHANICAL FOR MORE INFORMATION.
272	CEILING MOUNTED MECHANICAL UNIT OR EQUIPMENT. SEE MECHANICAL FOR MORE INFORMATION.

FLOOR PLAN LEGEND

SYMBOL	DESCRIPTION
	(E) WOOD STUD WALL OR PARTITION TO REMAIN.
	METAL STUD WALL ASSEMBLY. REFER TO WALL TYPE AND TYPICAL DETAILS ON A711 FOR MORE INFORMATION.
	EXISTING SUSPENDED T-BAR CEILING SYSTEM TO REMAIN, UNLESS NOTED OTHERWISE.
	EXISTING GLUE ON ACOUSTIC TILE TO REMAIN, UNLESS NOTED OTHERWISE.
	EXISTING LIGHT FIXTURE TO REMAIN. SEE ELECTRICAL FOR MORE INFORMATION.
	RELOCATED LIGHT FIXTURE. SEE ELECTRICAL FOR MORE INFORMATION.
	FRAMED GYPSUM BOARD CEILING SEE XXXX FOR ADDITIONAL INFORMATION AND REFERENCED DETAIL ON PLAN FOR SOFFIT CONDITIONS AS OCCURS. PAINT P-1
	AIR SUPPLY REGISTER
	RETURN AIR GRILLE
	EXHAUST GRILLE



SCALE: 1/8"=1'-0"

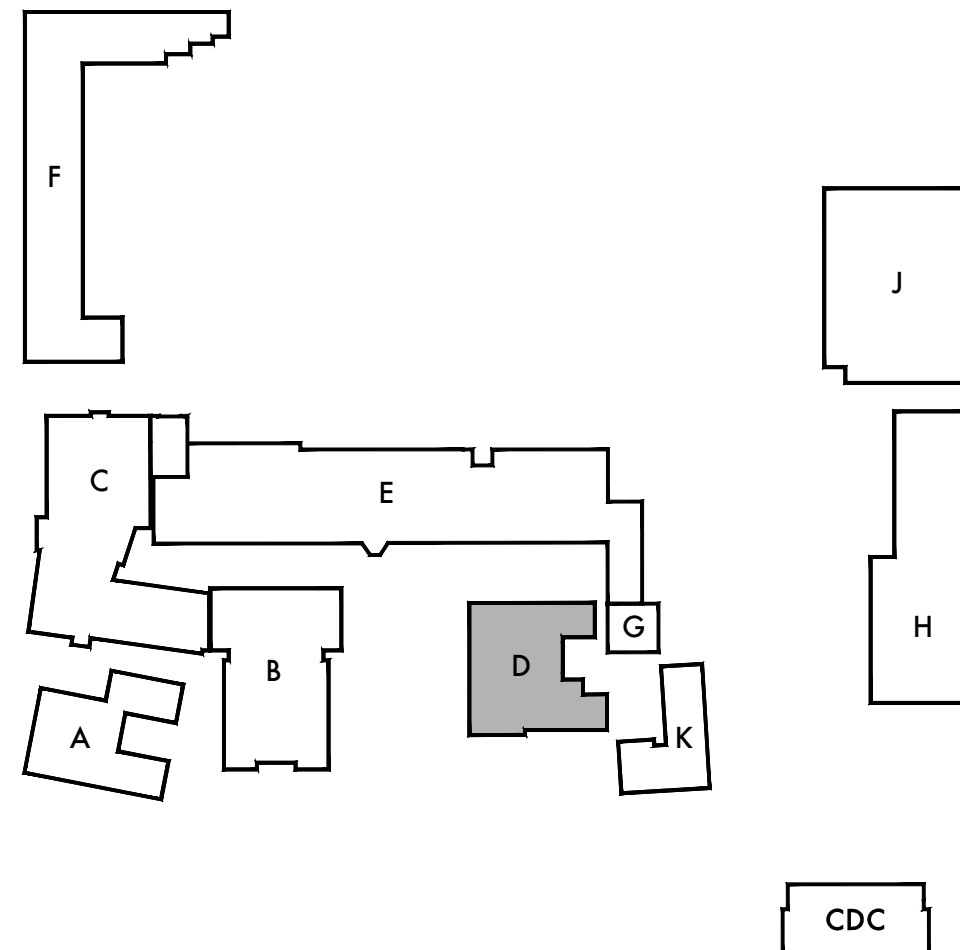

KEY PLAN

APPL. No. A 00-123456

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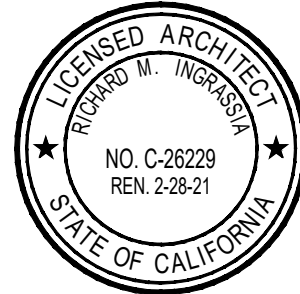
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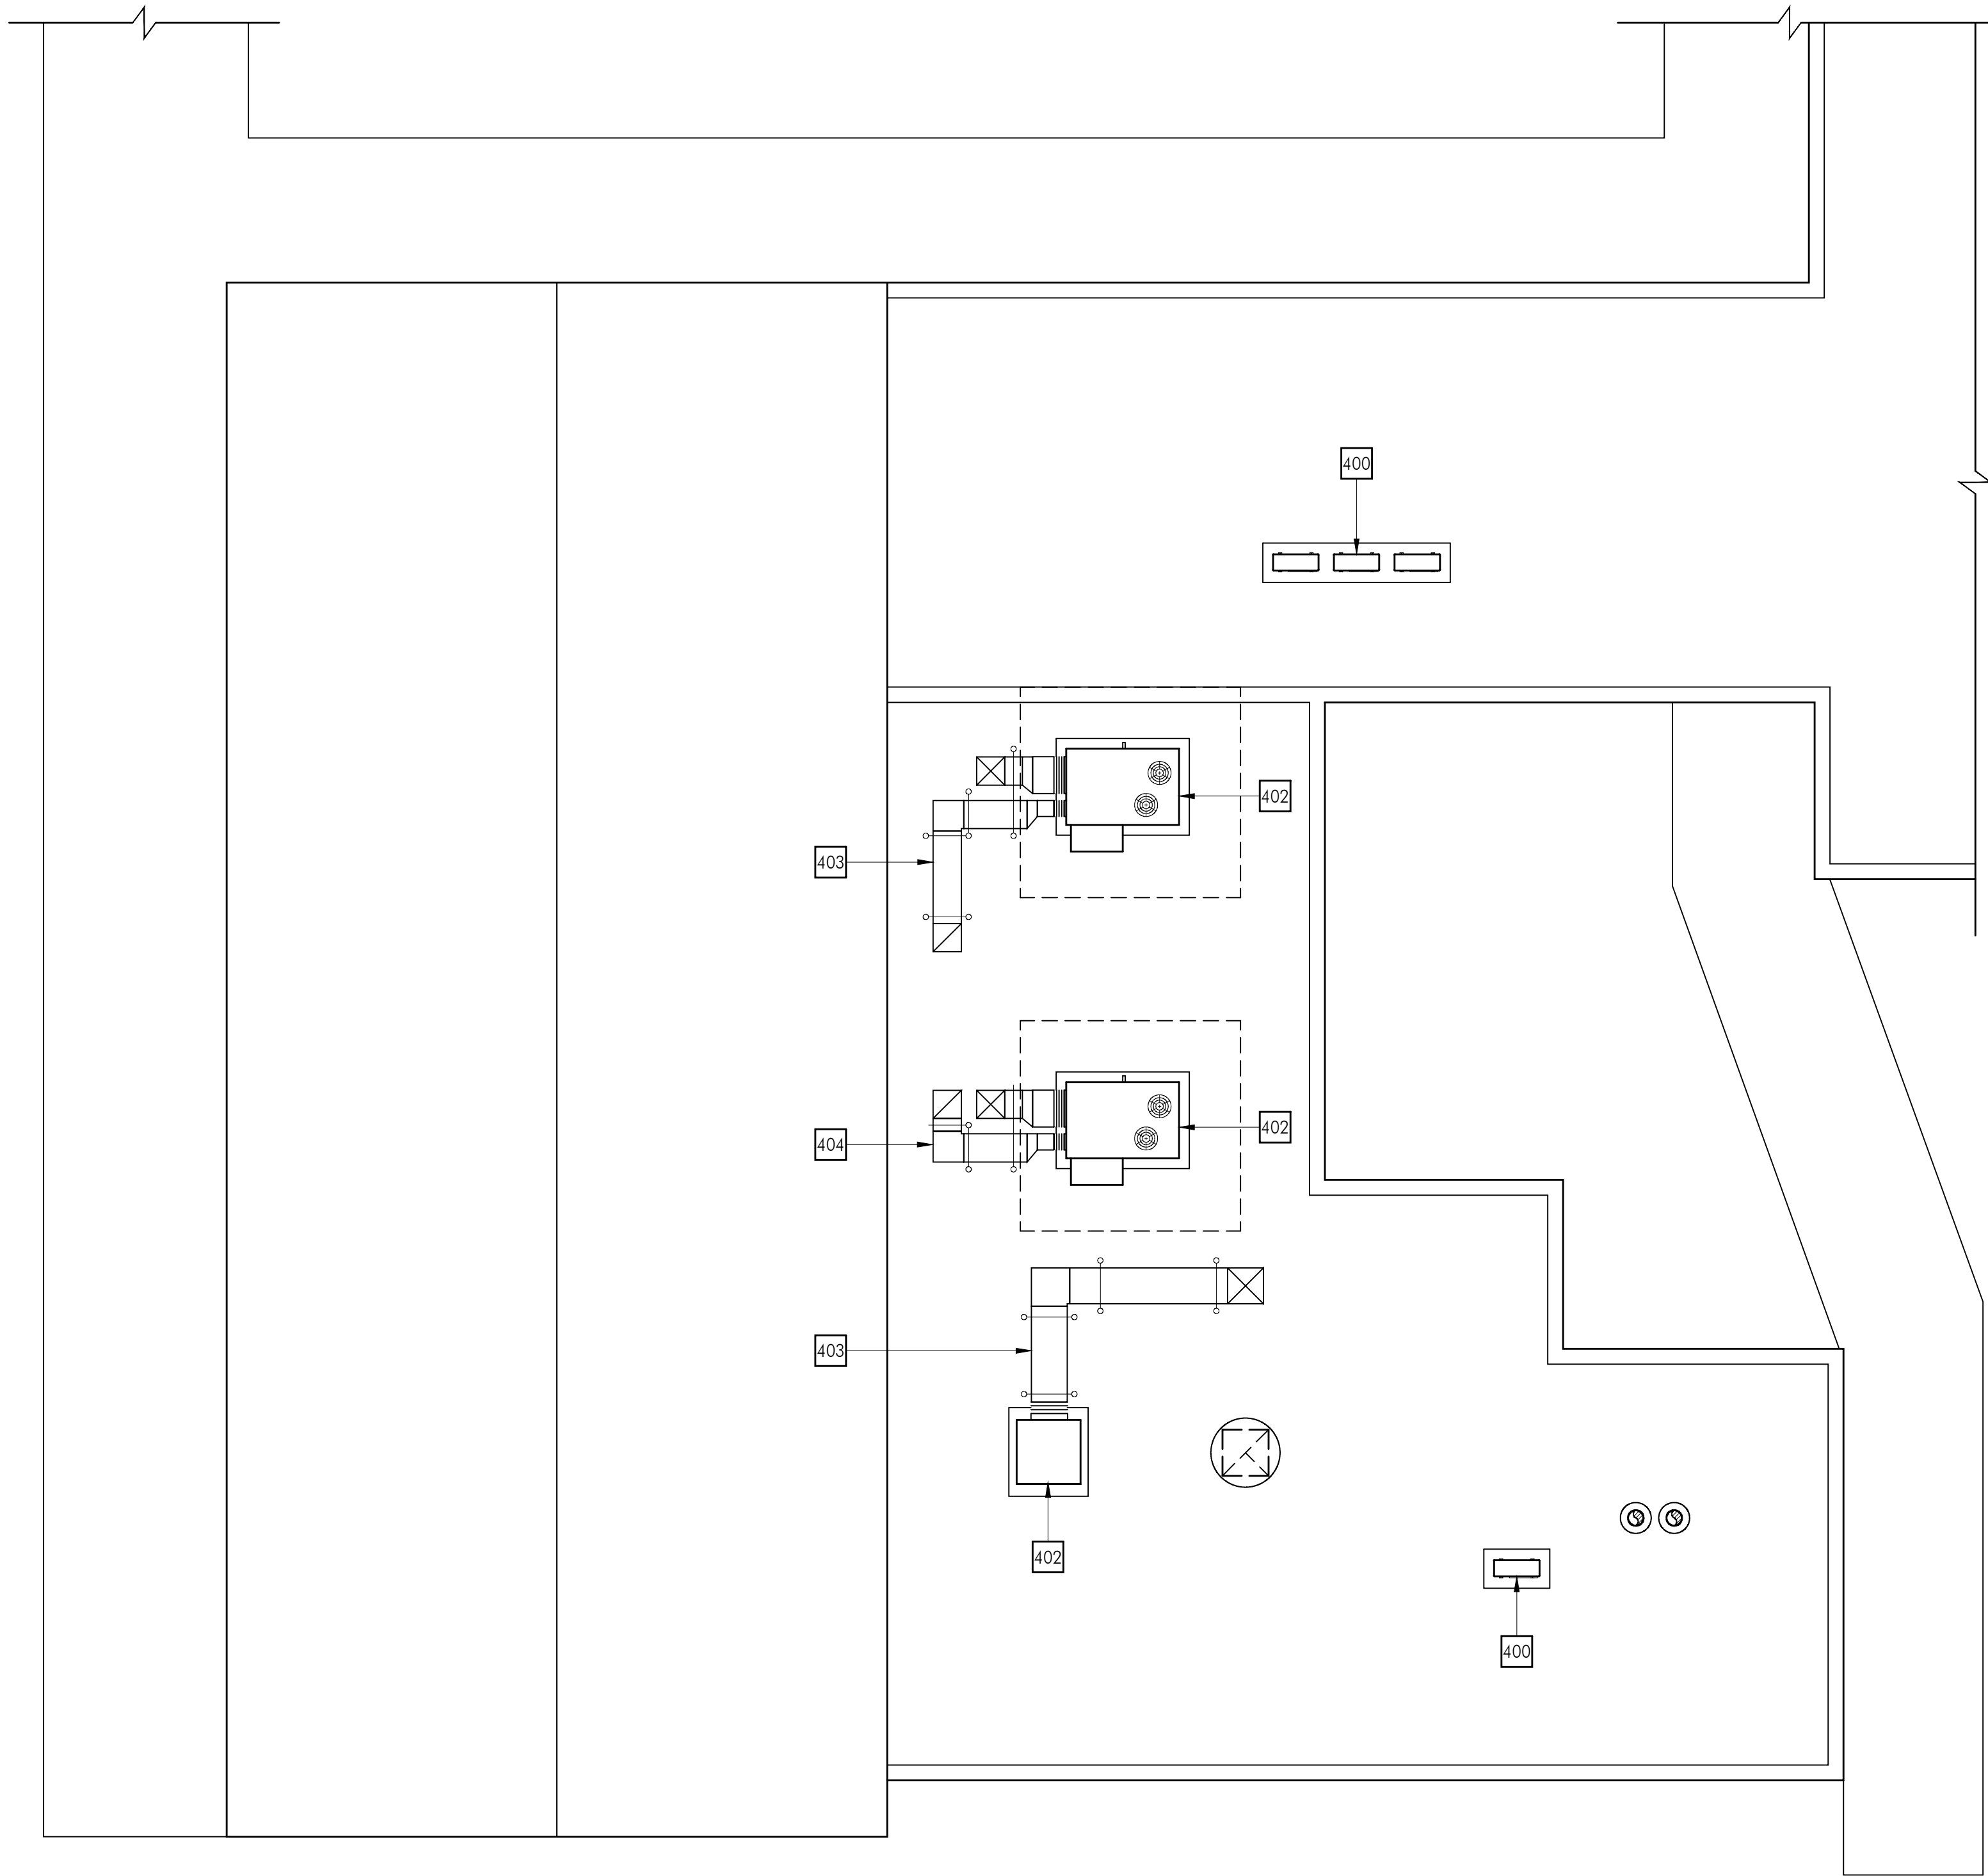


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Sheet Title
Building 'D' Reflected
Ceiling Plan

Sheet Number

AD231



FLOOR PLAN GENERAL NOTES


1. REMOVE EXISTING GYPSUM BOARD, TILE AND BACKER BOARD OR PLASTER TO ACCOMMODATE REMOVAL AND REPLACEMENT OF PIPING, ELECTRICAL AND FOR THE INSTALLATION OF SUPPORT BLOCKING AND MECHANICAL EQUIPMENT. PATCH BACK TO MATCH ADJACENT SURFACE.
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KEYNOTES

NO.	DESCRIPTION
400	ROOF MOUNTED MECHANICAL CONDENSER UNIT ON WOOD PAD. SEE PLAN FOR ROUGH DIMENSIONS, ADJUST PAD SIZE FOR NUMBER OF CONDENSERS AND REQUIRED CLEARANCES. SEE MECHANICAL AND DETAIL X/A831 FOR ADDITIONAL INFORMATION.
401	MECHANICAL DUCT PENETRATION AT EXISTING ROOF. SEE MECHANICAL AND DETAIL X/A831 FOR ADDITIONAL INFORMATION.
402	ROOF MOUNTED MECHANICAL UNIT. SEE MECHANICAL AND DETAIL X/A831 FOR ADDITIONAL INFORMATION.
403	ROOF MOUNTED MECHANICAL DUCT. SEE MECHANICAL AND DETAIL X/A831 FOR ADDITIONAL INFORMATION.



SCALE: 1/8"=1'-0"

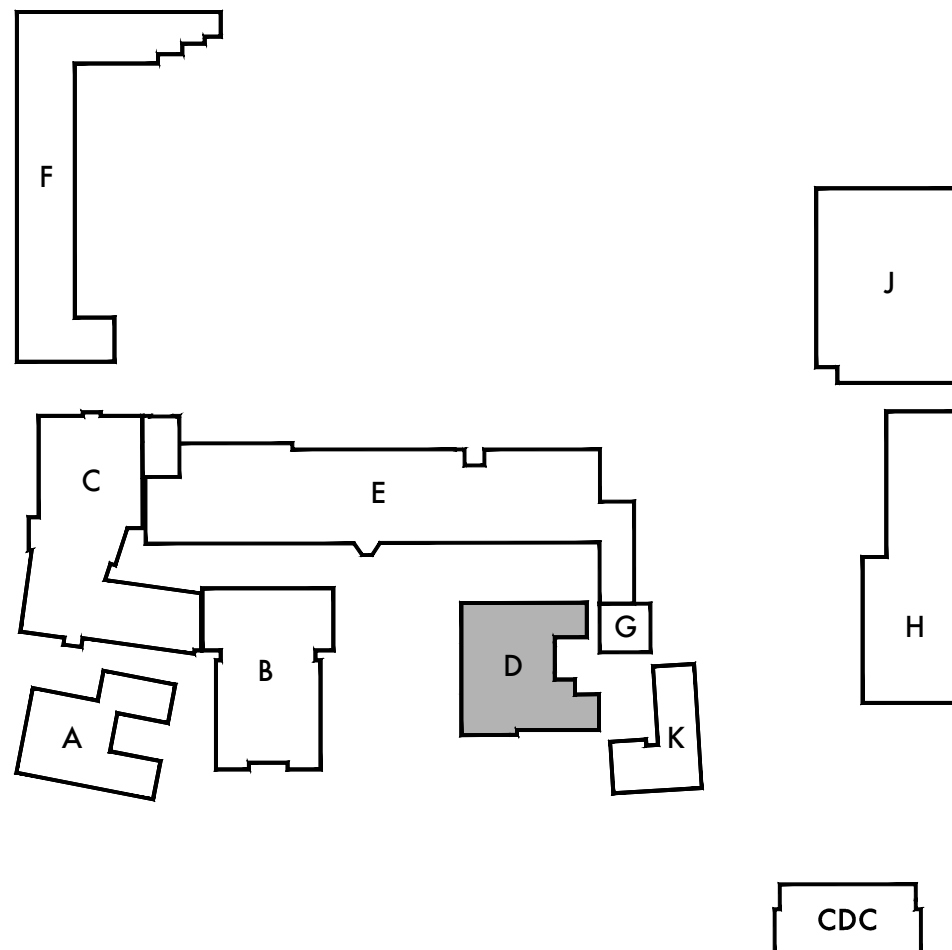

KEY PLAN

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Architect



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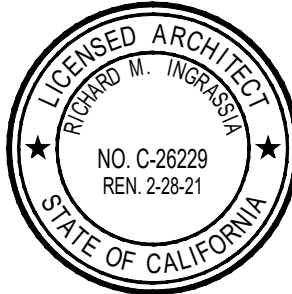
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Sheet Title

Building 'D' Roof Plan

Sheet Number

AD241

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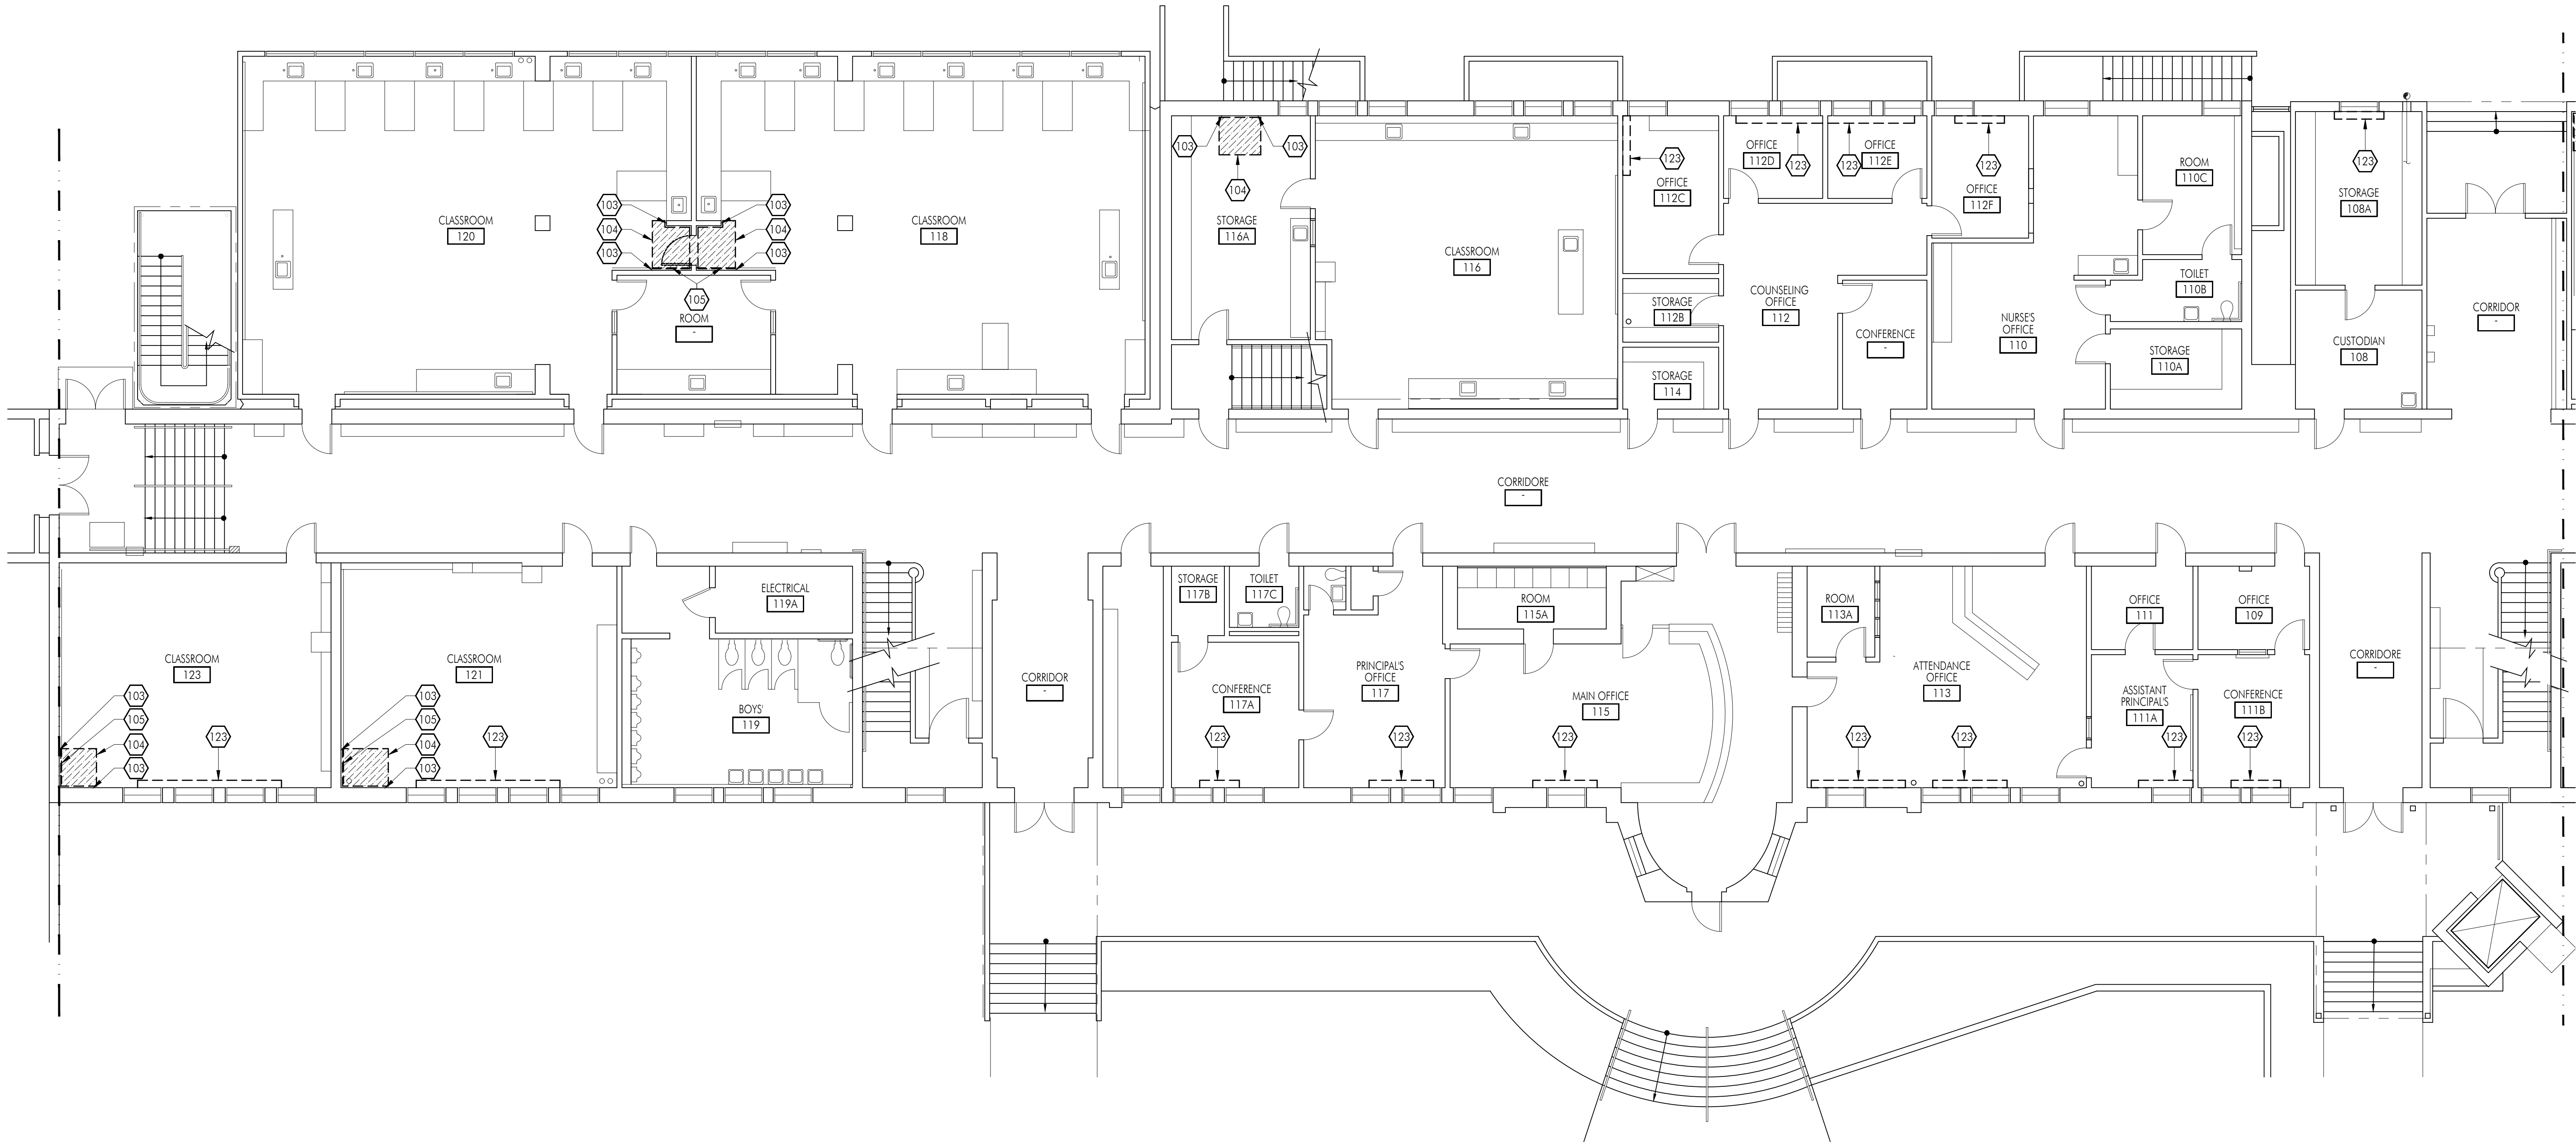
Consultants

Sheet Title

Building 'E' First
Floor Demolition
Plan

Sheet Number

AE210A



1 DEMOLITION FLOOR PLAN

FLOOR PLAN GENERAL NOTES

- REMOVE EXISTING GYPSUM BOARD, TILE AND BACKER BOARD OR PLASTER TO ACCOMMODATE REMOVAL AND REPLACEMENT OF PIPING, ELECTRICAL AND FOR THE INSTALLATION OF SUPPORT BLOCKING AND MECHANICAL EQUIPMENT. PATCH BACK TO MATCH ADJACENT SURFACE.
- REFER TO MECHANICAL, PLUMBING, ELECTRICAL AND FIRE ALARM DRAWINGS FOR ADDITIONAL SCOPE OF WORK IN EACH ROOM.
- ALL WALLS SHALL BE FULL HEIGHT TO THE ROOF DECK UNLESS NOTED OTHERWISE, AND SHALL BE CLOSED AND SEALED PER WALL TYPE AND AS DETAILED ON A711.
- UNSCHEDULED CUTTING, REMOVING OR TRIMMING OF EXISTING CONCRETE, MASONRY OR WOOD FRAMED WALLS IS NOT PERMITTED. UNLESS NOTED OTHERWISE ALL DOORS SHALL BE FITTED WITHIN EXISTING WALL OPENINGS WITHOUT ENLARGING OR TRIMMING HEAD OR JAMBS.

DEMOLITION KEYNOTES


NO.	DESCRIPTION
101	REMOVE EXISTING DOOR AND FRAME. PATCH AND REPAIR ADJACENT WALL AND FLOOR AT REMOVAL AND PREPARE ADJACENT WALL AND FLOOR SURFACES FOR NEW WORK.
102	REMOVE INDICATED PORTION OF EXISTING WALL OR PARTITION. PROTECT ADJACENT UNAFFECTED FINISHES, PATCH AND REPAIR AT REMOVAL AND PREPARE ADJACENT SURFACES FOR NEW WORK.
103	REMOVE EXISTING INTERIOR WALL FINISHES (INCLUDING BUT NOT LIMITED TO [SINGULARLY OR IN ANY COMBINATION] PLASTER, GYPSUM BOARD, ACOUSTIC TILE, TACKABLE SURFACE ETC.) DOWN TO STUDS (OR STRUCTURE AS OCCURS) IN PREPARATION FOR INSTALLATION OF NEW WALL AND FINISHES. PROTECT ADJACENT UNAFFECTED FINISHES, PATCH AND REPAIR AT REMOVAL AND PREPARE ADJACENT SURFACES FOR NEW WORK.
104	REMOVE PORTION OF EXISTING FLOOR AS REQUIRED FOR INSTALLATION OF NEW MECHANICAL CLOSET FRAMING AND EQUIPMENT. PATCH AND REPAIR AT REMOVAL AND PREPARE ADJACENT SURFACES FOR NEW WORK.
105	REMOVE PORTION OF EXISTING TACK BOARD (OR MARKER BOARD AS OCCURS) AS REQUIRED FOR INSTALLATION NEW WORK. TACK BOARD SHALL BE CUT IN A STRAIGHT LINE. PROTECT REMAINING TACK BOARD IN PLACE AND PROVIDE NEW TRIM TO MATCH EXISTING TRIM AT CUT EDGE.
106	REMOVE AND PROTECT EXISTING TACK BOARD (OR WHITE BOARD AS OCCURS) FOR RELOCATION IN SAME ROOM. SEE FLOOR PLAN FOR NEW LOCATION. TURN OVER TO DISTRICT WHERE NO NEW LOCATION IS AVAILABLE.
107	REMOVE EXISTING CONTROL CABINET AND ALL ASSOCIATED ITEMS INCLUDING CONDUIT AND. PROTECT EXISTING CONTROL CABINET FOR RELOCATION IN SAME ROOM AS SHOWN ON PLAN. REROUTE ALL EXISTING POWER AND DATA TO NEW LOCATION. SEE ELECTRICAL FOR MORE INFORMATION.
108	REMOVE INDICATED PORTION OF EXISTING WALL AT AN ELEVATION OF +10'-6" IN PREPARATION FOR NEW DUCT PENETRATION AND MECHANICAL REGISTER. SEE MECHANICAL FOR ADDITIONAL INFORMATION. [REVIEW LOCATION

DEMOLITION KEYNOTES

NO.	DESCRIPTION
120	REMOVE EXISTING MECHANICAL EQUIPMENT AND APPURTENANCES. SEE MECHANICAL, ELECTRICAL AND PLUMBING DRAWINGS FOR ADDITIONAL INFORMATION.
121	EXISTING MECHANICAL SOFFIT TO BE REUSED. REMOVE PORTIONS OF EXISTING PLASTER OR GYPSUM BOARD FINISH AS REQUIRED TO PERFORM NEW WORK. PATCH AND REPAIR AT REMOVAL TO MATCH EXISTING ADJACENT FINISH.
122	PROTECT EXISTING DUCT IN PLACE TO BE REUSED. SEE MECHANICAL FOR ADDITIONAL INFORMATION.
123	REMOVE EXISTING RADIATOR AND ALL ASSOCIATED PIPING. SEE MECHANICAL FOR ADDITIONAL INFORMATION. PATCH AND REPAIR AT REMOVAL TO MATCH EXISTING ADJACENT FINISH.
124	REMOVE EXISTING WALL MOUNTED MECHANICAL REGISTER AND ALL ASSOCIATED ITEMS. PREPARE EXISTING OPENING FOR NEW REGISTER AND DUCT AT SAME LOCATION. SEE MECHANICAL FOR ADDITIONAL INFORMATION.

DEMOLITION FLOOR PLAN LEGEND

SYMBOL	DESCRIPTION
	(E) STUD WALL OR PARTITION TO REMAIN.
	(E) STUD WALL OR PARTITION TO BE REMOVED.
	(E) DOOR TO REMAIN. SAND, CLEAN AND PATCH DOOR IN PREPARATION FOR NEW FINISHES.
	REMOVE EXISTING DOOR AND APPURTENANCES. PROTECT EXISTING FRAME IN PLACE U.N.O. CLEAN AND PATCH FRAME IN PREPARATION FOR NEW FINISHES AND DOOR HARDWARE.

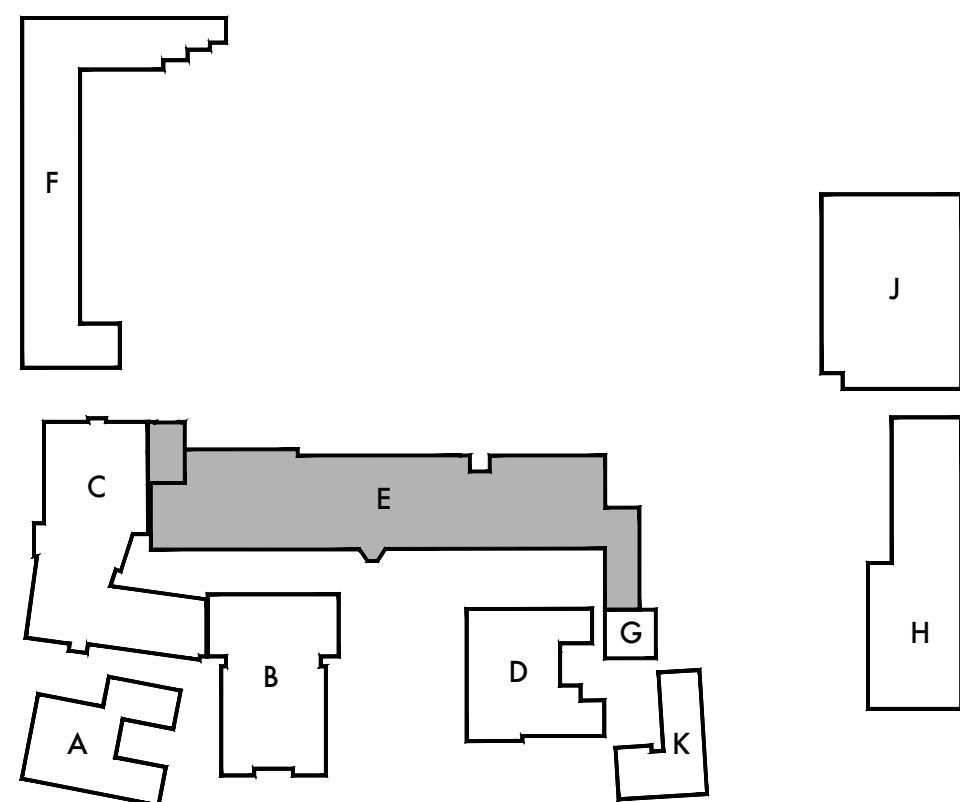

KEY PLAN

DSA Stamp

Architect



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Lincoln Middle School
1501 California Avenue
Santa Monica, California 90403


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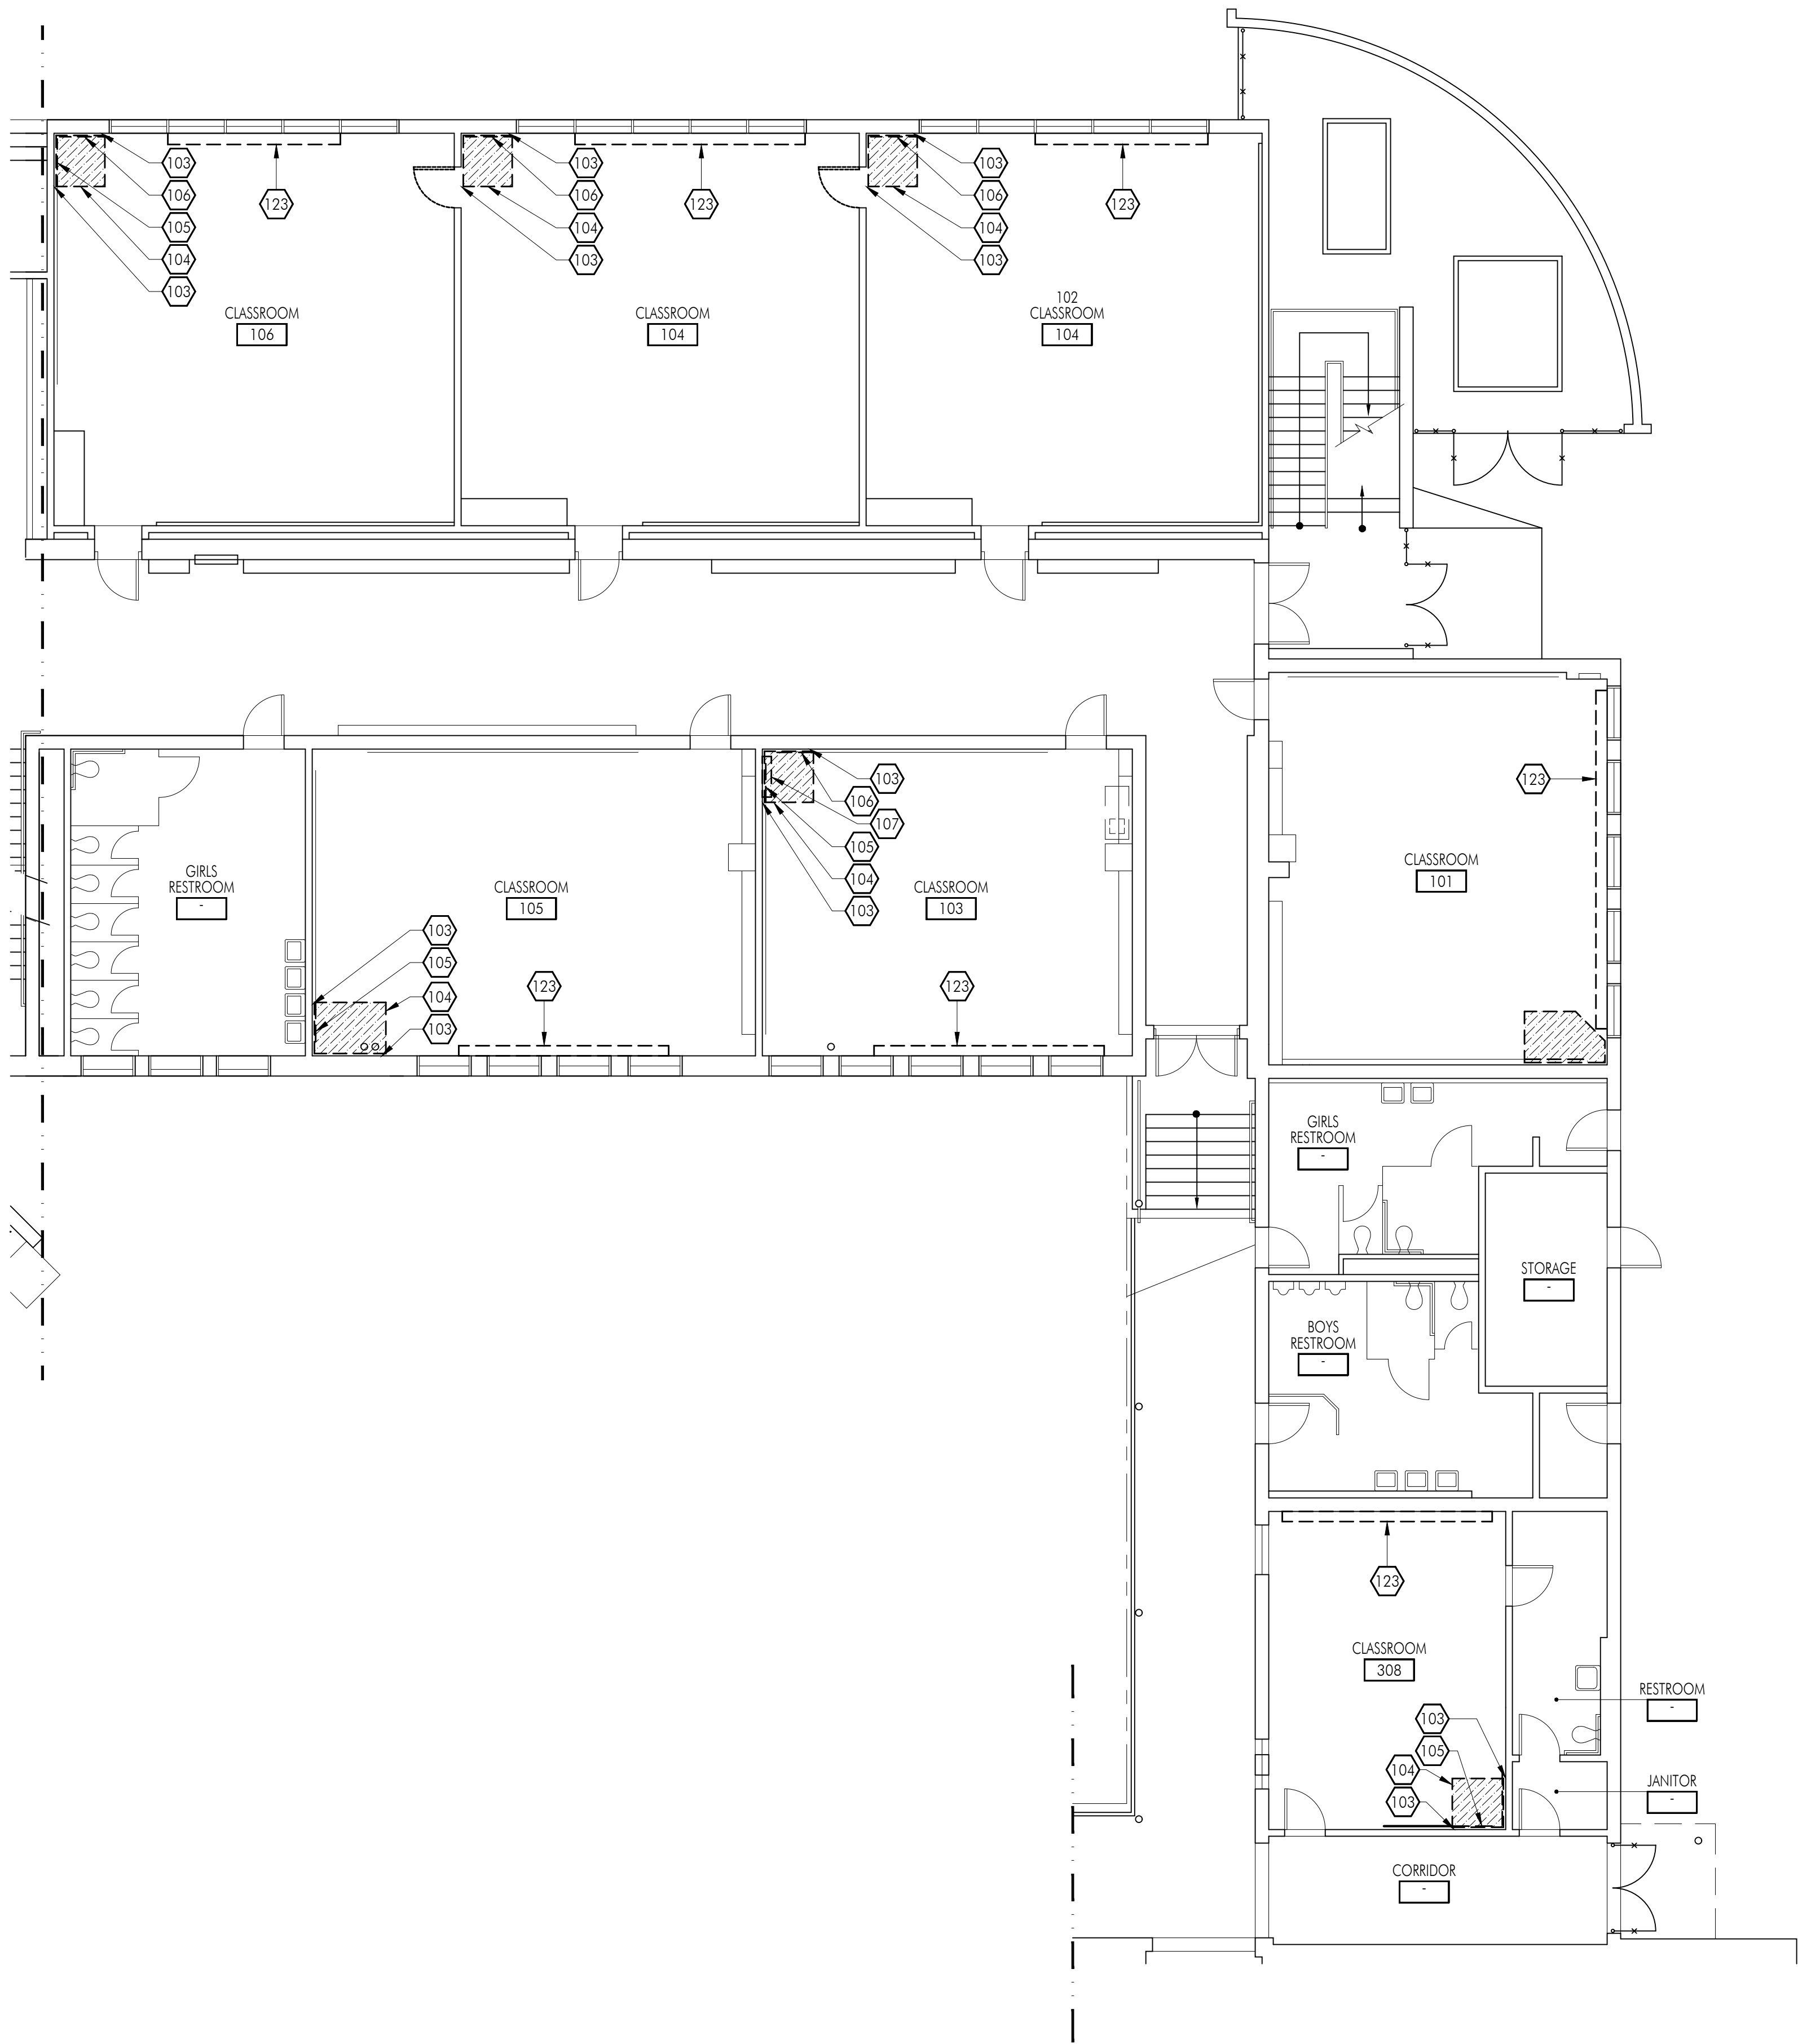
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Sheet Title

Building 'E' First
Floor Demolition
Plan

Sheet Number

AE201B

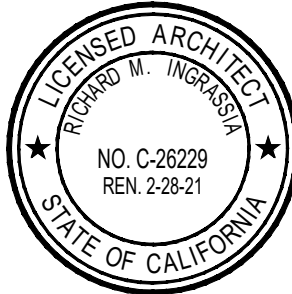

1 DEMOLITION FLOOR PLAN

FLOOR PLAN GENERAL NOTES


- REMOVE EXISTING GYPSUM BOARD, TILE AND BACKER BOARD OR PLASTER TO ACCOMMODATE REMOVAL AND REPLACEMENT OF PIPING, ELECTRICAL AND FOR THE INSTALLATION OF SUPPORT BLOCKING AND MECHANICAL EQUIPMENT. PATCH BACK TO MATCH ADJACENT SURFACE.
- REFER TO MECHANICAL, PLUMBING, ELECTRICAL AND FIRE ALARM DRAWINGS FOR ADDITIONAL SCOPE OF WORK IN EACH ROOM.
- ALL WALLS SHALL BE FULL HEIGHT TO THE ROOF DECK UNLESS NOTED OTHERWISE, AND SHALL BE CLOSED AND SEALED PER WALL TYPE AND AS DETAILED ON A711.
- UNSCHEDULED CUTTING, REMOVING OR TRIMMING OF EXISTING CONCRETE, MASONRY OR WOOD FRAMED WALLS IS NOT PERMITTED. UNLESS NOTED OTHERWISE ALL DOORS SHALL BE FITTED WITHIN EXISTING WALL OPENINGS WITHOUT ENLARGING OR TRIMMING HEAD OR JAMBS.

DEMOLITION KEYNOTES

NO.	DESCRIPTION
101	REMOVE EXISTING DOOR AND FRAME. PATCH AND REPAIR ADJACENT WALL AND FLOOR AT REMOVAL AND PREPARE ADJACENT WALL AND FLOOR SURFACES FOR NEW WORK.
102	REMOVE INDICATED PORTION OF EXISTING WALL OR PARTITION. PROTECT ADJACENT UNAFFECTED FINISHES, PATCH AND REPAIR AT REMOVAL AND PREPARE ADJACENT SURFACES FOR NEW WORK.
103	REMOVE EXISTING INTERIOR WALL FINISHES (INCLUDING BUT NOT LIMITED TO [SINGULARLY OR IN ANY COMBINATION] PLASTER, GYPSUM BOARD, ACOUSTIC TILE, TACKABLE SURFACE ETC.) DOWN TO STUDS (OR STRUCTURE AS OCCURS) IN PREPARATION FOR INSTALLATION OF NEW WALL AND FINISHES. PROTECT ADJACENT UNAFFECTED FINISHES, PATCH AND REPAIR AT REMOVAL AND PREPARE ADJACENT SURFACES FOR NEW WORK.
104	REMOVE PORTION OF EXISTING FLOOR AS REQUIRED FOR INSTALLATION OF NEW MECHANICAL CLOSET FRAMING AND EQUIPMENT. PATCH AND REPAIR AT REMOVAL AND PREPARE ADJACENT SURFACES FOR NEW WORK.
105	REMOVE PORTION OF EXISTING TACK BOARD (OR MARKER BOARD AS OCCURS) AS REQUIRED FOR INSTALLATION NEW WORK. TACK BOARD SHALL BE CUT IN A STRAIGHT LINE. PROTECT REMAINING TACK BOARD IN PLACE AND PROVIDE NEW TRIM TO MATCH EXISTING TRIM AT CUT EDGE.
106	REMOVE AND PROTECT EXISTING TACK BOARD (OR WHITE BOARD AS OCCURS) FOR RELOCATION IN SAME ROOM. SEE FLOOR PLAN FOR NEW LOCATION. TURN OVER TO DISTRICT WHERE NO NEW LOCATION IS AVAILABLE.
107	REMOVE EXISTING CONTROL CABINET AND ALL ASSOCIATED ITEMS INCLUDING CONDUIT AND. PROTECT EXISTING CONTROL CABINET FOR RELOCATION IN SAME ROOM AS SHOWN ON PLAN. REROUTE ALL EXISTING POWER AND DATA TO NEW LOCATION. SEE ELECTRICAL FOR MORE INFORMATION.
120	REMOVE EXISTING MECHANICAL EQUIPMENT AND APPURTENANCES. SEE MECHANICAL FOR ADDITIONAL INFORMATION. REVIEW LOCATION OF EXISTING MECHANICAL EQUIPMENT FOR ADDITIONAL INFORMATION. (REVIEW LOCATION OF EXISTING MECHANICAL EQUIPMENT FOR ADDITIONAL INFORMATION.)
121	EXISTING MECHANICAL SOFFIT TO BE REUSED. REMOVE PORTIONS OF EXISTING PLASTER OR GYPSUM BOARD FINISH AS REQUIRED TO PERFORM NEW WORK. PATCH AND REPAIR AT REMOVAL TO MATCH EXISTING ADJACENT FINISH.
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DEMOLITION FLOOR PLAN LEGEND

SYMBOL	DESCRIPTION
	(E) STUD WALL OR PARTITION TO REMAIN.
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KEY PLAN

DSA Stamp

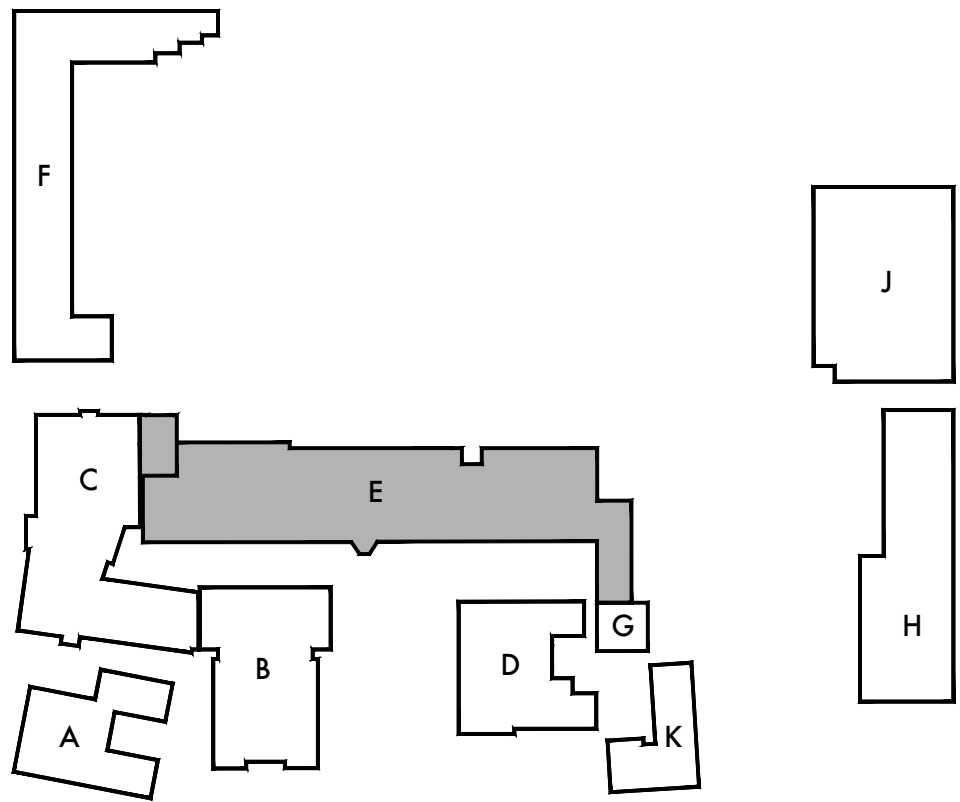Architect



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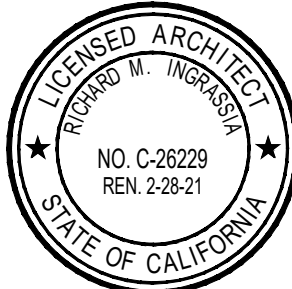
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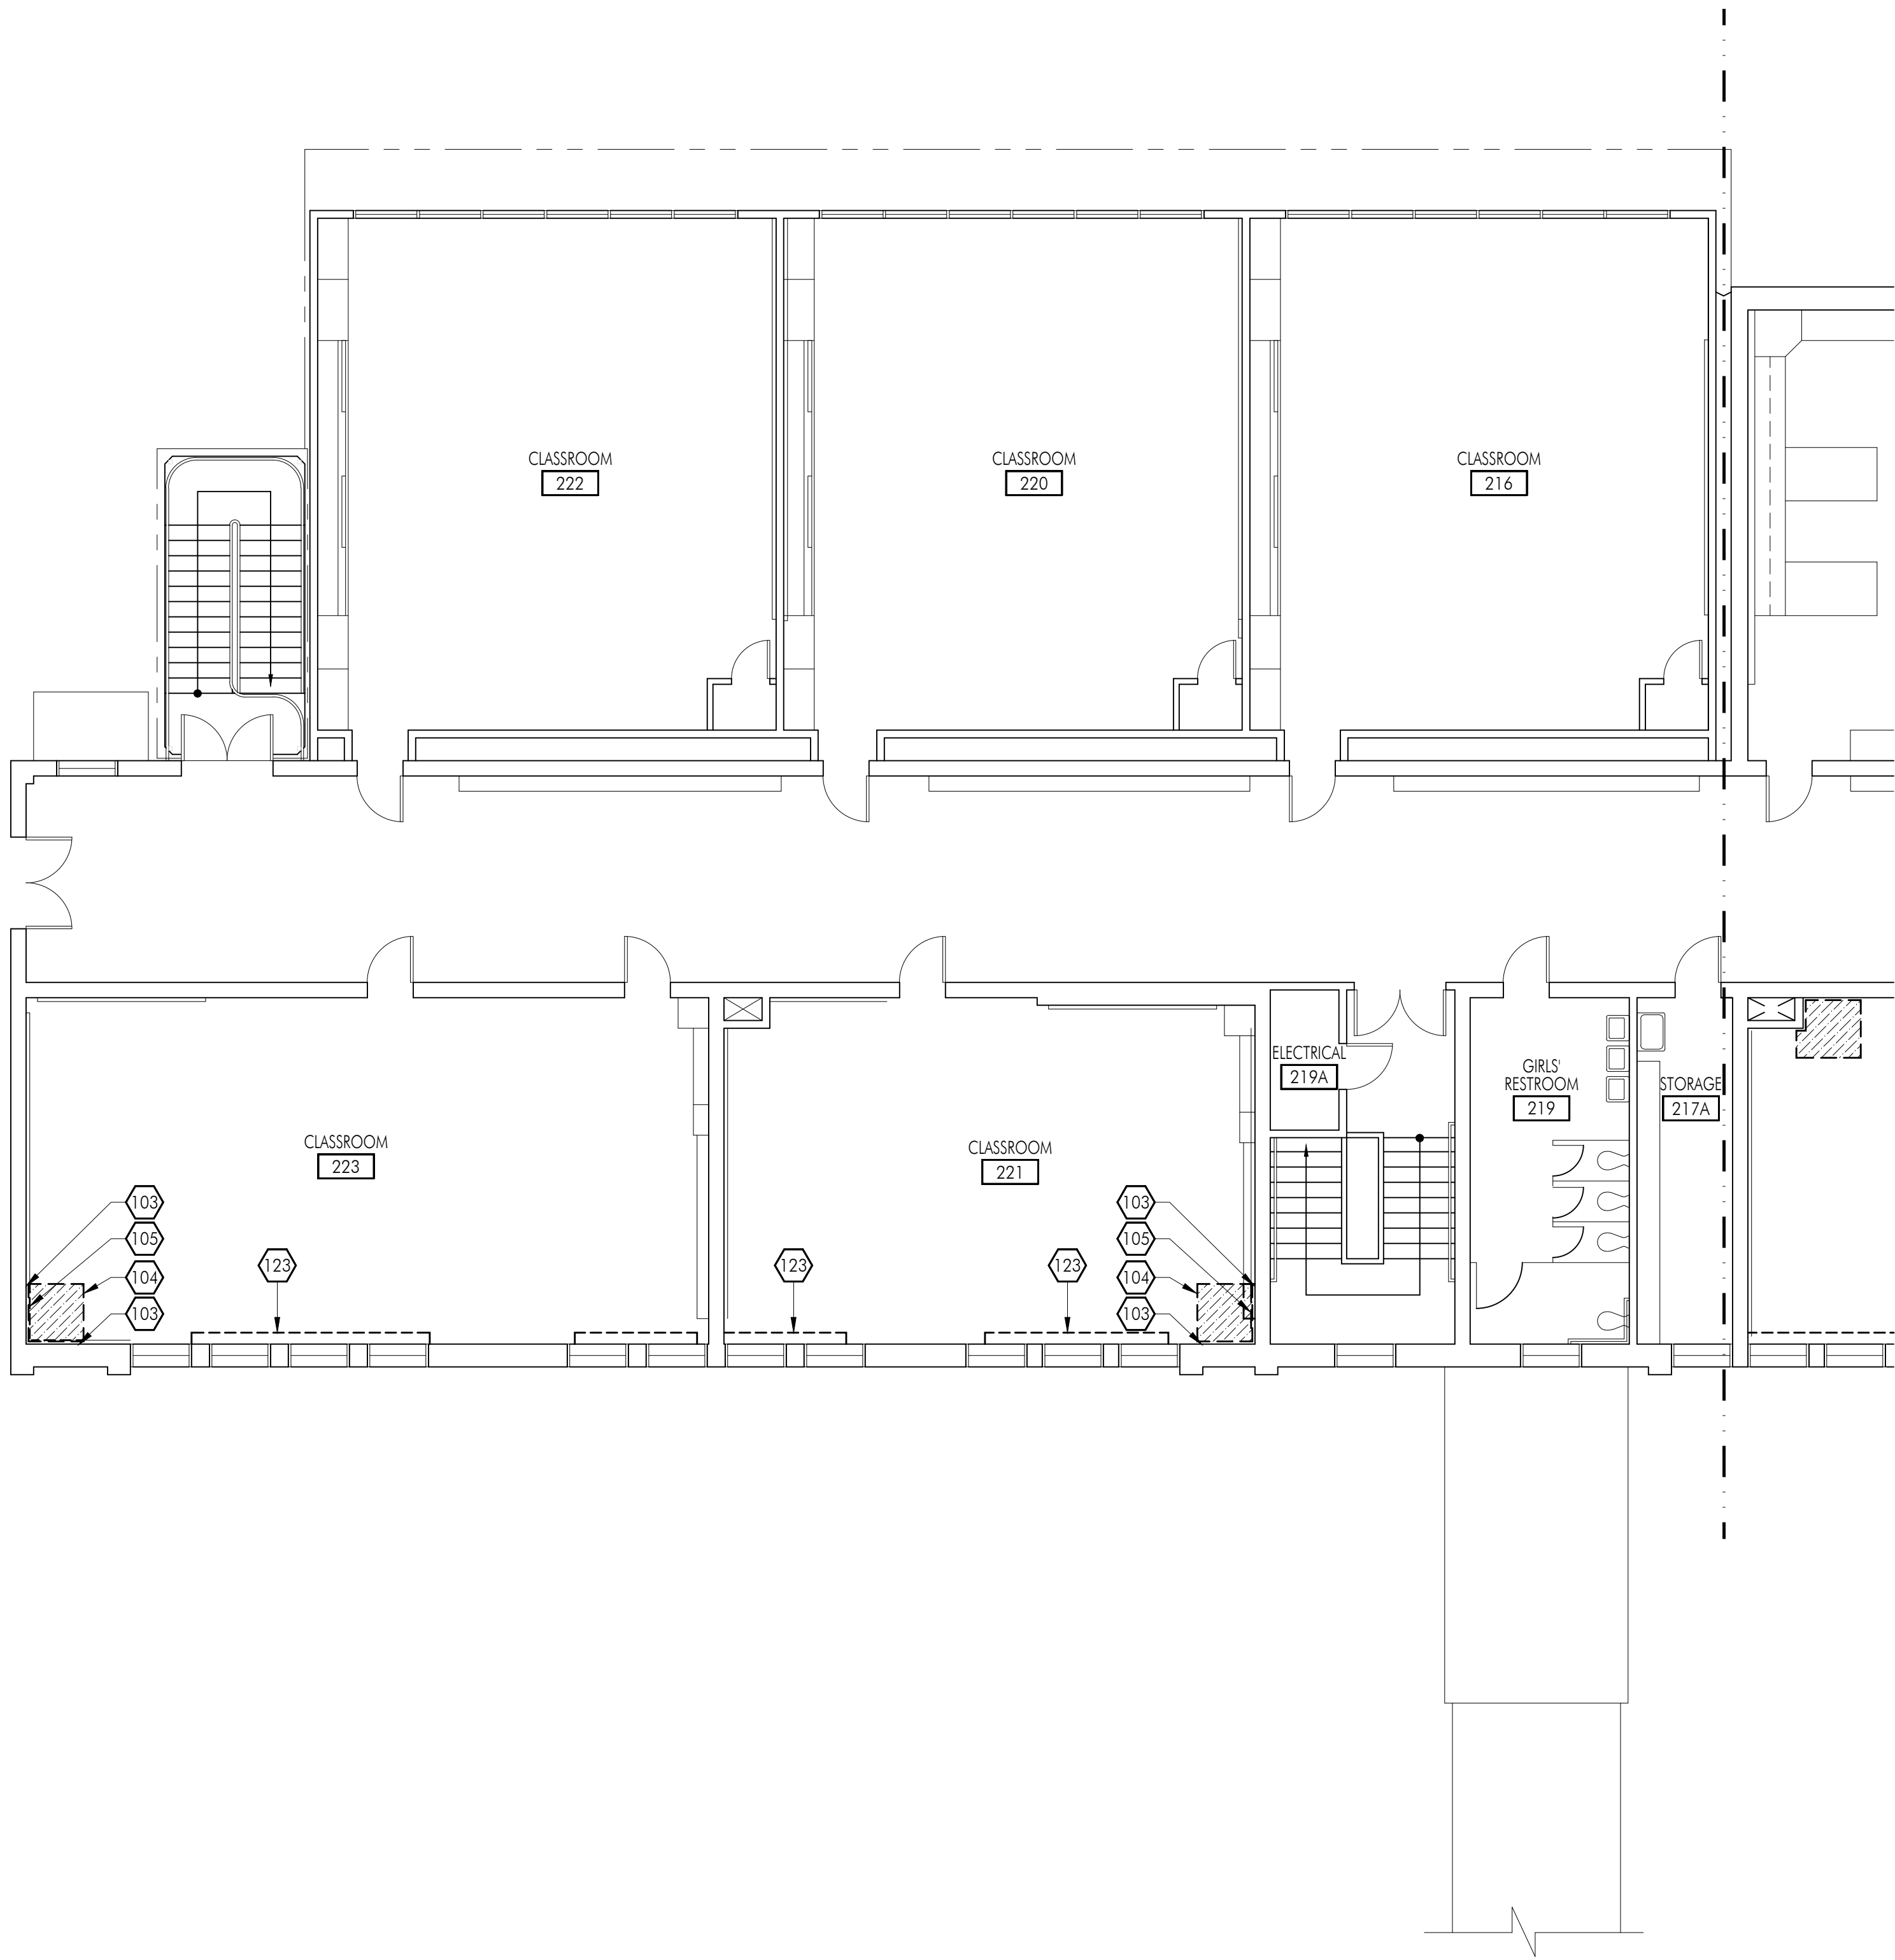


Consultants

Sheet Title
Building 'E' Second
Floor Demolition
Plan

Sheet Number

AE202A



1 DEMOLITION FLOOR PLAN

FLOOR PLAN GENERAL NOTES


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DEMOLITION KEYNOTES

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120	REMOVE EXISTING MECHANICAL EQUIPMENT AND APPURTENANCES OFF MECHANICAL REGISTER AND DUCT DURING REMOVAL OF MECHANICAL REGISTER. SEE MECHANICAL FOR ADDITIONAL INFORMATION. (REVIEW LOCATION)
121	EXISTING MECHANICAL SOFFIT TO BE REUSED. REMOVE PORTIONS OF EXISTING PLASTER OR GYPSUM BOARD FINISH AS REQUIRED TO PERFORM NEW WORK. PATCH AND REPAIR AT REMOVAL TO MATCH EXISTING ADJACENT FINISH.
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DEMOLITION FLOOR PLAN LEGEND

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KEY PLAN

DSA Stamp

Architect

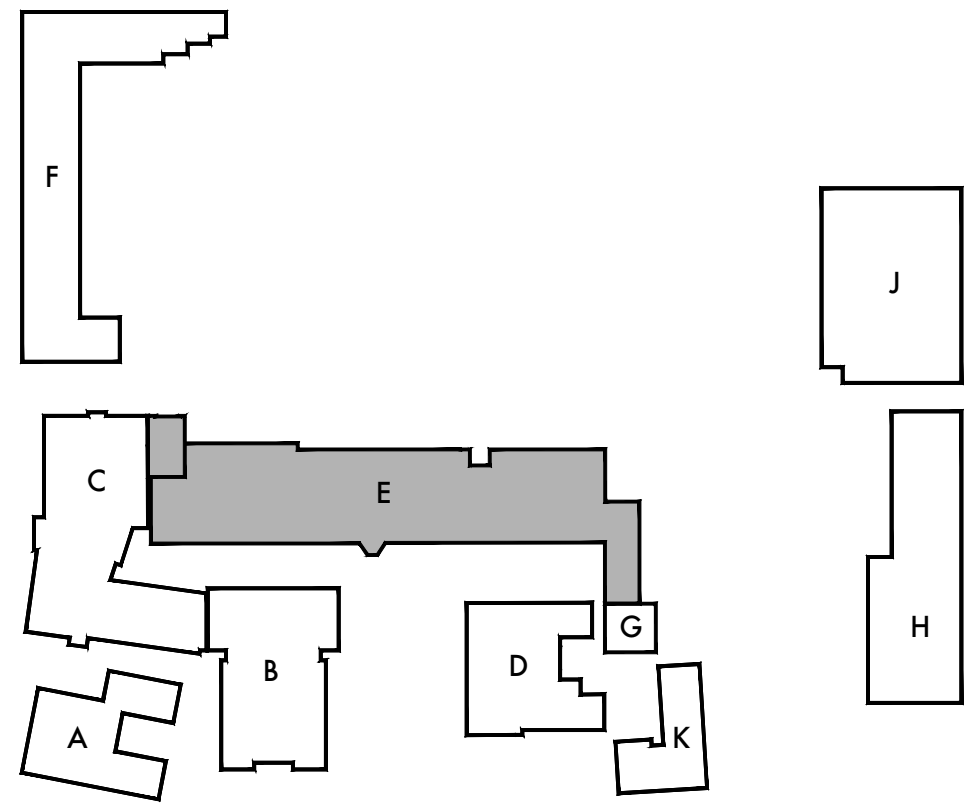

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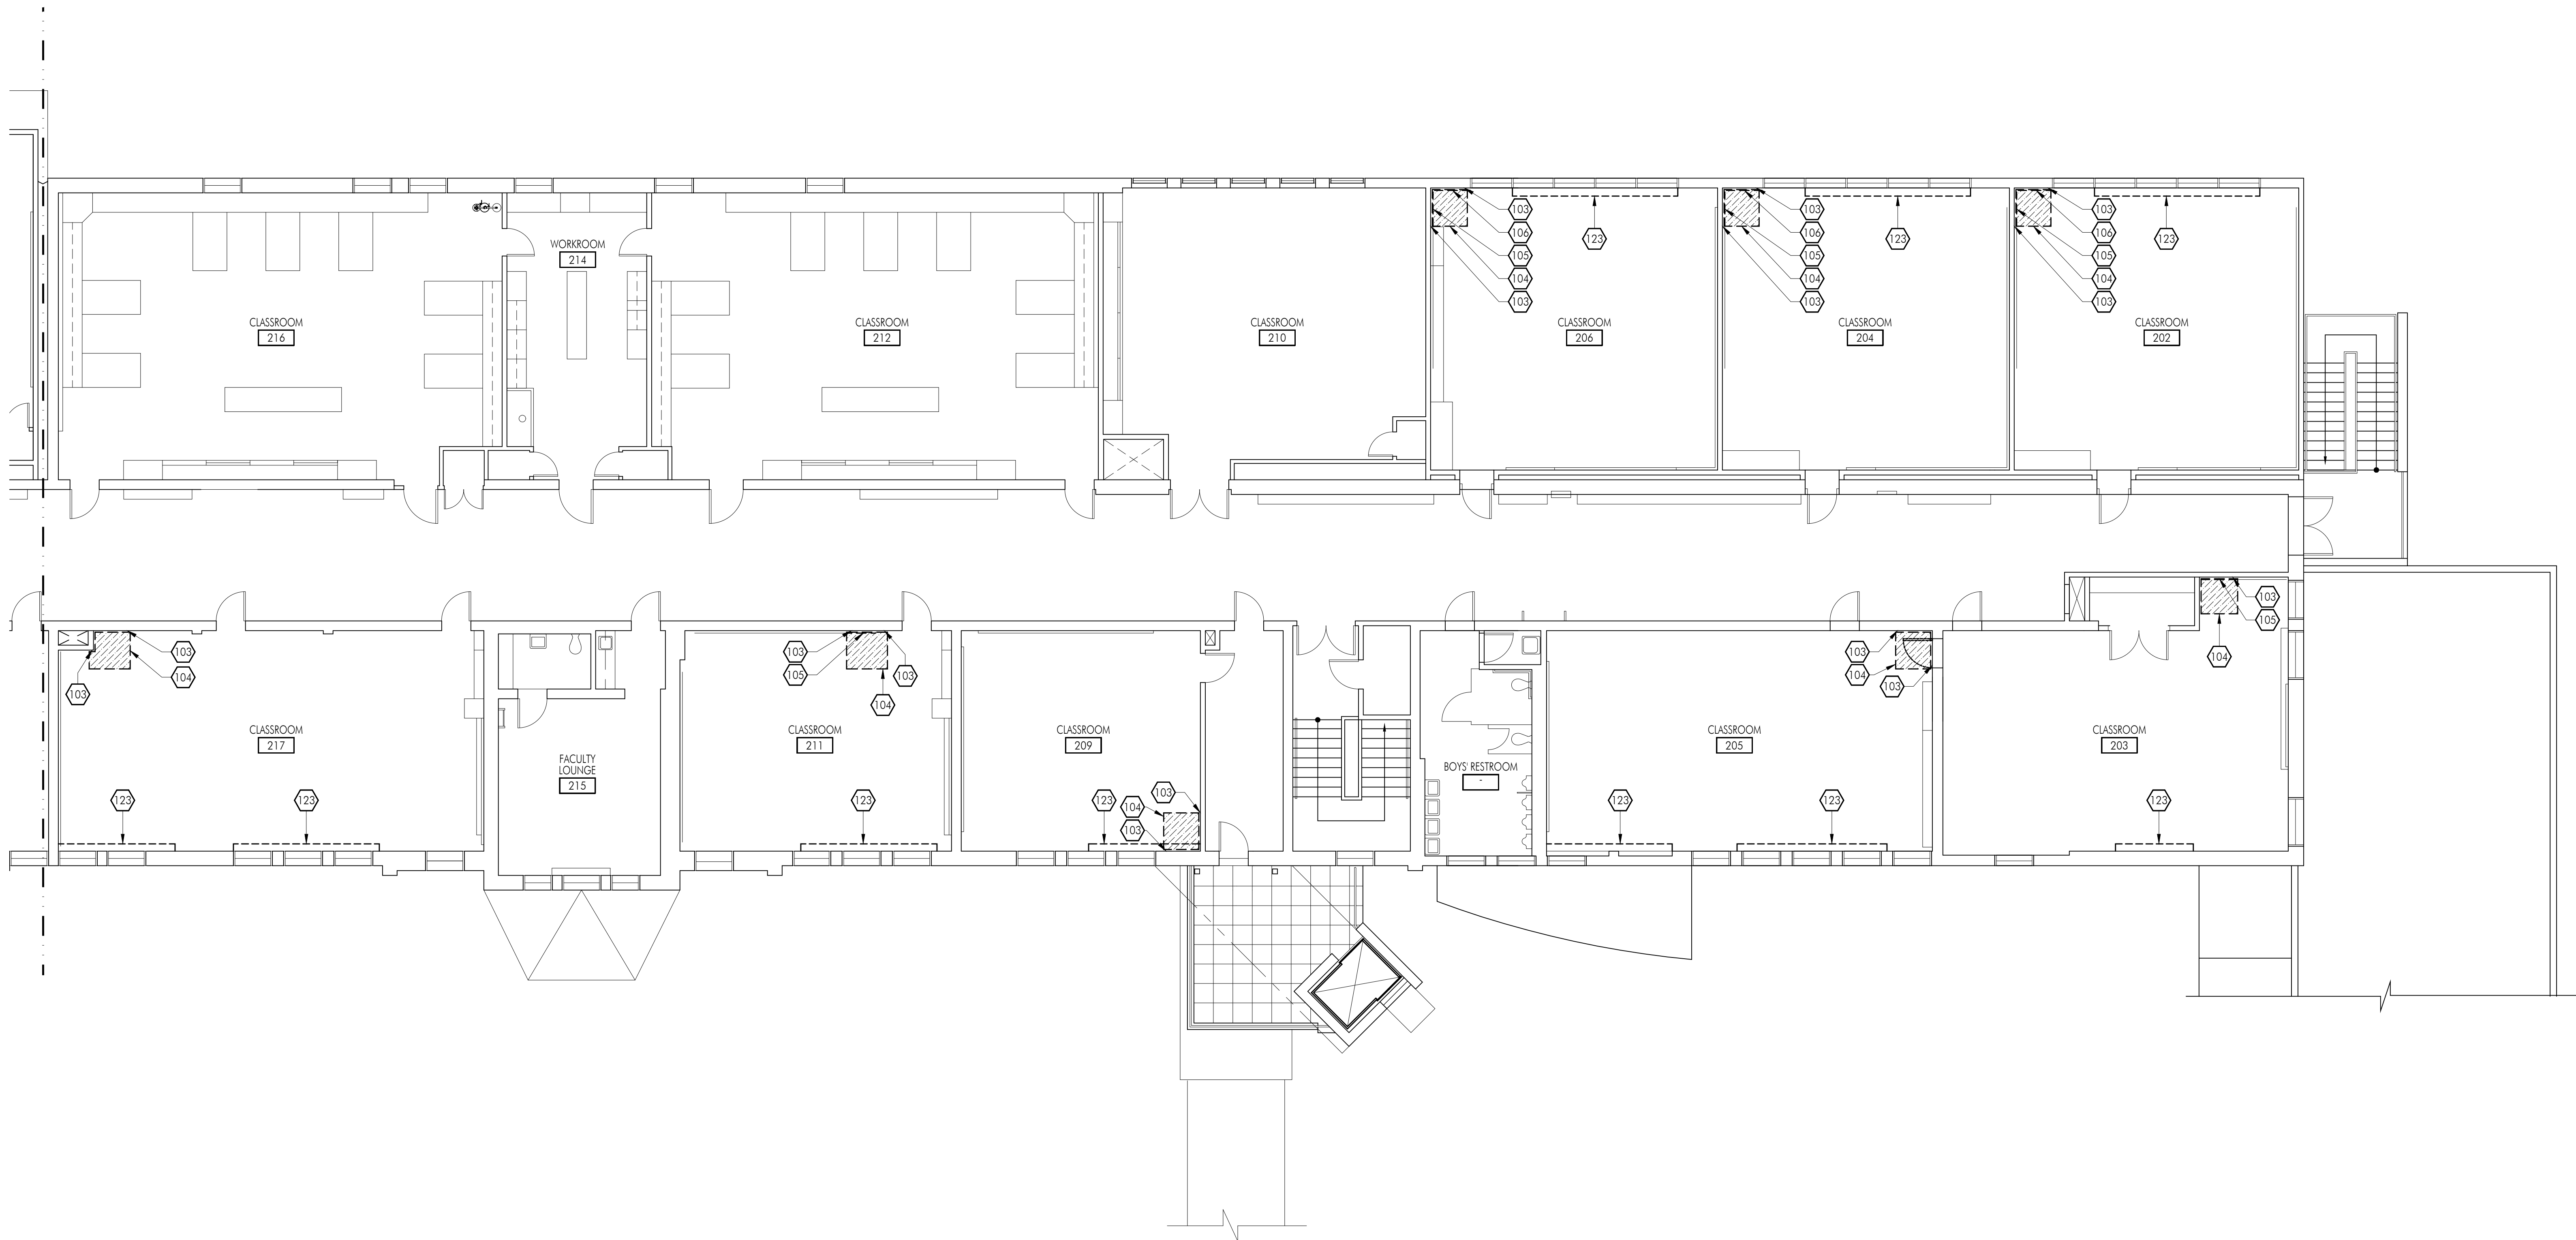
Consultants

Sheet Title

Building 'E' Second
Floor Demolition
Plan

Sheet Number

AE202B



1 DEMOLITION FLOOR PLAN

FLOOR PLAN GENERAL NOTES


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DEMOLITION KEYNOTES

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102	REMOVE INDICATED PORTION OF EXISTING WALL OR PARTITION. PROTECT ADJACENT UNAFFECTED FINISHES, PATCH AND REPAIR AT REMOVAL AND PREPARE ADJACENT SURFACES FOR NEW WORK.
103	REMOVE EXISTING INTERIOR WALL FINISHES (INCLUDING BUT NOT LIMITED TO [SINGULARLY OR IN ANY COMBINATION] PLASTER, GYPSUM BOARD, ACOUSTIC TILE, TACKABLE SURFACE ETC.) DOWN TO STUDS (OR STRUCTURE AS OCCURS) IN PREPARATION FOR INSTALLATION OF NEW WALL AND FINISHES. PROTECT ADJACENT UNAFFECTED FINISHES, PATCH AND REPAIR AT REMOVAL AND PREPARE ADJACENT SURFACES FOR NEW WORK.
104	REMOVE PORTION OF EXISTING FLOOR AS REQUIRED FOR INSTALLATION OF NEW MECHANICAL CLOSET FRAMING AND EQUIPMENT. PATCH AND REPAIR AT REMOVAL AND PREPARE ADJACENT SURFACES FOR NEW WORK.
105	REMOVE PORTION OF EXISTING TACK BOARD (OR MARKER BOARD AS OCCURS) AS REQUIRED FOR INSTALLATION NEW WORK. TACK BOARD SHALL BE CUT IN A STRAIGHT LINE. PROTECT REMAINING TACK BOARD IN PLACE AND PROVIDE NEW TRIM TO MATCH EXISTING TRIM AT CUT EDGE.
106	REMOVE AND PROTECT EXISTING TACK BOARD (OR WHITE BOARD AS OCCURS) FOR RELOCATION IN SAME ROOM. SEE FLOOR PLAN FOR NEW LOCATION. TURN OVER TO DISTRICT WHERE NO NEW LOCATION IS AVAILABLE.
107	REMOVE EXISTING CONTROL CABINET AND ALL ASSOCIATED ITEMS INCLUDING CONDUIT AND. PROTECT EXISTING CONTROL CABINET FOR RELOCATION IN SAME ROOM AS SHOWN ON PLAN. REROUTE ALL EXISTING POWER AND DATA TO NEW LOCATION. SEE ELECTRICAL FOR MORE INFORMATION.
120	REMOVE EXISTING MECHANICAL EQUIPMENT AND APPURTENANCES OFF MECHANICAL REGISTER AND DUCTWORK. SEE MECHANICAL FOR ADDITIONAL INFORMATION. (REVIEW LOCATION)
121	EXISTING MECHANICAL SOFFIT TO BE REUSED. REMOVE PORTIONS OF EXISTING PLASTER OR GYPSUM BOARD FINISH AS REQUIRED TO PERFORM NEW WORK. PATCH AND REPAIR AT REMOVAL TO MATCH EXISTING ADJACENT FINISH.
122	PROTECT EXISTING DUCT IN PLACE TO BE REUSED. SEE MECHANICAL FOR ADDITIONAL INFORMATION.
123	REMOVE EXISTING RADIATOR AND ALL ASSOCIATED PIPING. SEE MECHANICAL FOR ADDITIONAL INFORMATION. PATCH AND REPAIR AT REMOVAL TO MATCH EXISTING ADJACENT FINISH.
124	REMOVE EXISTING WALL MOUNTED MECHANICAL REGISTER AND ALL ASSOCIATED ITEMS. PREPARE EXISTING OPENING FOR NEW REGISTER AND DUCT AT SAME LOCATION. SEE MECHANICAL FOR ADDITIONAL INFORMATION.

DEMOLITION FLOOR PLAN LEGEND

SYMBOL	DESCRIPTION
	(E) STUD WALL OR PARTITION TO REMAIN.
	(E) STUD WALL OR PARTITION TO BE REMOVED.
	(E) DOOR TO REMAIN. SAND, CLEAN AND PATCH DOOR IN PREPARATION FOR NEW FINISHES.
	REMOVE EXISTING DOOR AND APPURTENANCES. PROTECT EXISTING FRAME IN PLACE U.N.O. CLEAN AND PATCH FRAME IN PREPARATION FOR NEW FINISHES AND DOOR HARDWARE.

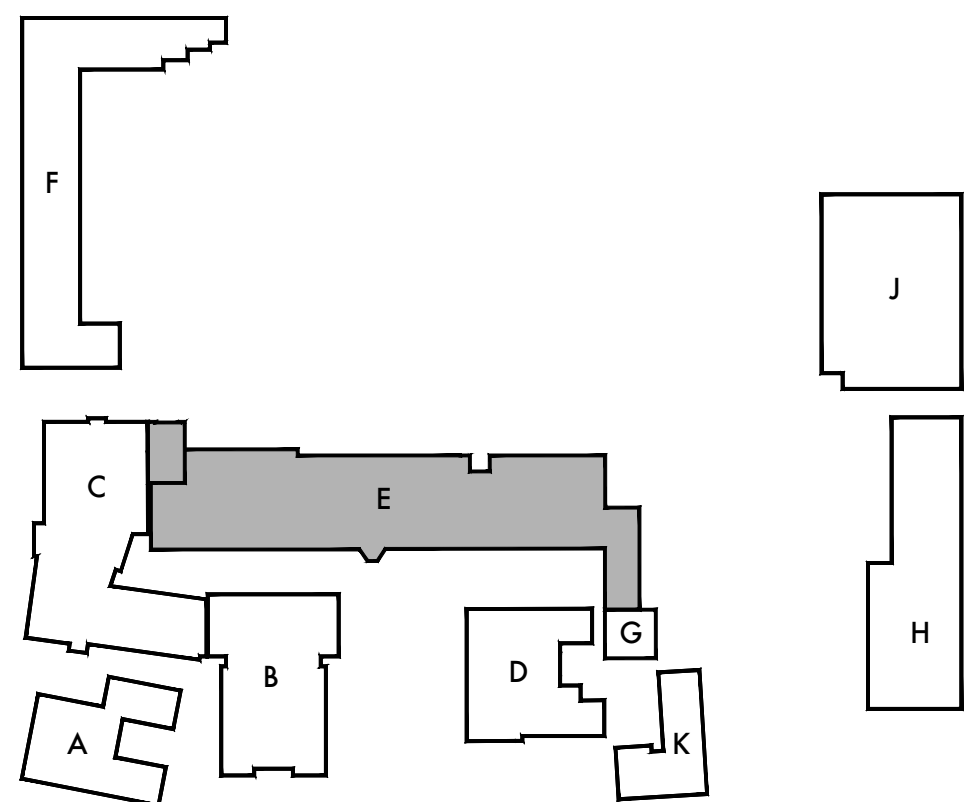

KEY PLAN

DSA Stamp

Architect



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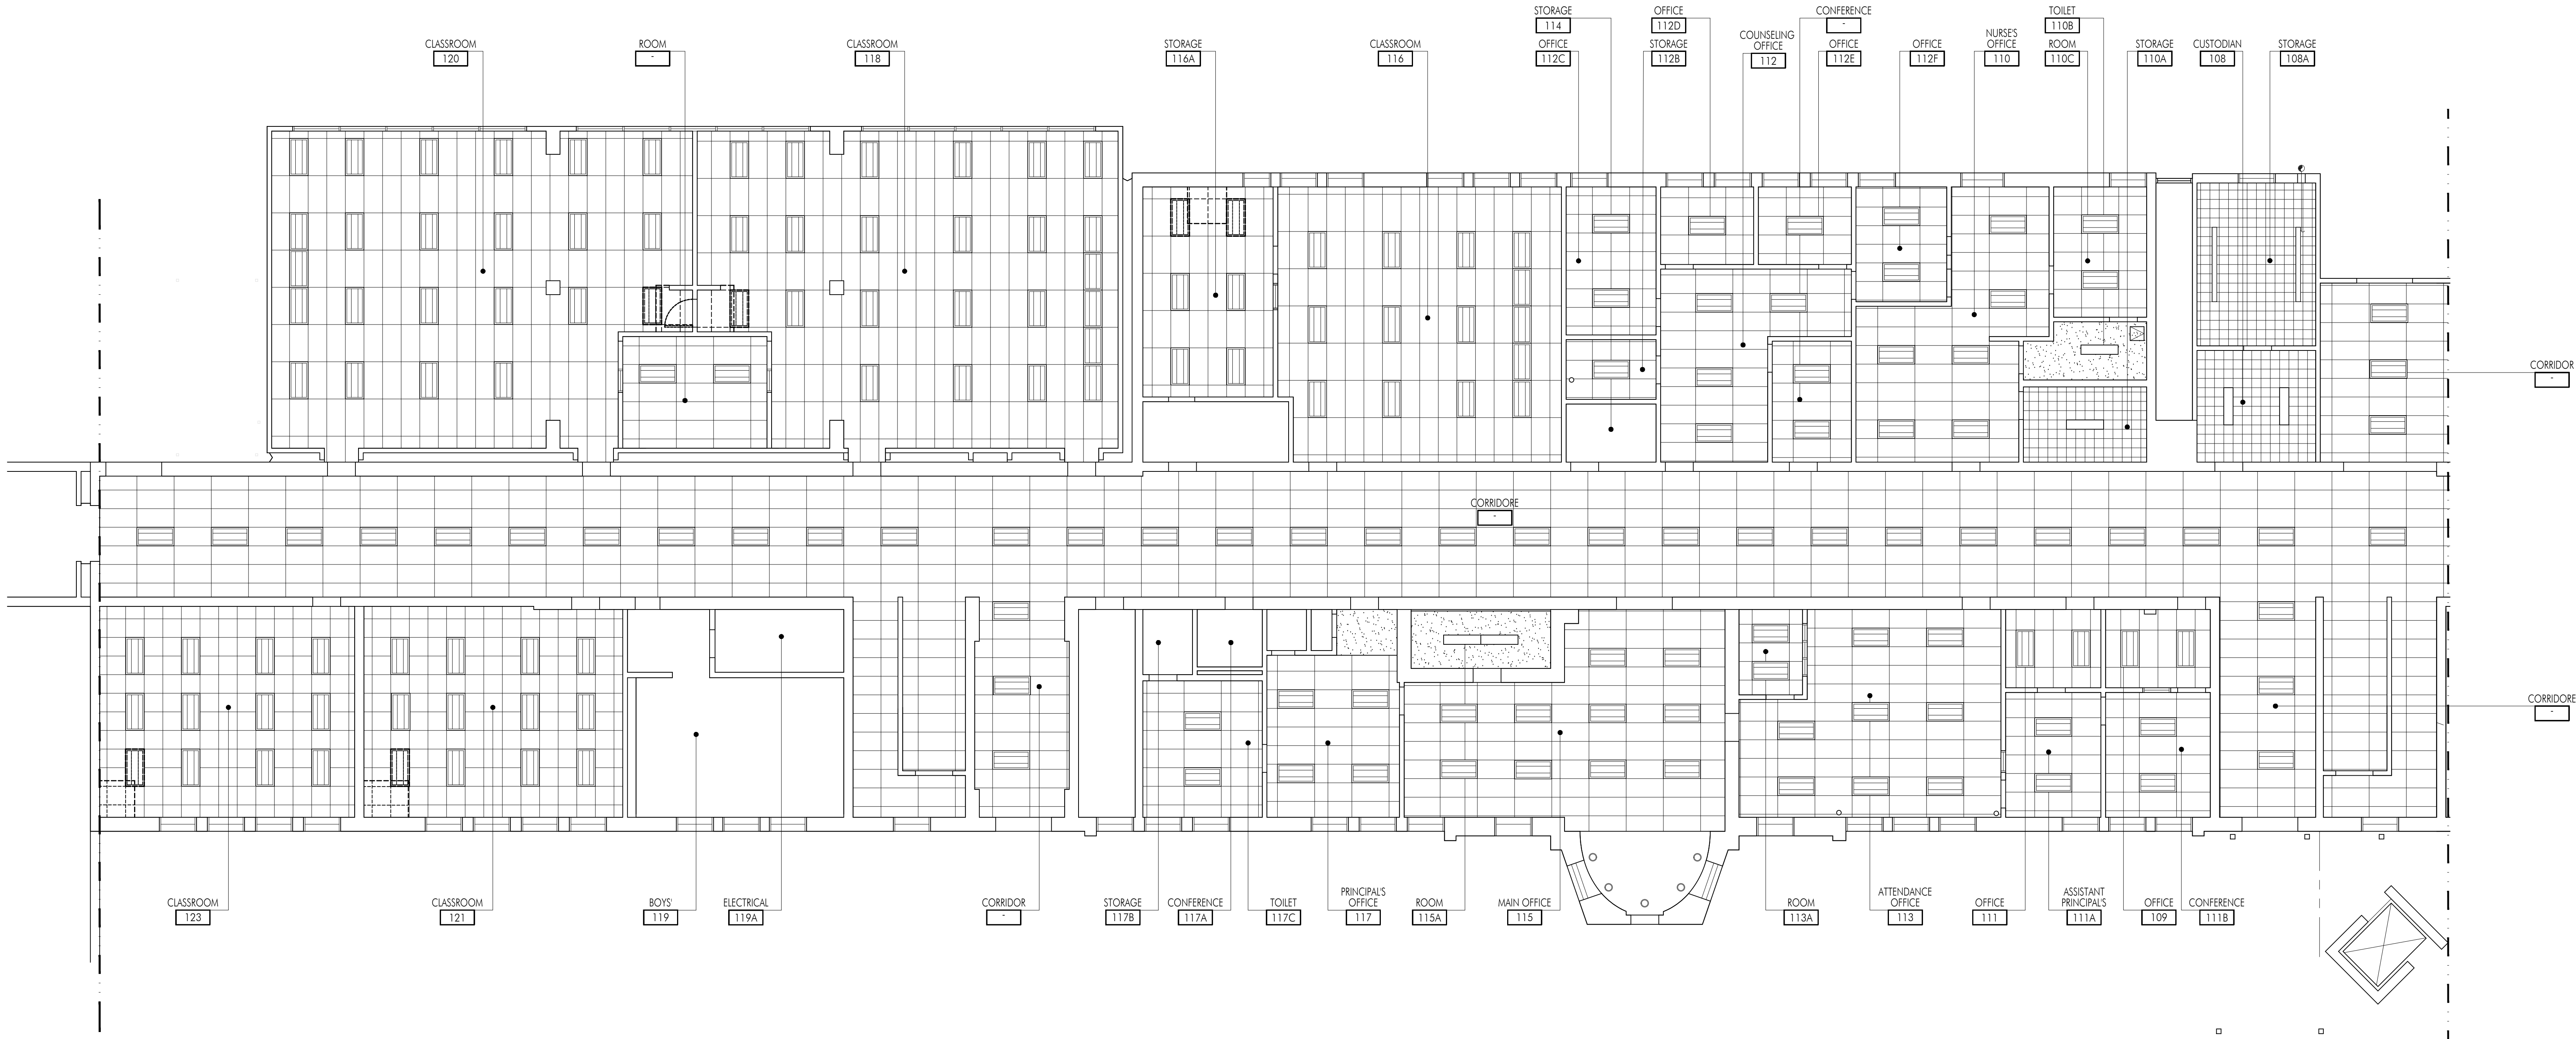
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Sheet Title

Building 'E' First
Floor Demolition
Reflected Ceiling
Plan

Sheet Number

AE203A



1 DEMOLITION REFLECTED CEILING PLAN

FLOOR PLAN GENERAL NOTES


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- REFER TO MECHANICAL, PLUMBING, ELECTRICAL AND FIRE ALARM DRAWINGS FOR ADDITIONAL SCOPE OF WORK IN EACH ROOM.
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- UNSCHEDULED CUTTING, REMOVING OR TRIMMING OF EXISTING CONCRETE, MASONRY OR WOOD FRAMED WALLS IS NOT PERMITTED. UNLESS NOTED OTHERWISE ALL DOORS SHALL BE FITTED WITHIN EXISTING WALL OPENINGS WITHOUT ENLARGING OR TRIMMING HEAD OR JAMBS.

DEMOLITION KEYNOTES

NO.	DESCRIPTION
151	REMOVE PORTION OF (E) CEILING AS REQUIRED FOR INSTALLATION OF NEW DUCTWORK, AND UTILITIES AS OCCURS ABOVE CEILING. REPLACE CEILING TILES, PATCH, REPAIR AND PAINT AT ALL REMOVALS TO MATCH EXISTING ADJACENT.
152	REMOVE PORTION OF (E) CEILING TILES AND SUSPENDED T-BAR SYSTEM IN PREPARATION OF NEW SOFFIT. PROTECT EXISTING ADJACENT CEILING AND MODIFY AS REQUIRED FOR TRANSITION TO NEW WORK AND FINISHES.
153	REMOVE PORTION OF (E) CEILING AS REQUIRED FOR INSTALLATION OF NEW MECHANICAL CLOSET, MECHANICAL EQUIPMENT AND ALL ASSOCIATED DUCTWORK AND APPURTENANCES. PATCH REPAIR AND PAINT AT ALL REMOVALS TO MATCH EXISTING ADJACENT FINISHES AND IN PREPARATION FOR NEW WORK.
154	EXISTING MECHANICAL DUCT TO REMAIN. PROTECT IN PLACE TO BE REUSED AND CONNECT TO NEW EQUIPMENT. SEE MECHANICAL FOR ADDITIONAL INFORMATION.
155	MECHANICAL DUCT PENETRATION AT EXISTING ROOF. SEE MECHANICAL AND DETAIL X/A831 FOR ADDITIONAL INFORMATION.
156	REMOVE PORTION OF (E) CEILING TILES AND SUSPENDED T-BAR SYSTEM IN PREPARATION OF NEW MECHANICAL UNIT, DUCT OR REGISTER. PROTECT EXISTING ADJACENT CEILING AND MODIFY AS REQUIRED FOR TRANSITION TO NEW WORK AND FINISHES. SEE MECHANICAL FOR ADDITIONAL INFORMATION.
157	REMOVE PORTION OF (E) GYPSUM BOARD OR PLASTER CEILING IN PREPARATION OF NEW MECHANICAL EQUIPMENT. PROTECT EXISTING ADJACENT CEILING AND MODIFY AS REQUIRED FOR TRANSITION TO NEW WORK AND FINISHES. SEE MECHANICAL FOR ADDITIONAL INFORMATION.

DEMOLITION FLOOR PLAN LEGEND



SYMBOL	DESCRIPTION
	(E) STUD WALL OR PARTITION TO REMAIN.
	(E) STUD WALL OR PARTITION TO BE REMOVED.
	EXISTING SUSPENDED T-BAR CEILING SYSTEM TO REMAIN, UNLESS NOTED OTHERWISE.
	EXISTING GLUE ON ACOUSTIC TILE TO REMAIN, UNLESS NOTED OTHERWISE.
	REMOVE EXISTING LIGHT AND APPURTENANCES. SEE ELECTRICAL FOR MORE INFORMATION.
	EXISTING LIGHT FIXTURE TO REMAIN. SEE ELECTRICAL FOR MORE INFORMATION.

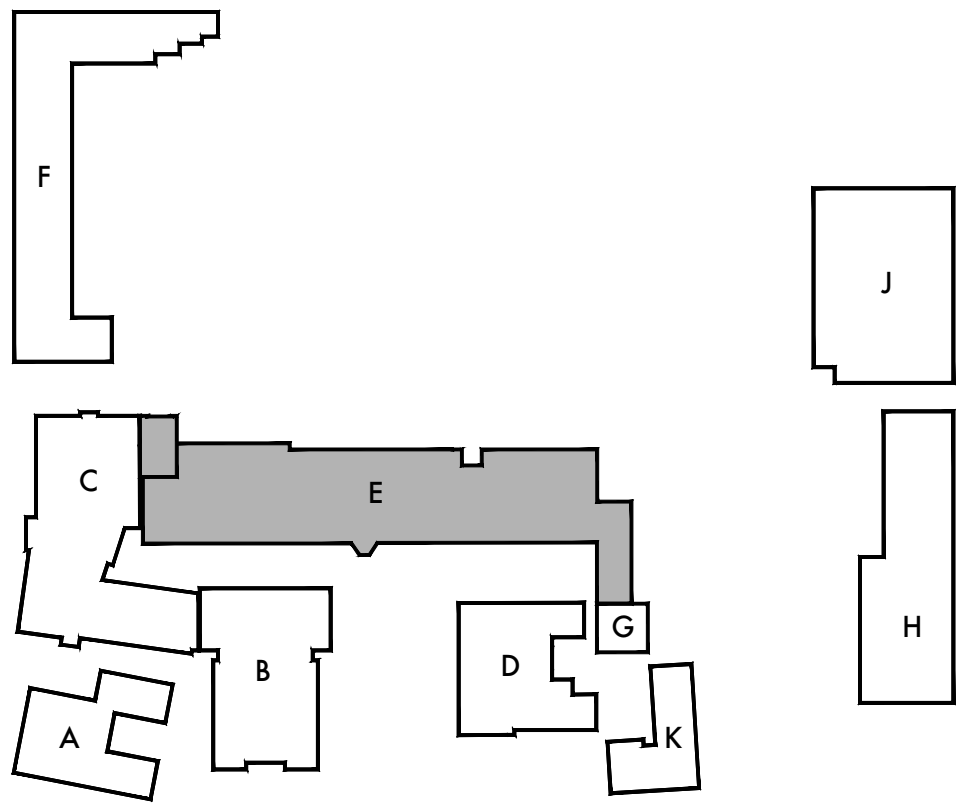

KEY PLAN

Plot Date: 11/27/2019 12:15:54 PM Last Save By: dhamilton Login: Rudy Monica G:\Project\School District\Santa Monica MLSD\SMMLUSD - LMS HVAC\SMMLUSD LMS Drawings\01 Architectural\SMMLUSD-LMS-AE203B.dwg

1 DEMOLITION REFLECTED CILING PLAN

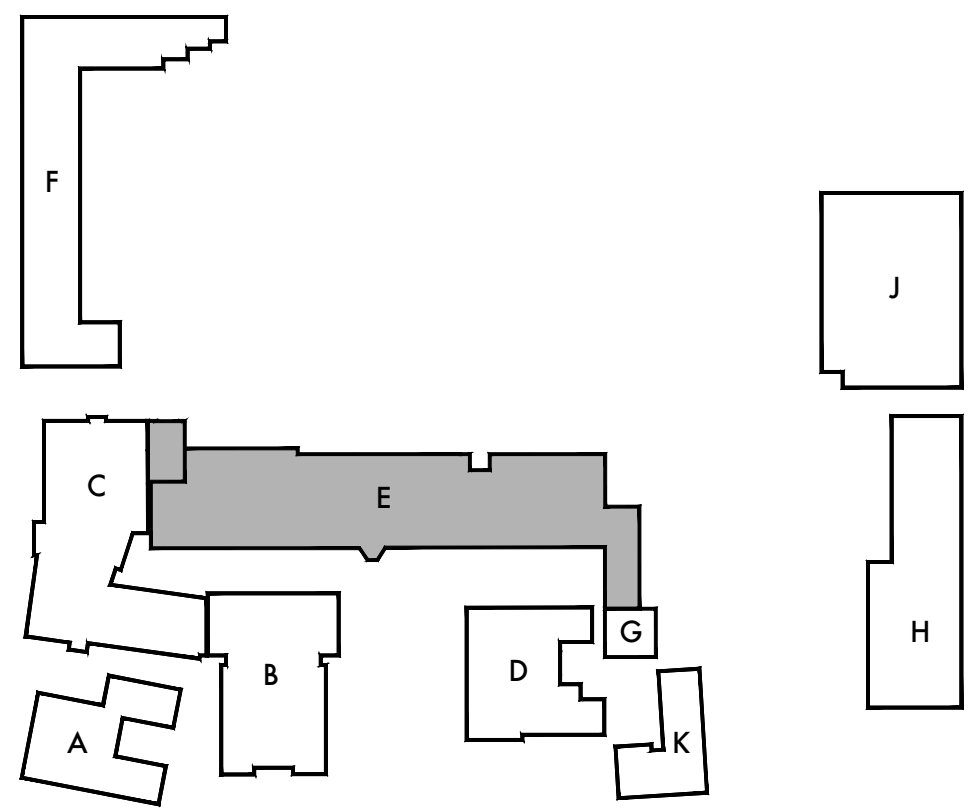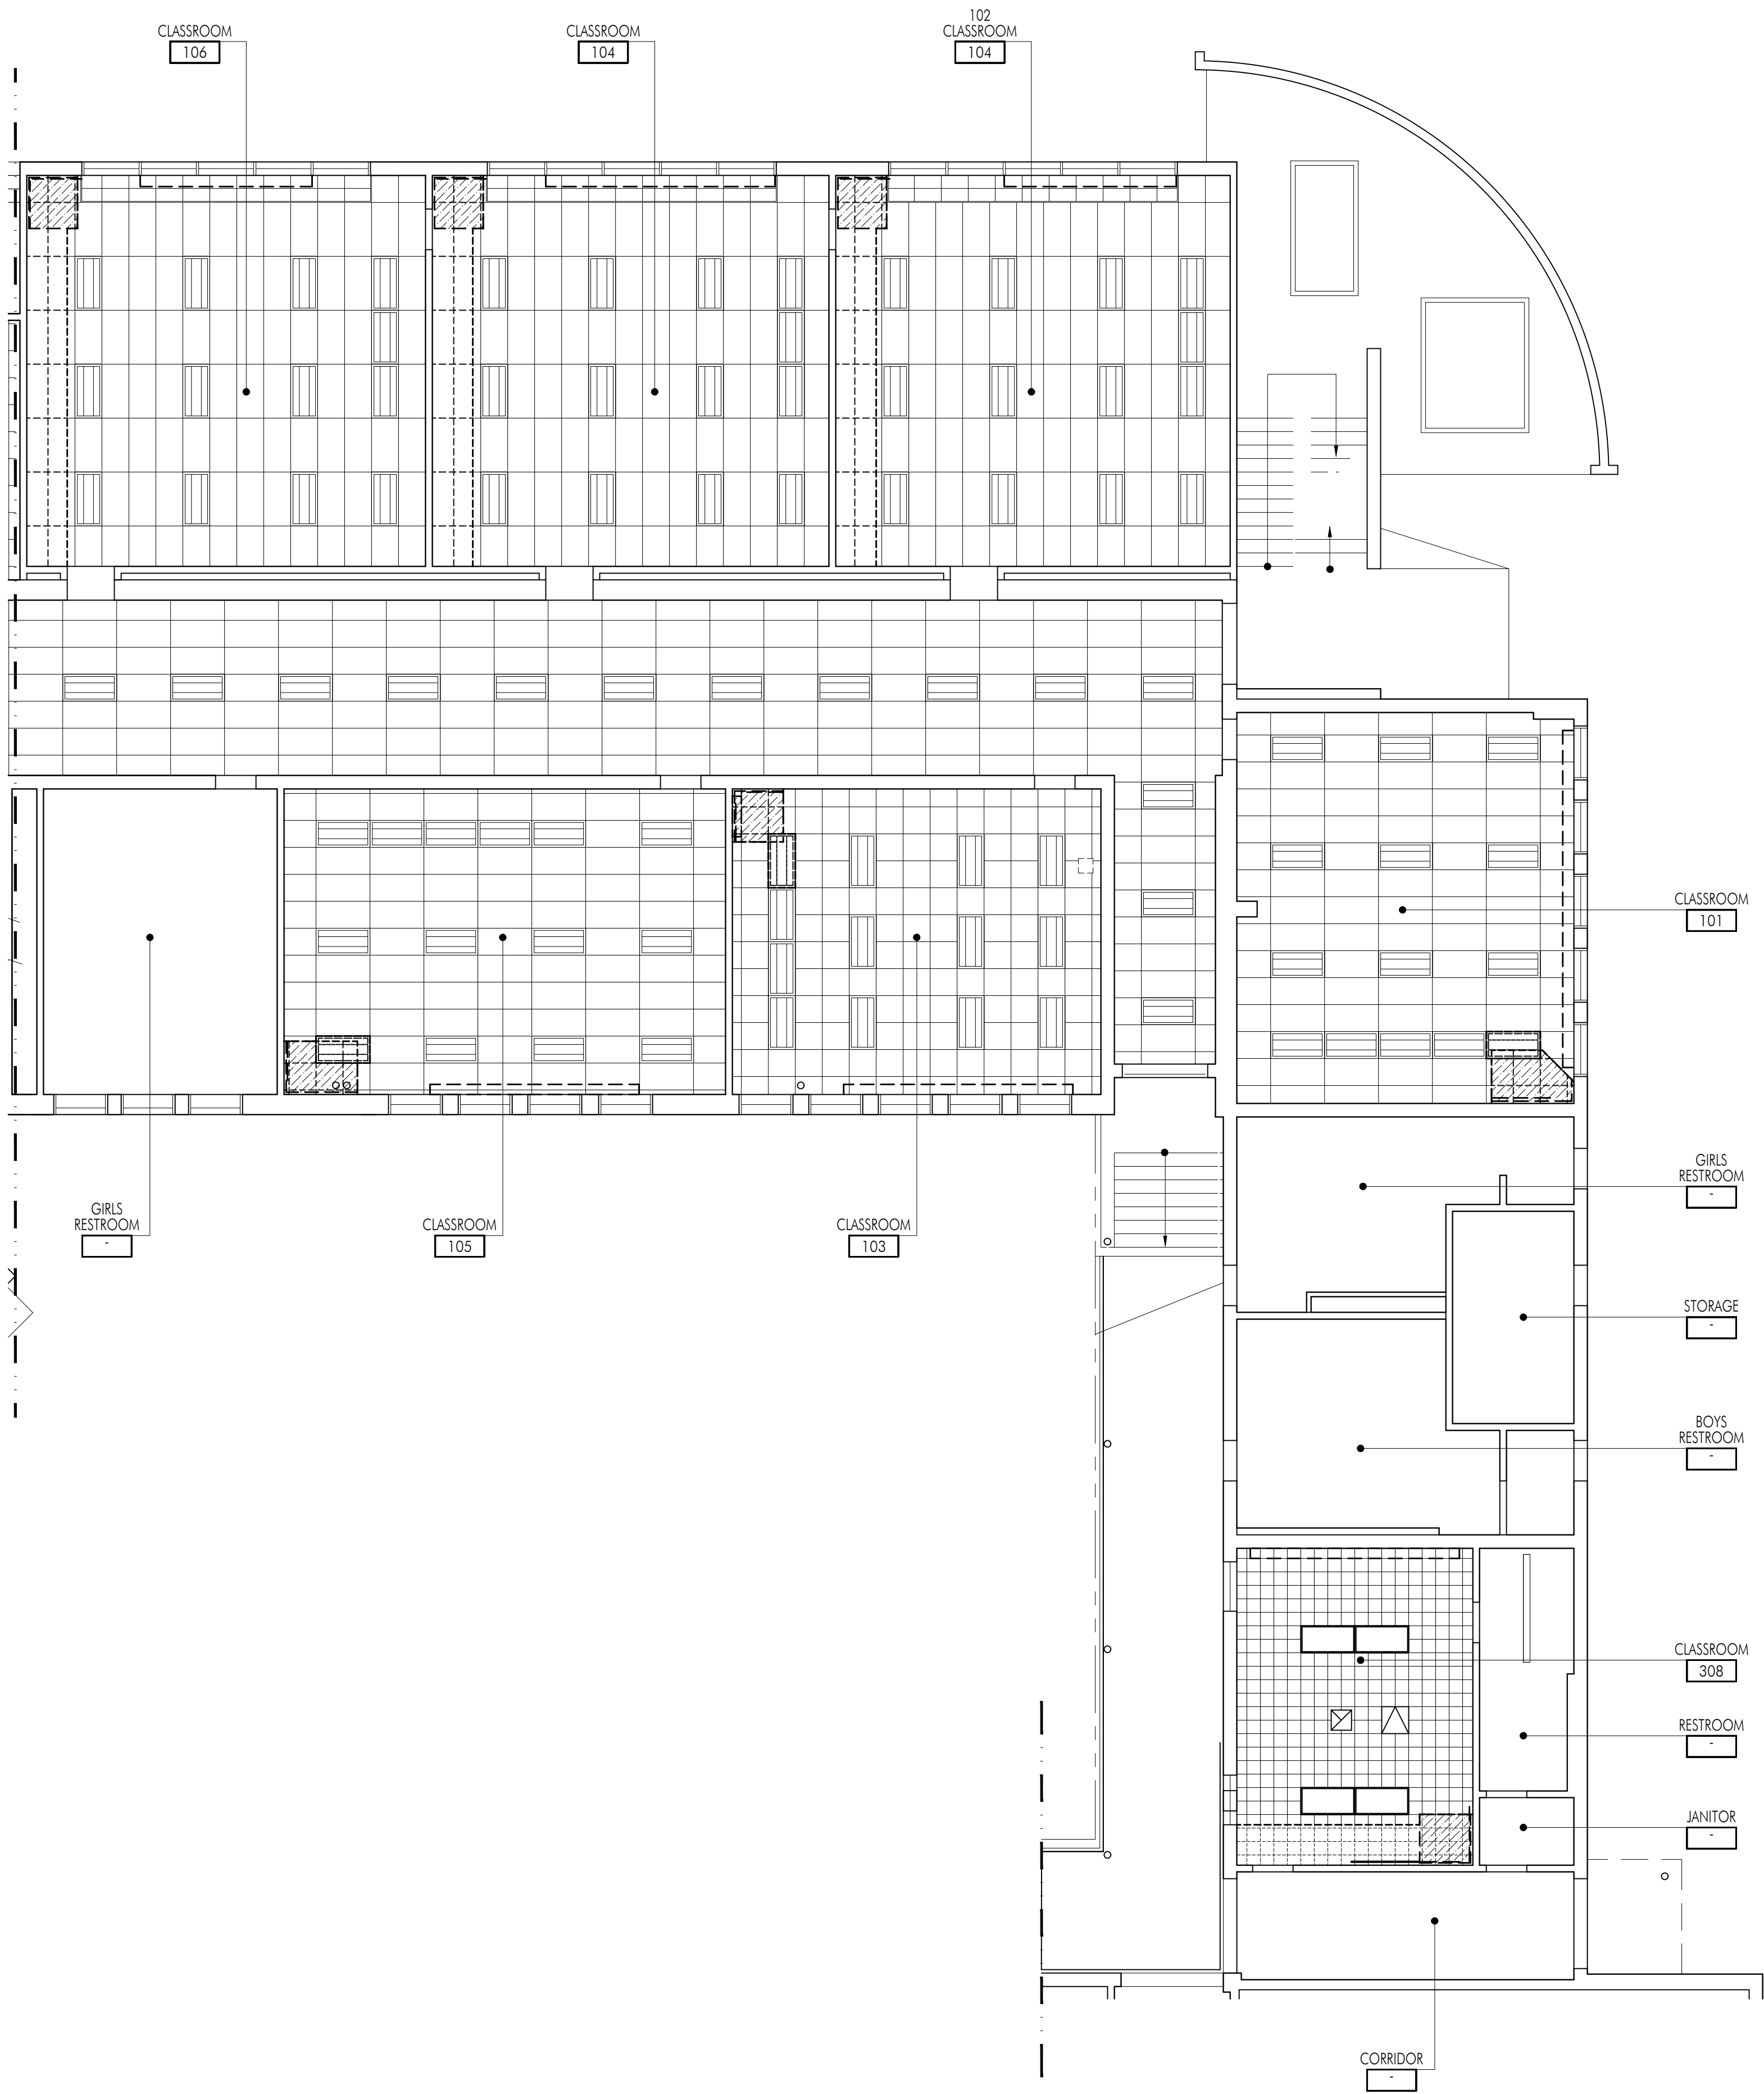

KEY PLAN



SCALE: 1/8"=1'-0"

DSA Stamp

Architect




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Sheet Title

Building 'E' First
Floor Demolition
Reflected Ceiling
Plan

Sheet Number

AE203B

DSA Stamp

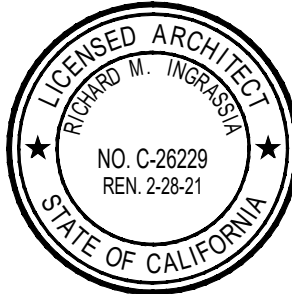Architect



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Lincoln Middle School
1501 California Avenue
Santa Monica, California 90403


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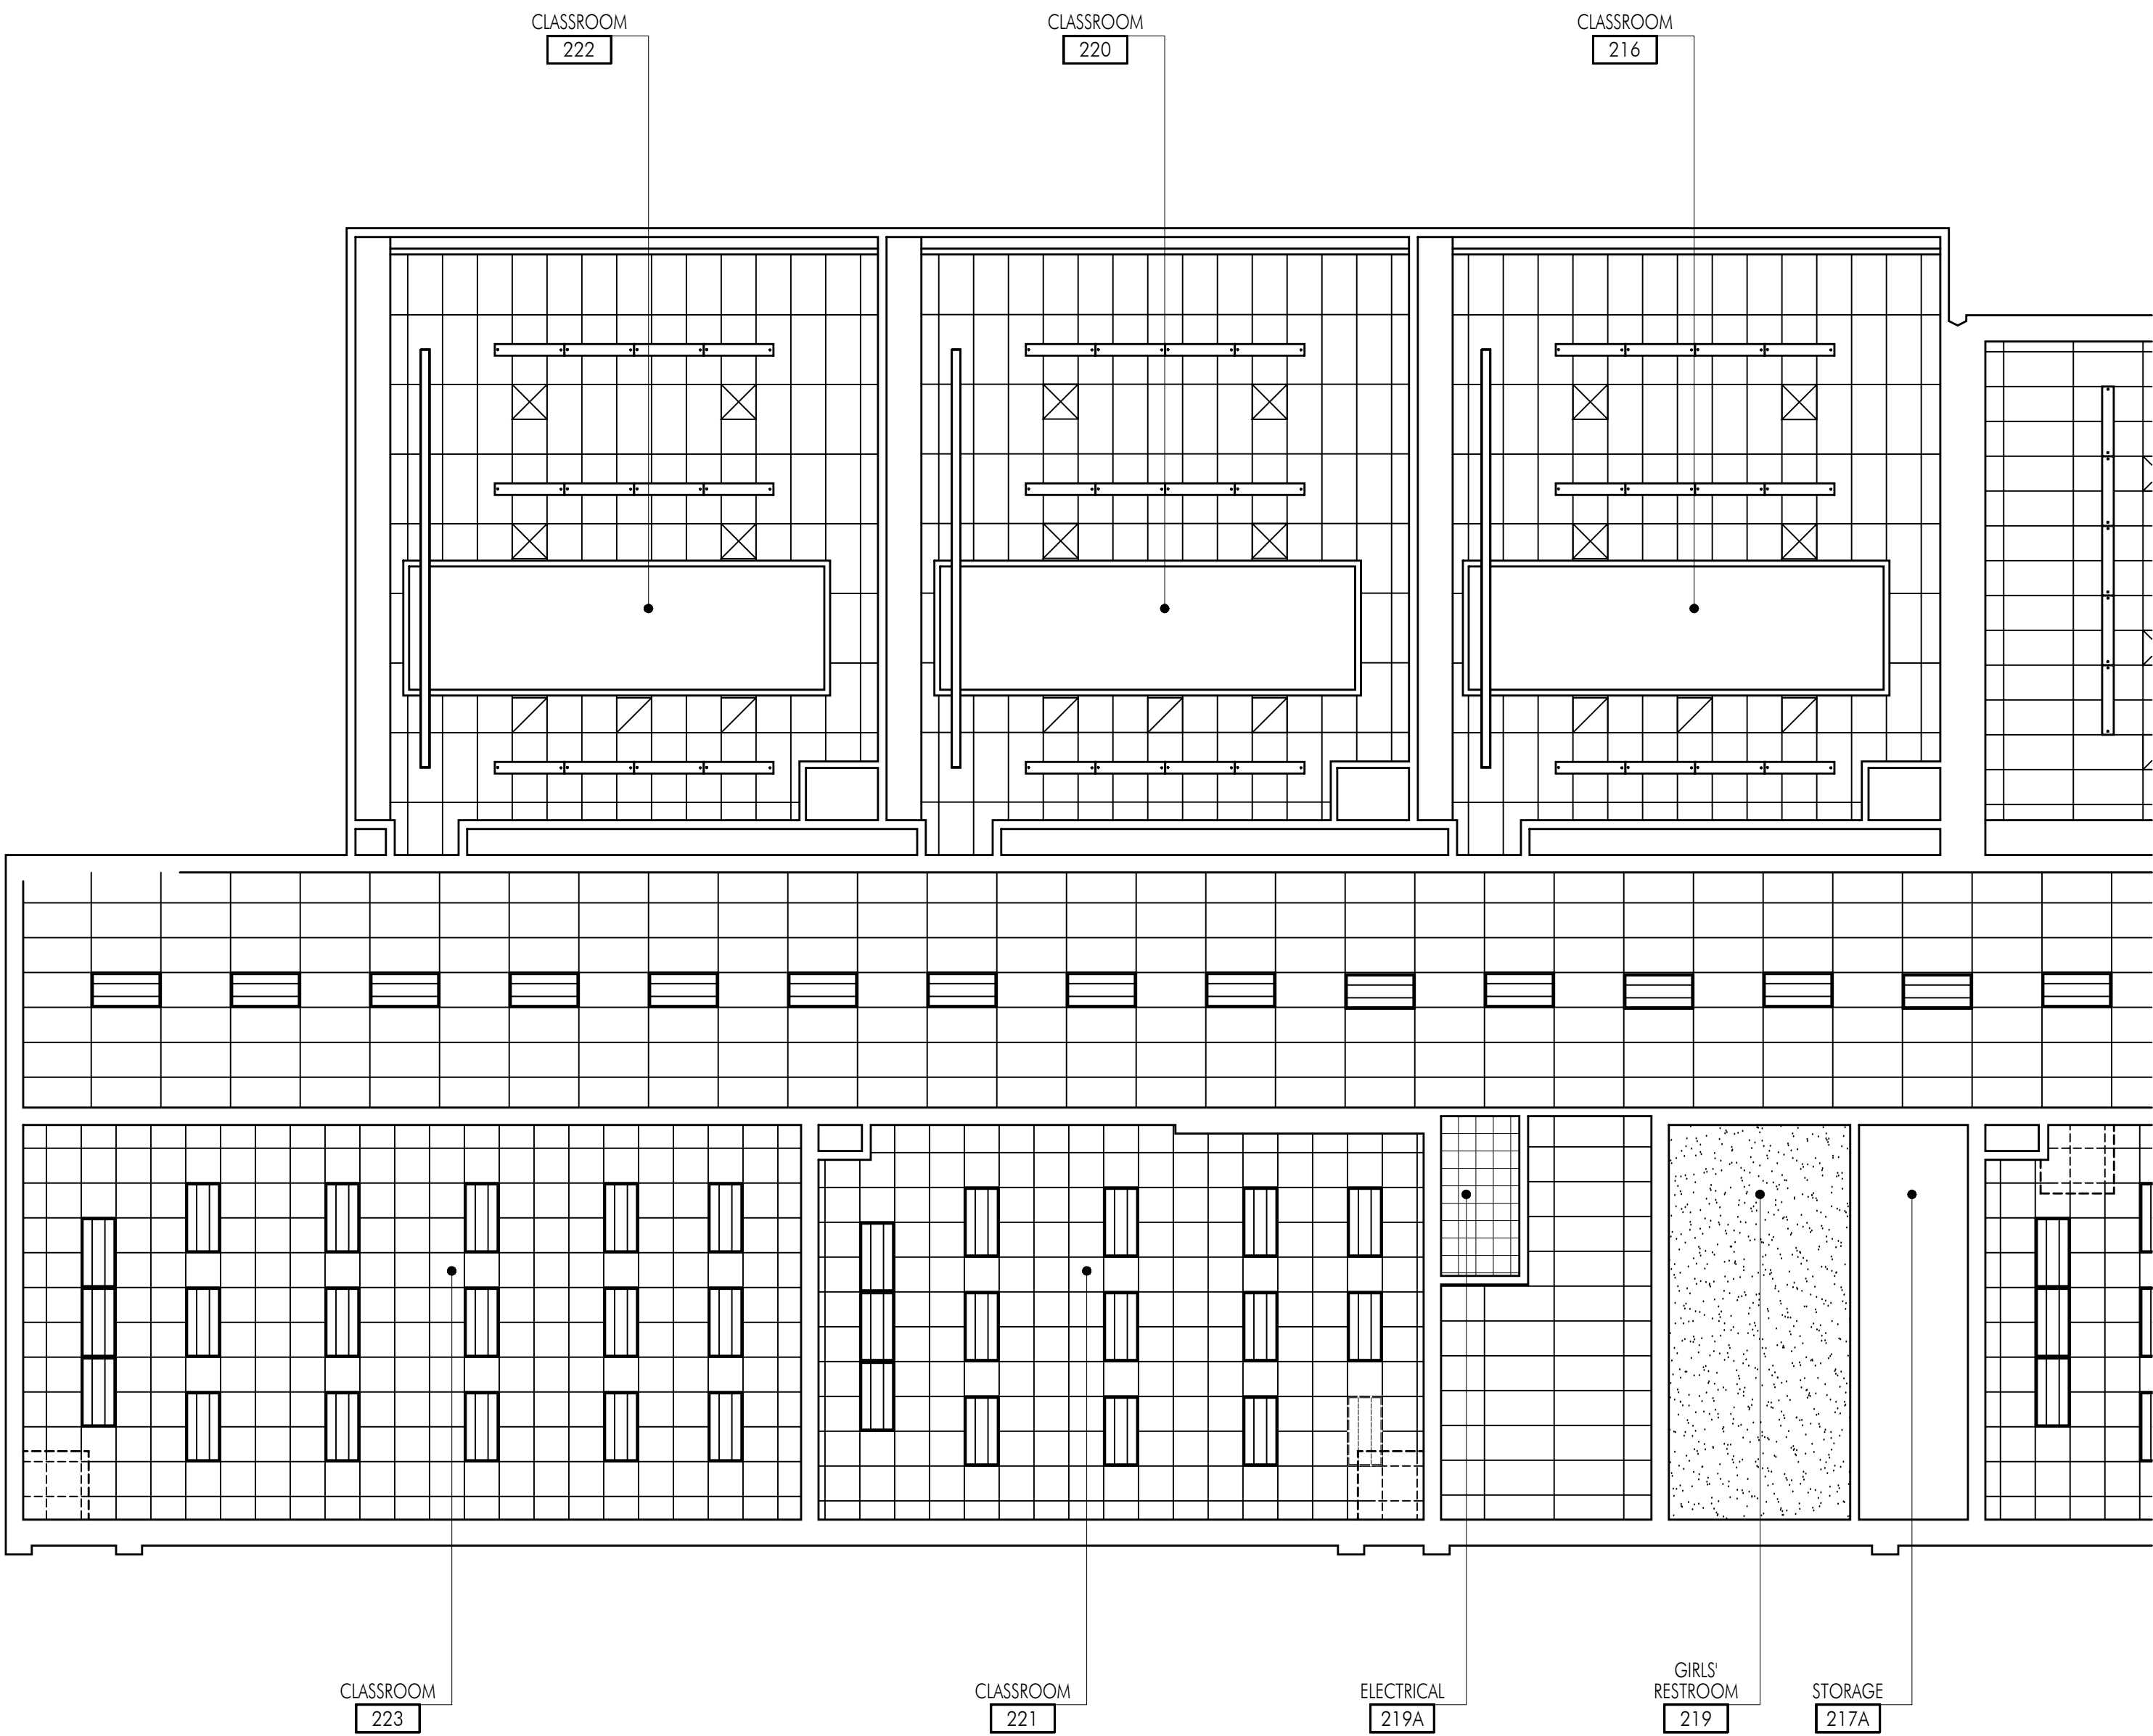


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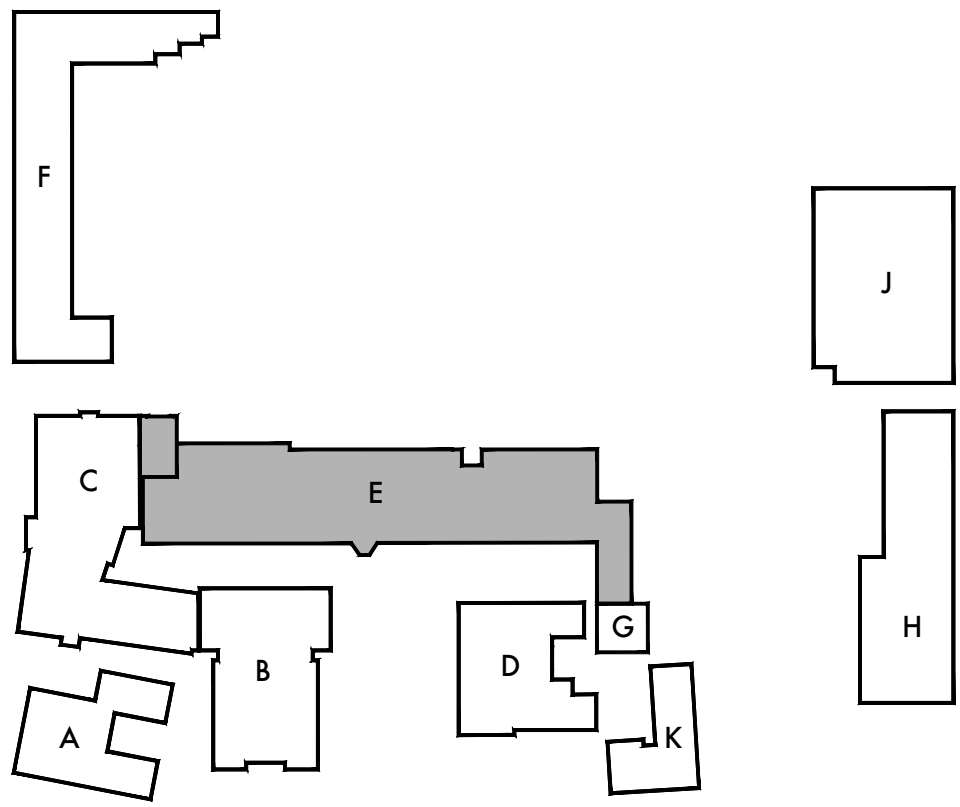
Sheet Title
Building 'E' Second
Floor Demolition
Reflected Ceiling
Plan

Sheet Number

AE204A

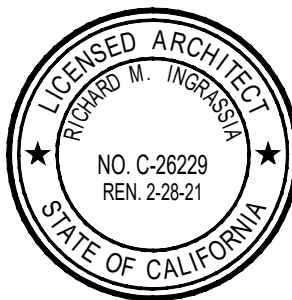

1 DEMOLITION REFLECTED CEILING PLAN



KEY PLAN

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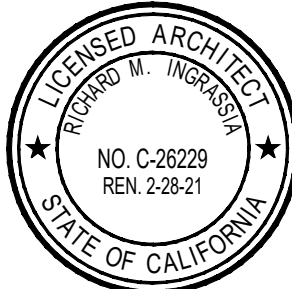
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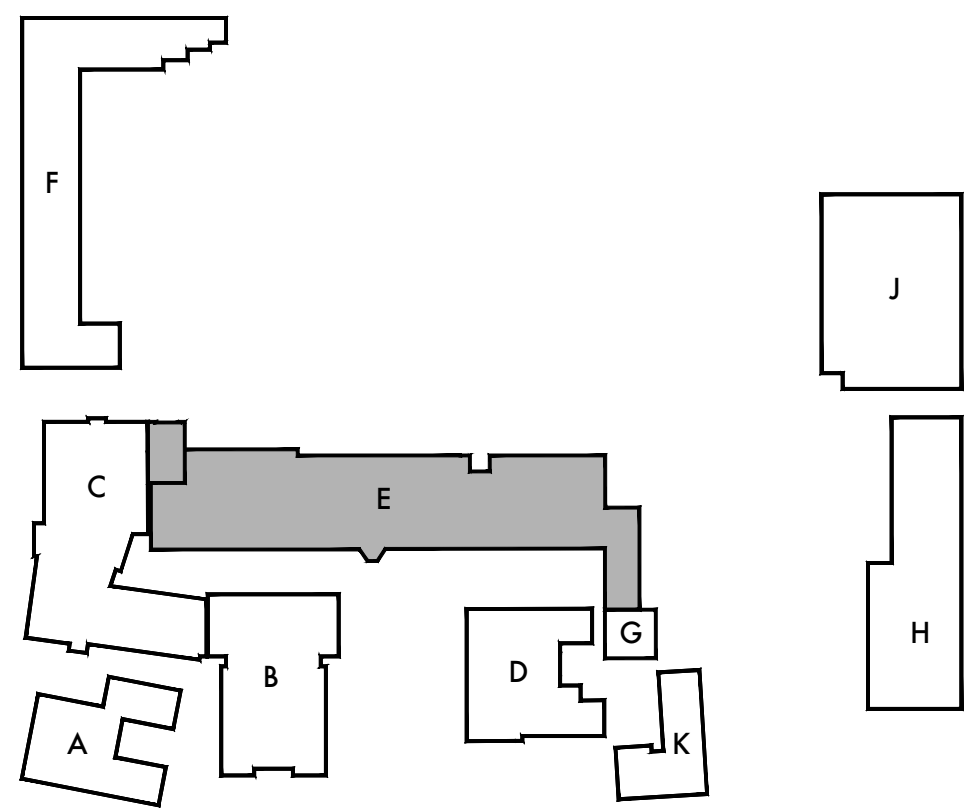
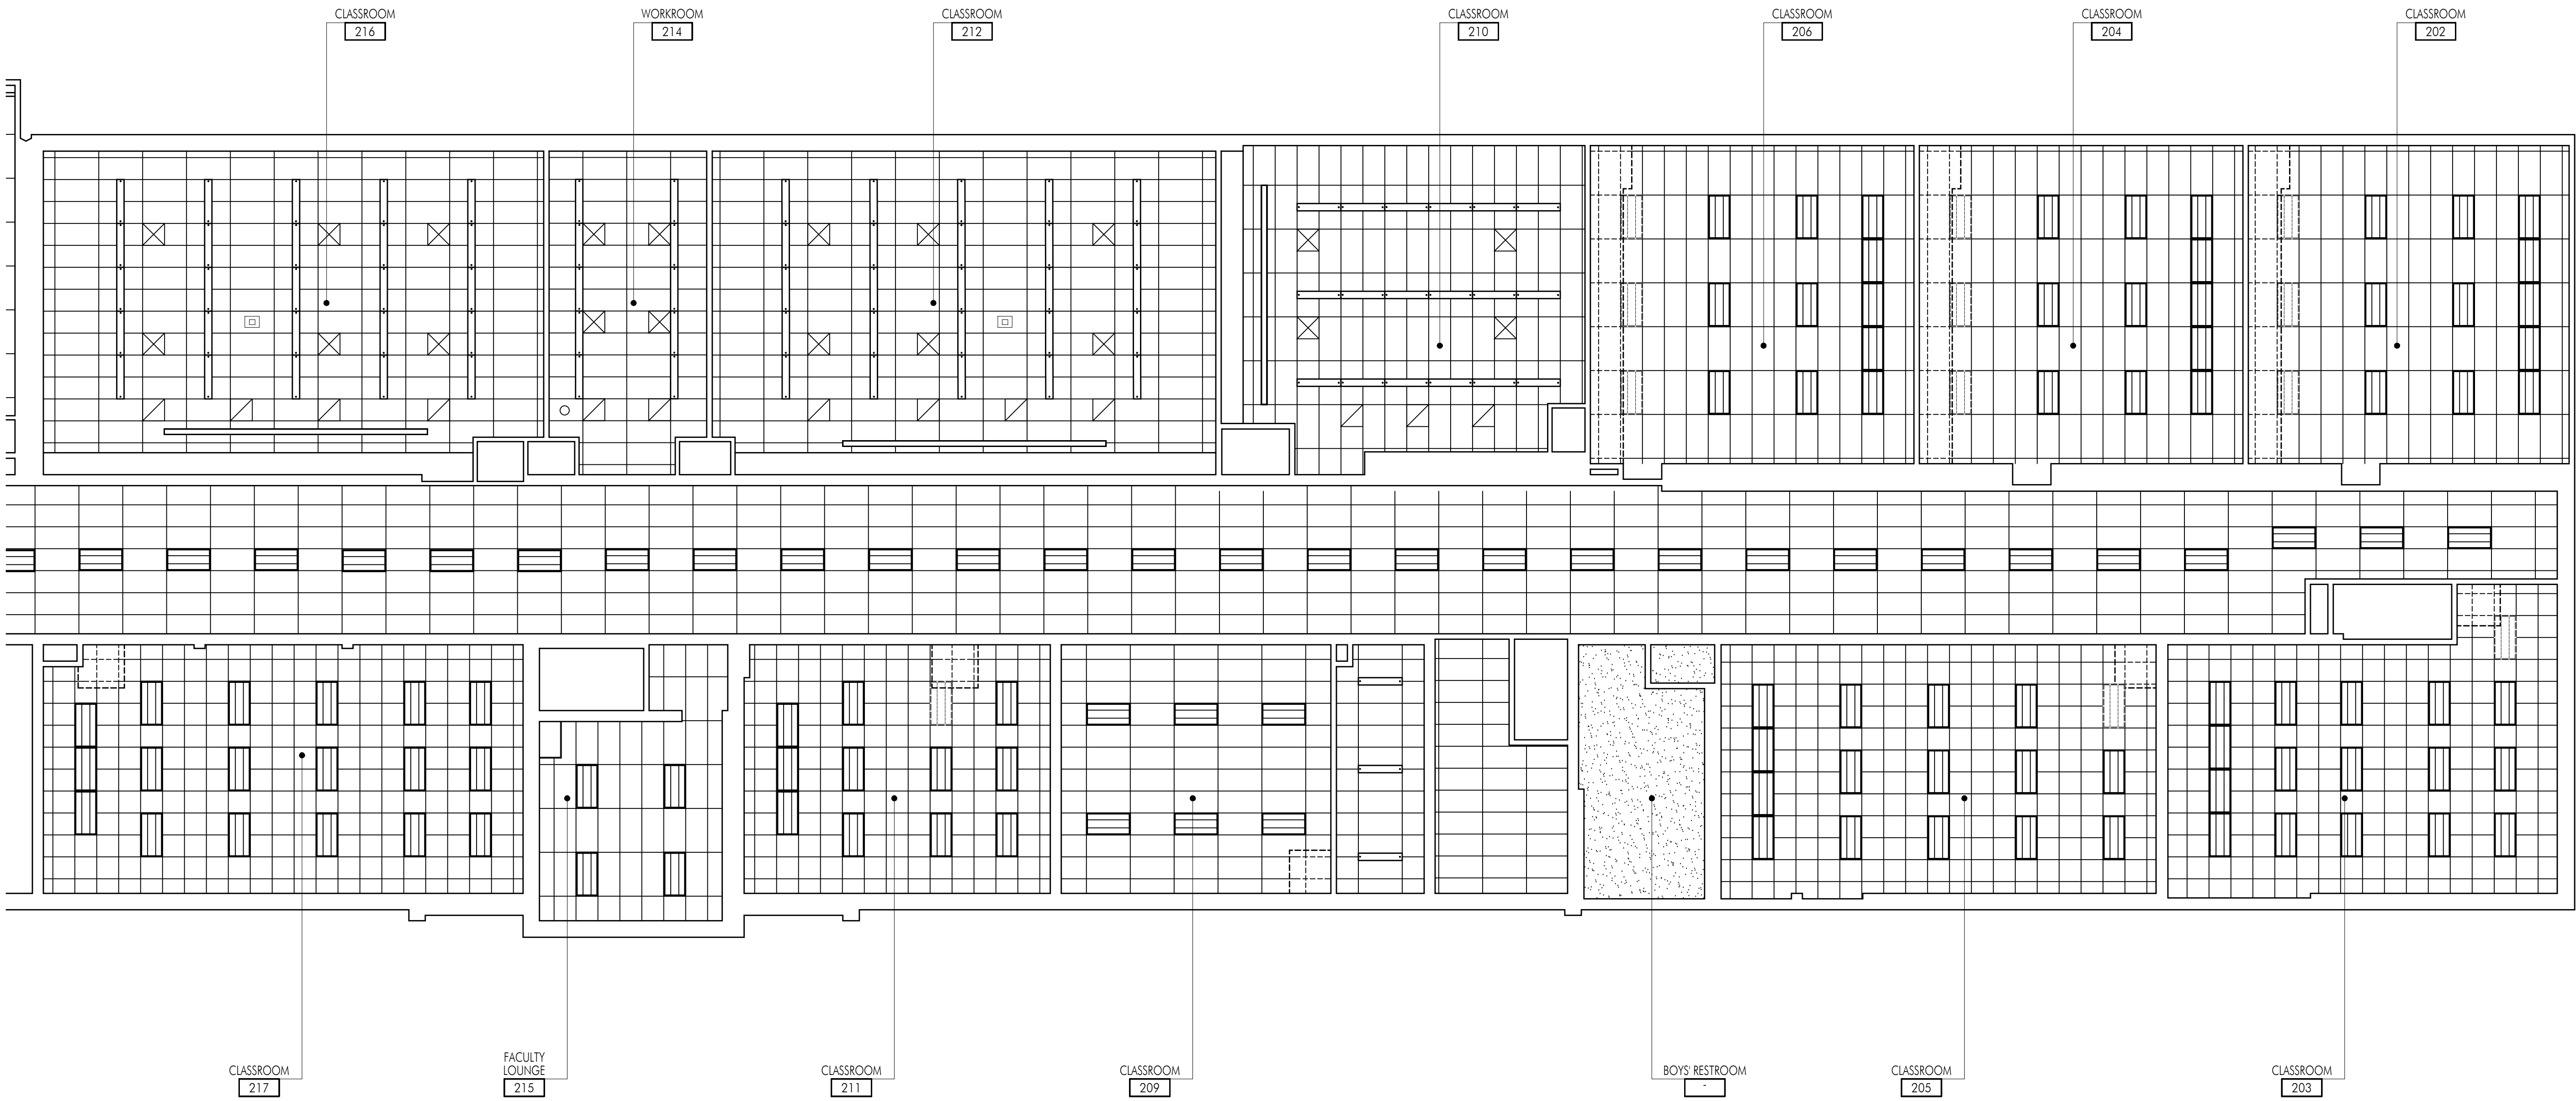


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Sheet Title
Building 'E' Second
Floor Demolition
Reflected Ceiling
Plan

Sheet Number

AE204B



KEY PLAN

1 DEMOLITION REFLECTED CEILING PLAN

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Sheet Title
Building 'E' First
Floor Plan

Sheet Number

AE211A

1 FLOOR PLAN

FLOOR PLAN GENERAL NOTES


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KEYNOTES

NO.	DESCRIPTION
201	MECHANICAL CLOSET SEE WALL TYPE AS REFERENCED AND PLAN FOR DIMENSIONS. SEE MECHANICAL DRAWINGS FOR MORE INFORMATION
221	MECHANICAL EQUIPMENT. SEE MECHANICAL AND ELECTRICAL FOR ADDITIONAL INFORMATION
222	MECHANICAL REGISTER AT +10'-4" ABOVE FINISH FLOOR. SEE MECHANICAL AND ELECTRICAL FOR ADDITIONAL INFORMATION. (REVIEW LOCATION IN THE FIELD WITH ARCHITECT PRIOR TO COMPLETING WORK)

FLOOR PLAN LEGEND

SYMBOL	DESCRIPTION
	(E) WOOD STUD WALL OR PARTITION TO REMAIN.
	METAL STUD WALL ASSEMBLY. REFER TO WALL TYPE AND TYPICAL DETAILS ON A711 FOR MORE INFORMATION
	NEW DOOR AND FRAME. SEE DOOR SCHEDULE ON A611 FOR MORE INFORMATION
	WALL TYPE. SEE A711 FOR MORE INFORMATION.

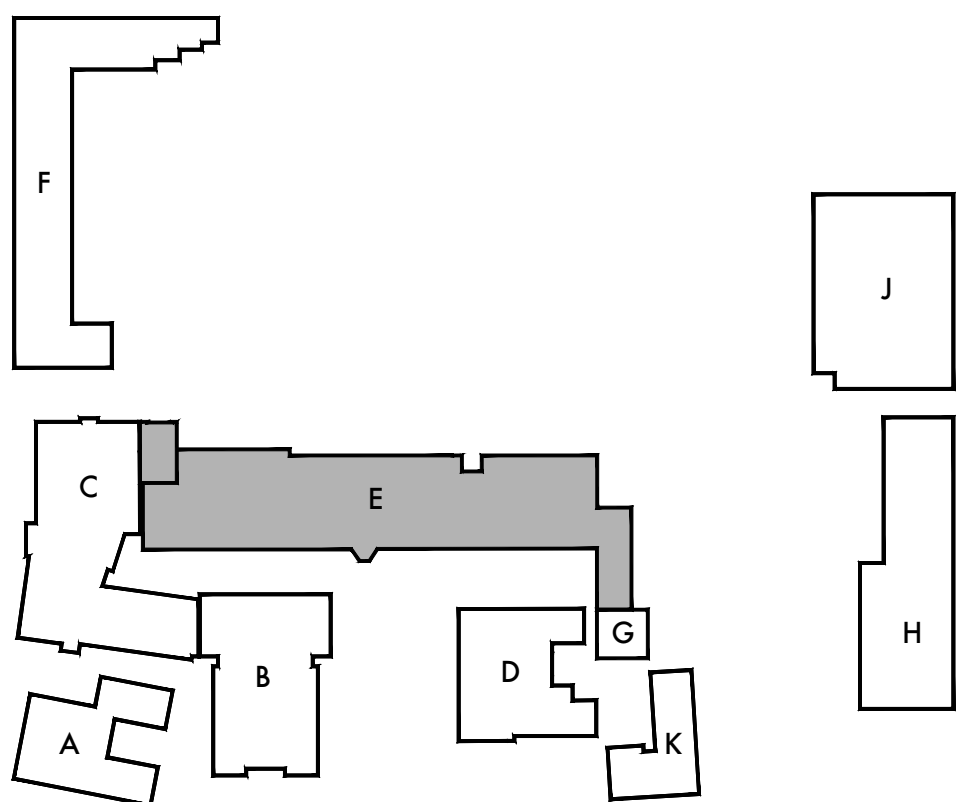

KEY PLAN

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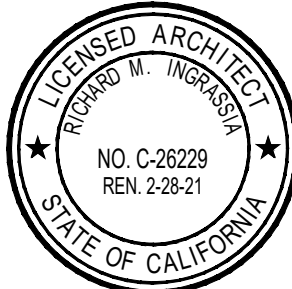
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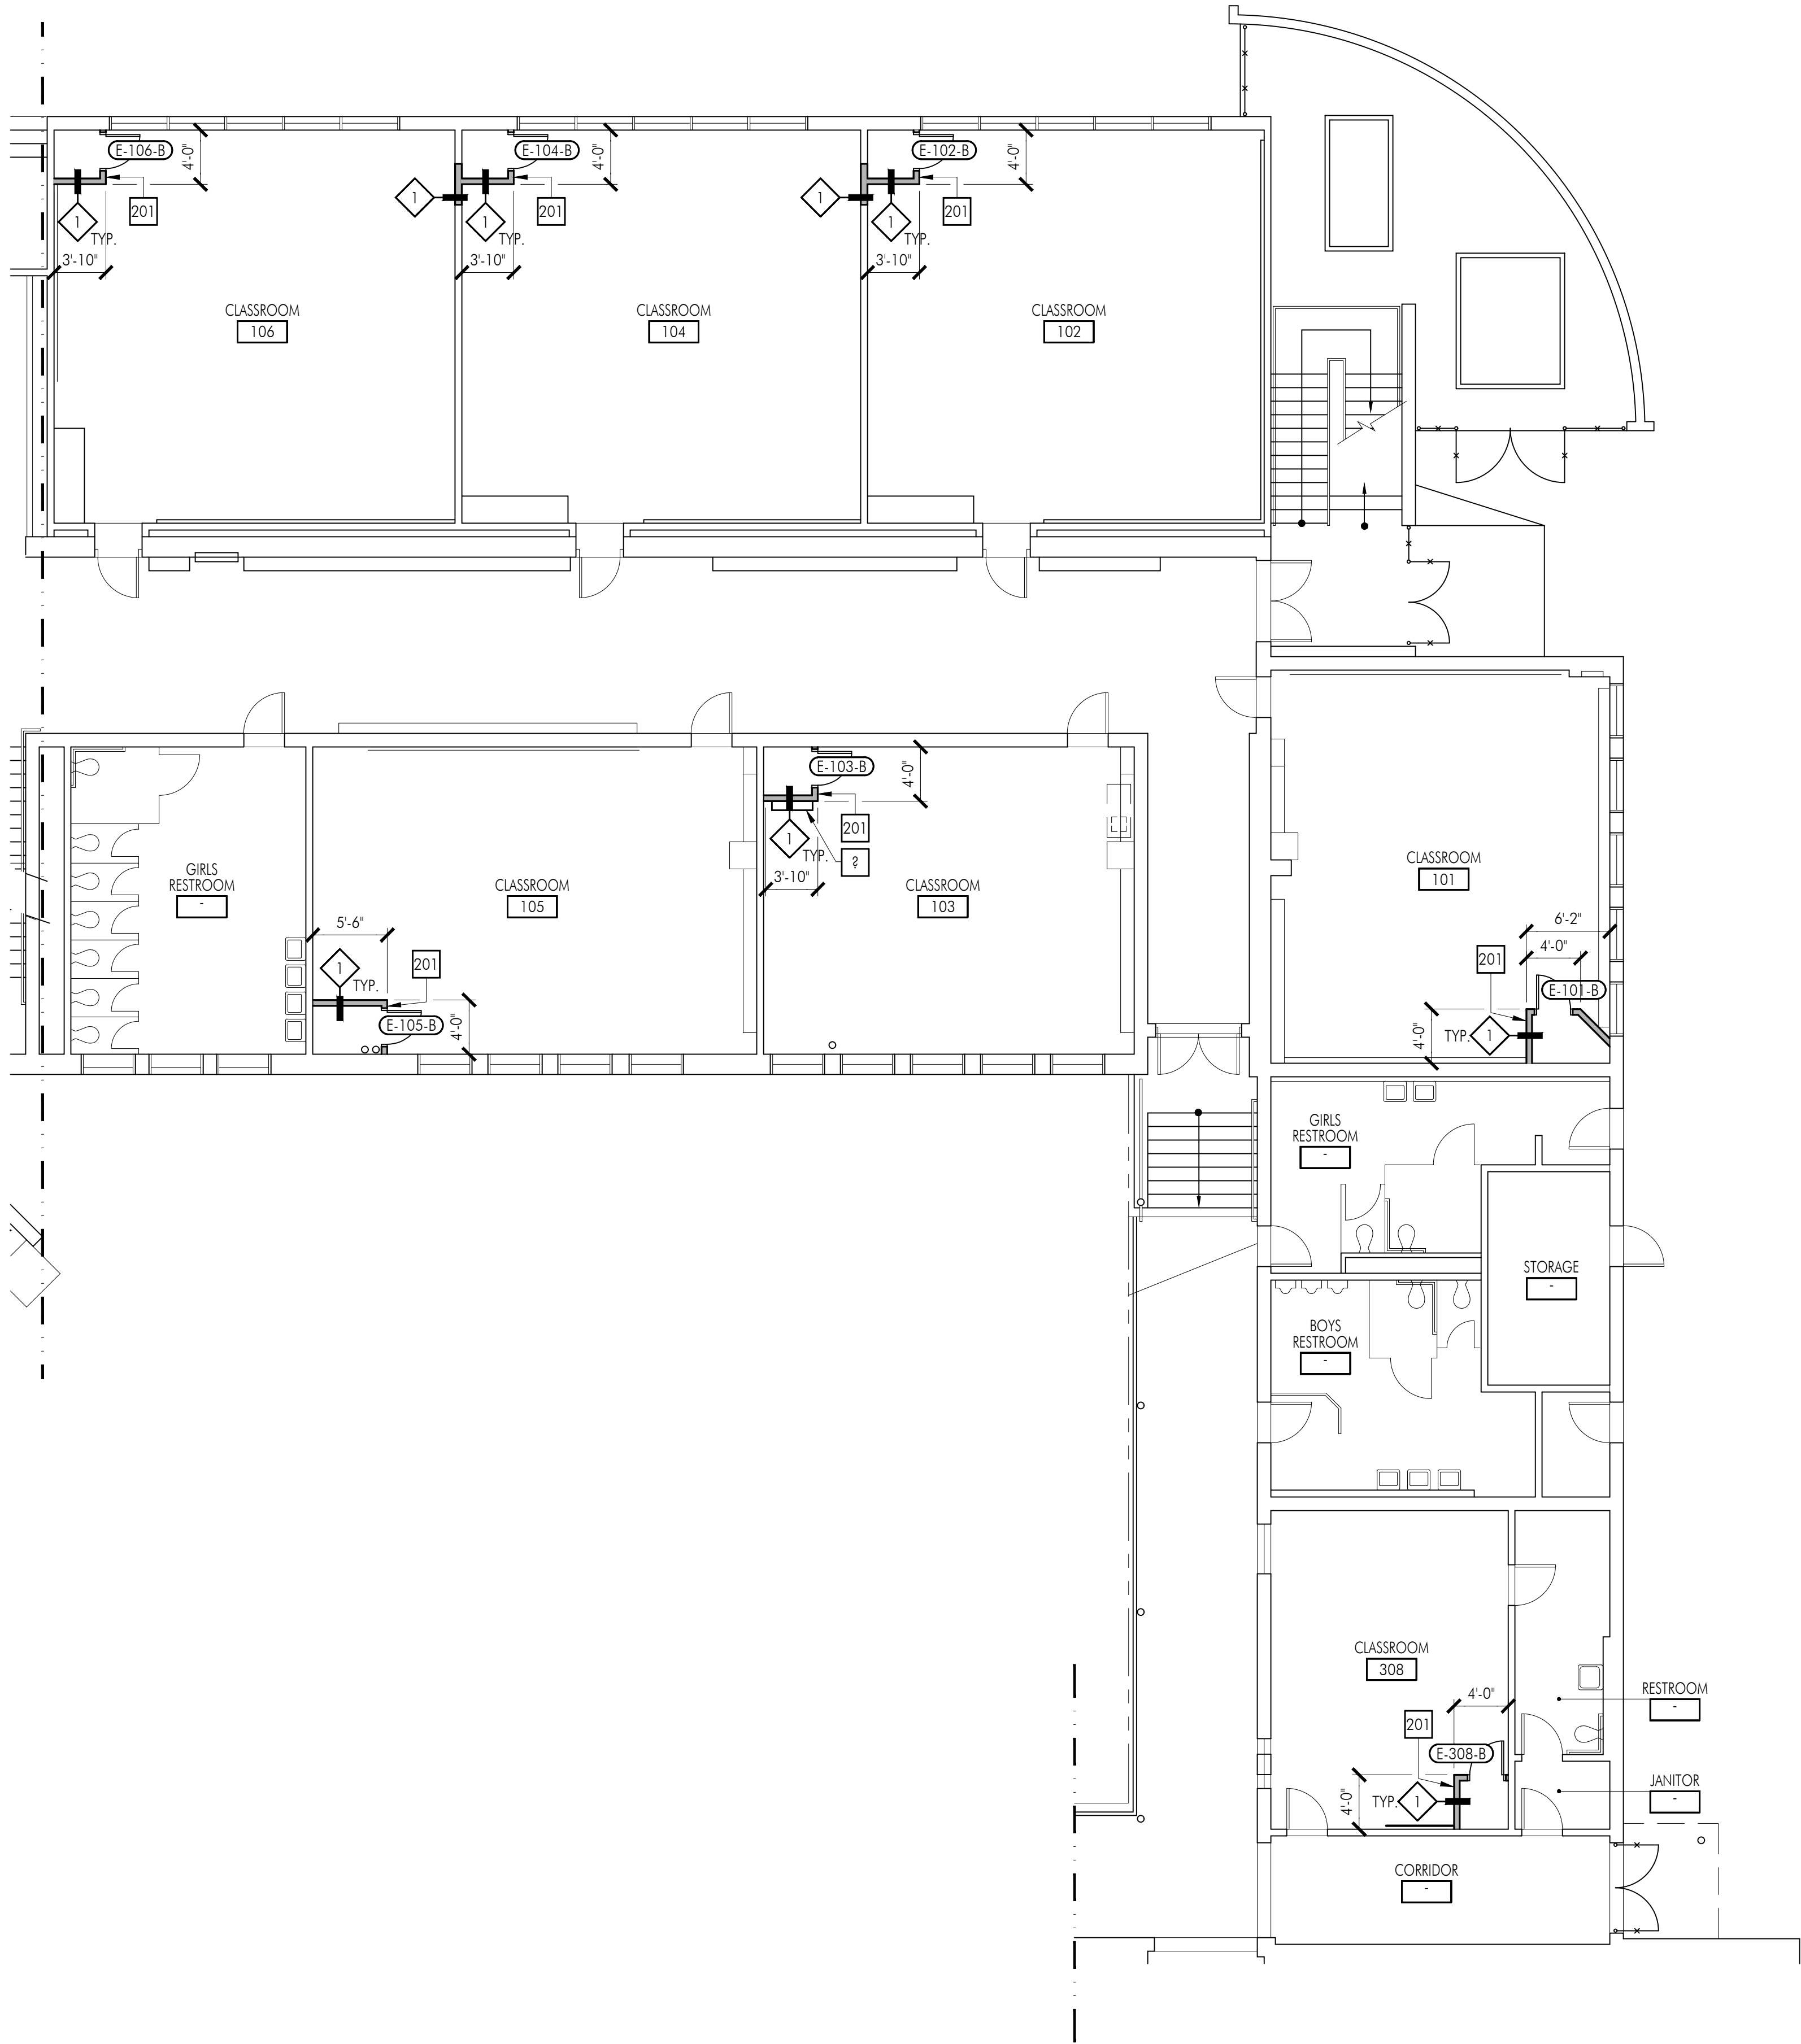
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Sheet Title

Building 'E' First
Floor Plan

Sheet Number

AE211B



1 FLOOR PLAN

FLOOR PLAN GENERAL NOTES


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FLOOR PLAN LEGEND

SYMBOL	DESCRIPTION
(E)	WOOD STUD WALL OR PARTITION TO REMAIN.
[Hatched Box]	METAL STUD WALL ASSEMBLY. REFER TO WALL TYPE AND TYPICAL DETAILS ON A711 FOR MORE INFORMATION
[Door Symbol]	NEW DOOR AND FRAME. SEE DOOR SCHEDULE ON A611 FOR MORE INFORMATION
[Diamond Symbol]	WALL TYPE. SEE A711 FOR MORE INFORMATION.



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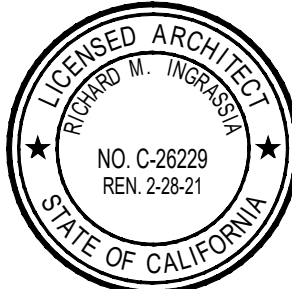
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Sheet Title
Building 'E' Second
Floor Plan

Sheet Number

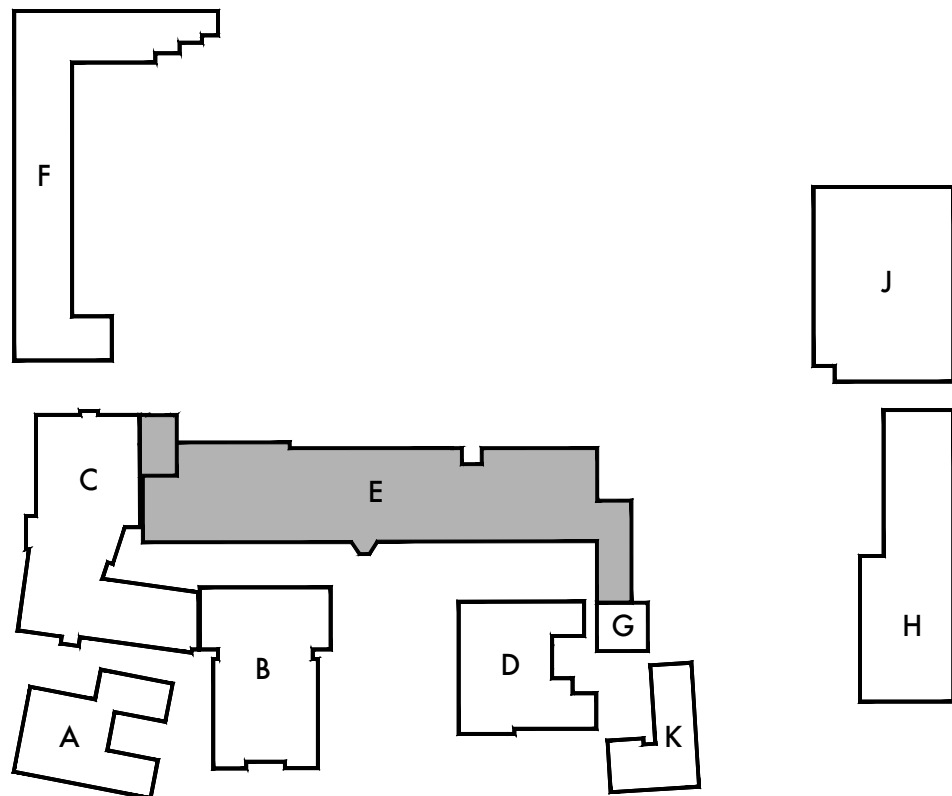AE212A

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1 FLOOR PLAN

FLOOR PLAN GENERAL NOTES


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KEYNOTES

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221	MECHANICAL EQUIPMENT. SEE MECHANICAL AND ELECTRICAL FOR ADDITIONAL INFORMATION
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FLOOR PLAN LEGEND

SYMBOL	DESCRIPTION
(E)	WOOD STUD WALL OR PARTITION TO REMAIN.
[Hatched Box]	METAL STUD WALL ASSEMBLY. REFER TO WALL TYPE AND TYPICAL DETAILS ON A711 FOR MORE INFORMATION
[Door Symbol]	NEW DOOR AND FRAME. SEE DOOR SCHEDULE ON A611 FOR MORE INFORMATION
[Diamond]	WALL TYPE. SEE A711 FOR MORE INFORMATION.



KEY PLAN

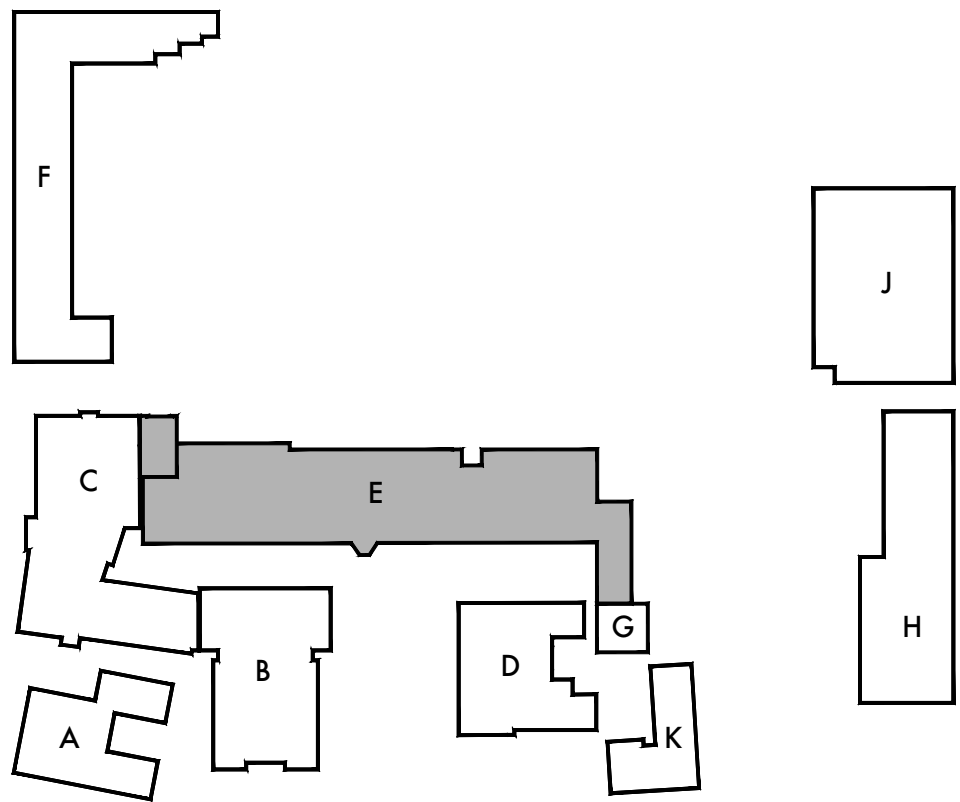DSA Stamp

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Lincoln Middle School
1501 California Avenue
Santa Monica, California 90403


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Consultants

Sheet Title
Building 'E' Second
Floor Plan

Sheet Number

AE212B

1 FLOOR PLAN

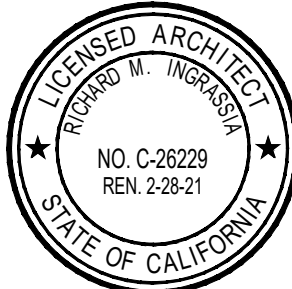FLOOR PLAN GENERAL NOTES


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KEYNOTES

NO.	DESCRIPTION
201	MECHANICAL CLOSET SEE WALL TYPE AS REFERENCED AND PLAN FOR DIMENSIONS. SEE MECHANICAL DRAWINGS FOR MORE INFORMATION
221	MECHANICAL EQUIPMENT. SEE MECHANICAL AND ELECTRICAL FOR ADDITIONAL INFORMATION
222	MECHANICAL REGISTER AT +10'-4" ABOVE FINISH FLOOR. SEE MECHANICAL AND ELECTRICAL FOR ADDITIONAL INFORMATION. (REVIEW LOCATION IN THE FIELD WITH ARCHITECT PRIOR TO COMPLETING WORK)

FLOOR PLAN LEGEND

SYMBOL	DESCRIPTION
(E)	WOOD STUD WALL OR PARTITION TO REMAIN.
Metal Stud Wall Assembly	METAL STUD WALL ASSEMBLY. REFER TO WALL TYPE AND TYPICAL DETAILS ON A711 FOR MORE INFORMATION
Door and Frame	NEW DOOR AND FRAME. SEE DOOR SCHEDULE ON A611 FOR MORE INFORMATION
Wall Type	WALL TYPE. SEE A711 FOR MORE INFORMATION.

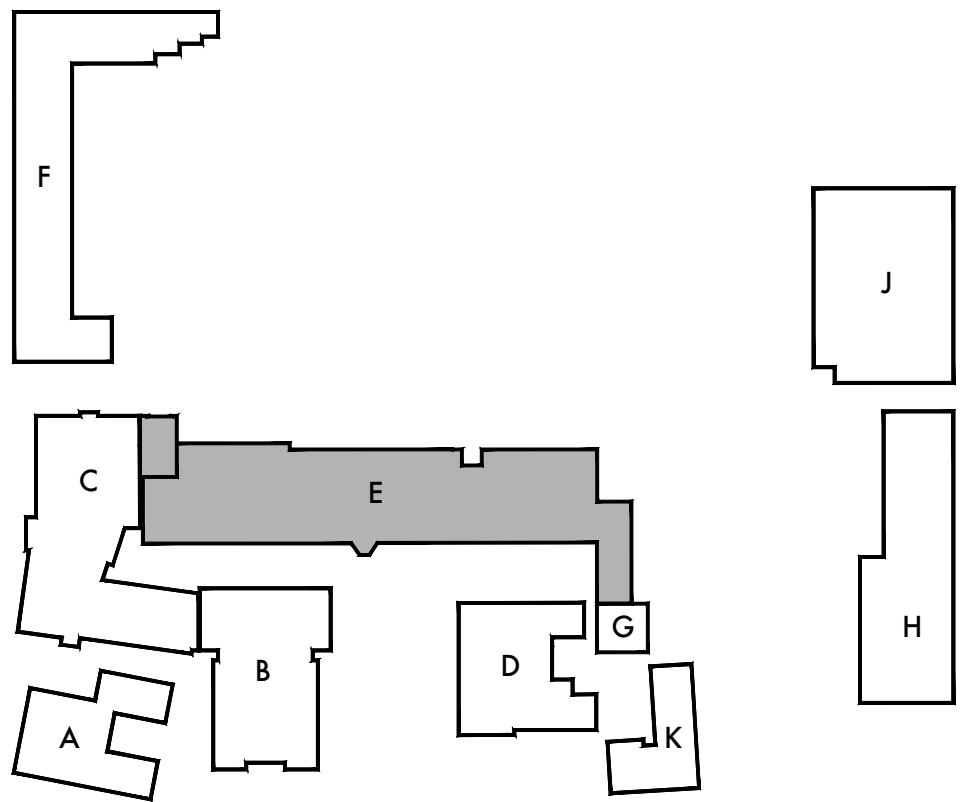

KEY PLAN

DSA Stamp

Architect




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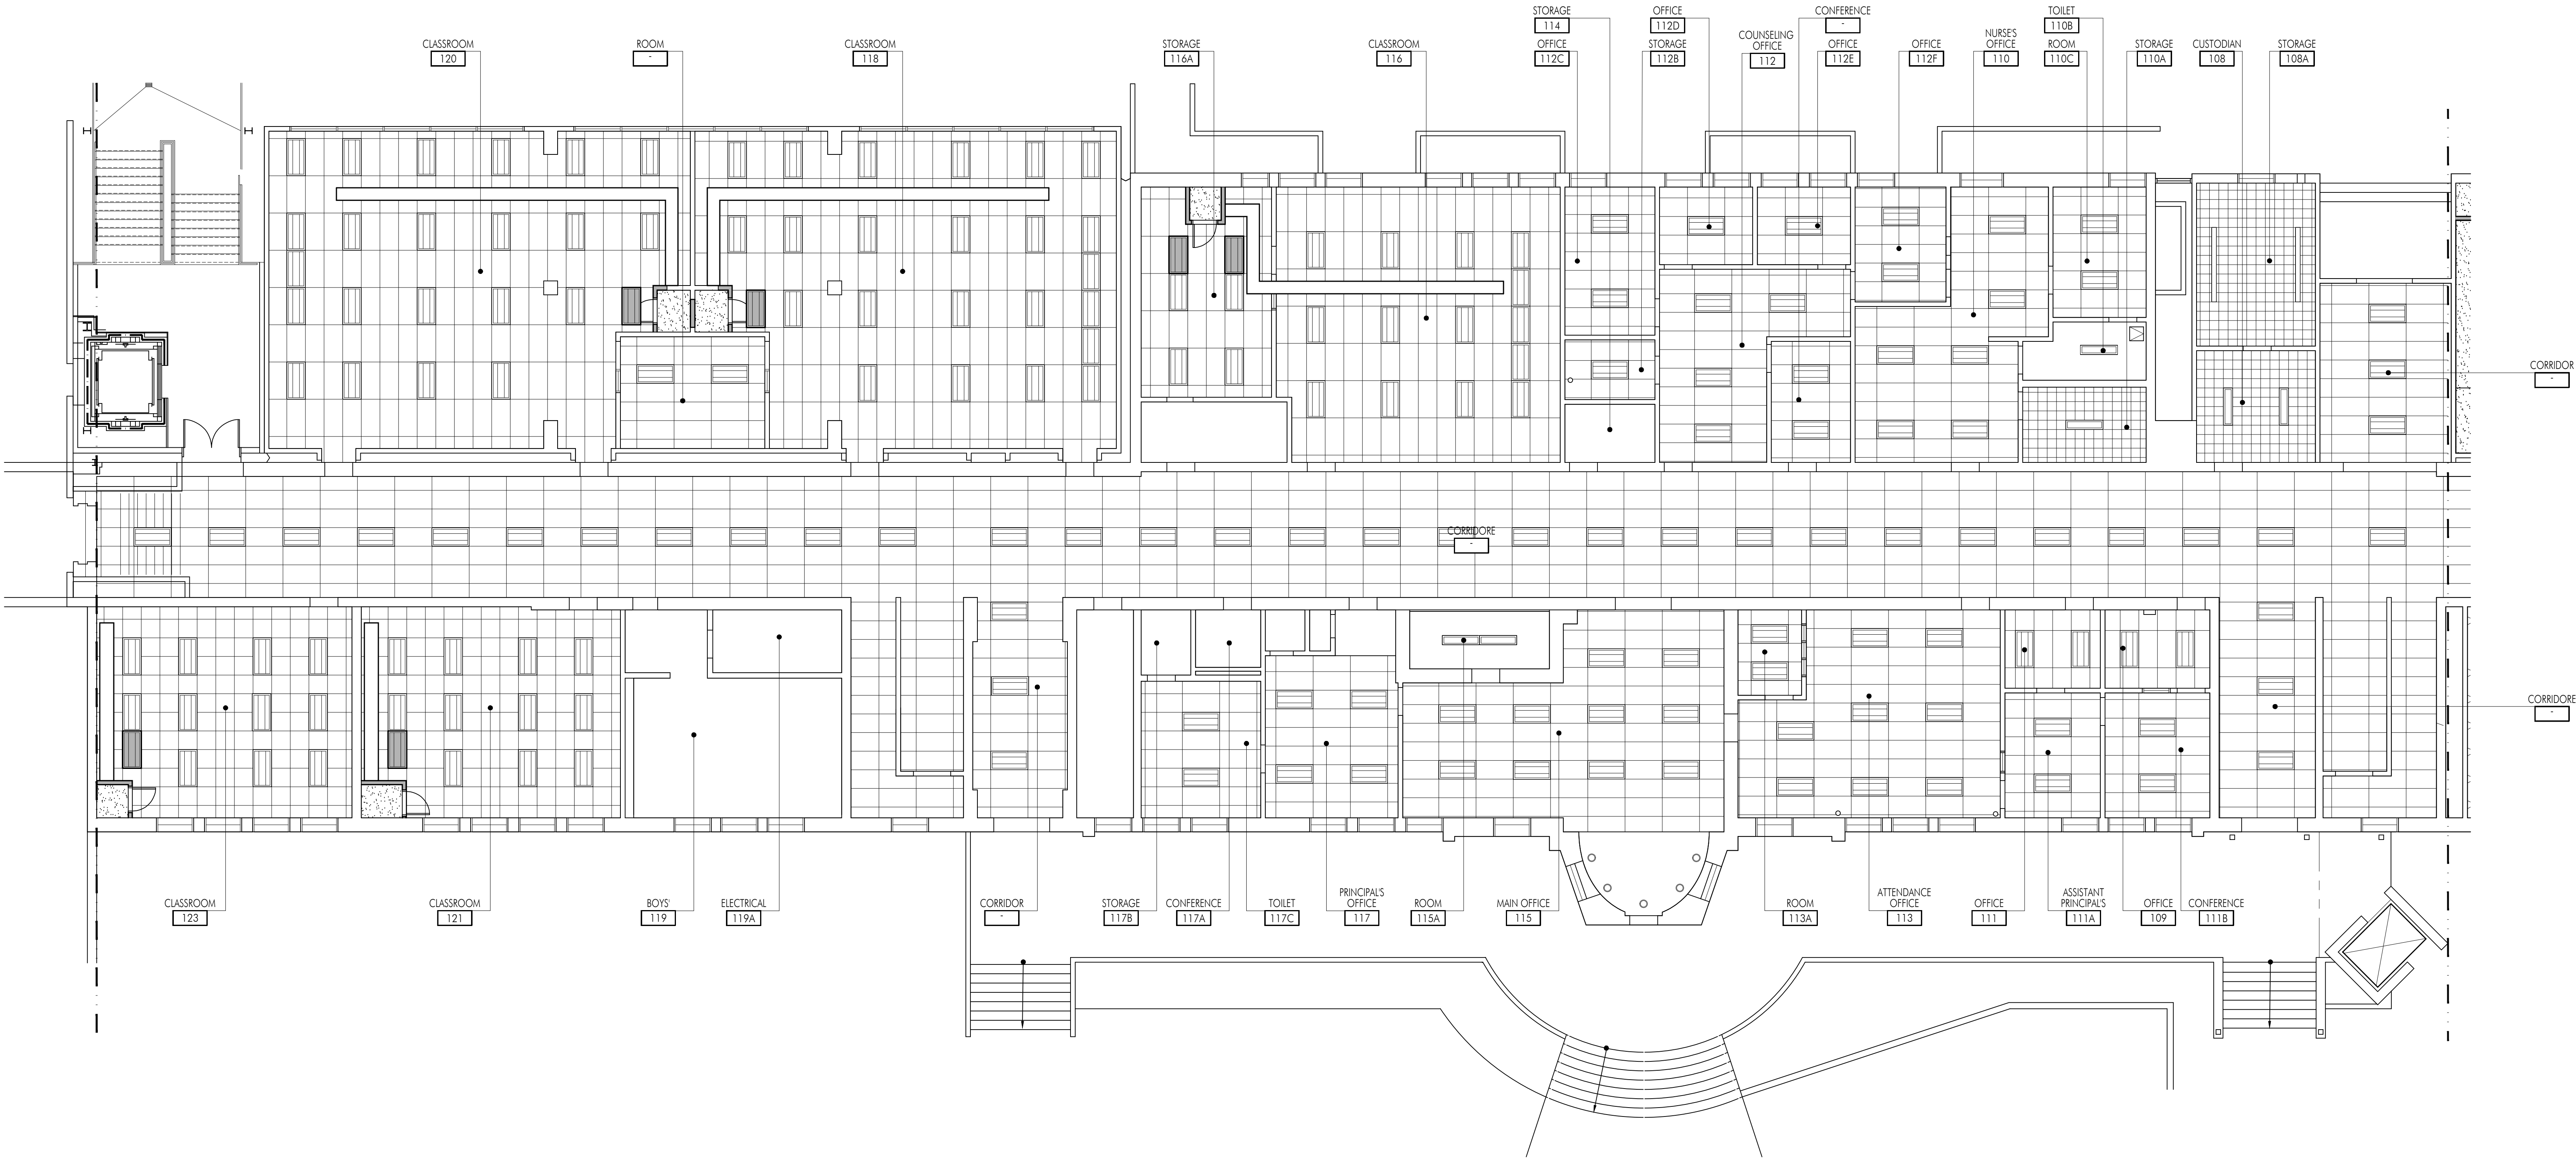


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Sheet Title
Building 'E' First
Floor Reflected
Ceiling Plan

Sheet Number

AE231A

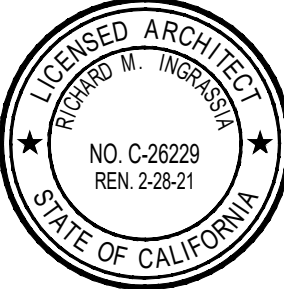

1 REFLECTED CEILING PLAN

FLOOR PLAN GENERAL NOTES


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KEYNOTES

NO.	DESCRIPTION
320	EXISTING MECHANICAL DUCT TO REMAIN; PROTECT IN PLACE TO BE REUSED AND CONNECT TO NEW EQUIPMENT. SEE MECHANICAL FOR ADDITIONAL INFORMATION.

FLOOR PLAN LEGEND

SYMBOL	DESCRIPTION
	(E) WOOD STUD WALL OR PARTITION TO REMAIN.
	METAL STUD WALL ASSEMBLY. REFER TO WALL TYPE AND TYPICAL DETAILS ON A711 FOR MORE INFORMATION.
	EXISTING SUSPENDED T-BAR CEILING SYSTEM TO REMAIN, UNLESS NOTED OTHERWISE.
	EXISTING GLUE ON ACOUSTIC TILE TO REMAIN, UNLESS NOTED OTHERWISE.
	EXISTING LIGHT FIXTURE TO REMAIN. SEE ELECTRICAL FOR MORE INFORMATION.
	RELOCATED LIGHT FIXTURE. SEE ELECTRICAL FOR MORE INFORMATION.
	FRAMED GYPSUM BOARD CEILING SEE XXXX FOR ADDITIONAL INFORMATION AND REFERENCED DETAIL ON PLAN FOR SOFFIT CONDITIONS AS OCCURS. PAINT P-1
	AIR SUPPLY REGISTER
	RETURN AIR GRILLE

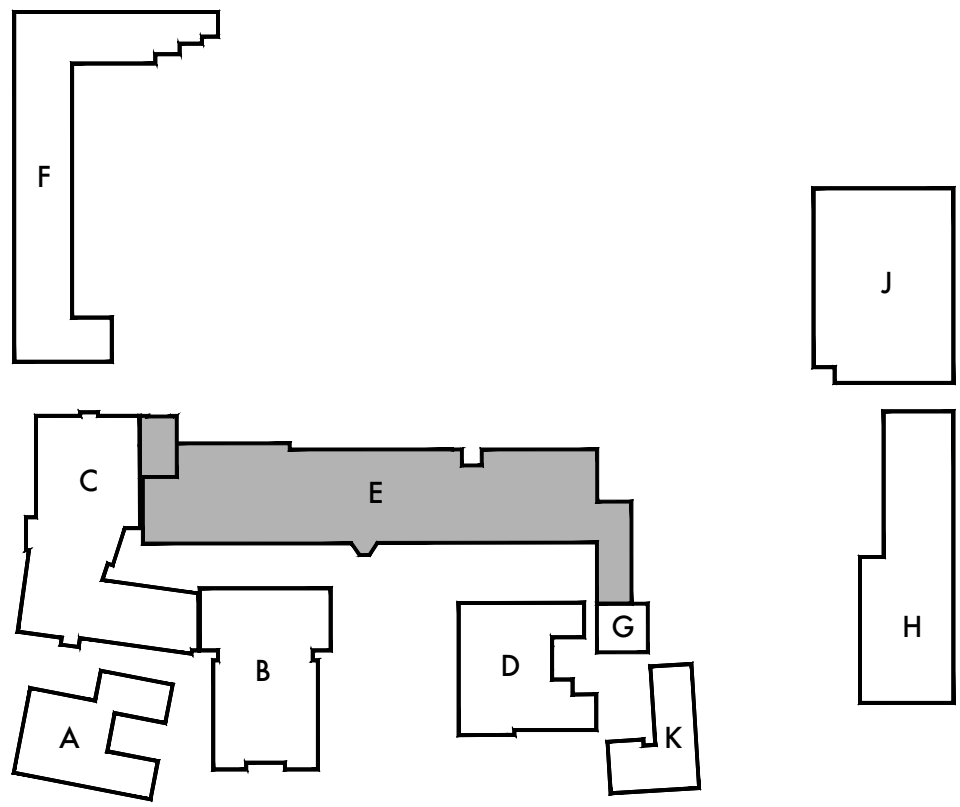

KEY PLAN

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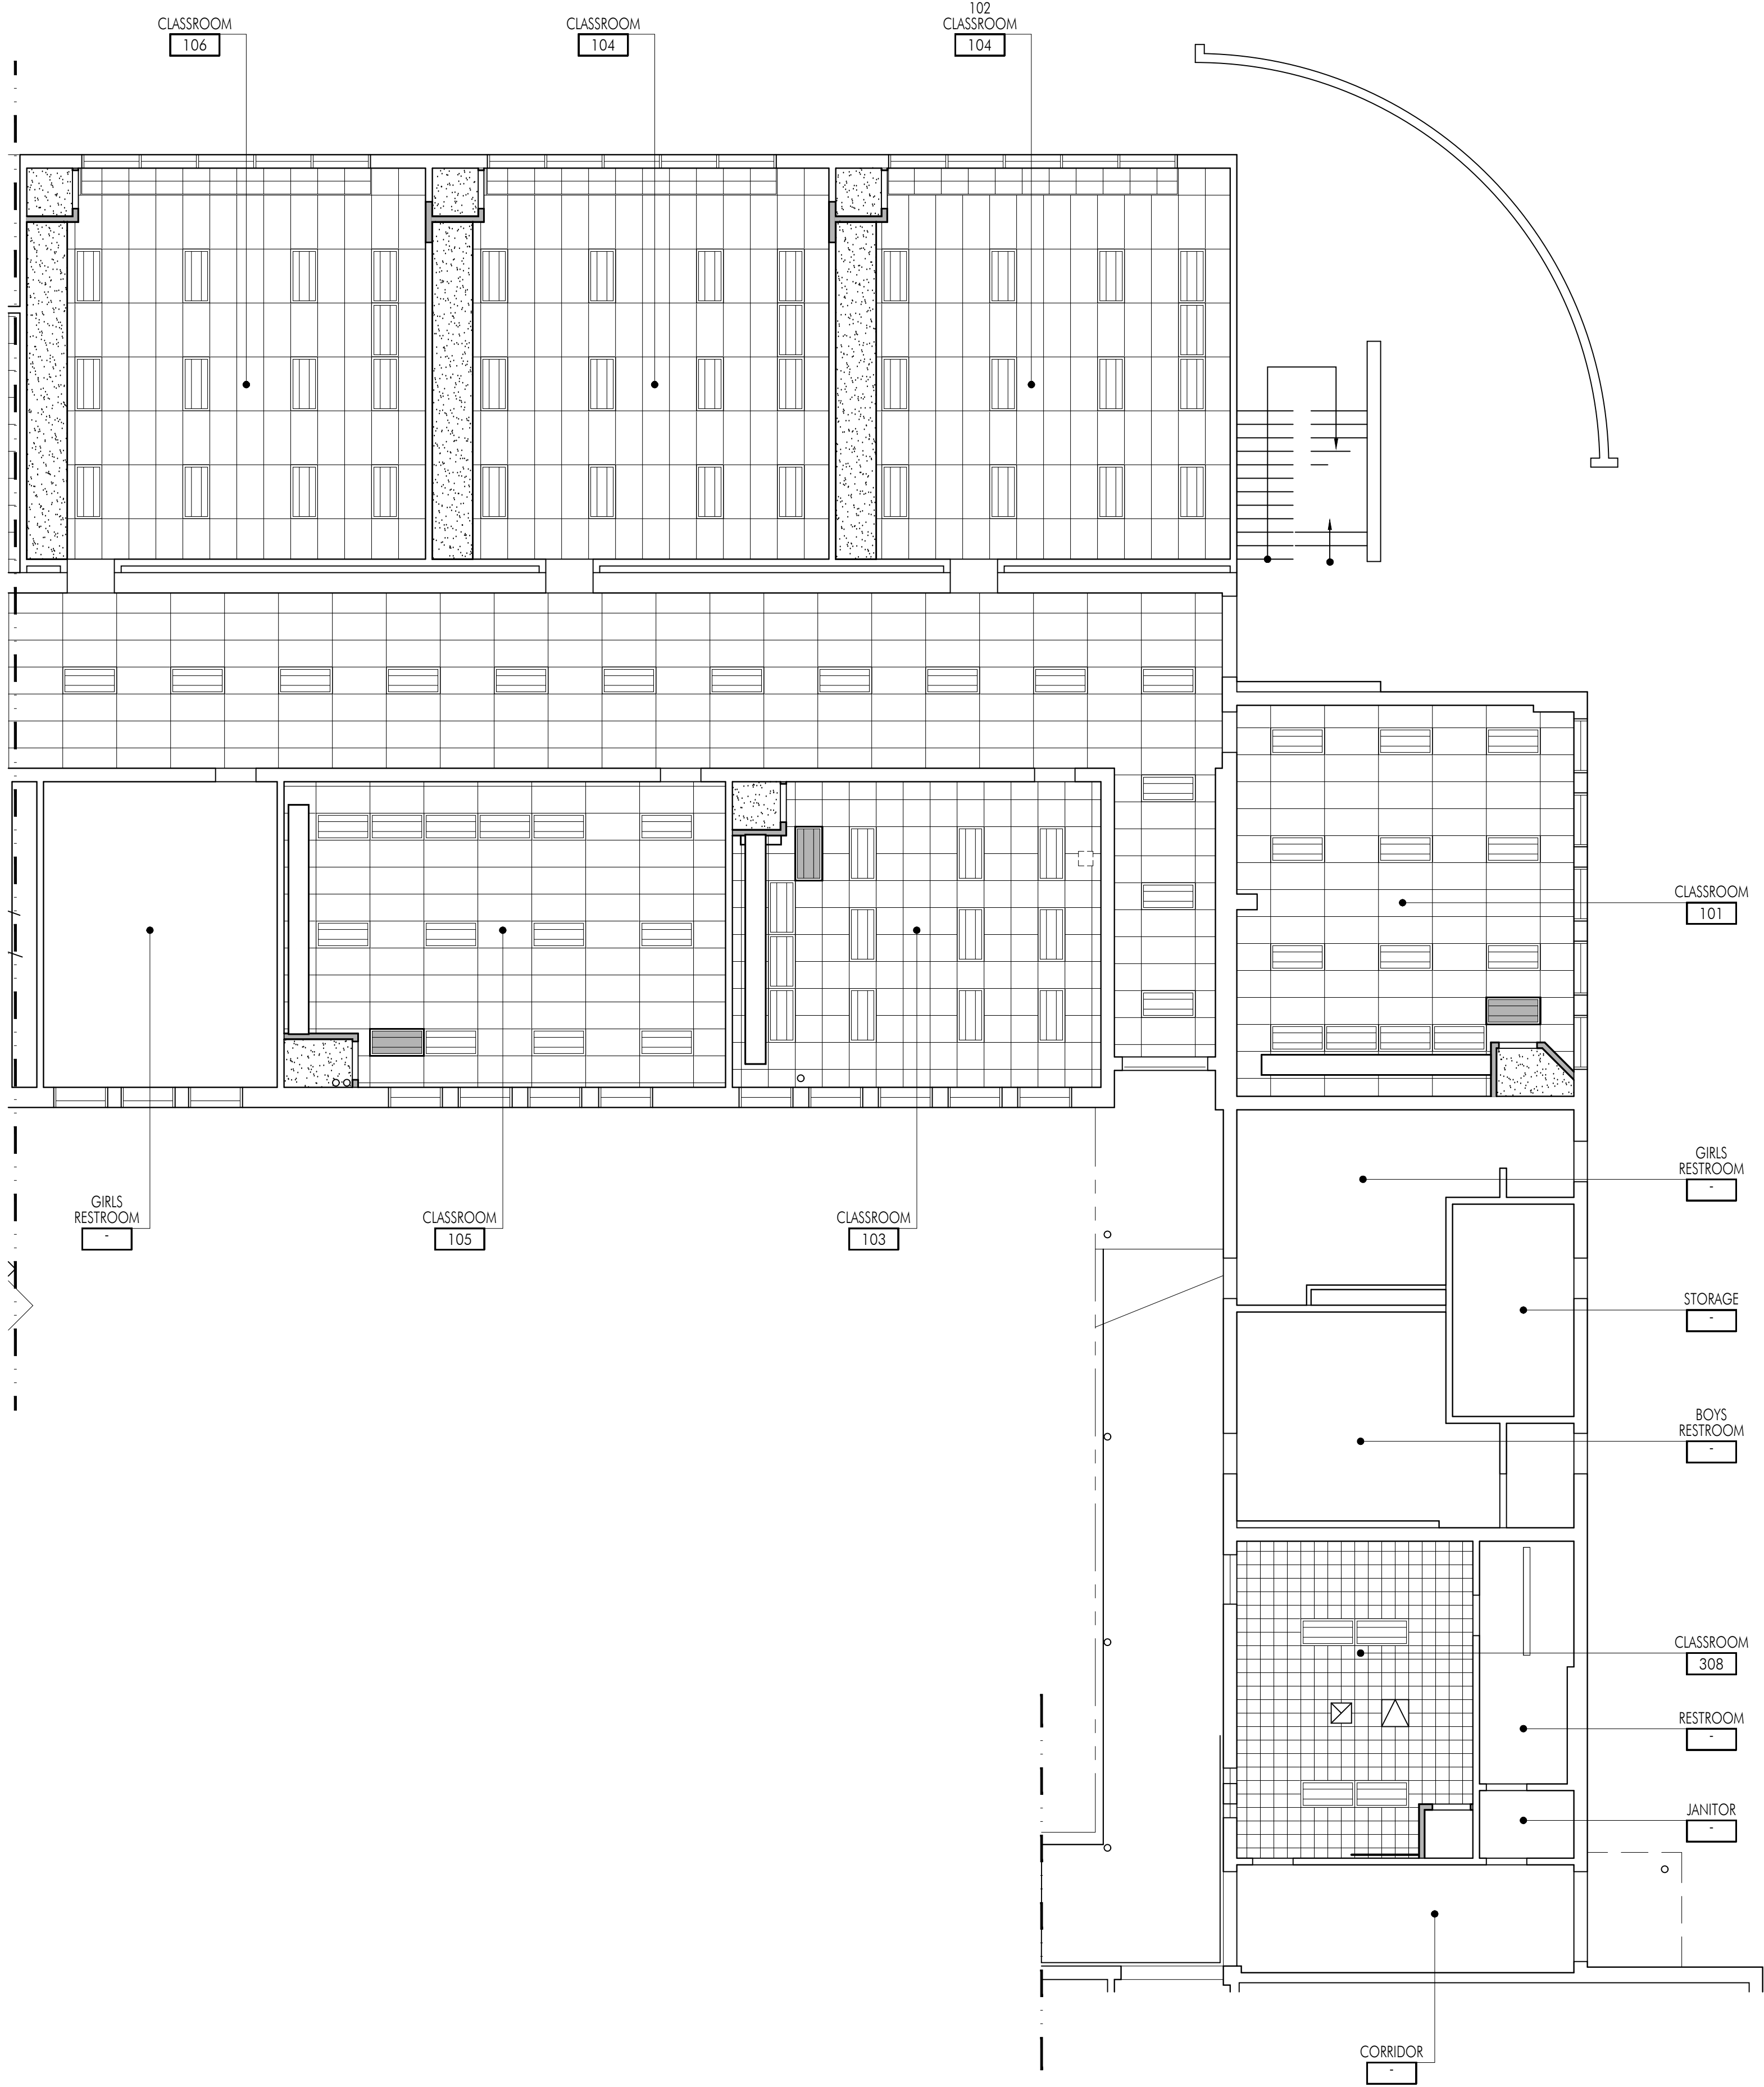


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Sheet Title
Building 'E' First
Floor Reflected
Ceiling Plan

Sheet Number

AE231B



1 REFLECTED CILING PLAN

FLOOR PLAN GENERAL NOTES


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FLOOR PLAN LEGEND

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	EXISTING GLUE ON ACOUSTIC TILE TO REMAIN, UNLESS NOTED OTHERWISE.
	EXISTING LIGHT FIXTURE TO REMAIN. SEE ELECTRICAL FOR MORE INFORMATION.
	RELOCATED LIGHT FIXTURE. SEE ELECTRICAL FOR MORE INFORMATION.
	FRAMED GYPSUM BOARD CEILING SEE XXXX FOR ADDITIONAL INFORMATION AND REFERENCED DETAIL ON PLAN FOR SOFFIT CONDITIONS AS OCCURS. PAINT P-1
	AIR SUPPLY REGISTER
	RETURN AIR GRILLE



KEY PLAN

DSA Stamp

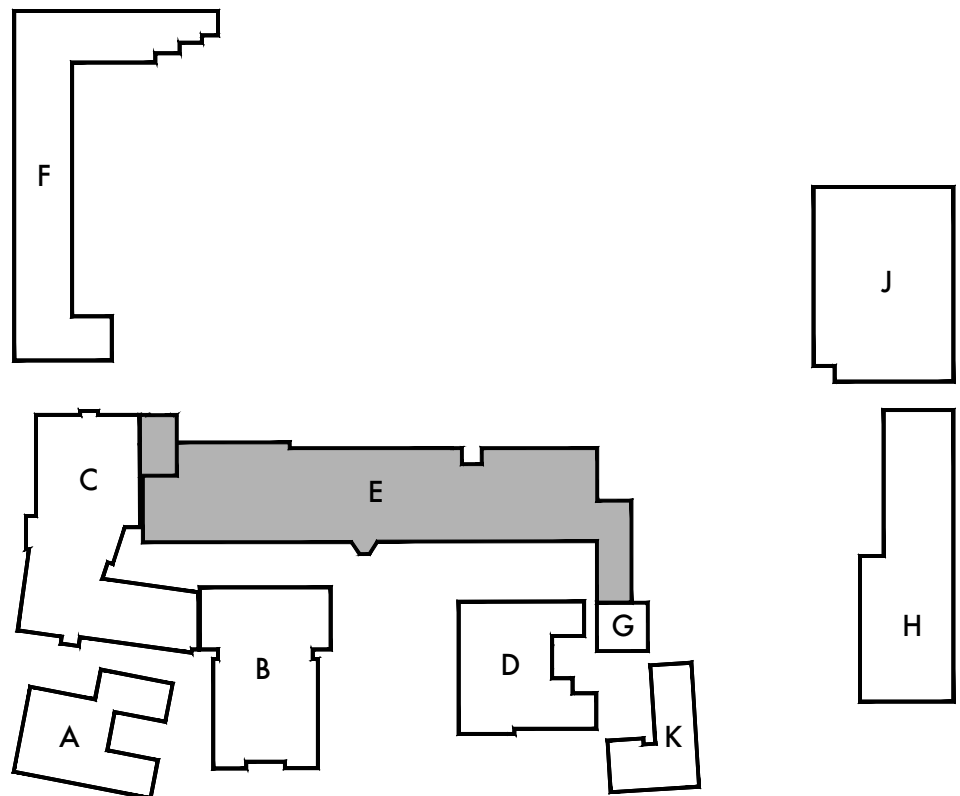Architect



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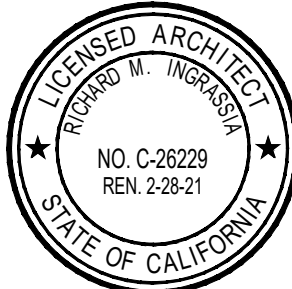
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1	11.27.19	50% CD's



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Date: 11.27.2019
Scale: As Shown
Drawn By: DH, RM
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Sheet Title
Building 'E' Second
Floor Reflected
Ceiling Plan

Sheet Number

AE232A

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1 REFLECTED CEILING PLAN

FLOOR PLAN GENERAL NOTES


- REMOVE EXISTING GYPSUM BOARD, TILE AND BACKER BOARD OR PLASTER TO ACCOMMODATE REMOVAL AND REPLACEMENT OF PIPING, ELECTRICAL AND FOR THE INSTALLATION OF SUPPORT BLOCKING AND MECHANICAL EQUIPMENT. PATCH BACK TO MATCH ADJACENT SURFACE.
- REFER TO MECHANICAL, PLUMBING, ELECTRICAL AND FIRE ALARM DRAWINGS FOR ADDITIONAL SCOPE OF WORK IN EACH ROOM.
- ALL WALLS SHALL BE FULL HEIGHT TO THE ROOF DECK UNLESS NOTED OTHERWISE, AND SHALL BE CLOSED AND SEALED PER WALL TYPE AND AS DETAILED ON A711.
- UNSCHEDULED CUTTING, REMOVING OR TRIMMING OF EXISTING CONCRETE, MASONRY OR WOOD FRAMED WALLS IS NOT PERMITTED. UNLESS NOTED OTHERWISE ALL DOORS SHALL BE FITTED WITHIN EXISTING WALL OPENINGS WITHOUT ENLARGING OR TRIMMING HEAD OR JAMBS.

KEYNOTES

NO.	DESCRIPTION
320	EXISTING MECHANICAL DUCT TO REMAIN; PROTECT IN PLACE TO BE REUSED AND CONNECT TO NEW EQUIPMENT. SEE MECHANICAL FOR ADDITIONAL INFORMATION.

FLOOR PLAN LEGEND

SYMBOL	DESCRIPTION
	(E) WOOD STUD WALL OR PARTITION TO REMAIN.
	METAL STUD WALL ASSEMBLY. REFER TO WALL TYPE AND TYPICAL DETAILS ON A711 FOR MORE INFORMATION.
	EXISTING SUSPENDED T-BAR CEILING SYSTEM TO REMAIN, UNLESS NOTED OTHERWISE.
	EXISTING GLUE ON ACOUSTIC TILE TO REMAIN, UNLESS NOTED OTHERWISE.
	EXISTING LIGHT FIXTURE TO REMAIN. SEE ELECTRICAL FOR MORE INFORMATION.
	RELOCATED LIGHT FIXTURE. SEE ELECTRICAL FOR MORE INFORMATION.
	FRAMED GYPSUM BOARD CEILING SEE XXXX FOR ADDITIONAL INFORMATION AND REFERENCED DETAIL ON PLAN FOR SOFFIT CONDITIONS AS OCCURS. PAINT P-1
	AIR SUPPLY REGISTER
	RETURN AIR GRILLE
	EXHAUST GRILLE

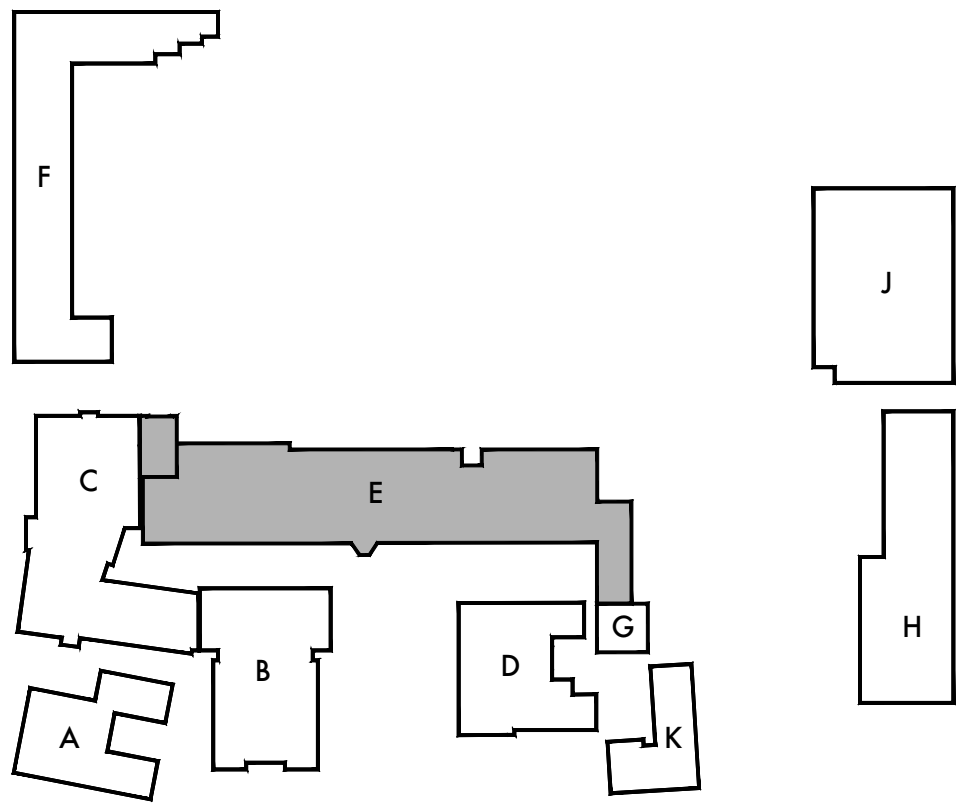

KEY PLAN

DSA Stamp

Architect



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Lincoln Middle School
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Santa Monica, California 90403


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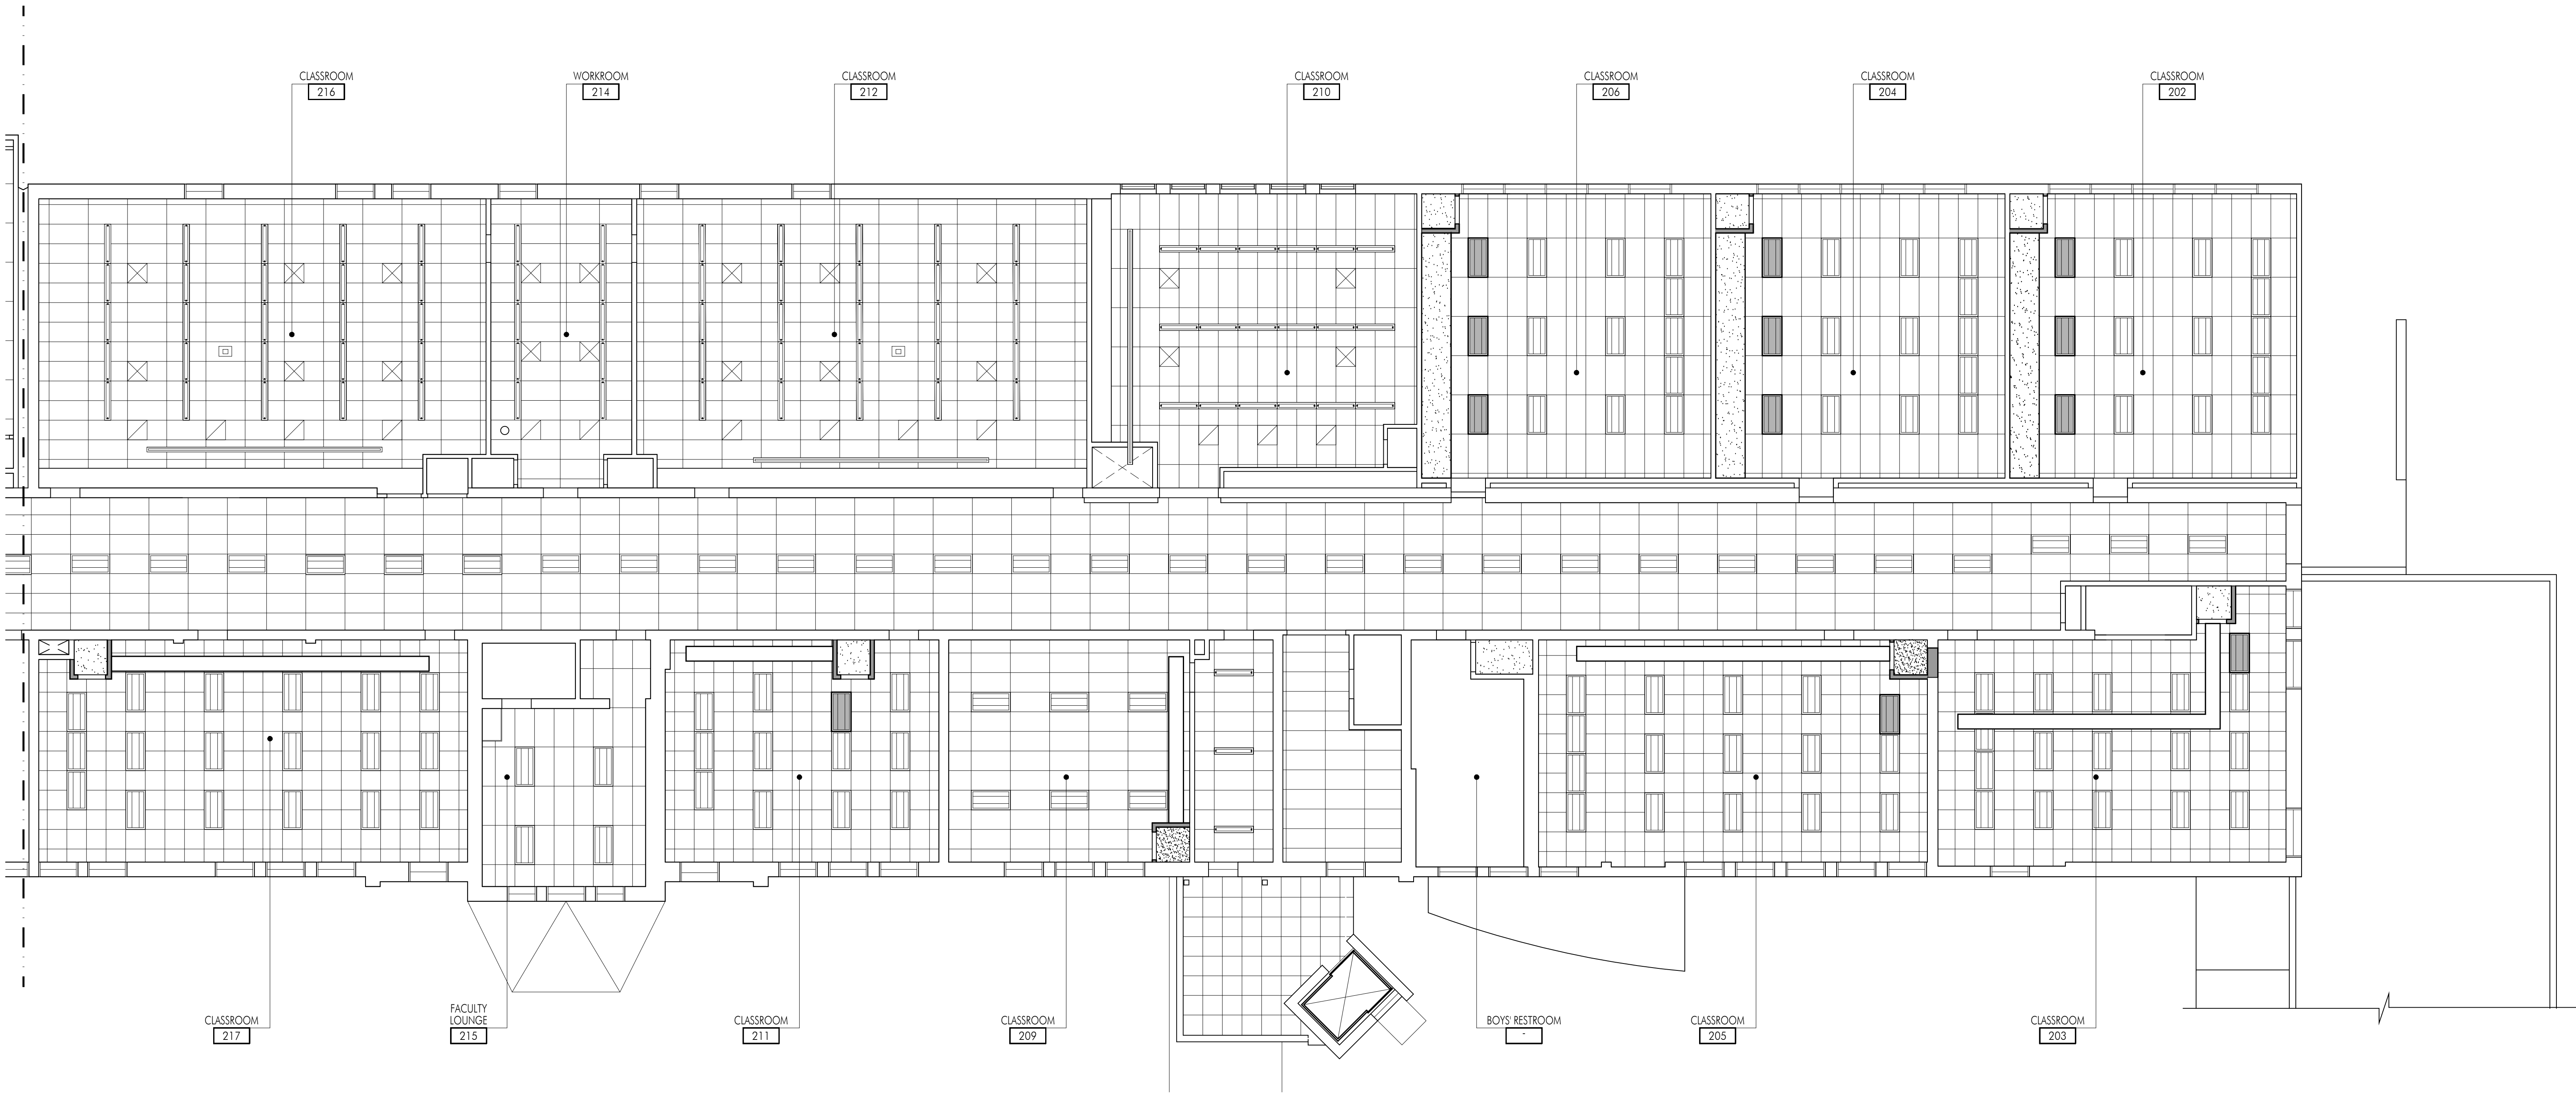


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Sheet Title
Building 'E' Second
Floor Reflected
Ceiling Plan

Sheet Number

AE232B

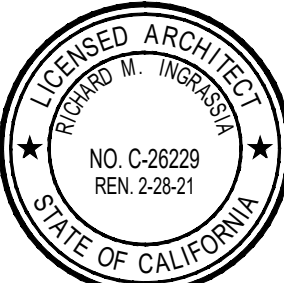

1 REFLECTED CEILING PLAN

FLOOR PLAN GENERAL NOTES


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KEYNOTES

NO.	DESCRIPTION
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FLOOR PLAN LEGEND

SYMBOL	DESCRIPTION
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	EXISTING LIGHT FIXTURE TO REMAIN. SEE ELECTRICAL FOR MORE INFORMATION.
	RELOCATED LIGHT FIXTURE. SEE ELECTRICAL FOR MORE INFORMATION.
	FRAMED GYPSUM BOARD CEILING SEE XXXX FOR ADDITIONAL INFORMATION AND REFERENCED DETAIL ON PLAN FOR SOFFIT CONDITIONS AS OCCURS. PAINT P-1
	AIR SUPPLY REGISTER
	RETURN AIR GRILLE



KEY PLAN
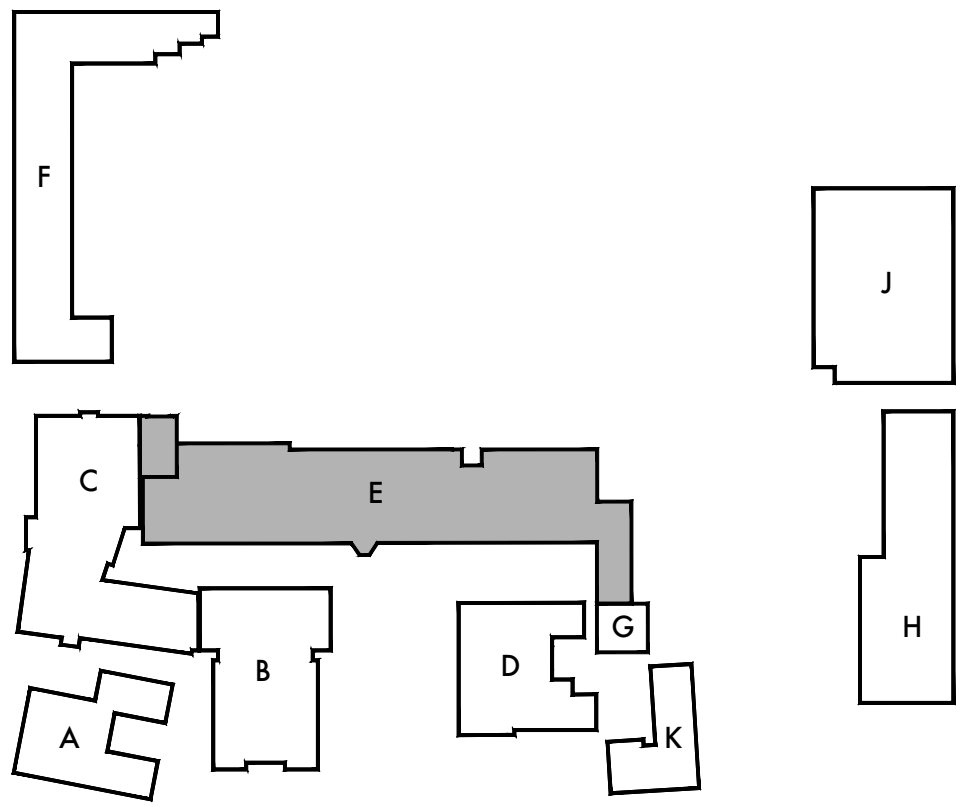
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Architect



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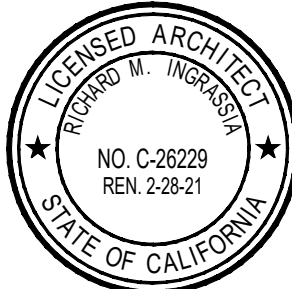
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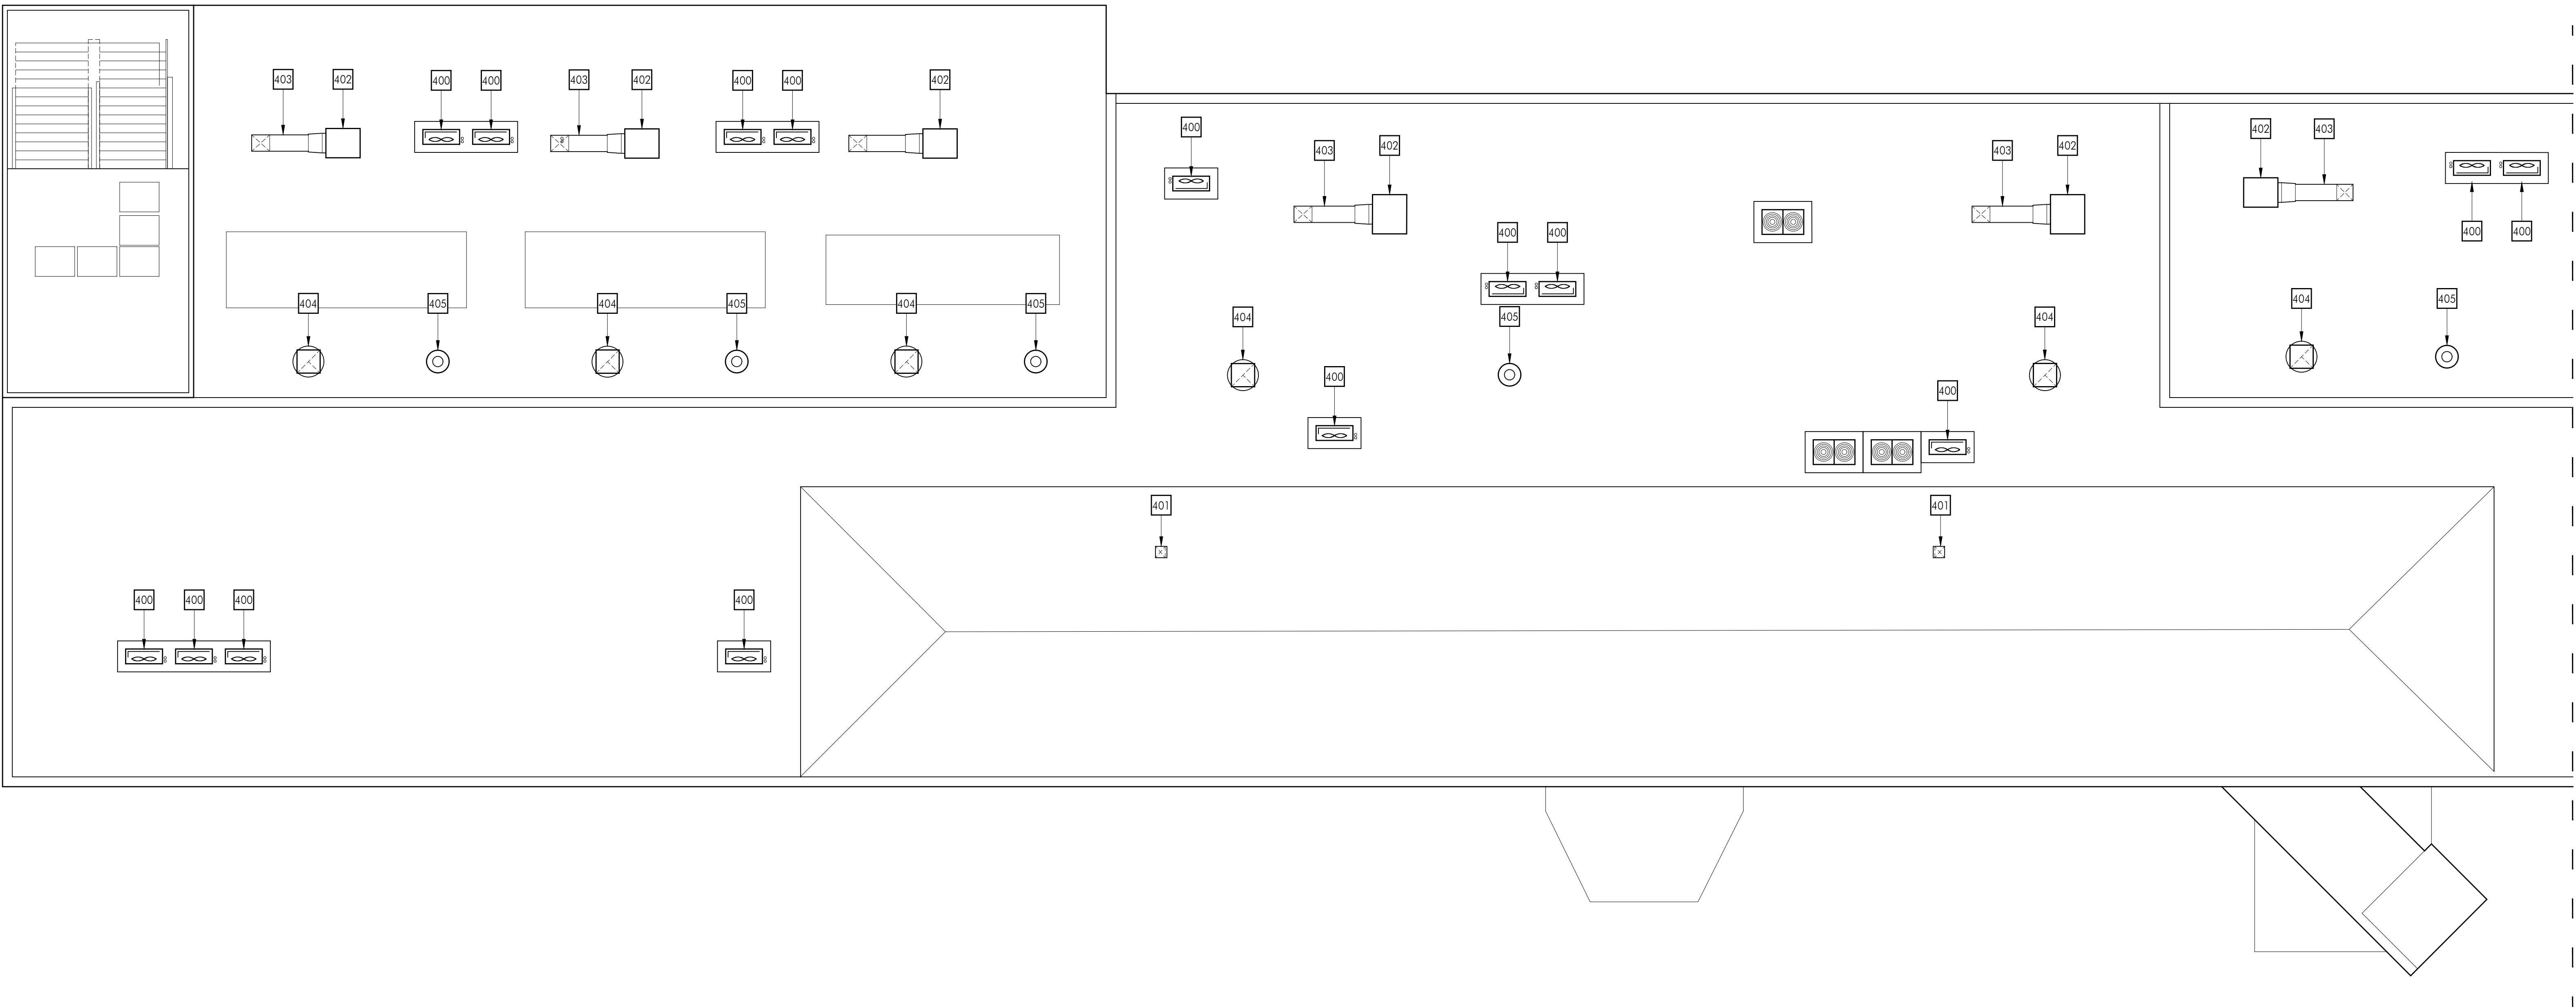


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Sheet Title
Building 'E' Roof
Plan

Sheet Number

AE241A




1 DEMOLITION FLOOR PLAN

FLOOR PLAN GENERAL NOTES

- REMOVE EXISTING GYPSUM BOARD, TILE AND BACKER BOARD OR PLASTER TO ACCOMMODATE REMOVAL AND REPLACEMENT OF PIPING, ELECTRICAL AND FOR THE INSTALLATION OF SUPPORT BLOCKING AND MECHANICAL EQUIPMENT. PATCH BACK TO MATCH ADJACENT SURFACE.
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KEYNOTES

NO.	DESCRIPTION
400	ROOF MOUNTED MECHANICAL CONDENSER UNIT ON WOOD PAD. SEE PLAN FOR ROUGH DIMENSIONS, ADJUST PAD SIZE FOR NUMBER OF CONDENSERS AND REQUIRED CLEARANCES. SEE MECHANICAL AND DETAIL X/A831 FOR ADDITIONAL INFORMATION.
401	MECHANICAL DUCT PENETRATION AT EXISTING ROOF. SEE MECHANICAL AND DETAIL X/A831 FOR ADDITIONAL INFORMATION.
402	ROOF MOUNTED MECHANICAL UNIT. SEE MECHANICAL AND DETAIL X/A831 FOR ADDITIONAL INFORMATION.
403	ROOF MOUNTED MECHANICAL DUCT. SEE MECHANICAL AND DETAIL X/A831 FOR ADDITIONAL INFORMATION.
404	ROOF MOUNTED EXHAUST FAN. SEE MECHANICAL AND DETAIL X/A831 FOR ADDITIONAL INFORMATION.
405	ROOF MOUNTED GRAVITY INTAKE. SEE MECHANICAL AND DETAIL X/A831 FOR ADDITIONAL INFORMATION.

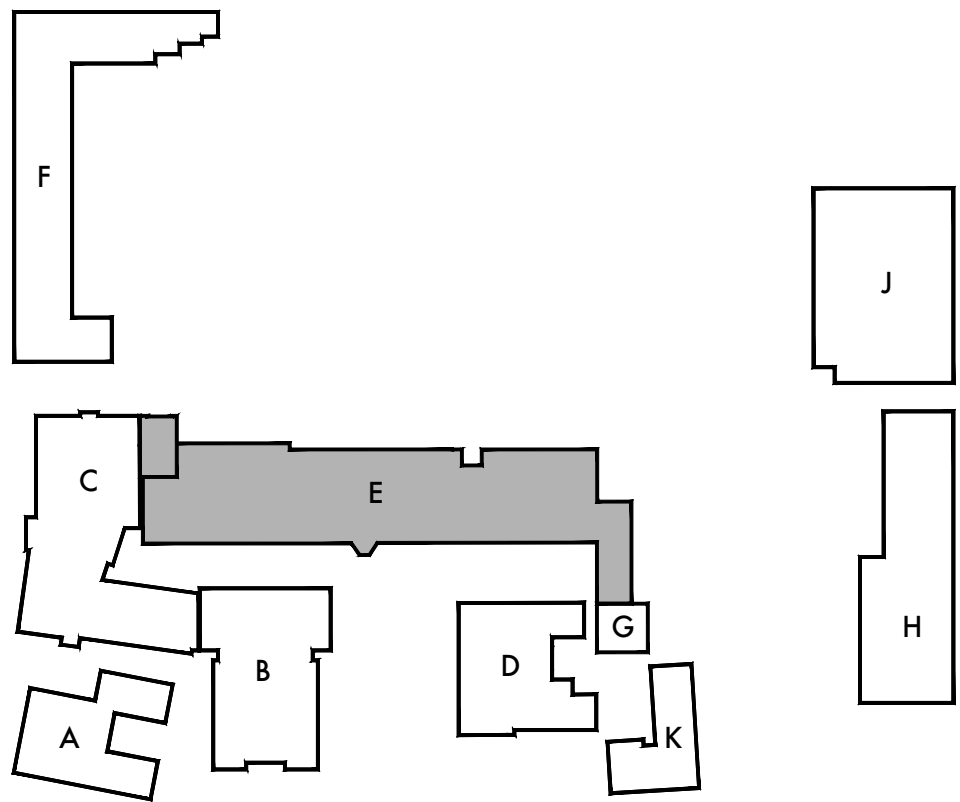

KEY PLAN

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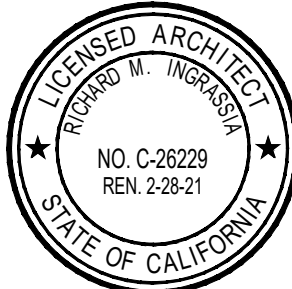
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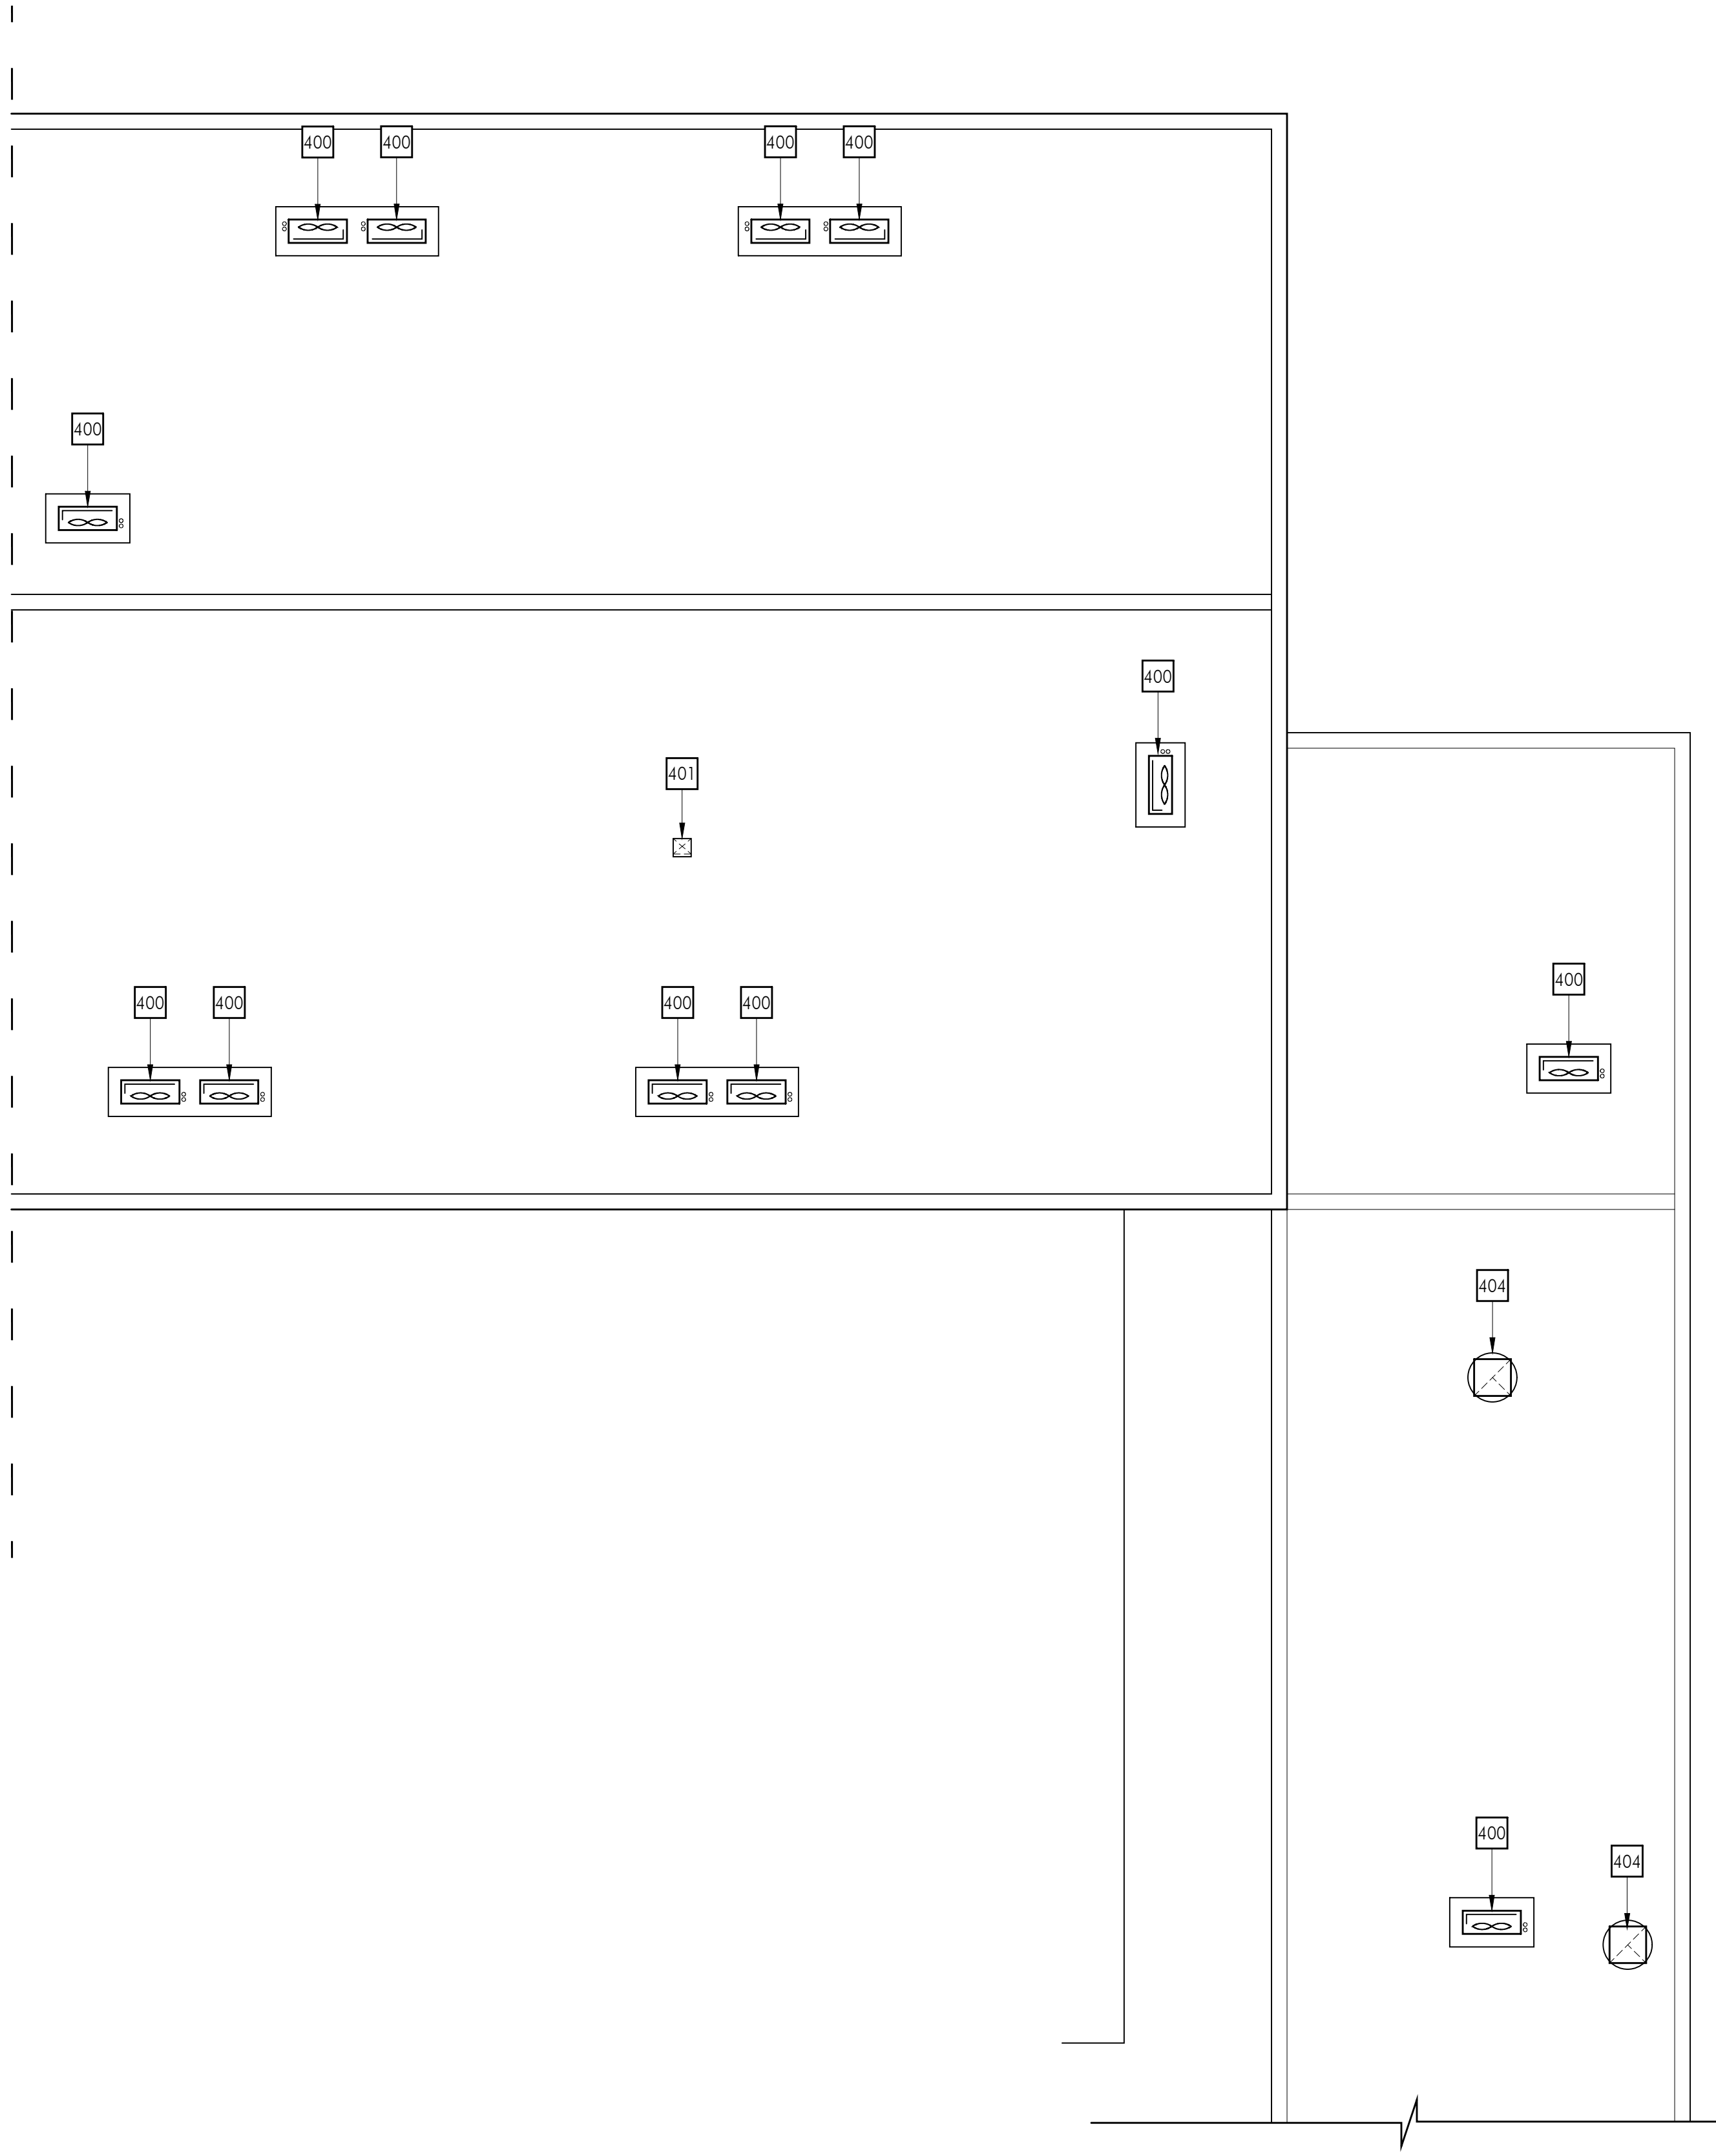
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Sheet Title

Building 'E' Roof
Plan

Sheet Number

AE241B




1 DEMOLITION FLOOR PLAN

FLOOR PLAN GENERAL NOTES

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KEYNOTES


NO.	DESCRIPTION
400	ROOF MOUNTED MECHANICAL CONDENSER UNIT ON WOOD PAD. SEE PLAN FOR ROUGH DIMENSIONS, ADJUST PAD SIZE FOR NUMBER OF CONDENSERS AND REQUIRED CLEARANCES. SEE MECHANICAL AND DETAIL X/A831 FOR ADDITIONAL INFORMATION.
401	MECHANICAL DUCT PENETRATION AT EXISTING ROOF. SEE MECHANICAL AND DETAIL X/A831 FOR ADDITIONAL INFORMATION.
402	ROOF MOUNTED MECHANICAL UNIT. SEE MECHANICAL AND DETAIL X/A831 FOR ADDITIONAL INFORMATION.
403	ROOF MOUNTED MECHANICAL DUCT. SEE MECHANICAL AND DETAIL X/A831 FOR ADDITIONAL INFORMATION.
404	ROOF MOUNTED EXHAUST FAN. SEE MECHANICAL AND DETAIL X/A831 FOR ADDITIONAL INFORMATION.
405	ROOF MOUNTED GRAVITY INTAKE. SEE MECHANICAL AND DETAIL X/A831 FOR ADDITIONAL INFORMATION.

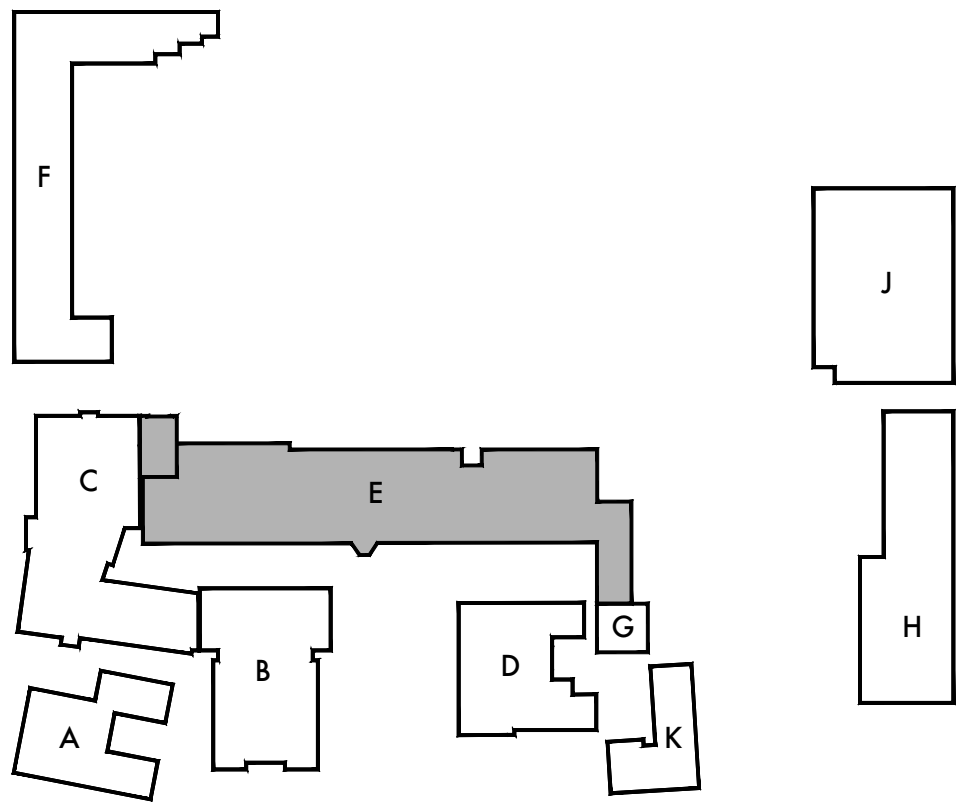

KEY PLAN


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2 DEMOLITION REFLECTED CEILING PLAN

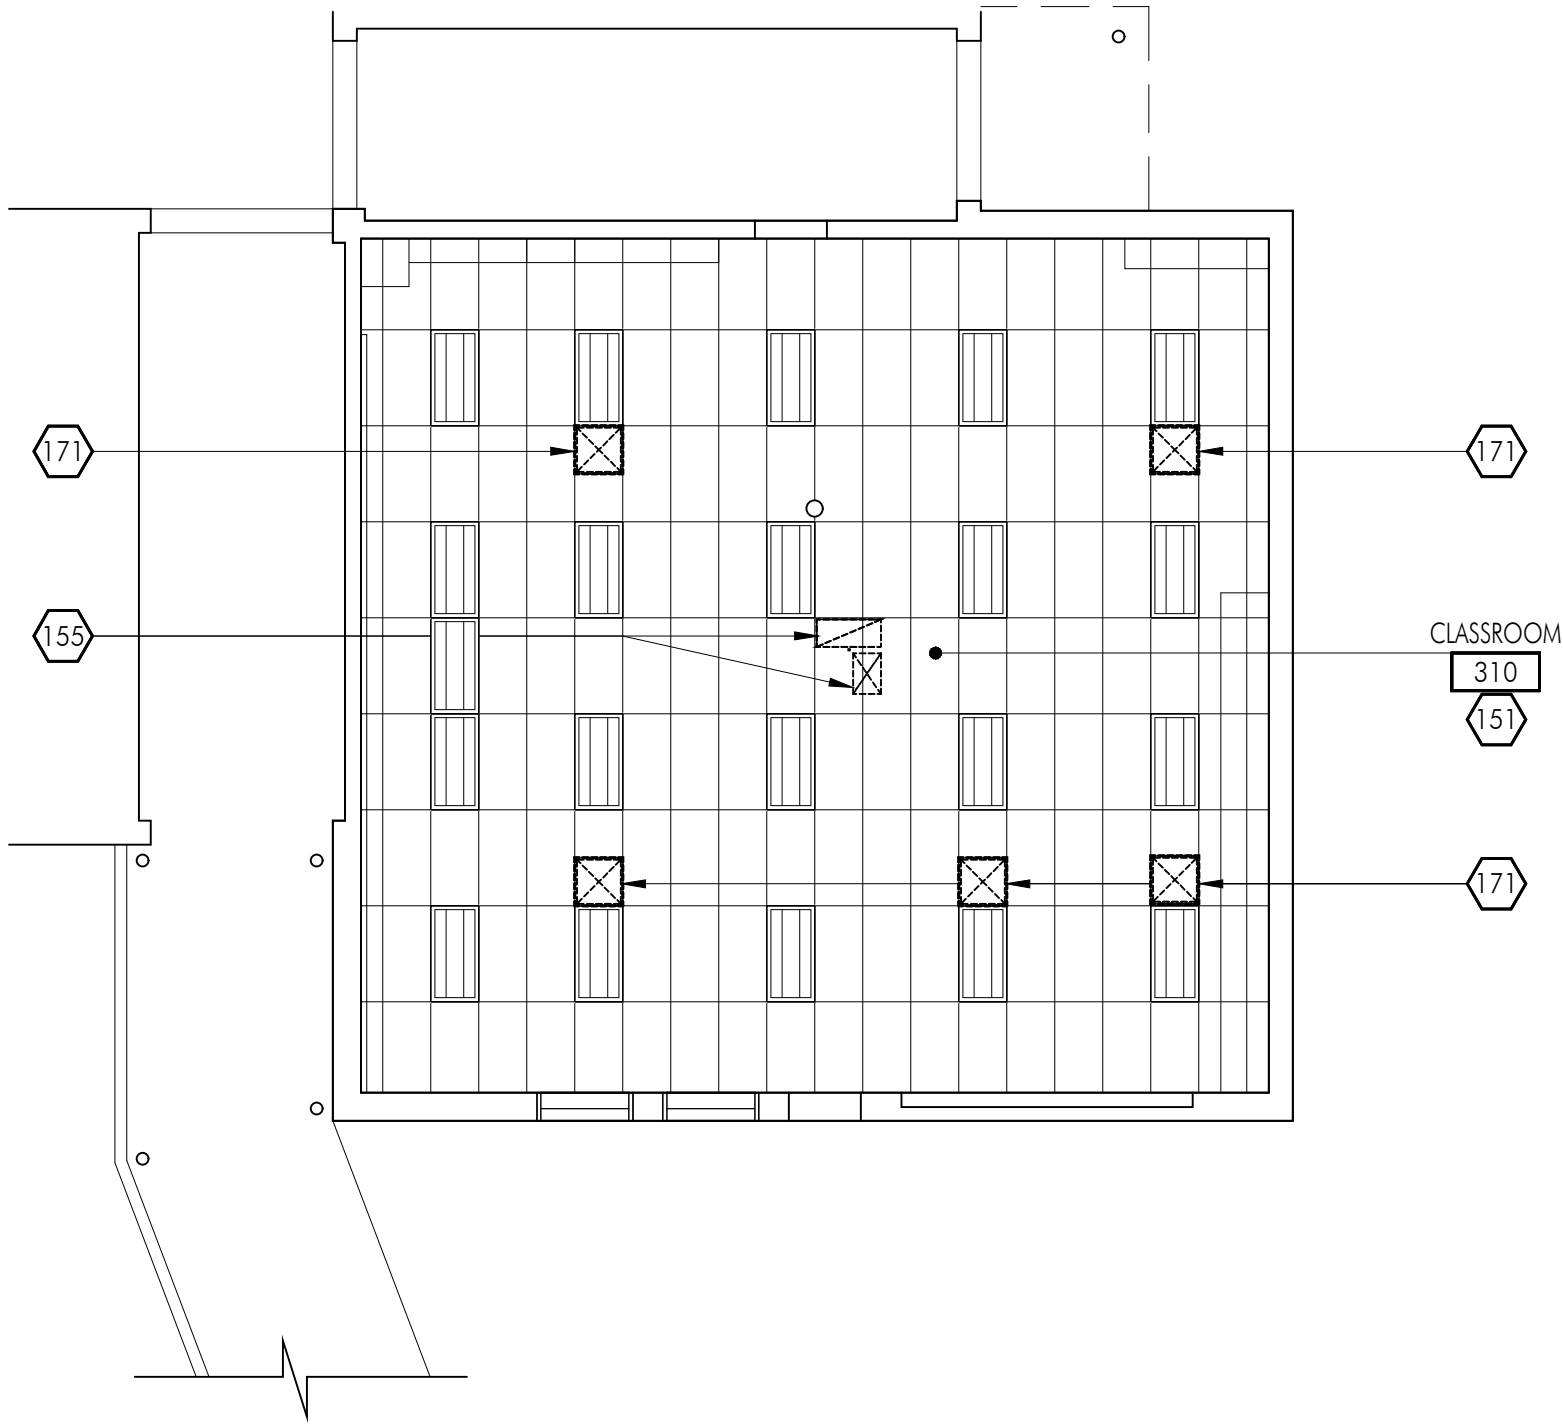


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1 DEMOLITION FLOOR PLAN



SCALE: 1/8"=1'-0"

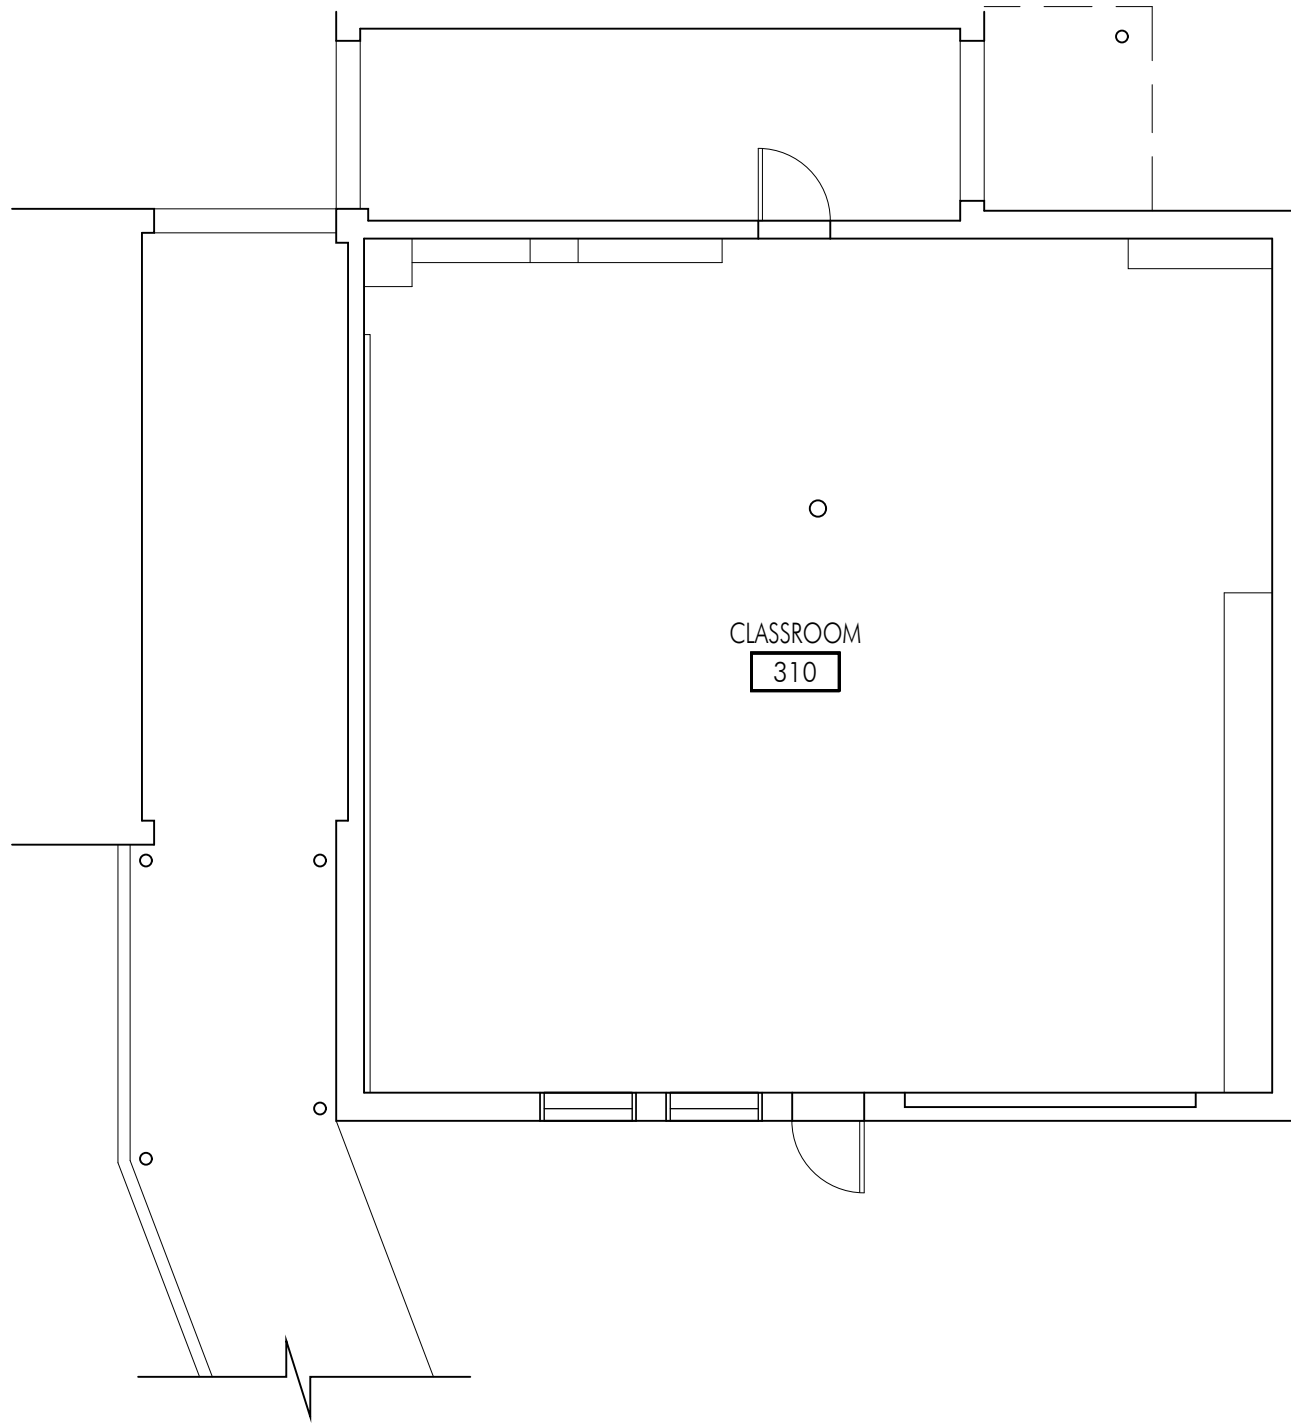3 DEMOLITION FLOOR PLAN

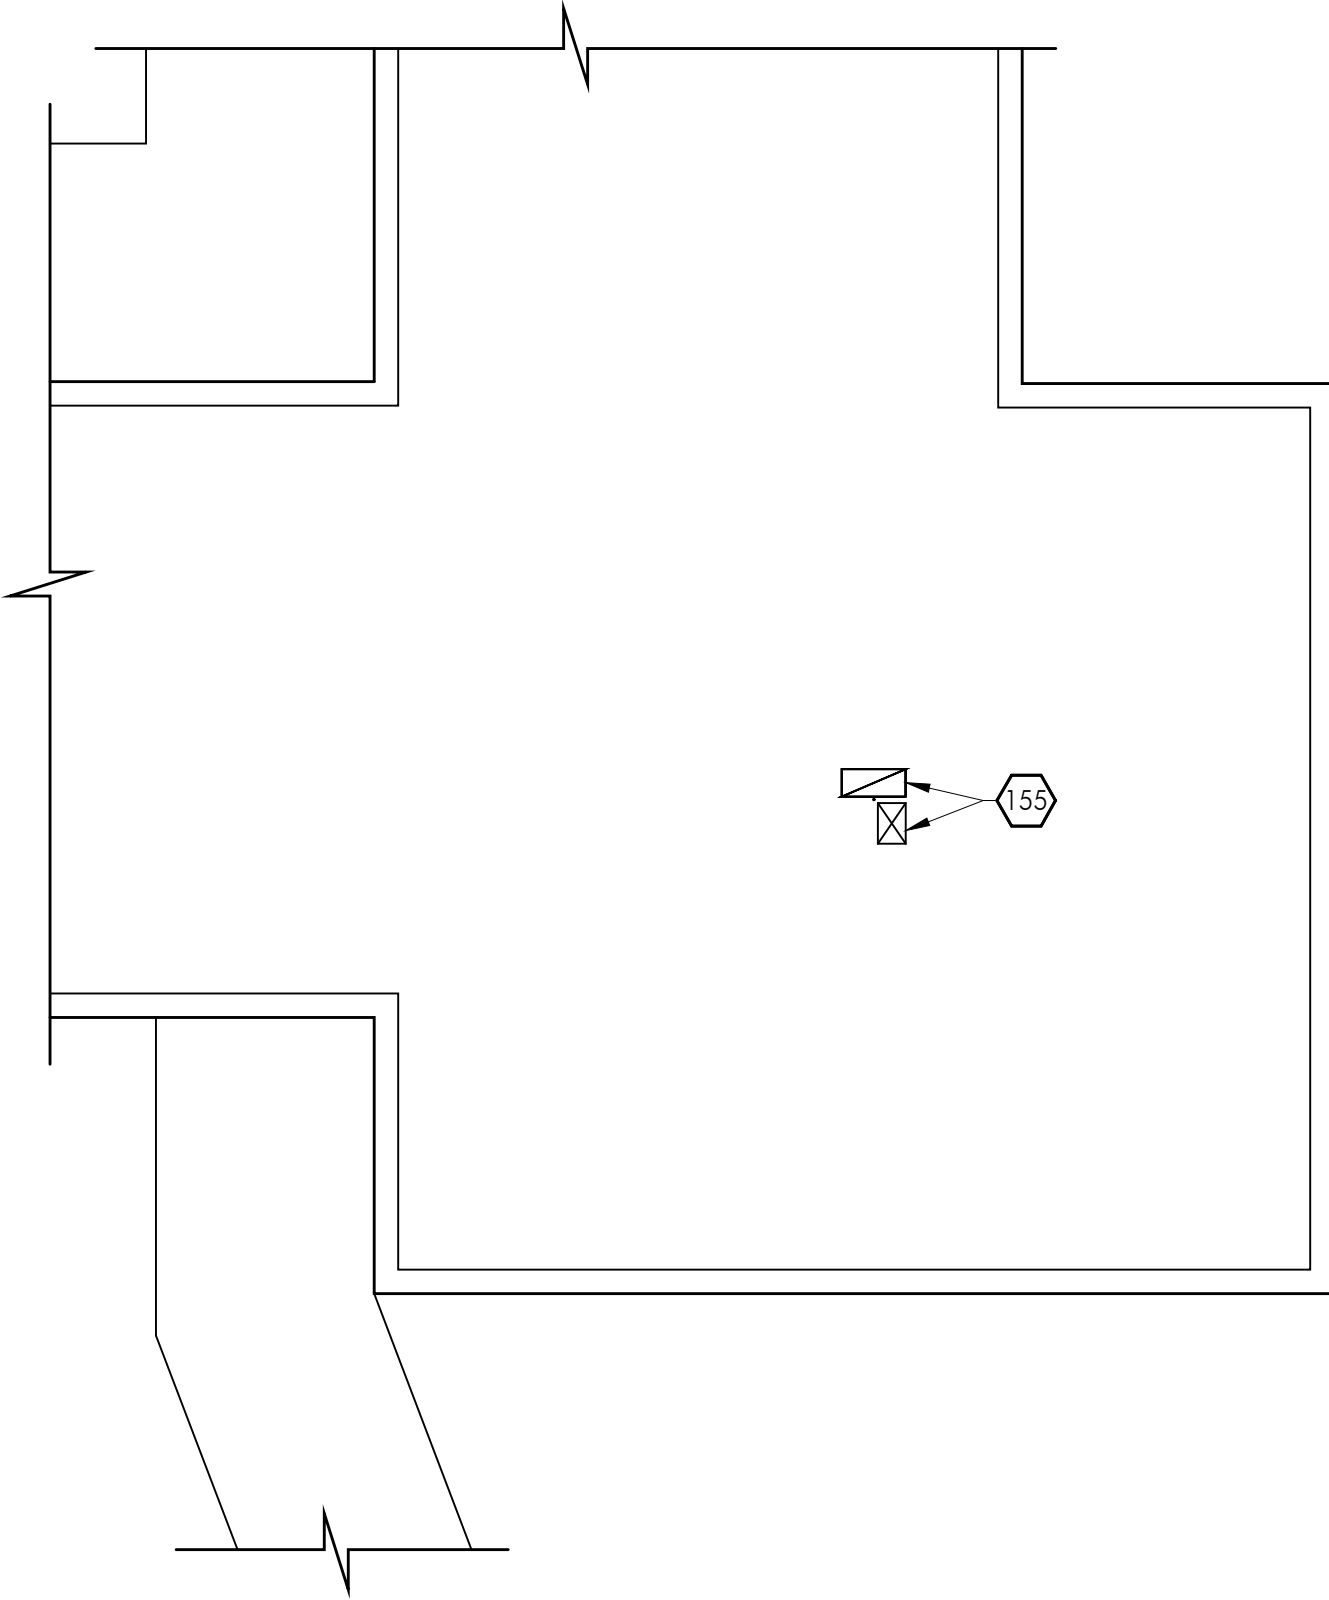

SCALE: 1/8"=1'-0"

FLOOR PLAN GENERAL NOTES


1. REMOVE EXISTING GYPSUM BOARD, TILE AND BACKER BOARD OR PLASTER TO ACCOMMODATE REMOVAL AND REPLACEMENT OF PIPING, ELECTRICAL AND FOR THE INSTALLATION OF SUPPORT BLOCKING AND MECHANICAL EQUIPMENT. PATCH BACK TO MATCH ADJACENT SURFACE.
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4. UNSCHEDULED CUTTING, REMOVING OR TRIMMING OF EXISTING CONCRETE, MASONRY OR WOOD FRAMED WALLS IS NOT PERMITTED UNLESS NOTED OTHERWISE ALL DOORS SHALL BE FITTED WITHIN EXISTING WALL OPENINGS WITHOUT ENLARGING OR TRIMMING HEAD OR JAMBS.

DEMOLITION KEYNOTES

NO.	DESCRIPTION
155	REMOVE PORTION OF (E) CEILING AS REQUIRED FOR INSTALLATION OF NEW DUCTWORK, AND UTILITIES AS OCCURS ABOVE CEILING. REPLACE CEILING TILES, PATCH, REPAIR AND PAINT AT ALL REMOVALS TO MATCH EXISTING ADJACENT.
155	MECHANICAL DUCT PENETRATION AT EXISTING ROOF. SEE MECHANICAL AND DETAIL X/A831 FOR ADDITIONAL INFORMATION.
171	REMOVE EXISTING MECHANICAL REGISTER AND ALL ASSOCIATED ITEMS. PROTECT EXISTING CEILING IN PLACE AND PREPARE FOR NEW WORK. PATCH AND REPAIR AT REMOVAL AND PROVIDE NEW CEILING TILE TO MATCH EXISTING ADJACENT. SEE MECHANICAL FOR ADDITIONAL INFORMATION.

DEMOLITION FLOOR PLAN LEGEND

SYMBOL	DESCRIPTION
	(E) STUD WALL OR PARTITION TO REMAIN.
	(E) STUD WALL OR PARTITION TO BE REMOVED.
	(E) DOOR TO REMAIN. SAND, CLEAN AND PATCH DOOR IN PREPARATION FOR NEW FINISHES.
	REMOVE EXISTING DOOR AND APPURTENANCES. PROTECT EXISTING FRAME IN PLACE U.N.O. CLEAN AND PATCH FRAME IN PREPARATION FOR NEW FINISHES AND DOOR HARDWARE.
	(E) STUD WALL OR PARTITION TO REMAIN.
	(E) STUD WALL OR PARTITION TO BE REMOVED.
	EXISTING SUSPENDED T-BAR CEILING SYSTEM TO REMAIN, UNLESS NOTED OTHERWISE.
	EXISTING GLUE ON ACOUSTIC TILE TO REMAIN, UNLESS NOTED OTHERWISE.
	REMOVE EXISTING LIGHT AND APPURTENANCES. SEE ELECTRICAL FOR MORE INFORMATION.
	EXISTING LIGHT FIXTURE TO REMAIN. SEE ELECTRICAL FOR MORE INFORMATION.

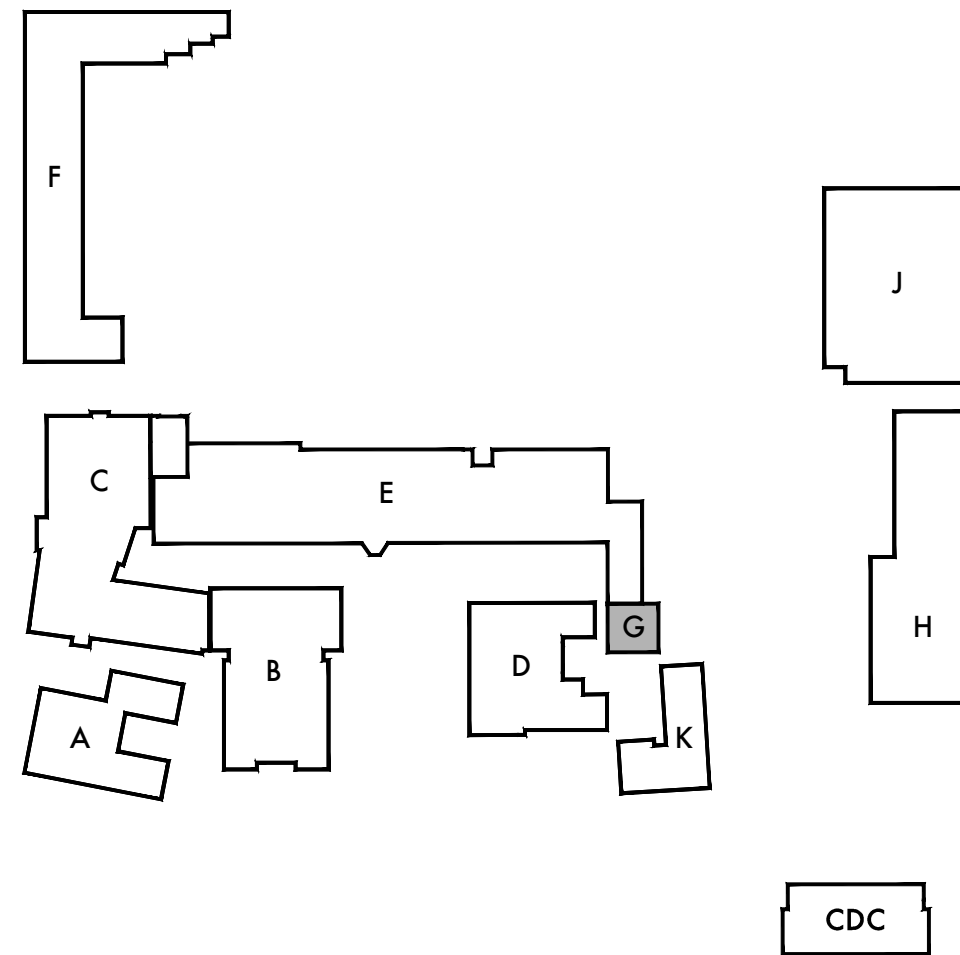

KEY PLAN

APPL. No. A 00-123456

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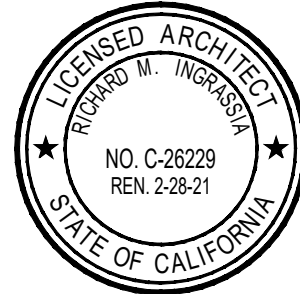
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Lincoln Middle School
1501 California Avenue
Santa Monica, California 90403

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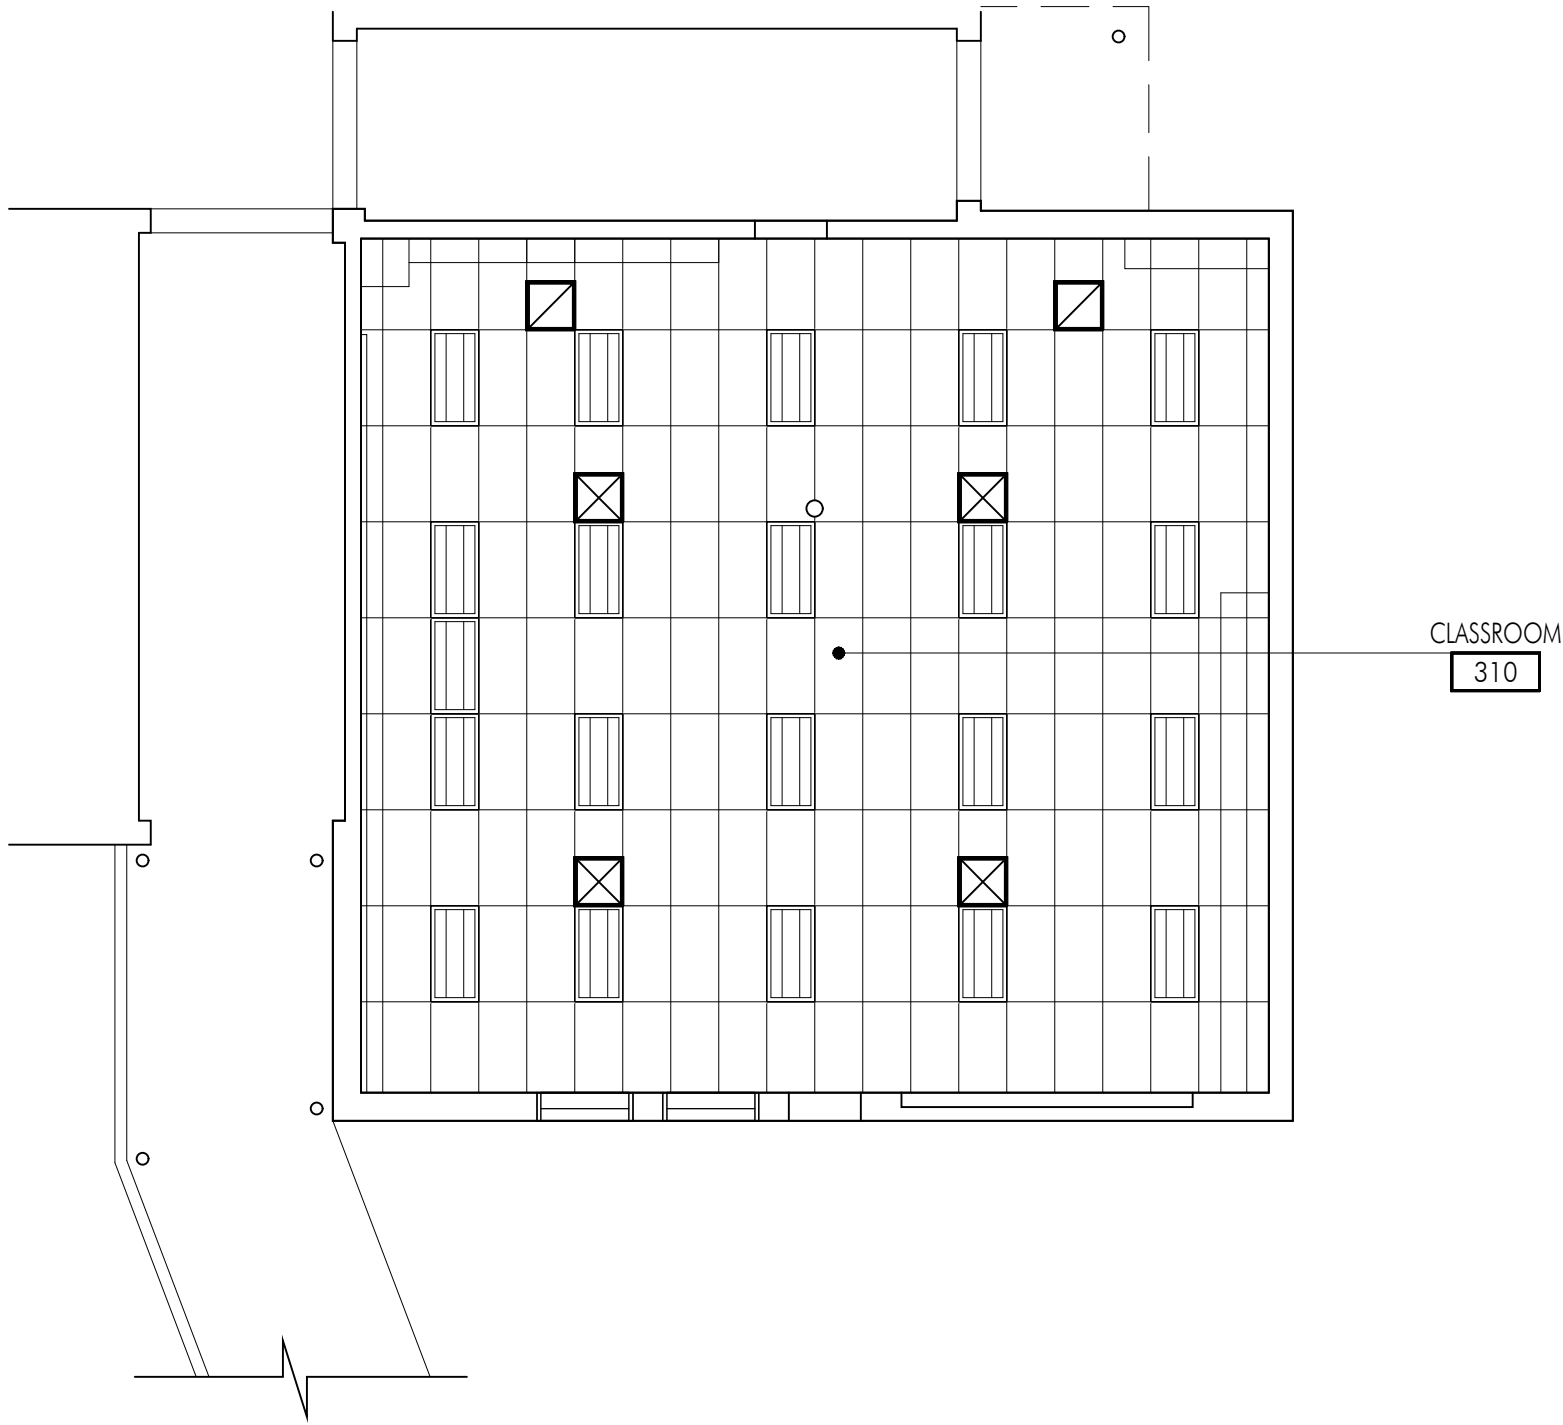
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Building 'G'
Demolition Floor,
Reflected Ceiling and
Roof Plans

Sheet Number

AG201


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2 REFLECTED CEILING PLAN




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1 FLOOR PLAN



SCALE: 1/8"=1'-0"

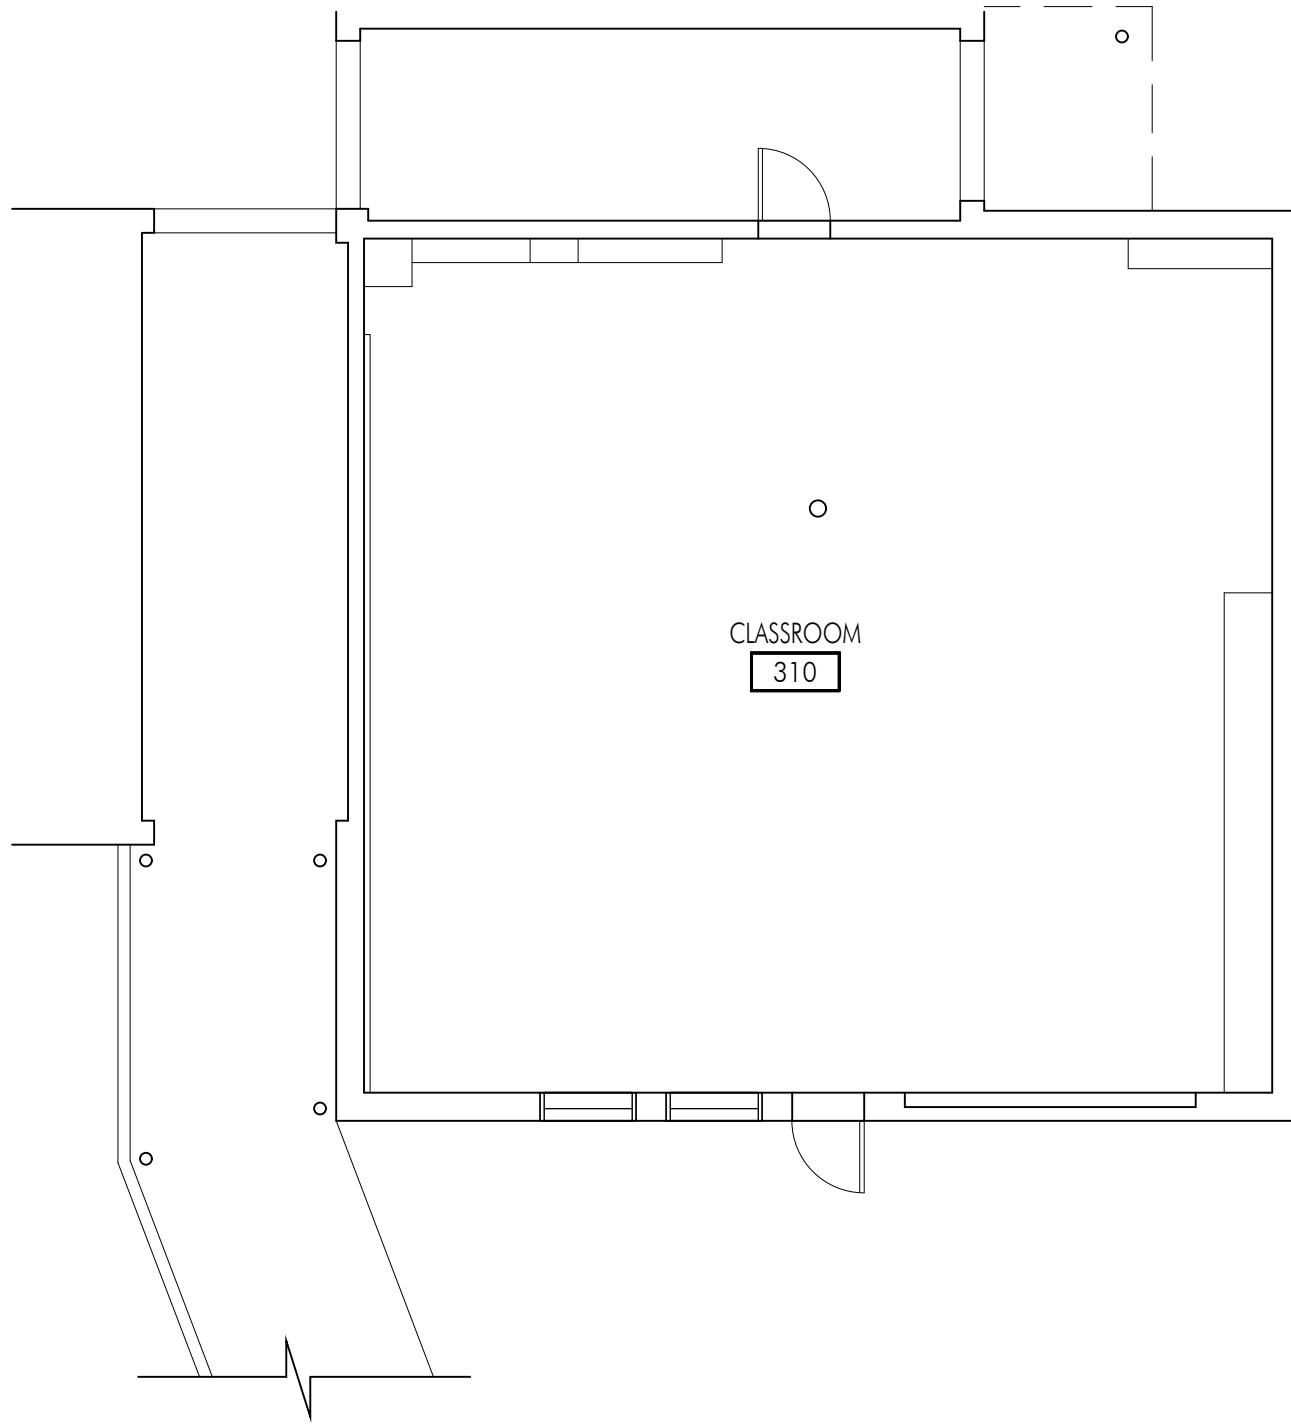3 ROOF PLAN

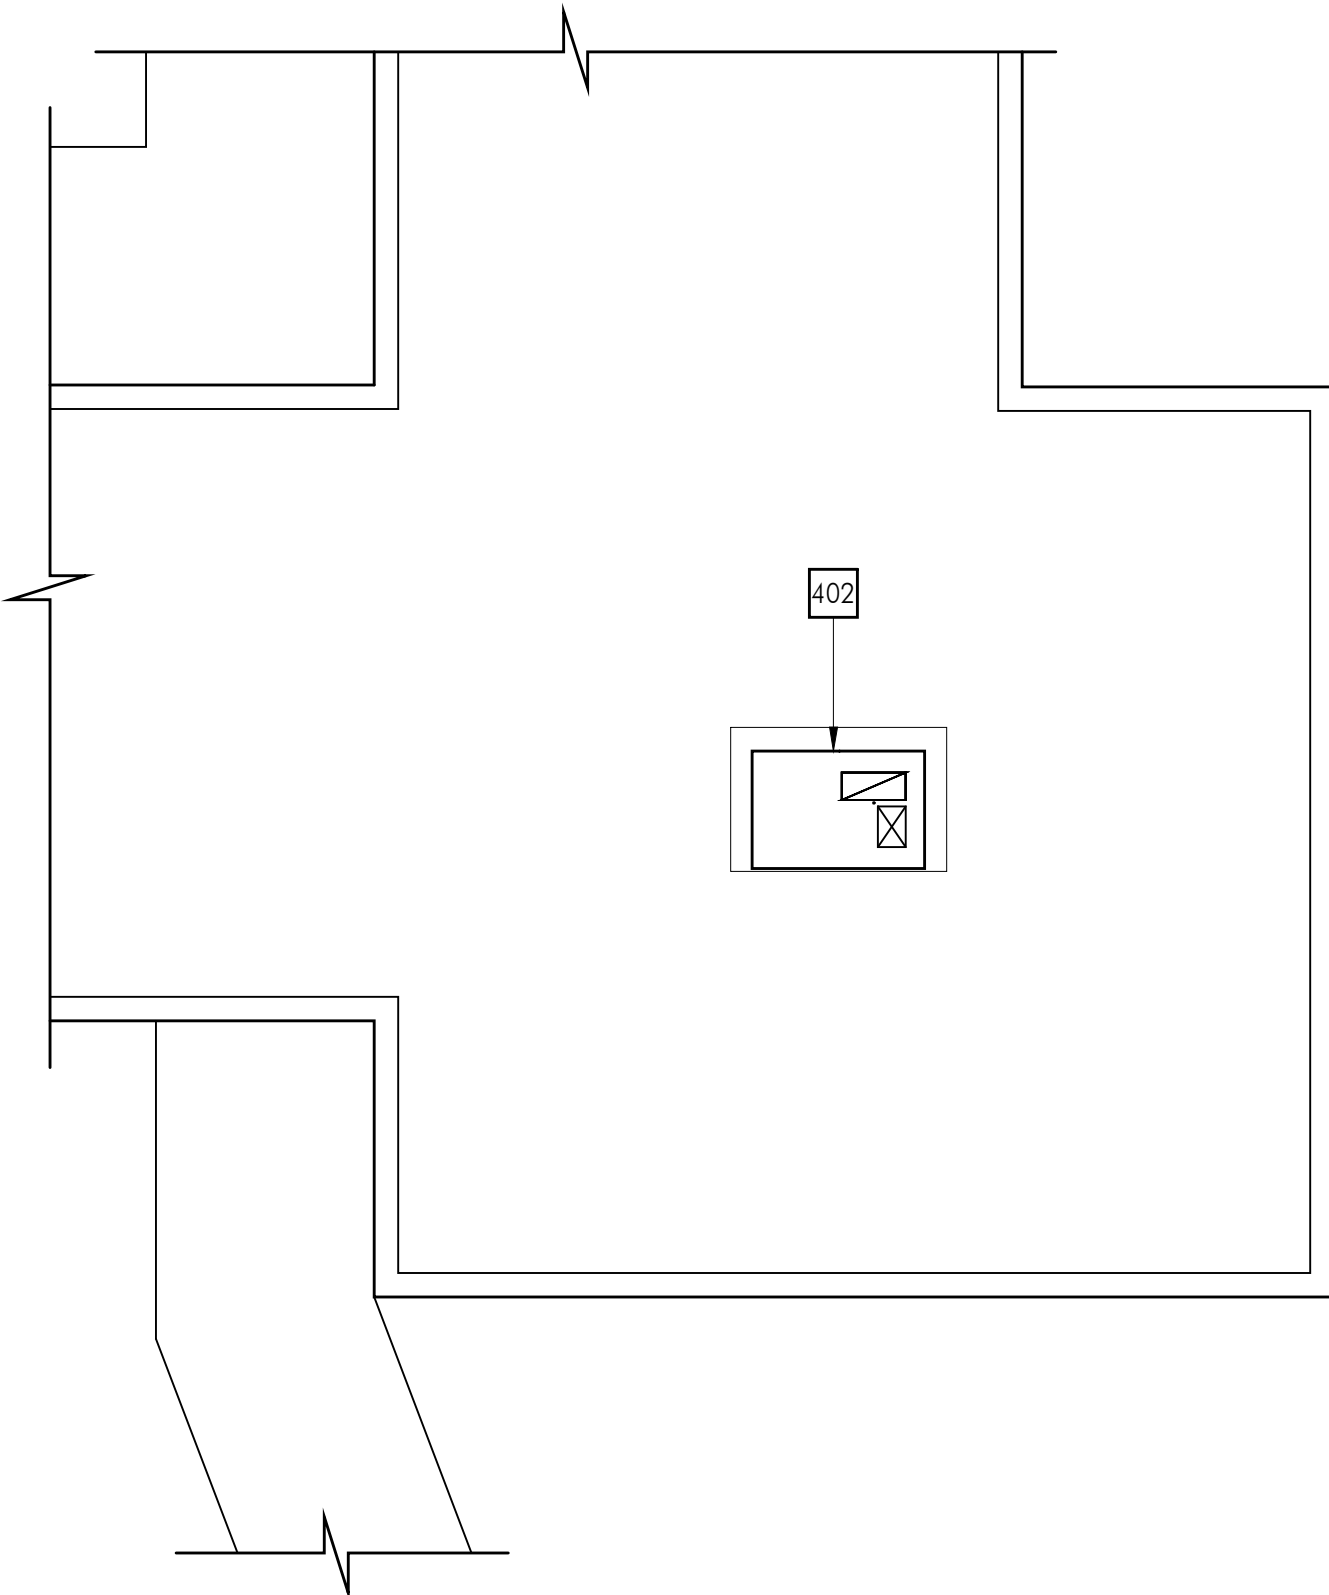

SCALE: 1/8"=1'-0"

FLOOR PLAN GENERAL NOTES


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KEYNOTES

NO.	DESCRIPTION
402	ROOF MOUNTED MECHANICAL UNIT. SEE MECHANICAL AND DETAIL X/A831 FOR ADDITIONAL INFORMATION.

FLOOR PLAN LEGEND

SYMBOL	DESCRIPTION
	(E) WOOD STUD WALL OR PARTITION TO REMAIN.
	METAL STUD WALL ASSEMBLY. REFER TO WALL TYPE AND TYPICAL DETAILS ON A711 FOR MORE INFORMATION.
	NEW DOOR AND FRAME. SEE DOOR SCHEDULE ON A611 FOR MORE INFORMATION.
	WALL TYPE. SEE A711 FOR MORE INFORMATION.
	EXISTING SUSPENDED T-BAR CEILING SYSTEM TO REMAIN, UNLESS NOTED OTHERWISE.
	EXISTING GLUE ON ACOUSTIC TILE TO REMAIN, UNLESS NOTED OTHERWISE.
	EXISTING LIGHT FIXTURE TO REMAIN. SEE ELECTRICAL FOR MORE INFORMATION.
	RELOCATED LIGHT FIXTURE. SEE ELECTRICAL FOR MORE INFORMATION.
	FRAMED GYPSUM BOARD CEILING SEE XXXX FOR ADDITIONAL INFORMATION AND REFERENCED DETAIL ON PLAN FOR SOFFIT CONDITIONS AS OCCURS. PAINT P-1
	AIR SUPPLY REGISTER
	RETURN AIR GRILLE
	EXHAUST GRILLE

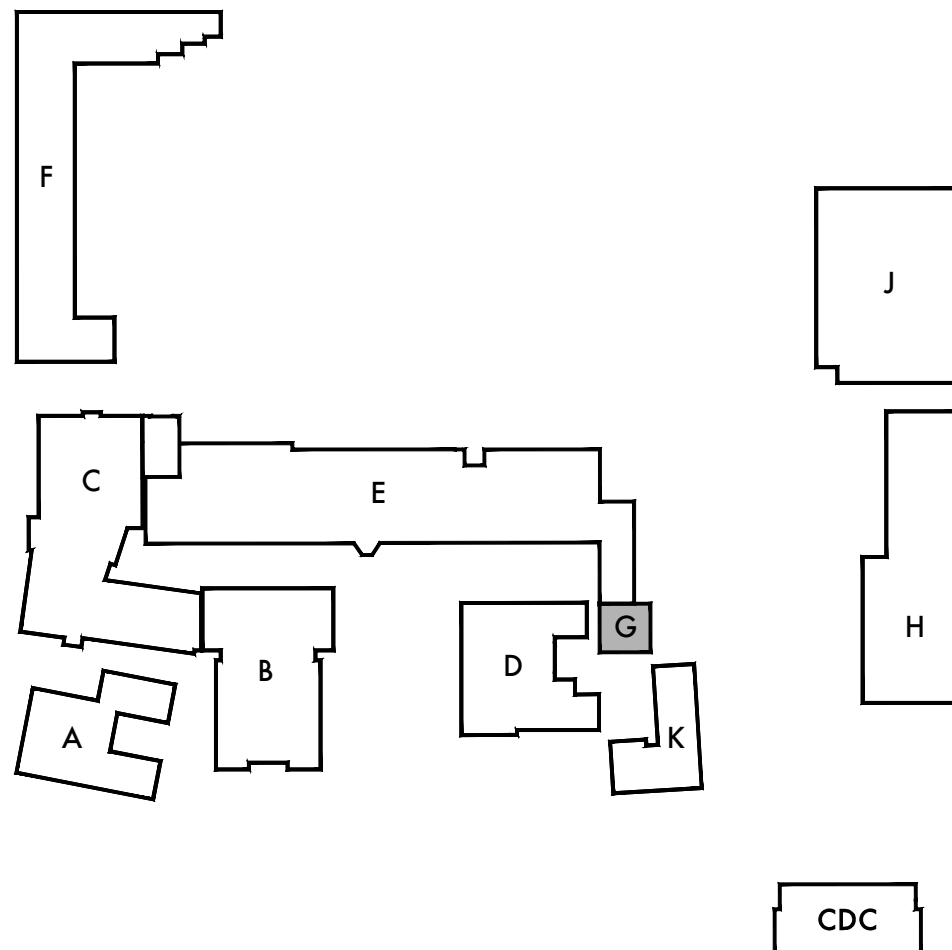

KEY PLAN

APPL. No. A 00-123456

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Architect



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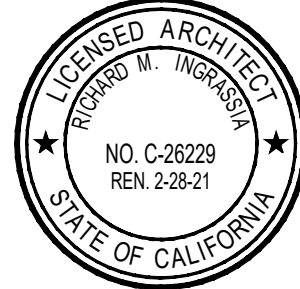
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Sheet Title
Building 'G' Floor,
Reflected Ceiling and
Roof Plans

Sheet Number

AG211

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Architect



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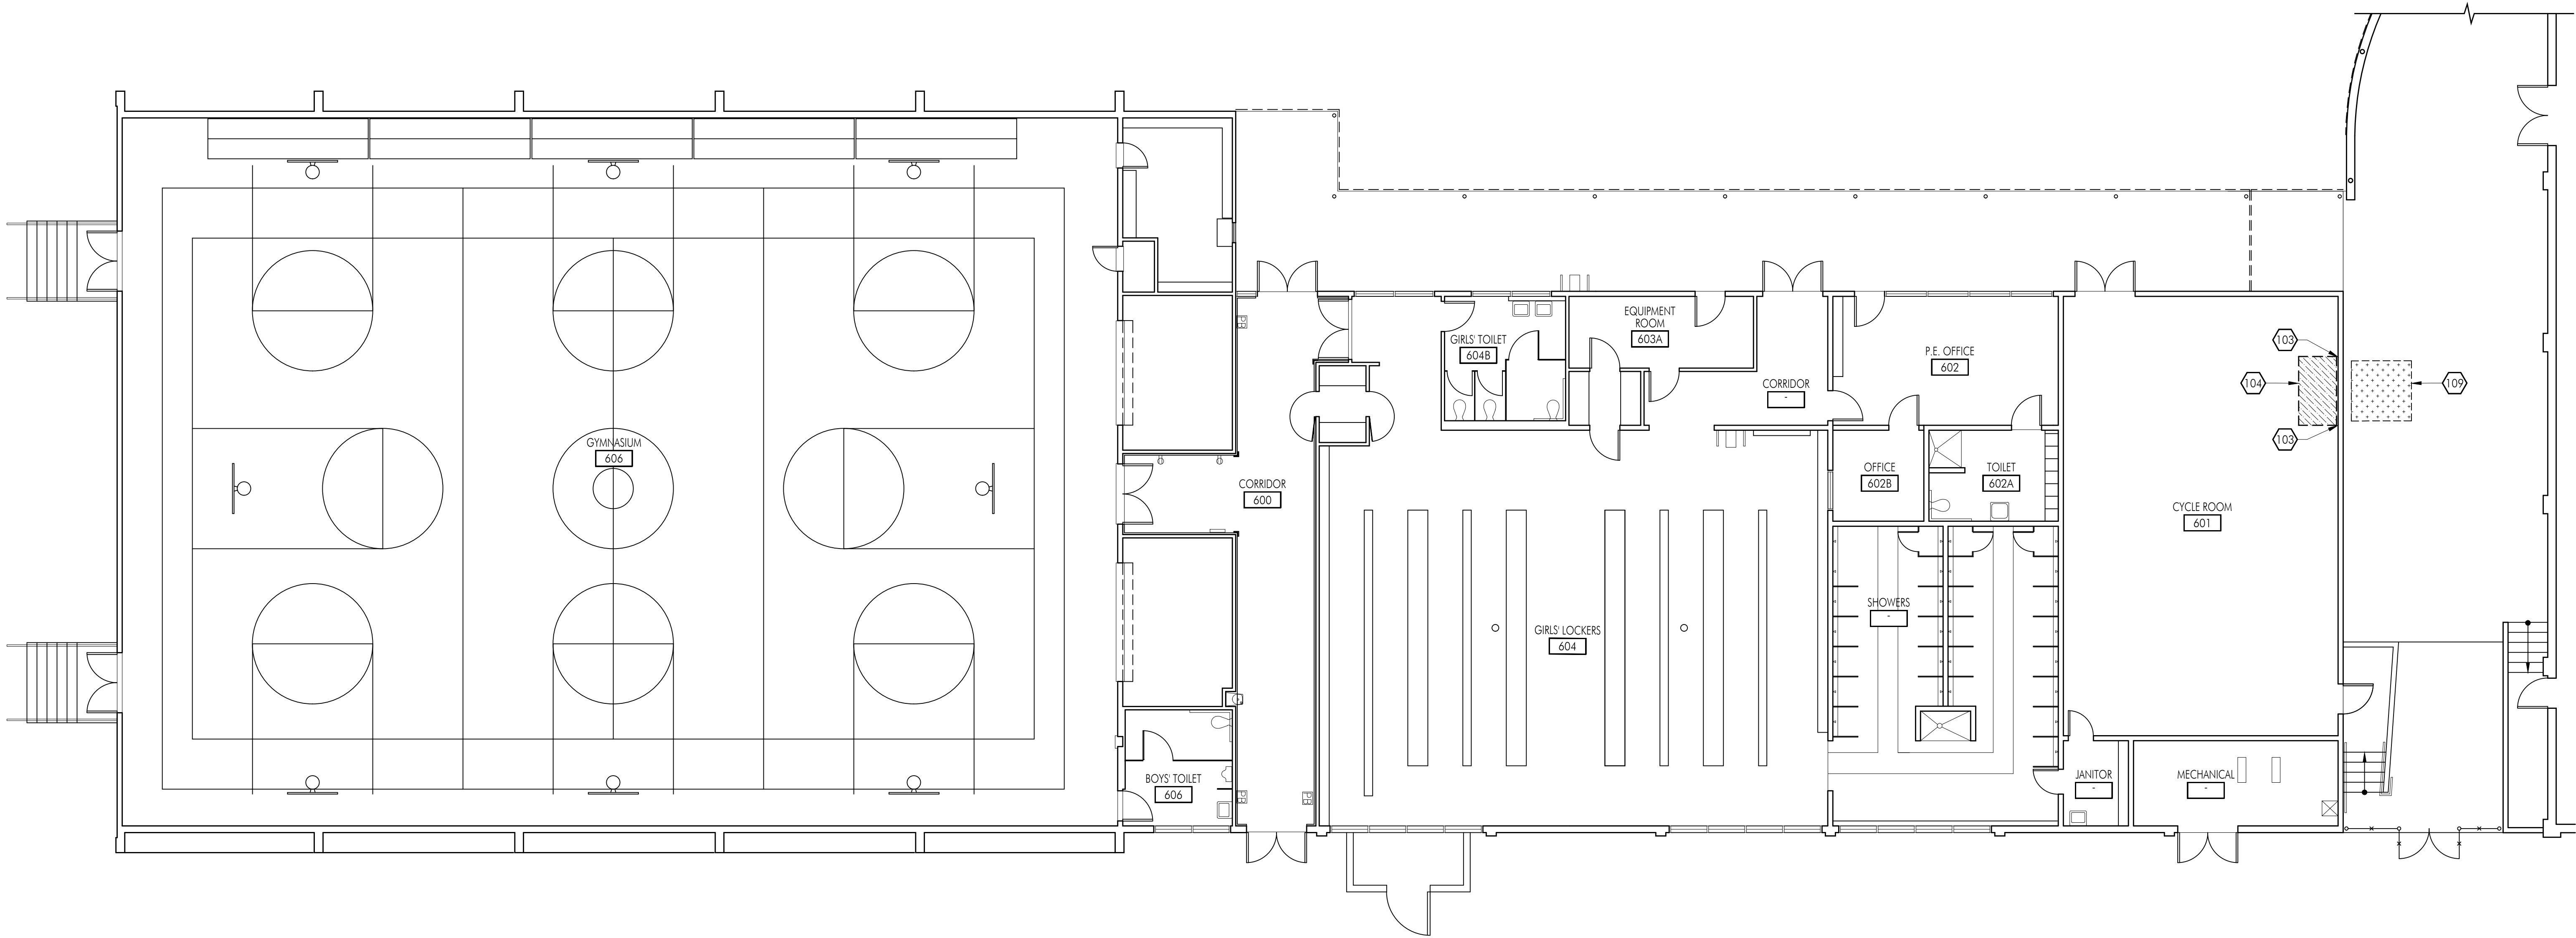


Consultants

Sheet Title
Building 'H'
Demolition Floor Plan

Sheet Number

AH201



1 DEMOLITION FLOOR PLAN

FLOOR PLAN GENERAL NOTES

- REMOVE EXISTING GYPSUM BOARD, TILE AND BACKER BOARD OR PLASTER TO ACCOMMODATE REMOVAL AND REPLACEMENT OF PIPING, ELECTRICAL AND FOR THE INSTALLATION OF SUPPORT BLOCKING AND MECHANICAL EQUIPMENT. PATCH BACK TO MATCH ADJACENT SURFACE.
- REFER TO MECHANICAL, PLUMBING, ELECTRICAL AND FIRE ALARM DRAWINGS FOR ADDITIONAL SCOPE OF WORK IN EACH ROOM.
- ALL WALLS SHALL BE FULL HEIGHT TO THE ROOF DECK UNLESS NOTED OTHERWISE, AND SHALL BE CLOSED AND SEALED PER WALL TYPE AND AS DETAILED ON A711.
- UNSCHEDULED CUTTING, REMOVING OR TRIMMING OF EXISTING CONCRETE, MASONRY OR WOOD FRAMED WALLS IS NOT PERMITTED. UNLESS NOTED OTHERWISE ALL DOORS SHALL BE FITTED WITHIN EXISTING WALL OPENINGS WITHOUT ENLARGING OR TRIMMING HEAD OR JAMBS.

DEMOLITION KEYNOTES


NO.	DESCRIPTION
101	REMOVE EXISTING DOOR AND FRAME. PATCH AND REPAIR ADJACENT WALL AND FLOOR AT REMOVAL AND PREPARE ADJACENT WALL AND FLOOR SURFACES FOR NEW WORK.
102	REMOVE INDICATED PORTION OF EXISTING WALL OR PARTITION. PROTECT ADJACENT UNAFFECTED FINISHES. PATCH AND REPAIR AT REMOVAL AND PREPARE ADJACENT SURFACES FOR NEW WORK.
103	REMOVE EXISTING INTERIOR WALL FINISHES INCLUDING BUT NOT LIMITED TO [SINGULARLY OR IN ANY COMBINATION] PLASTER, GYPSUM BOARD, ACOUSTIC TILE, TACKABLE SURFACE ETC.] DOWN TO STUDS (OR STRUCTURE AS OCCURS) IN PREPARATION FOR INSTALLATION OF NEW WALL AND FINISHES. PROTECT ADJACENT UNAFFECTED FINISHES. PATCH AND REPAIR AT REMOVAL AND PREPARE ADJACENT SURFACES FOR NEW WORK.
104	REMOVE PORTION OF EXISTING FLOOR AS REQUIRED FOR INSTALLATION OF NEW MECHANICAL CLOSET FRAMING AND EQUIPMENT. PATCH AND REPAIR AT REMOVAL AND PREPARE ADJACENT SURFACES FOR NEW WORK.
105	REMOVE PORTION OF EXISTING TACK BOARD (OR MARKER BOARD AS OCCURS) AS REQUIRED FOR INSTALLATION NEW WORK. TACK BOARD SHALL BE CUT IN A STRAIGHT LINE. PROTECT REMAINING TACK BOARD IN PLACE AND PROVIDE NEW TRIM TO MATCH EXISTING TRIM AT CUT EDGE.
106	REMOVE AND PROTECT EXISTING TACK BOARD (OR WHITE BOARD AS OCCURS) FOR RELOCATION IN SAME ROOM. SEE FLOOR PLAN FOR NEW LOCATION. TURN OVER TO DISTRICT WHERE NO NEW LOCATION IS AVAILABLE.
107	REMOVE EXISTING CONTROL CABINET AND ALL ASSOCIATED ITEMS INCLUDING CONDUIT AND. PROTECT EXISTING CONTROL CABINET FOR RELOCATION IN SAME ROOM AS SHOWN ON PLAN. REROUTE ALL EXISTING POWER AND DATA TO NEW LOCATION. SEE ELECTRICAL FOR MORE INFORMATION.
108	REMOVE INDICATED PORTION OF EXISTING WALL AT AN ELEVATION OF +10'-6" IN PREPARATION FOR NEW DUCT PENETRATION AND MECHANICAL REGISTER. SEE MECHANICAL FOR ADDITIONAL INFORMATION. [REVIEW LOCATION

DEMOLITION KEYNOTES

NO.	DESCRIPTION
120	REMOVE EXISTING MECHANICAL EQUIPMENT AND APPURTENANCES. SEE MECHANICAL, ELECTRICAL AND PLUMBING DRAWINGS FOR ADDITIONAL INFORMATION.
121	EXISTING MECHANICAL SOFFIT TO BE REUSED. REMOVE PORTIONS OF EXISTING PLASTER OR GYPSUM BOARD FINISH AS REQUIRED TO PERFORM NEW WORK. PATCH AND REPAIR AT REMOVAL TO MATCH EXISTING ADJACENT FINISH.
122	PROTECT EXISTING DUCT IN PLACE TO BE REUSED. SEE MECHANICAL FOR ADDITIONAL INFORMATION.
123	REMOVE EXISTING RADIATOR AND ALL ASSOCIATED PIPING. SEE MECHANICAL FOR ADDITIONAL INFORMATION. PATCH AND REPAIR AT REMOVAL TO MATCH EXISTING ADJACENT FINISH.
124	REMOVE EXISTING WALL MOUNTED MECHANICAL REGISTER AND ALL ASSOCIATED ITEMS. PREPARE EXISTING OPENING FOR NEW REGISTER AND DUCT AT SAME LOCATION. SEE MECHANICAL FOR ADDITIONAL INFORMATION.

DEMOLITION FLOOR PLAN LEGEND

SYMBOL	DESCRIPTION
	(E) STUD WALL OR PARTITION TO REMAIN.
	(E) STUD WALL OR PARTITION TO BE REMOVED.
	(E) DOOR TO REMAIN. SAND, CLEAN AND PATCH DOOR IN PREPARATION FOR NEW FINISHES.
	REMOVE EXISTING DOOR AND APPURTENANCES. PROTECT EXISTING FRAME IN PLACE U.N.O. CLEAN AND PATCH FRAME IN PREPARATION FOR NEW FINISHES AND DOOR HARDWARE.

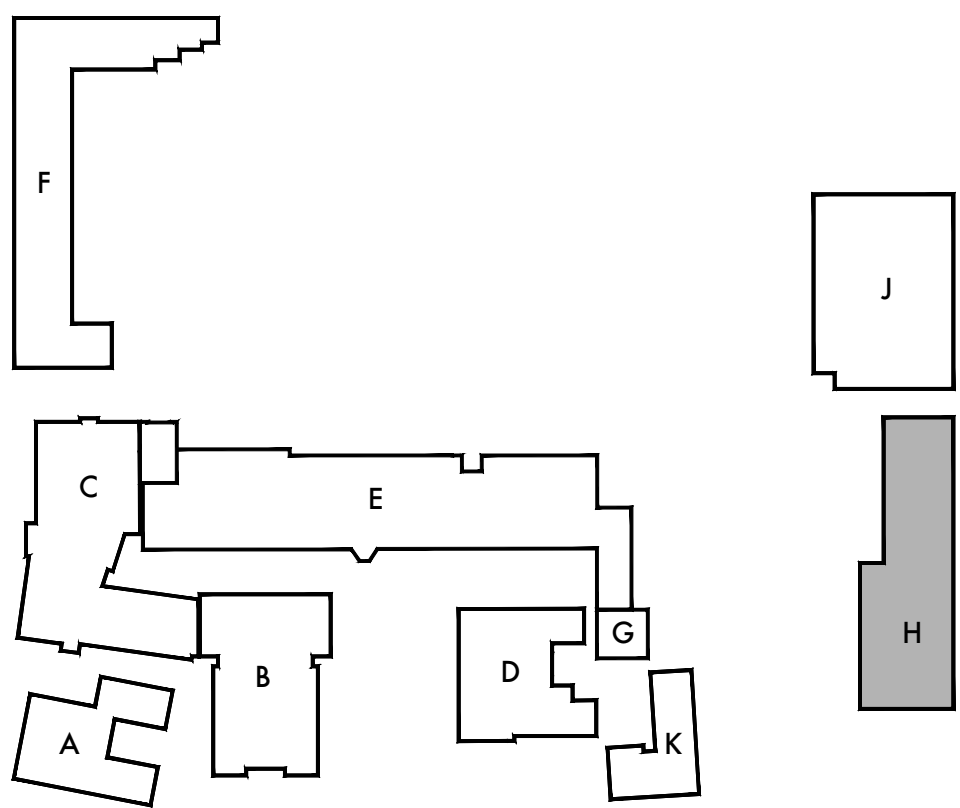

KEY PLAN

DSA Stamp

Architect



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Lincoln Middle School HVAC Replacement Project
Lincoln Middle School
1501 California Avenue
Santa Monica, California 90403

Rev	Date	Issue
1	11.27.19	50% CD's



SCALE: 1/8"=1'-0"

Date: 11.27.2019
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Checked By: RL

Architect / Engineer Stamp



Consultants

Sheet Title

Building 'H'
Demolition Reflected
Ceiling Plan

Sheet Number

AH202

1 DEMOLITION RFLECTED CEILING PLAN

FLOOR PLAN GENERAL NOTES


- REMOVE EXISTING GYPSUM BOARD, TILE AND BACKER BOARD OR PLASTER TO ACCOMMODATE REMOVAL AND REPLACEMENT OF PIPING, ELECTRICAL AND FOR THE INSTALLATION OF SUPPORT BLOCKING AND MECHANICAL EQUIPMENT. PATCH BACK TO MATCH ADJACENT SURFACE.
- REFER TO MECHANICAL, PLUMBING, ELECTRICAL AND FIRE ALARM DRAWINGS FOR ADDITIONAL SCOPE OF WORK IN EACH ROOM.
- ALL WALLS SHALL BE FULL HEIGHT TO THE ROOF DECK UNLESS NOTED OTHERWISE, AND SHALL BE CLOSED AND SEALED PER WALL TYPE AND AS DETAILED ON A711.
- UNSCHEDULED CUTTING, REMOVING OR TRIMMING OF EXISTING CONCRETE, MASONRY OR WOOD FRAMED WALLS IS NOT PERMITTED. UNLESS NOTED OTHERWISE ALL DOORS SHALL BE FITTED WITHIN EXISTING WALL OPENINGS WITHOUT ENLARGING OR TRIMMING HEAD OR JAMBS.

DEMOLITION KEYNOTES

NO.	DESCRIPTION
(151)	REMOVE PORTION OF (E) CEILING AS REQUIRED FOR INSTALLATION OF NEW DUCTWORK, AND UTILITIES AS OCCURS ABOVE CEILING. REPLACE CEILING TILES, PATCH, REPAIR AND PAINT AT ALL REMOVALS TO MATCH EXISTING ADJACENT.
(152)	REMOVE PORTION OF (E) CEILING TILES AND SUSPENDED T-BAR SYSTEM IN PREPARATION OF NEW SOFFIT. PROTECT EXISTING ADJACENT CEILING AND MODIFY AS REQUIRED FOR TRANSITION TO NEW WORK AND FINISHES.
(153)	REMOVE PORTION OF (E) CEILING AS REQUIRED FOR INSTALLATION OF NEW MECHANICAL CLOSET, MECHANICAL EQUIPMENT AND ALL ASSOCIATED DUCTWORK AND APPURTENANCES. PATCH REPAIR AND PAINT AT ALL REMOVALS TO MATCH EXISTING ADJACENT FINISHES AND IN PREPARATION FOR NEW WORK.
(154)	EXISTING MECHANICAL DUCT TO REMAIN. PROTECT IN PLACE TO BE REUSED AND CONNECT TO NEW EQUIPMENT. SEE MECHANICAL FOR ADDITIONAL INFORMATION.
(155)	MECHANICAL DUCT PENETRATION AT EXISTING ROOF. SEE MECHANICAL AND DETAIL X/A831 FOR ADDITIONAL INFORMATION.
(156)	REMOVE PORTION OF (E) CEILING TILES AND SUSPENDED T-BAR SYSTEM IN PREPARATION OF NEW MECHANICAL UNIT, DUCT OR REGISTER. PROTECT EXISTING ADJACENT CEILING AND MODIFY AS REQUIRED FOR TRANSITION TO NEW WORK AND FINISHES. SEE MECHANICAL FOR ADDITIONAL INFORMATION.
(157)	REMOVE PORTION OF (E) GYPSUM BOARD OR PLASTER CEILING IN PREPARATION OF NEW MECHANICAL EQUIPMENT. PROTECT EXISTING ADJACENT CEILING AND MODIFY AS REQUIRED FOR TRANSITION TO NEW WORK AND FINISHES. SEE MECHANICAL FOR ADDITIONAL INFORMATION.

DEMOLITION FLOOR PLAN LEGEND

SYMBOL	DESCRIPTION
	(E) STUD WALL OR PARTITION TO REMAIN.
	(E) STUD WALL OR PARTITION TO BE REMOVED.
	EXISTING SUSPENDED T-BAR CEILING SYSTEM TO REMAIN, UNLESS NOTED OTHERWISE.
	EXISTING GLUE ON ACOUSTIC TILE TO REMAIN, UNLESS NOTED OTHERWISE.
	REMOVE EXISTING LIGHT AND APPURTENANCES. SEE ELECTRICAL FOR MORE INFORMATION
	EXISTING LIGHT FIXTURE TO REMAIN. SEE ELECTRICAL FOR MORE INFORMATION

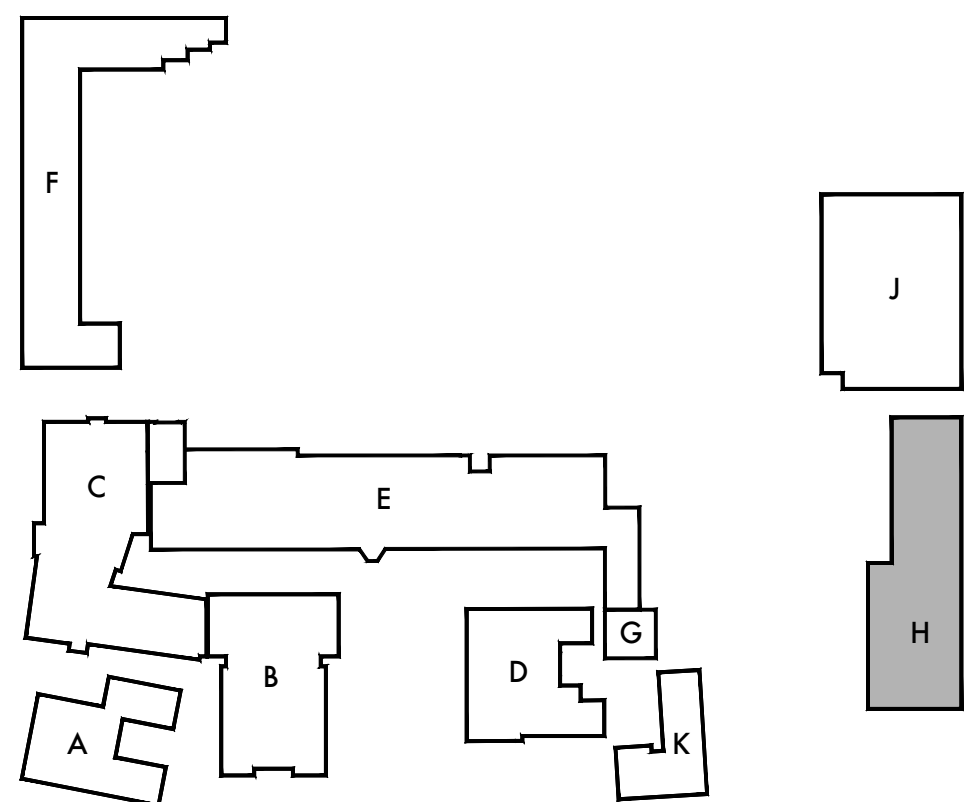

KEY PLAN

DSA Stamp

Architect



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Lincoln Middle School
1501 California Avenue
Santa Monica, California 90403

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Architect / Engineer Stamp




Consultants

Sheet Title
Building 'H' Floor Plan

Sheet Number

AH211

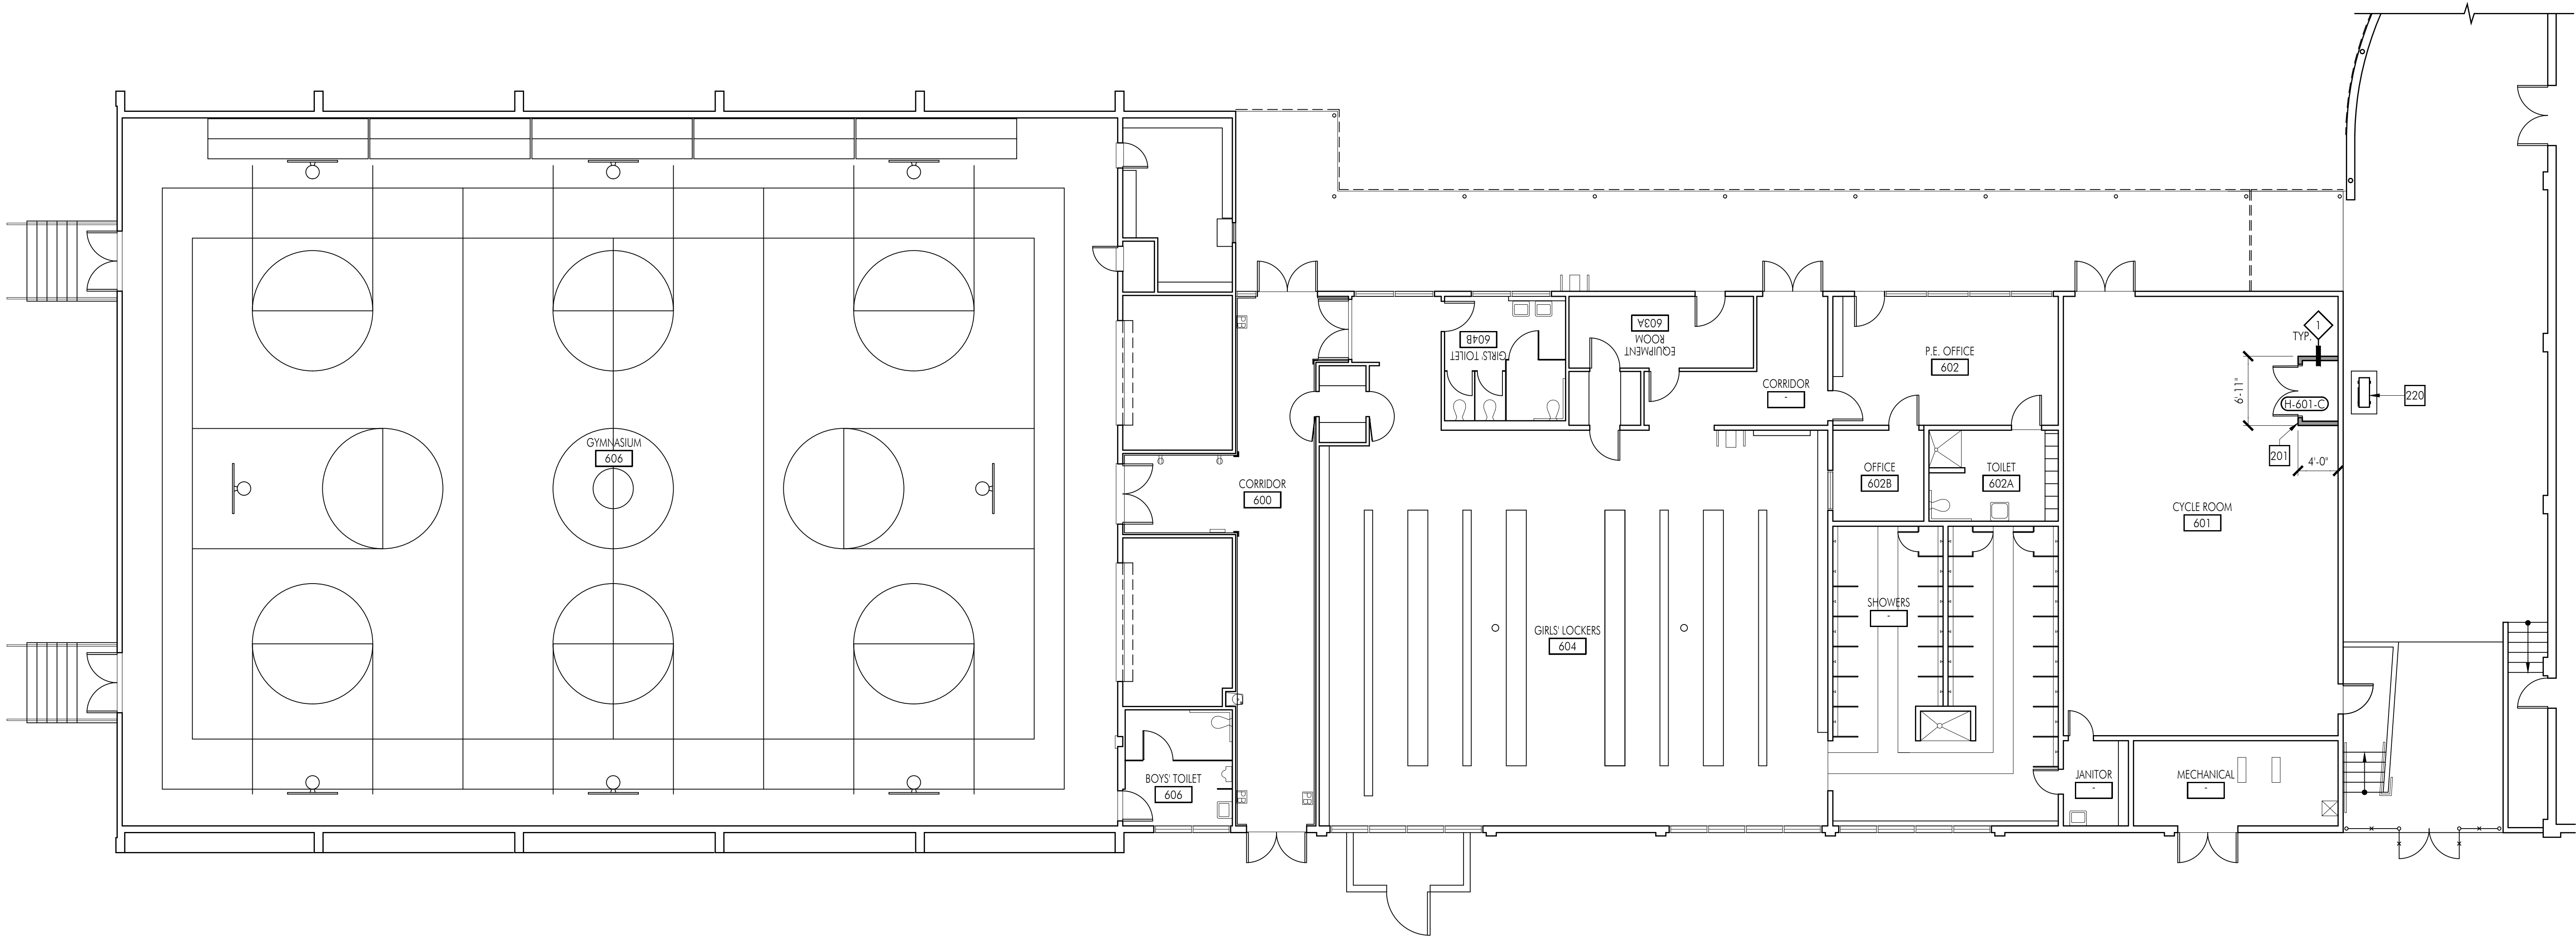

1 FLOOR PLAN

FLOOR PLAN GENERAL NOTES


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KEYNOTES

NO.	DESCRIPTION
201	MECHANICAL CLOSET SEE WALL TYPE AS REFERENCED AND PLAN FOR DIMENSIONS. SEE MECHANICAL DRAWINGS FOR MORE INFORMATION
220	MECHANICAL CONDENSER UNIT ON CONCRETE PAD. PROVIDE CONCRETE PAD AS REQUIRED FOR NUMBER OF CONDENSER UNITS AT EACH LOCATION. SEE MECHANICAL AND DETAIL X/A811 FOR ADDITIONAL INFORMATION.

FLOOR PLAN LEGEND

SYMBOL	DESCRIPTION
(E)	WOOD STUD WALL OR PARTITION TO REMAIN.
[Hatched Box]	METAL STUD WALL ASSEMBLY. REFER TO WALL TYPE AND TYPICAL DETAILS ON A711 FOR MORE INFORMATION
[Door Symbol]	NEW DOOR AND FRAME. SEE DOOR SCHEDULE ON A611 FOR MORE INFORMATION
[Diamond Symbol]	WALL TYPE. SEE A711 FOR MORE INFORMATION.

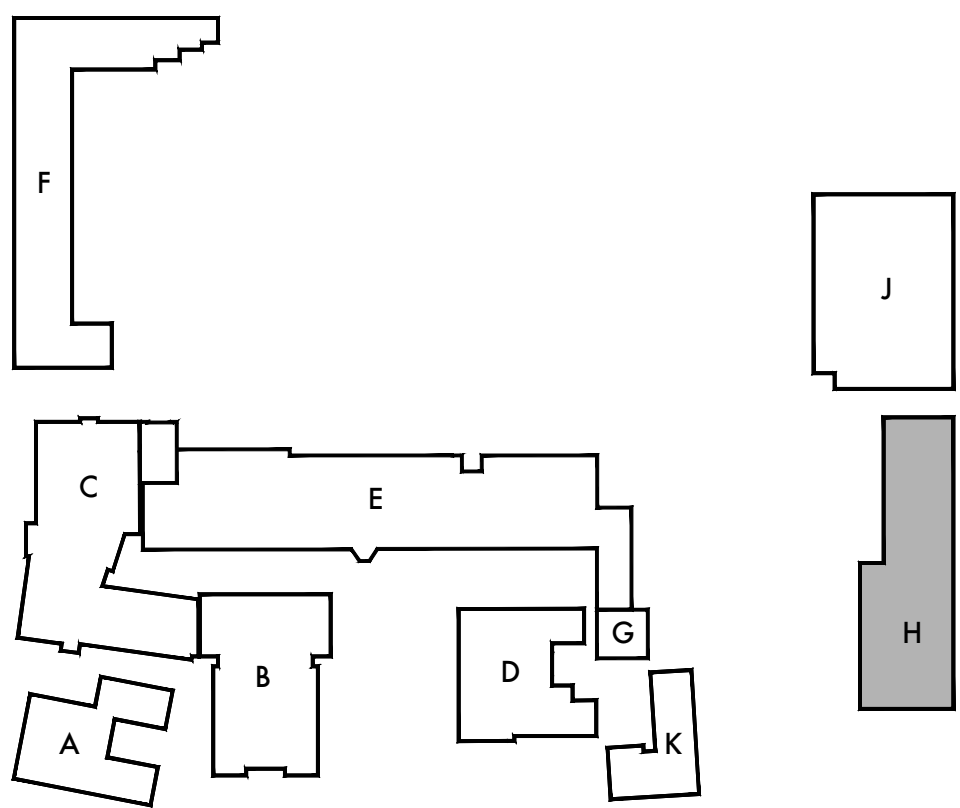

KEY PLAN

DSA Stamp

Architect



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Lincoln Middle School
1501 California Avenue
Santa Monica, California 90403


Rev	Date	Issue
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SCALE: 1/8"=1'-0"

Date: 11.27.2019
Scale: As Shown
Drawn By: DH, RM
Checked By: RI

Architect / Engineer Stamp



Consultants

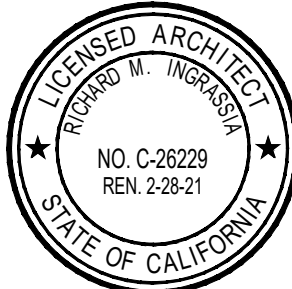Sheet Title
Building 'H' Reflected Ceiling Plan

Sheet Number

AH231

1 RFLECTED CEILING PLAN

FLOOR PLAN GENERAL NOTES


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KEYNOTES

NO.	DESCRIPTION
320	EXISTING MECHANICAL DUCT TO REMAIN, PROTECT IN PLACE TO BE REUSED AND CONNECT TO NEW EQUIPMENT. SEE MECHANICAL FOR ADDITIONAL INFORMATION.
321	EXPOSED DUCT. SEE MECHANICAL FOR MORE INFORMATION.
401	MECHANICAL DUCT PENETRATION AT EXISTING ROOF. SEE MECHANICAL AND DETAIL X/AB31 FOR ADDITIONAL INFORMATION.

FLOOR PLAN LEGEND

SYMBOL	DESCRIPTION
	(E) WOOD STUD WALL OR PARTITION TO REMAIN.
	METAL STUD WALL ASSEMBLY. REFER TO WALL TYPE AND TYPICAL DETAILS ON A711 FOR MORE INFORMATION.
	EXISTING SUSPENDED T-BAR CEILING SYSTEM TO REMAIN, UNLESS NOTED OTHERWISE.
	EXISTING GLUE ON ACOUSTIC TILE TO REMAIN, UNLESS NOTED OTHERWISE.
	EXISTING LIGHT FIXTURE TO REMAIN. SEE ELECTRICAL FOR MORE INFORMATION.
	RELOCATED LIGHT FIXTURE. SEE ELECTRICAL FOR MORE INFORMATION.
	FRAMED GYPSUM BOARD CEILING SEE XXXX FOR ADDITIONAL INFORMATION AND REFERENCED DETAIL ON PLAN FOR SOFFIT CONDITIONS AS OCCURS. PAINT P-1.
	AIR SUPPLY REGISTER
	RETURN AIR GRILLE
	EXHAUST GRILLE

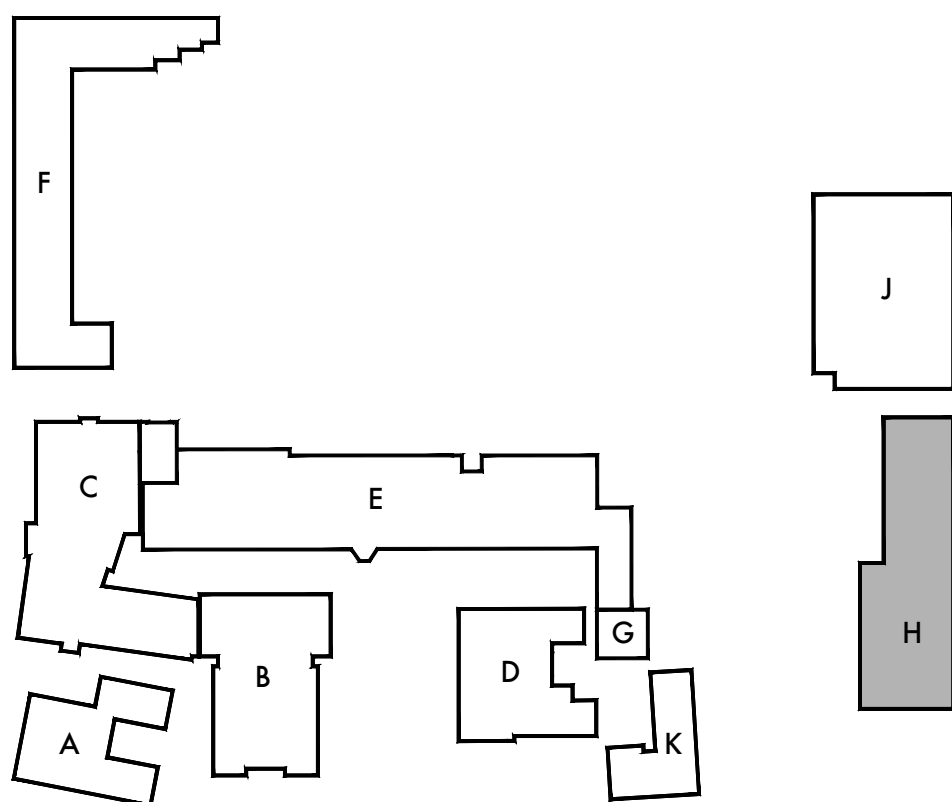

KEY PLAN

DSA Stamp

Architect



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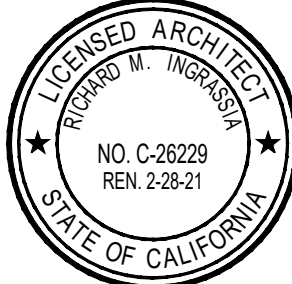
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Consultants

Sheet Title
Building 'H' Roof Plan

Sheet Number

AH241


1 ROOF PLAN

FLOOR PLAN GENERAL NOTES

- REMOVE EXISTING GYPSUM BOARD, TILE AND BACKER BOARD OR PLASTER TO ACCOMMODATE REMOVAL AND REPLACEMENT OF PIPING, ELECTRICAL AND FOR THE INSTALLATION OF SUPPORT BLOCKING AND MECHANICAL EQUIPMENT. PATCH BACK TO MATCH ADJACENT SURFACE.
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KEYNOTES

NO.	DESCRIPTION
400	ROOF MOUNTED MECHANICAL CONDENSER UNIT ON WOOD PAD. SEE PLAN FOR ROUGH DIMENSIONS, ADJUST PAD SIZE FOR NUMBER OF CONDENSERS AND REQUIRED CLEARANCES. SEE MECHANICAL AND DETAIL X/A831 FOR ADDITIONAL INFORMATION.
401	MECHANICAL DUCT PENETRATION AT EXISTING ROOF. SEE MECHANICAL AND DETAIL X/A831 FOR ADDITIONAL INFORMATION.
402	ROOF MOUNTED MECHANICAL UNIT. SEE MECHANICAL AND DETAIL X/A831 FOR ADDITIONAL INFORMATION.
403	ROOF MOUNTED MECHANICAL DUCT. SEE MECHANICAL AND DETAIL X/A831 FOR ADDITIONAL INFORMATION.
404	ROOF MOUNTED EXHAUST FAN. SEE MECHANICAL AND DETAIL X/A831 FOR ADDITIONAL INFORMATION.

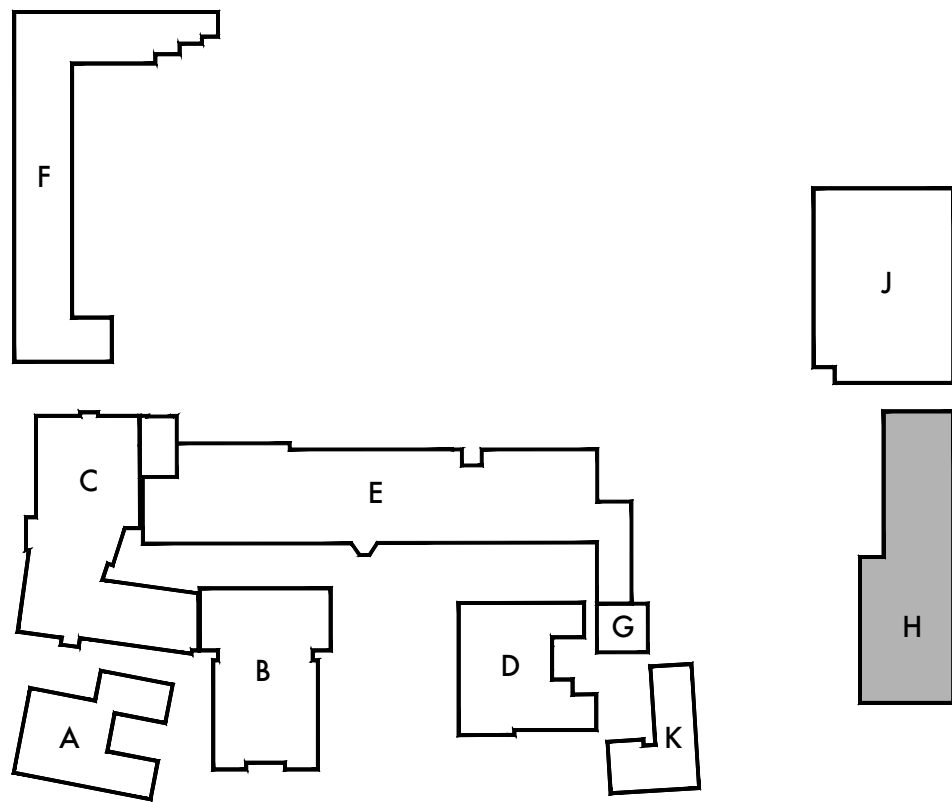



KEY PLAN



SCALE: 1/8"=1'-0"



SCALE: 1/8"=1'-0"

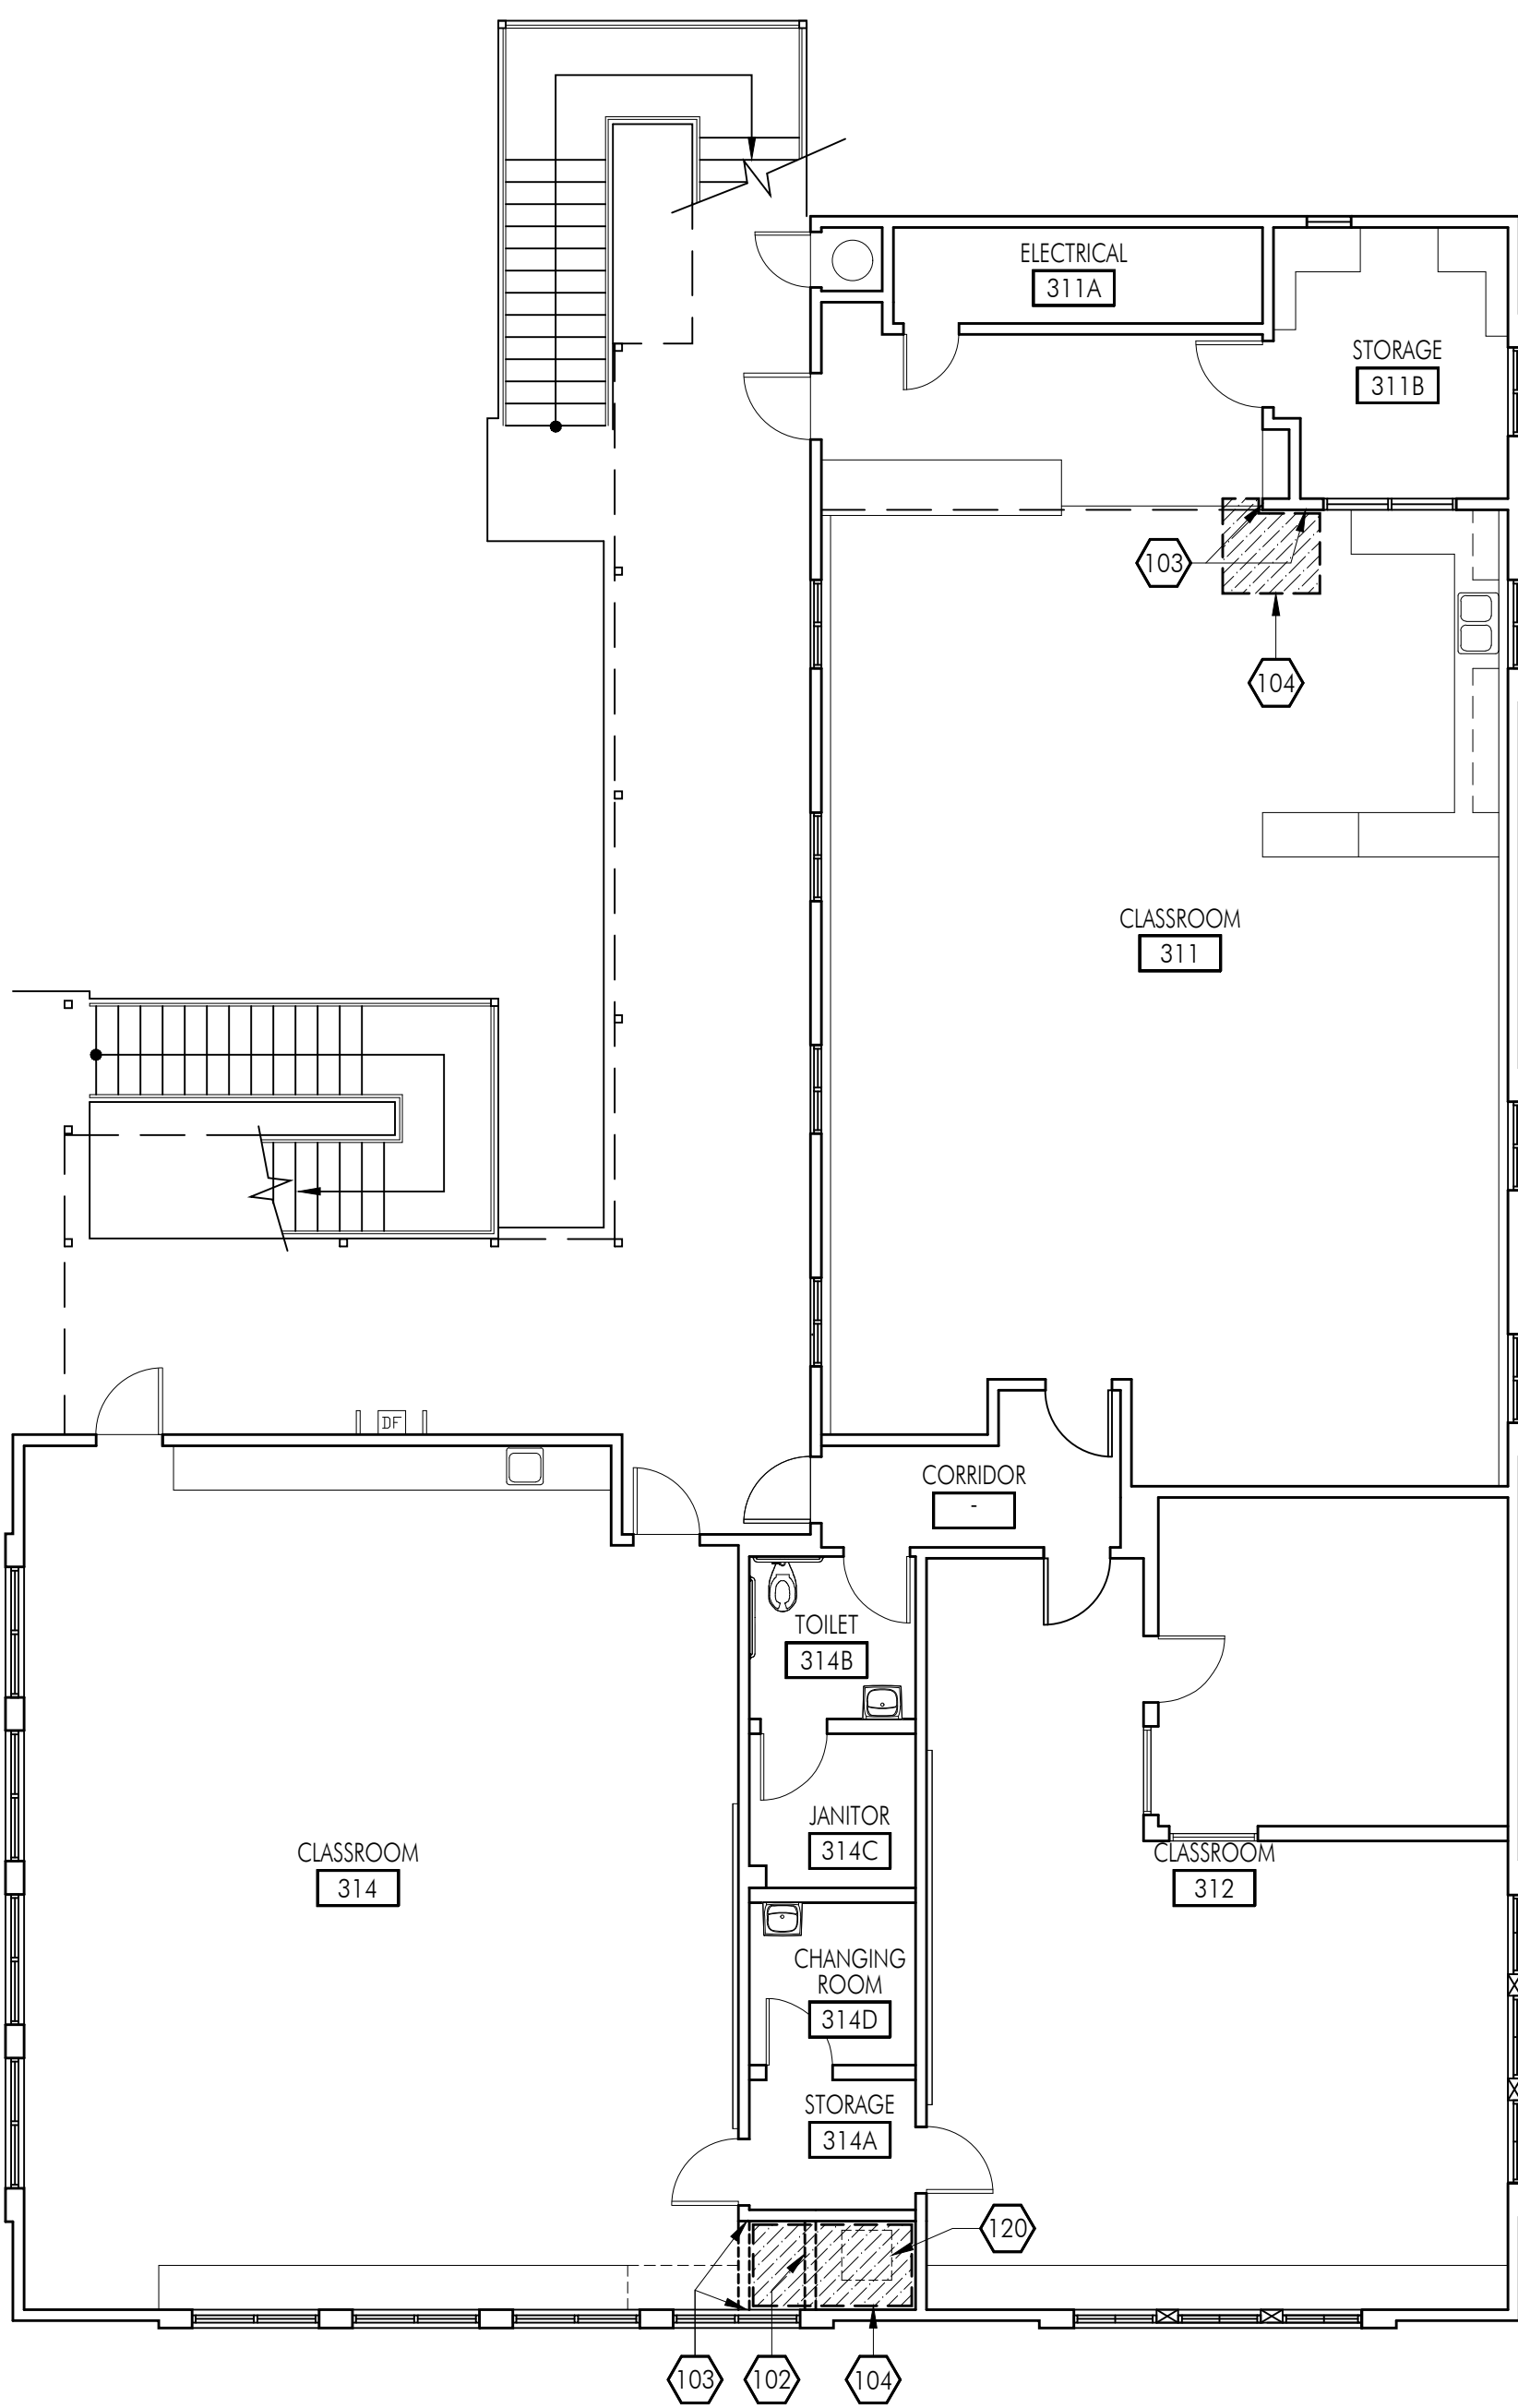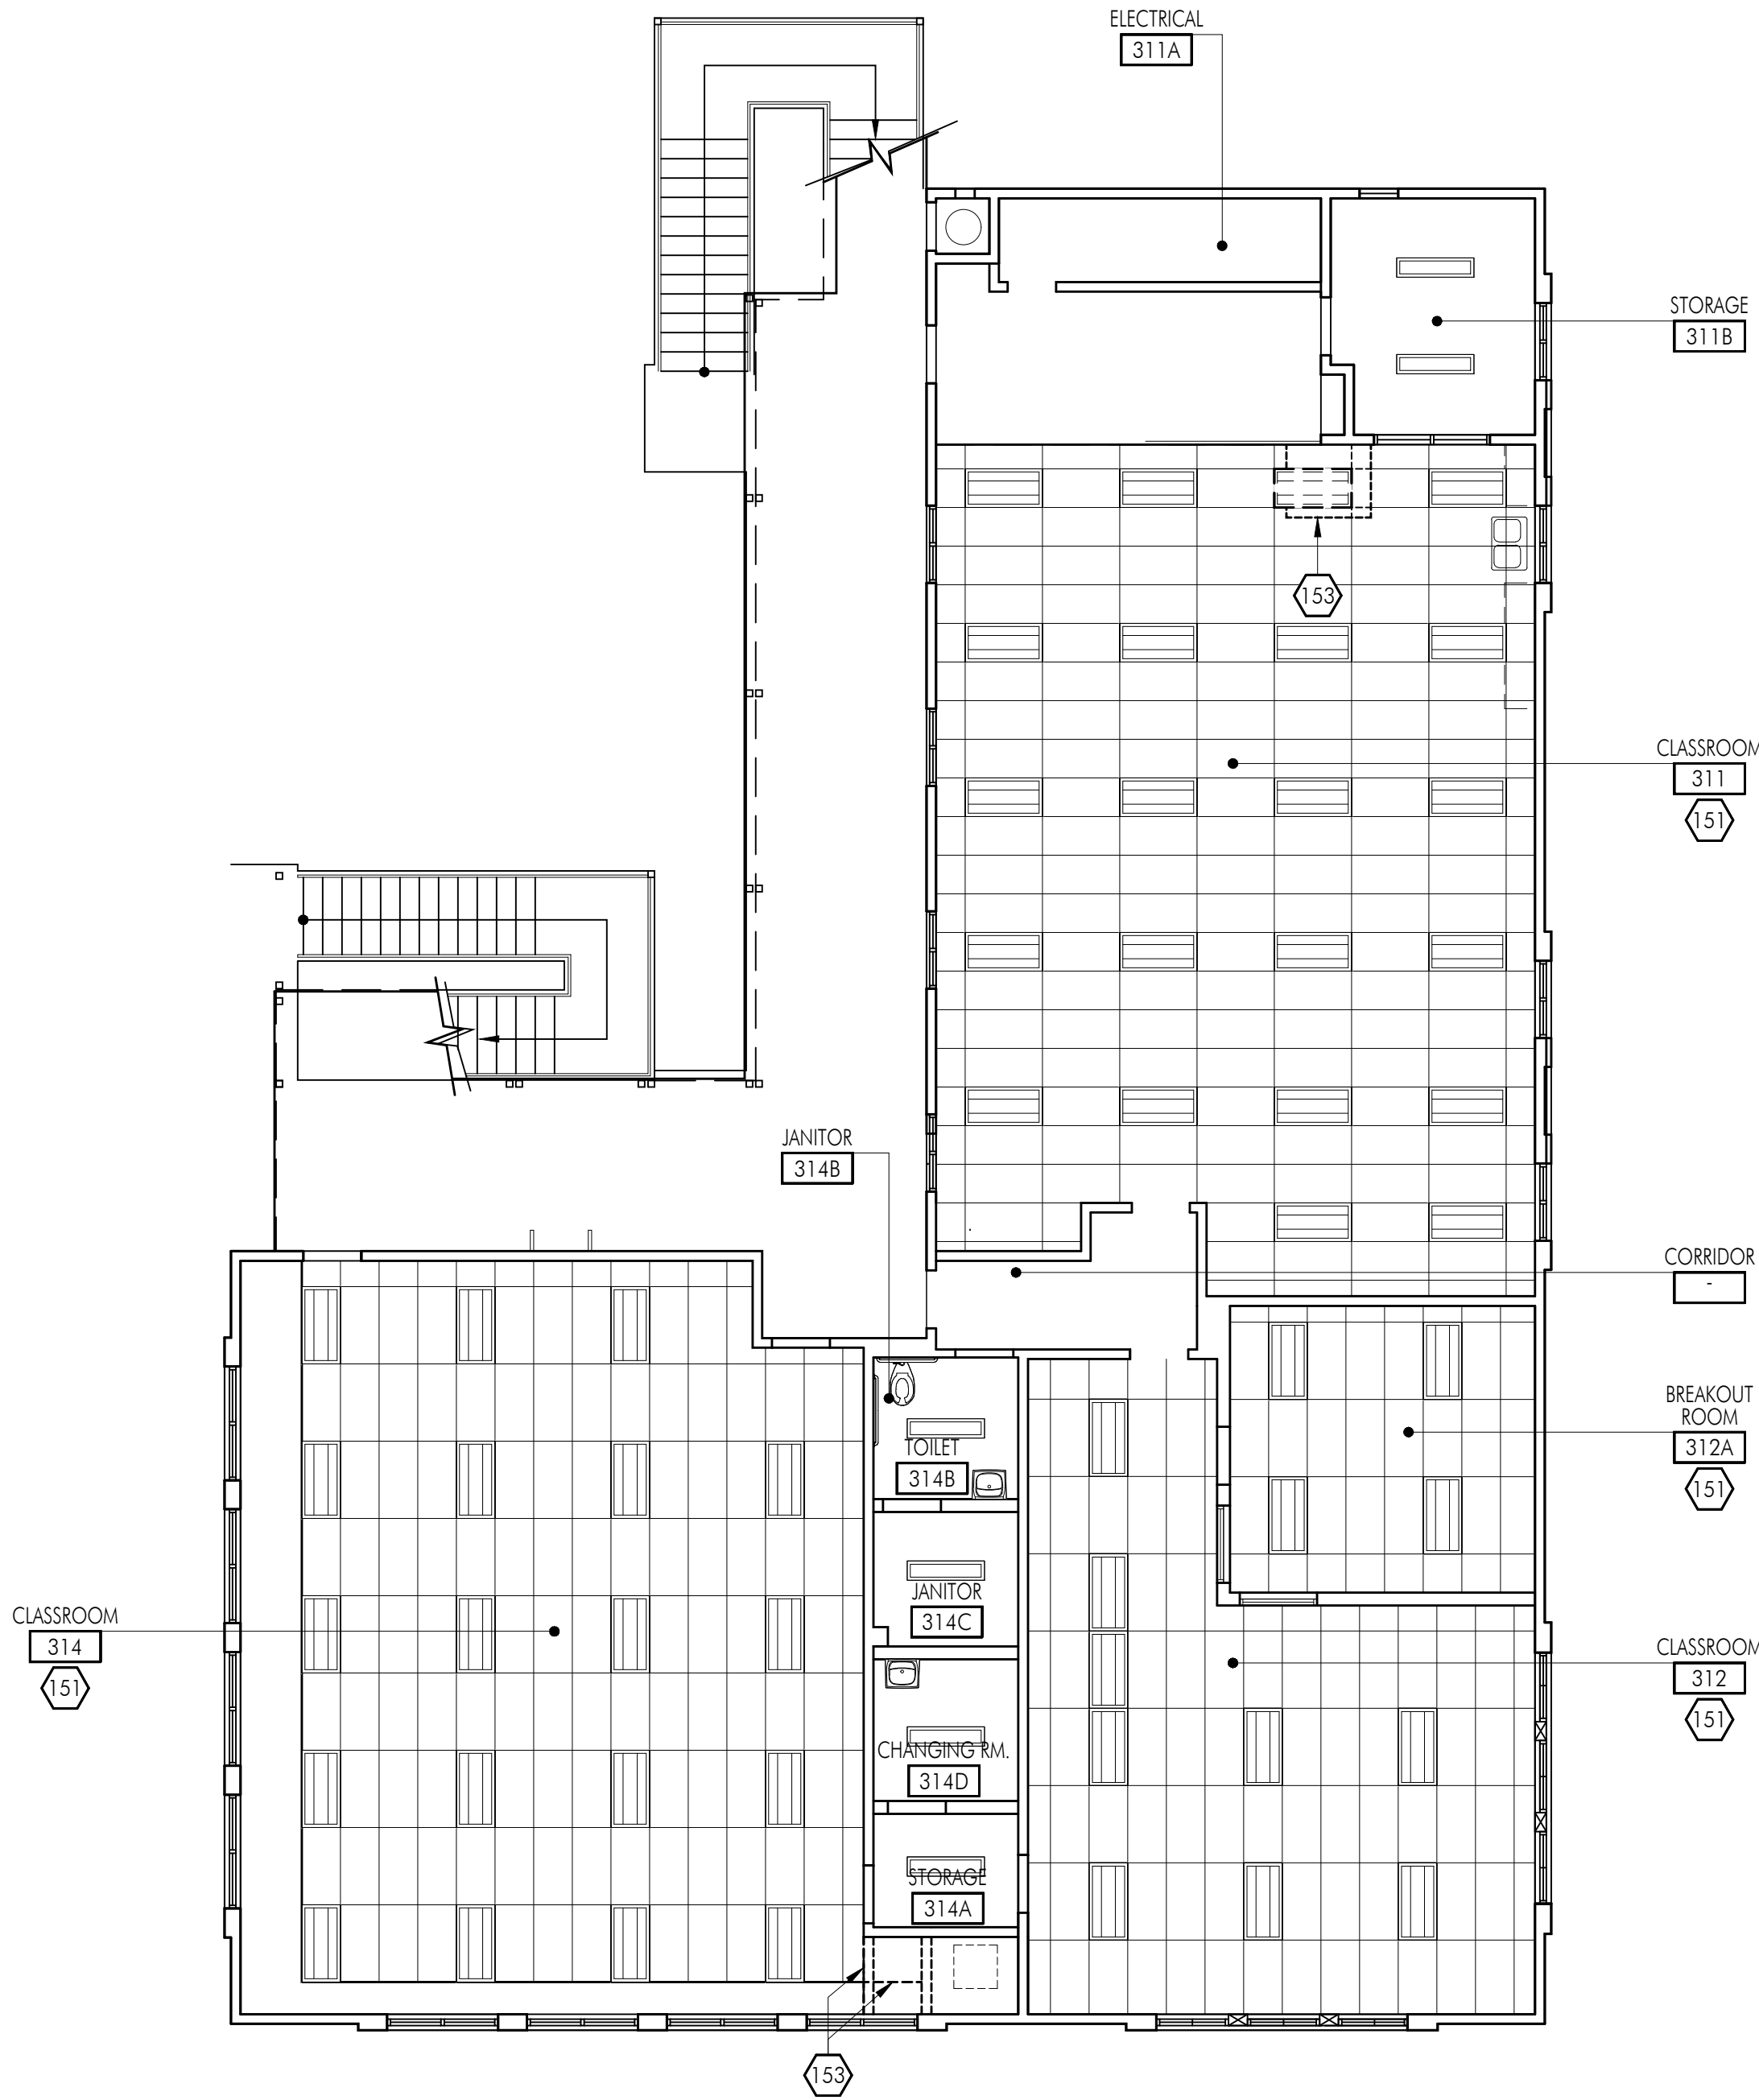

FLOOR PLAN GENERAL NOTES


1. REMOVE EXISTING GYPSUM BOARD, TILE AND BACKER BOARD OR PLASTER TO ACCOMMODATE REMOVAL AND REPLACEMENT OF PIPING, ELECTRICAL AND FOR THE INSTALLATION OF SUPPORT BLOCKING AND MECHANICAL EQUIPMENT. PATCH BACK TO MATCH ADJACENT SURFACE.
2. REFER TO MECHANICAL, PLUMBING, ELECTRICAL AND FIRE ALARM DRAWINGS FOR ADDITIONAL SCOPE OF WORK IN EACH ROOM.
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4. UNSCHEDULED CUTTING, REMOVING OR TRIMMING OF EXISTING CONCRETE, MASONRY OR WOOD FRAMED WALLS IS NOT PERMITTED, UNLESS NOTED OTHERWISE ALL DOORS SHALL BE FITTED WITHIN EXISTING WALL OPENINGS WITHOUT ENLARGING OR TRIMMING HEAD OR JAMBS.

DEMOLITION KEYNOTES

NO.	DESCRIPTION
103	REMOVE INDICATED PORTION OF EXISTING WALL OR PARTITION. PROTECT ADJACENT UNAFFECTED FINISHES, PATCH AND REPAIR AT REMOVAL AND PREPARE ADJACENT SURFACES FOR NEW WORK.
103	REMOVE EXISTING INTERIOR WALL FINISHES (INCLUDING BUT NOT LIMITED TO: SINGULARLY OR IN ANY COMBINATION PLASTER, GYPSUM BOARD, ACOUSTIC TILE, TACKABLE SURFACE ETC.) DOWN TO STUDS (OR STRUCTURE AS OCCURS) IN PREPARATION FOR INSTALLATION OF NEW WALL AND FINISHES. PROTECT ADJACENT UNAFFECTED FINISHES, PATCH AND REPAIR AT REMOVAL AND PREPARE ADJACENT SURFACES FOR NEW WORK.
104	REMOVE PORTION OF EXISTING FLOOR AS REQUIRED FOR INSTALLATION OF NEW MECHANICAL CLOSET FRAMING AND EQUIPMENT. PATCH AND REPAIR AT REMOVAL AND PREPARE ADJACENT SURFACES FOR NEW WORK.
120	REMOVE EXISTING MECHANICAL EQUIPMENT AND APPURTENANCES. SEE MECHANICAL, ELECTRICAL AND PLUMBING DRAWINGS FOR ADDITIONAL INFORMATION.
151	REMOVE PORTION OF (E) CEILING AS REQUIRED FOR INSTALLATION OF NEW DUCTWORK, AND UTILITIES AS OCCURS ABOVE CEILING. REPLACE CEILING TILES, PATCH, REPAIR AND PAINT AT ALL REMOVALS TO MATCH EXISTING ADJACENT.
153	REMOVE PORTION OF (E) CEILING AS REQUIRED FOR INSTALLATION OF NEW MECHANICAL CLOSET, MECHANICAL EQUIPMENT AND ALL ASSOCIATED DUCTWORK AND APPURTENANCES. PATCH REPAIR AND PAINT AT ALL REMOVALS TO MATCH EXISTING ADJACENT FINISHES AND IN PREPARATION FOR NEW WORK.

DEMOLITION FLOOR PLAN LEGEND

SYMBOL	DESCRIPTION
	(E) STUD WALL OR PARTITION TO REMAIN.
	(E) STUD WALL OR PARTITION TO BE REMOVED.
	(E) DOOR TO REMAIN. SAND, CLEAN AND PATCH DOOR IN PREPARATION FOR NEW FINISHES.
	REMOVE EXISTING DOOR AND APPURTENANCES. PROTECT EXISTING FRAME IN PLACE U.N.O. CLEAN AND PATCH FRAME IN PREPARATION FOR NEW FINISHES AND DOOR HARDWARE.
	EXISTING SUSPENDED T-BAR CEILING SYSTEM TO REMAIN, UNLESS NOTED OTHERWISE.
	EXISTING GLUE ON ACOUSTIC TILE TO REMAIN, UNLESS NOTED OTHERWISE.
	REMOVE EXISTING LIGHT AND APPURTENANCES. SEE ELECTRICAL FOR MORE INFORMATION.
	EXISTING LIGHT FIXTURE TO REMAIN. SEE ELECTRICAL FOR MORE INFORMATION.

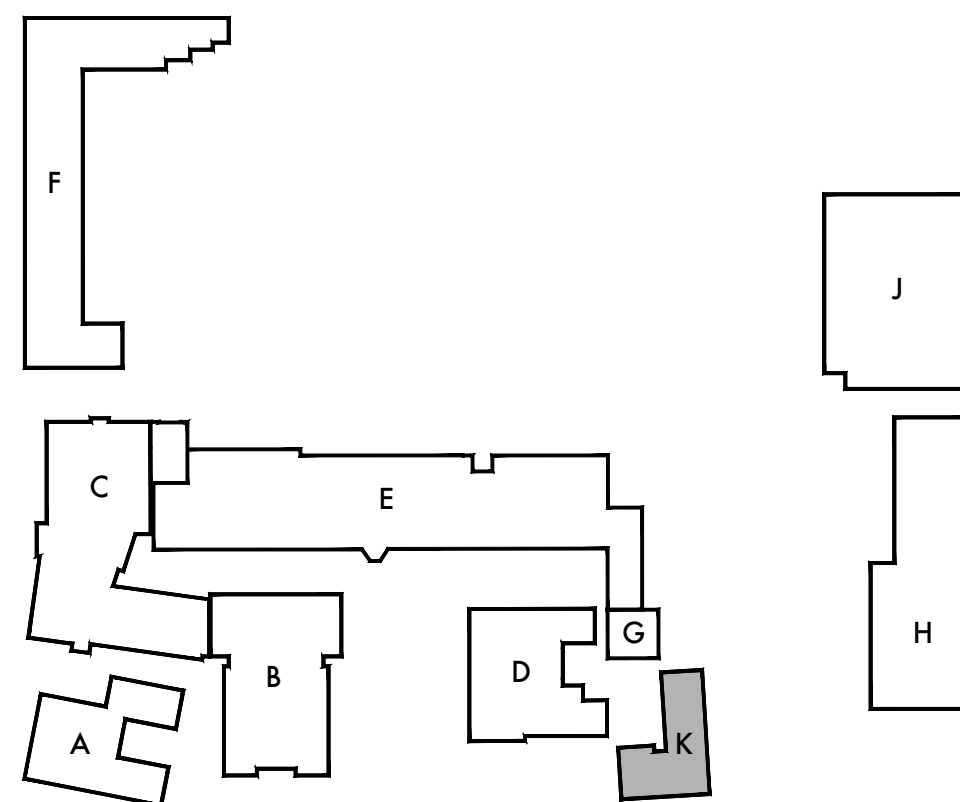

KEY PLAN

DSA Stamp

Architect



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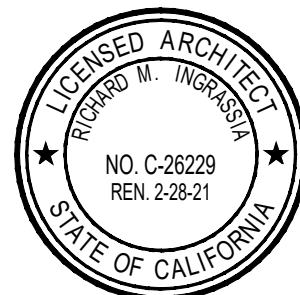
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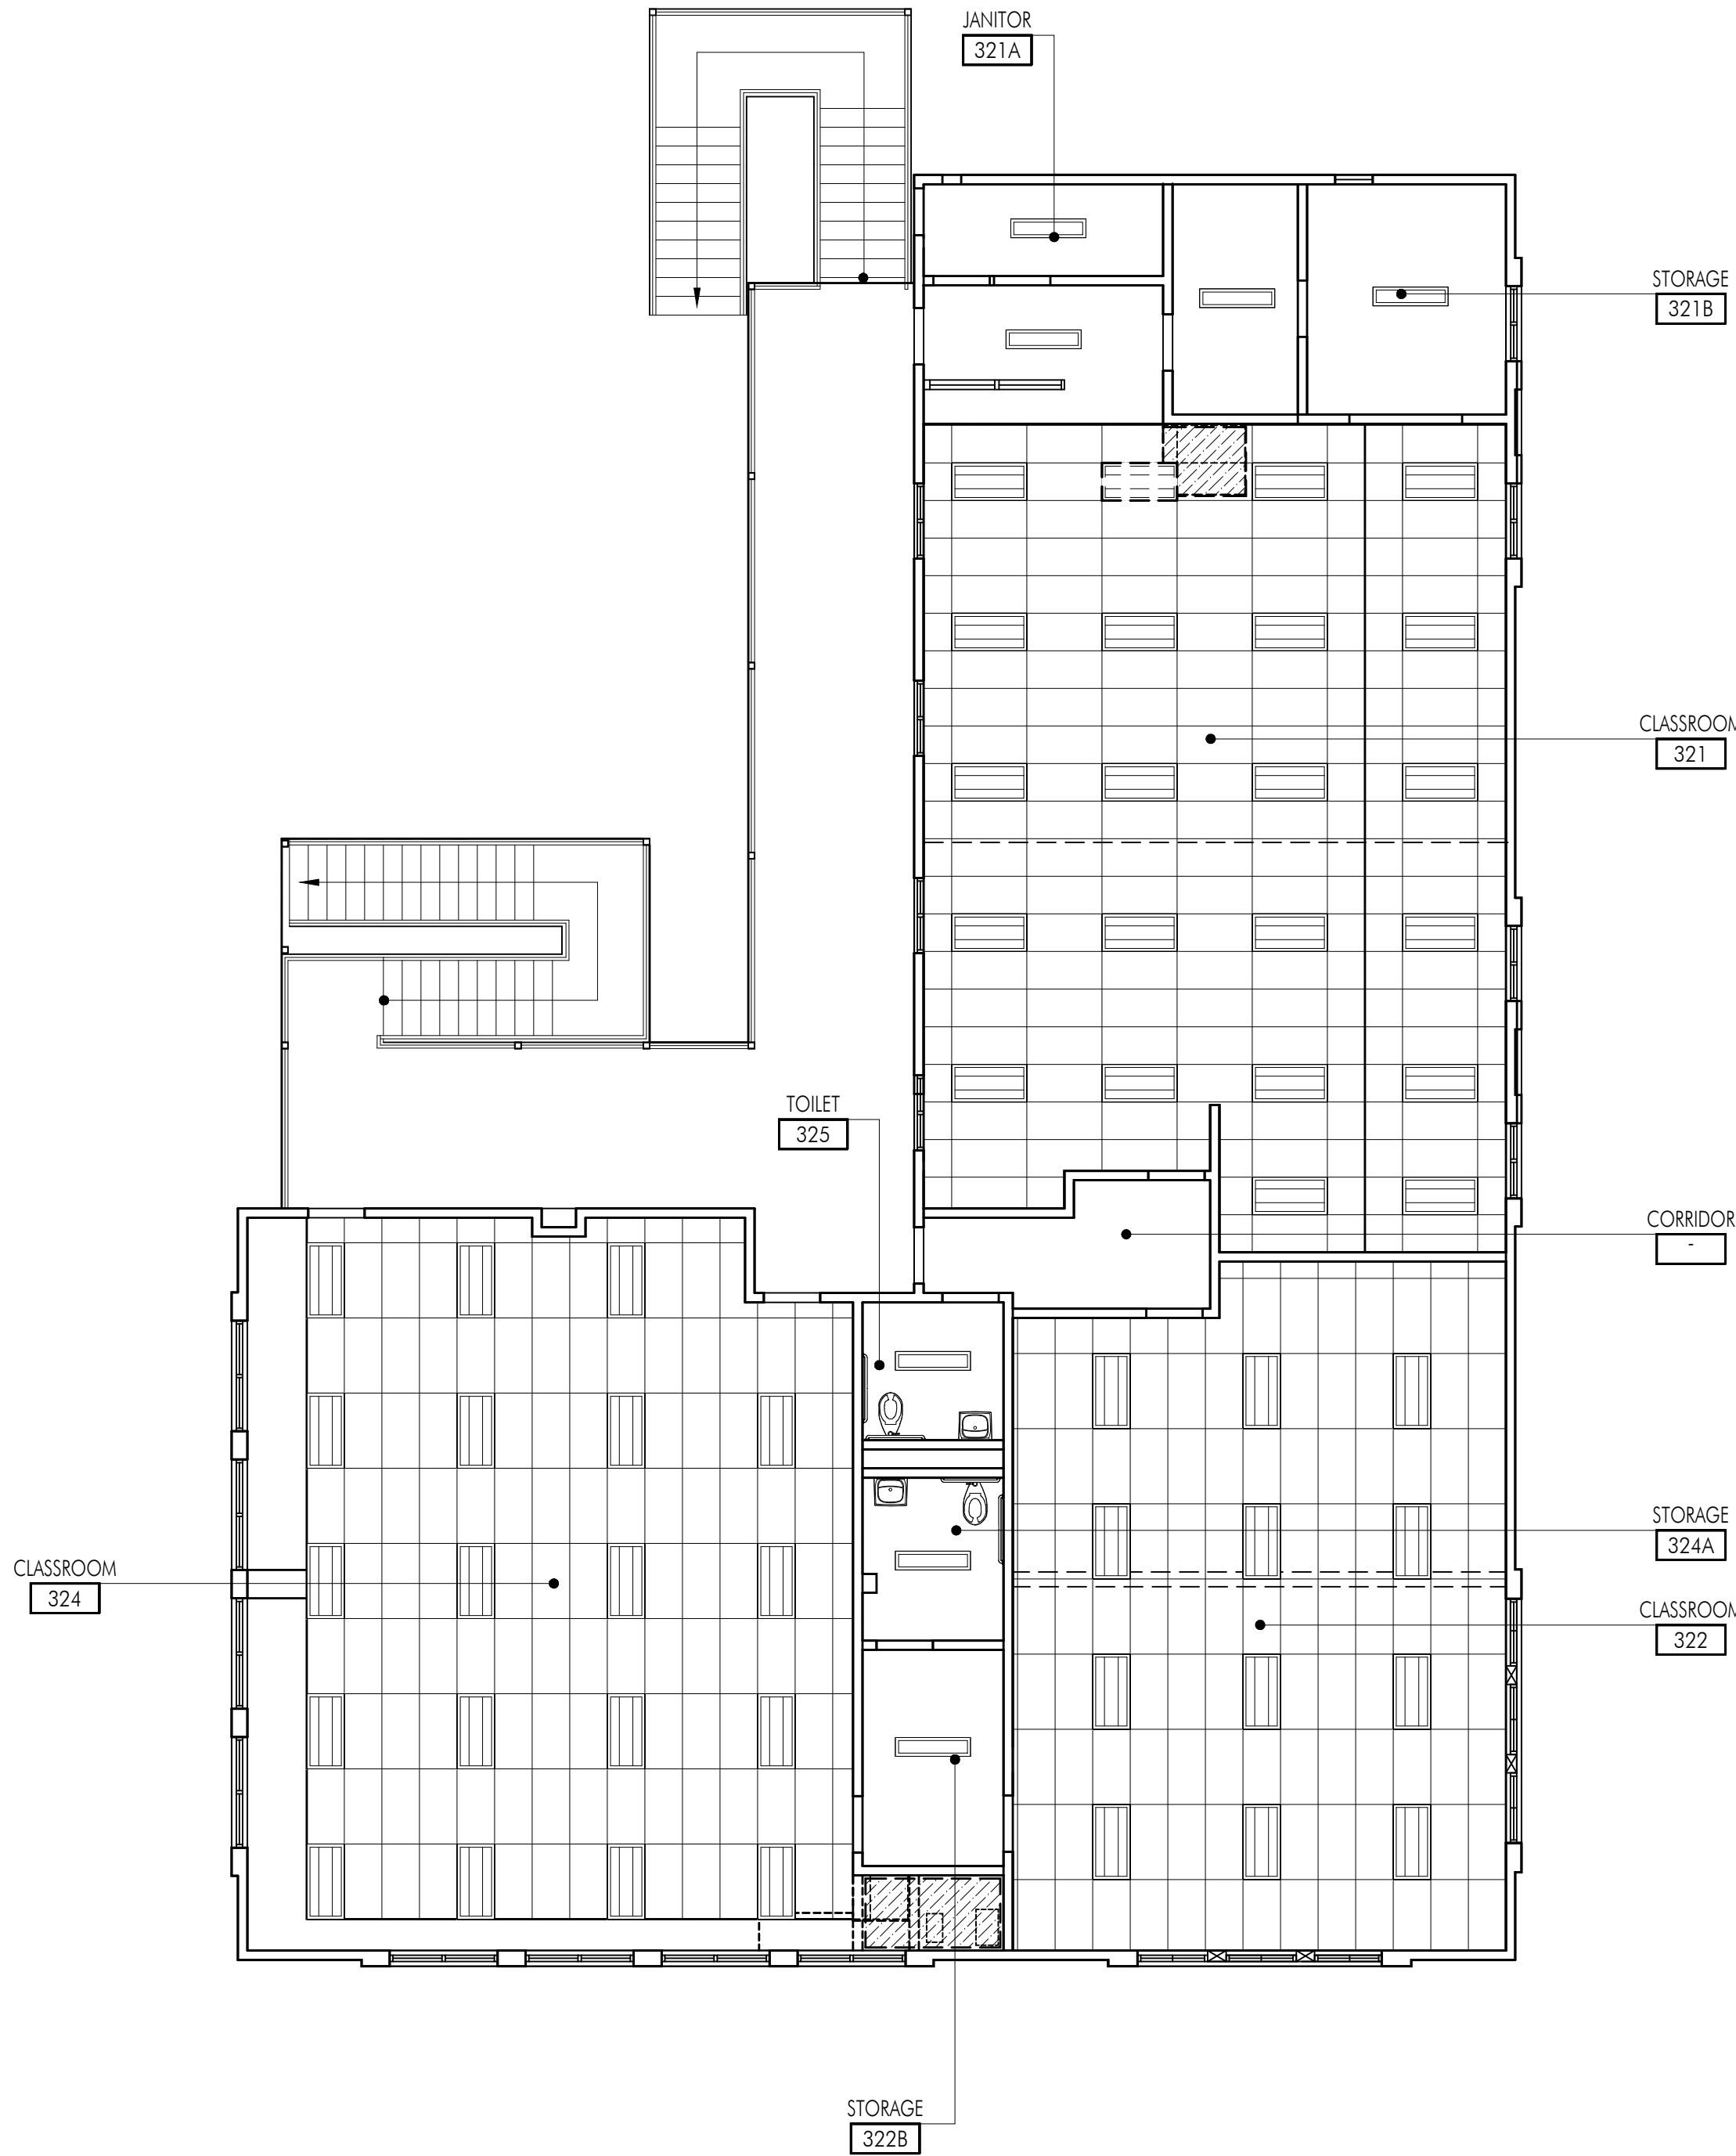
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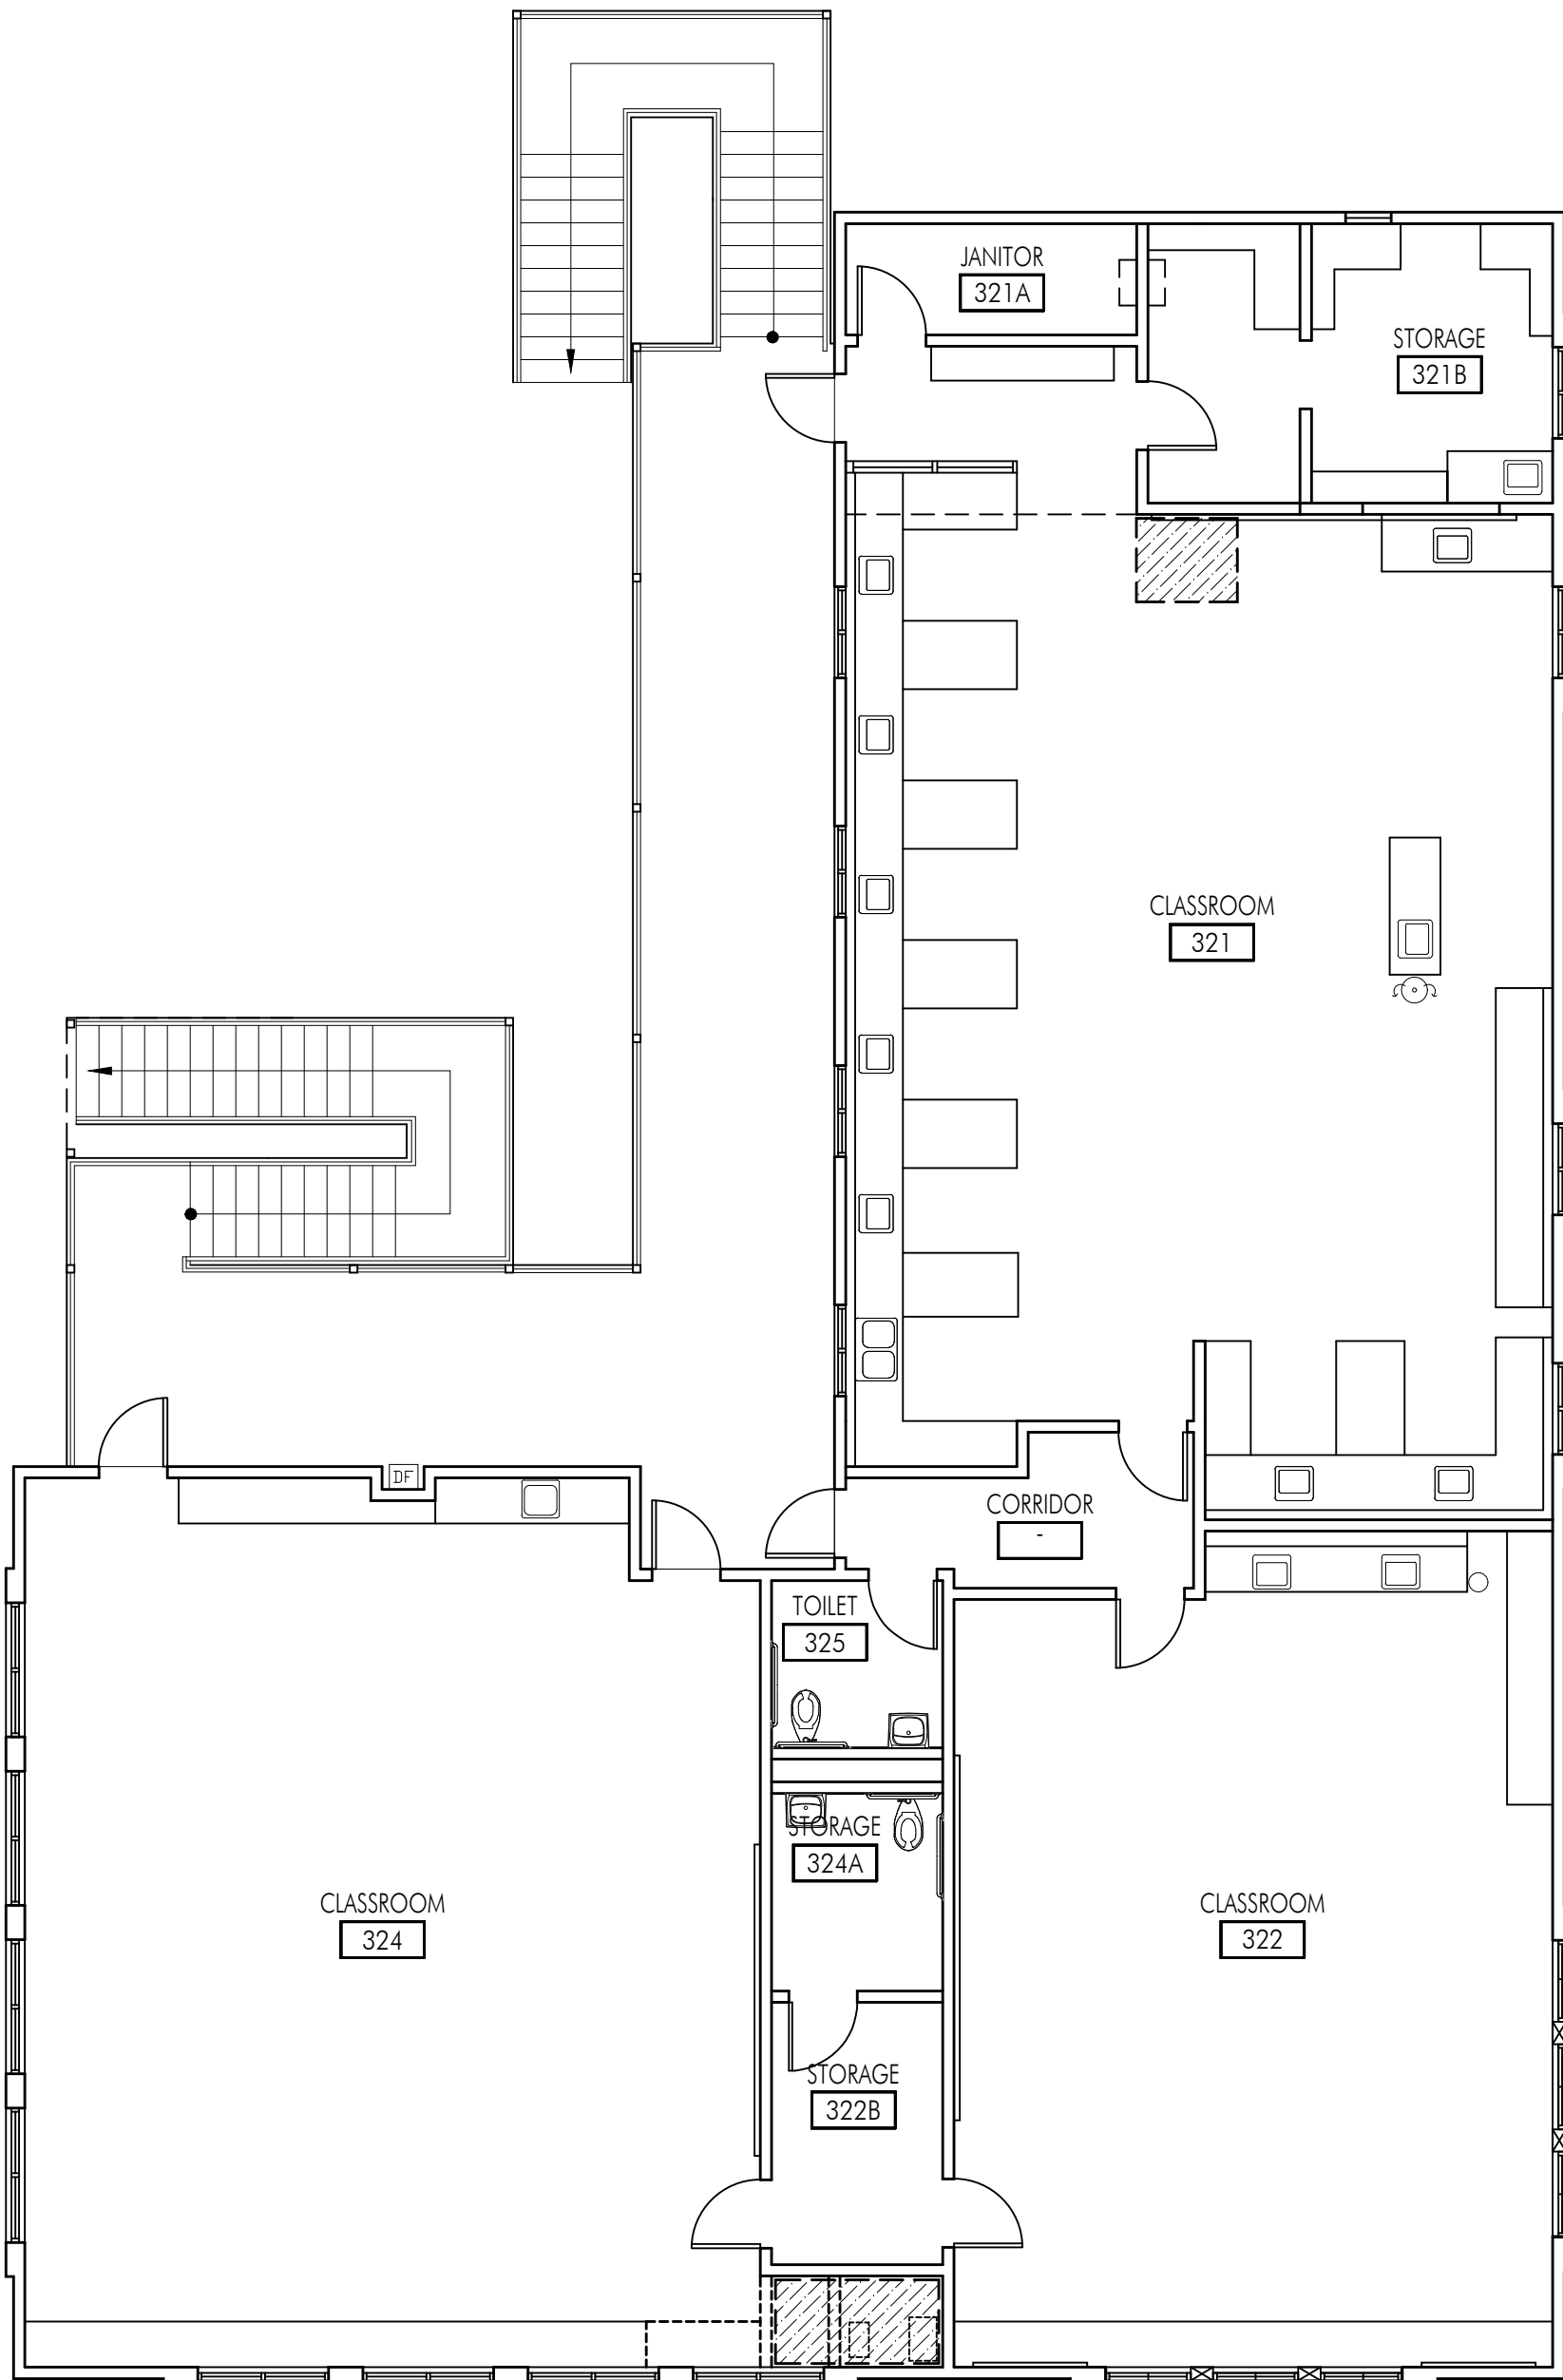
Building 'K' First Floor
Demolition Plan and
Demolition Reflected
Ceiling Plan

Sheet Number


AK201



SCALE: 1/8"=1'-0"



SCALE: 1/8"=1'-0"

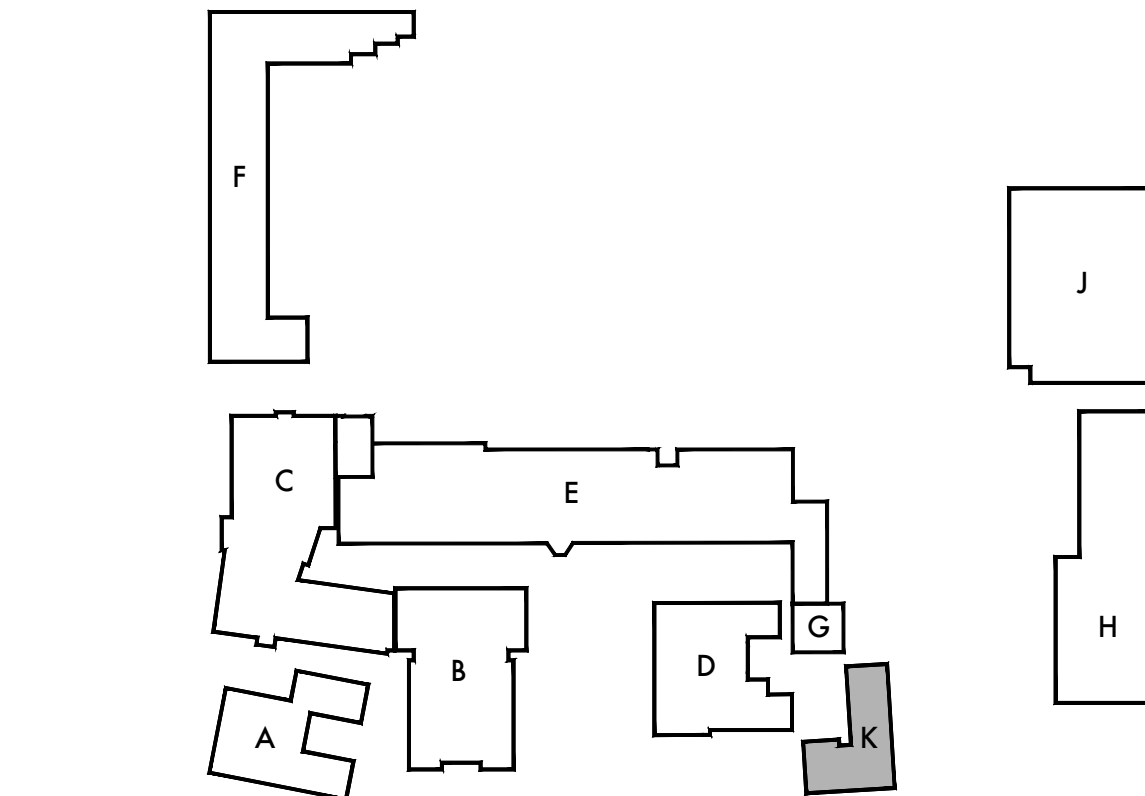

KEY PLAN

DEMOLITION FLOOR PLAN LEGEND

SYMBOL	DESCRIPTION
	(E) STUD WALL OR PARTITION TO REMAIN.
	(E) STUD WALL OR PARTITION TO BE REMOVED.
	(E) DOOR TO REMAIN. SAND, CLEAN AND PATCH DOOR IN PREPARATION FOR NEW FINISHES.
	REMOVE EXISTING DOOR AND APPURTENANCES. PROTECT EXISTING FRAME IN PLACE U.N.O. CLEAN AND PATCH FRAME IN PREPARATION FOR NEW FINISHES AND DOOR HARDWARE.
	EXISTING SUSPENDED T-BAR CEILING SYSTEM TO REMAIN, UNLESS NOTED OTHERWISE.
	EXISTING GLUE ON ACOUSTIC TILE TO REMAIN, UNLESS NOTED OTHERWISE.
	REMOVE EXISTING LIGHT AND APPURTENANCES. SEE ELECTRICAL FOR MORE INFORMATION.
	EXISTING LIGHT FIXTURE TO REMAIN. SEE ELECTRICAL FOR MORE INFORMATION.

DEMOLITION KEYNOTES

NO.	DESCRIPTION
(102)	REMOVE INDICATED PORTION OF EXISTING WALL OR PARTITION. PROTECT ADJACENT UNAFFECTED FINISHES, PATCH AND REPAIR AT REMOVAL AND PREPARE ADJACENT SURFACES FOR NEW WORK.
(103)	REMOVE EXISTING INTERIOR WALL FINISHES (INCLUDING BUT NOT LIMITED TO: SINGULARLY OR IN ANY COMBINATION PLASTER, GYPSUM BOARD, ACOUSTIC TILE, TACKABLE SURFACE ETC.) DOWN TO STUDS (OR STRUCTURE AS OCCURS) IN PREPARATION FOR INSTALLATION OF NEW WALL AND FINISHES. PROTECT ADJACENT UNAFFECTED FINISHES, PATCH AND REPAIR AT REMOVAL AND PREPARE ADJACENT SURFACES FOR NEW WORK.
(104)	REMOVE PORTION OF EXISTING FLOOR AS REQUIRED FOR INSTALLATION OF NEW MECHANICAL CLOSET FRAMING AND EQUIPMENT. PATCH AND REPAIR AT REMOVAL AND PREPARE ADJACENT SURFACES FOR NEW WORK.
(120)	REMOVE EXISTING MECHANICAL EQUIPMENT AND APPURTENANCES. SEE MECHANICAL, ELECTRICAL AND PLUMBING DRAWINGS FOR ADDITIONAL INFORMATION.
(151)	REMOVE PORTION OF (E) CEILING AS REQUIRED FOR INSTALLATION OF NEW DUCTWORK, AND UTILITIES AS OCCURS ABOVE CEILING. REPLACE CEILING TILES, PATCH, REPAIR AND PAINT AT ALL REMOVALS TO MATCH EXISTING ADJACENT.
(153)	REMOVE PORTION OF (E) CEILING AS REQUIRED FOR INSTALLATION OF NEW MECHANICAL CLOSET, MECHANICAL EQUIPMENT AND ALL ASSOCIATED DUCTWORK AND APPURTENANCES. PATCH REPAIR AND PAINT AT ALL REMOVALS TO MATCH EXISTING ADJACENT FINISHES AND IN PREPARATION FOR NEW WORK.

FLOOR PLAN GENERAL NOTES

1. REMOVE EXISTING GYPSUM BOARD, TILE AND BACKER BOARD OR PLASTER TO ACCOMMODATE REMOVAL AND REPLACEMENT OF PIPING, ELECTRICAL AND FOR THE INSTALLATION OF SUPPORT BLOCKING AND MECHANICAL EQUIPMENT. PATCH BACK TO MATCH ADJACENT SURFACE.
2. REFER TO MECHANICAL, PLUMBING, ELECTRICAL AND FIRE ALARM DRAWINGS FOR ADDITIONAL SCOPE OF WORK IN EACH ROOM.
3. ALL WALLS SHALL BE FULL HEIGHT TO THE ROOF DECK UNLESS NOTED OTHERWISE, AND SHALL BE CLOSED AND SEALED PER WALL TYPE AND AS DETAILED ON A711.
4. UNSCHEDULED CUTTING, REMOVING OR TRIMMING OF EXISTING CONCRETE, MASONRY OR WOOD FRAMED WALLS IS NOT PERMITTED, UNLESS NOTED OTHERWISE ALL DOORS SHALL BE FITTED WITHIN EXISTING WALL OPENINGS WITHOUT ENLARGING OR TRIMMING HEAD OR JAMBS.

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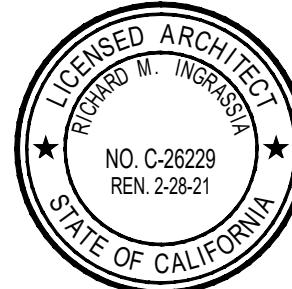
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Lincoln Middle School HVAC Replacement Project
Lincoln Middle School
1501 California Avenue
Santa Monica, California 90403

Rev	Date	Issue
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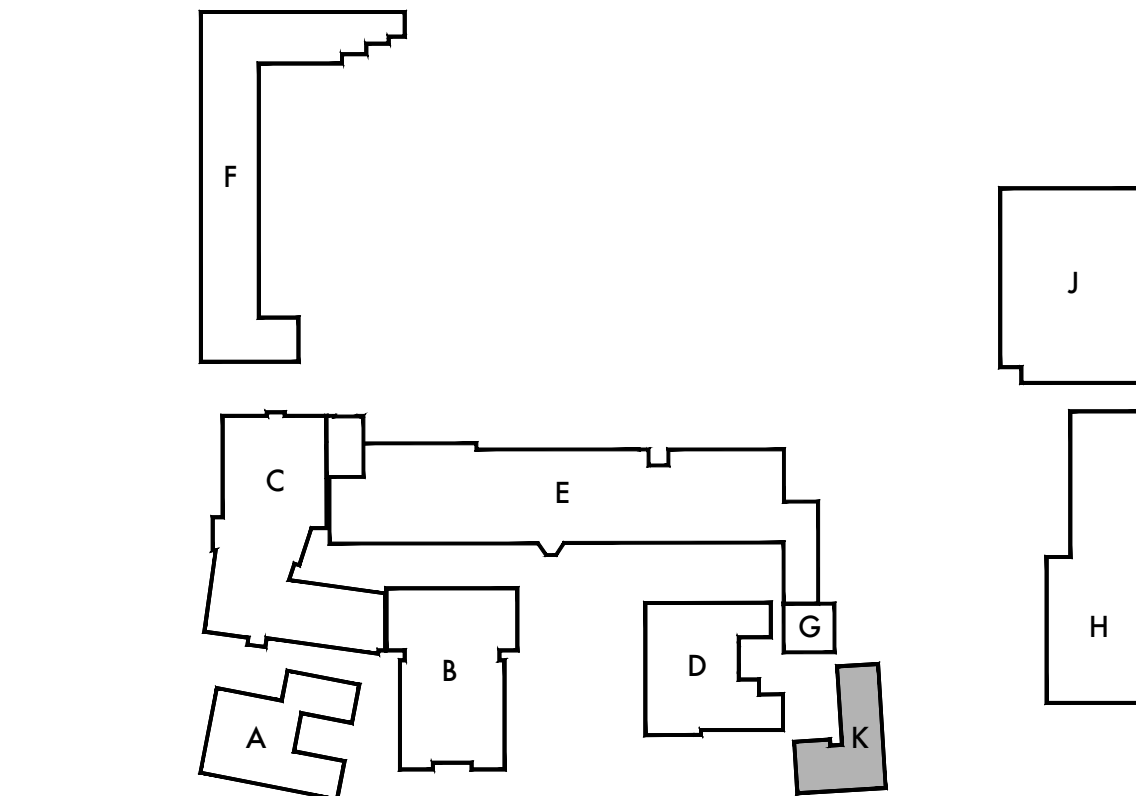
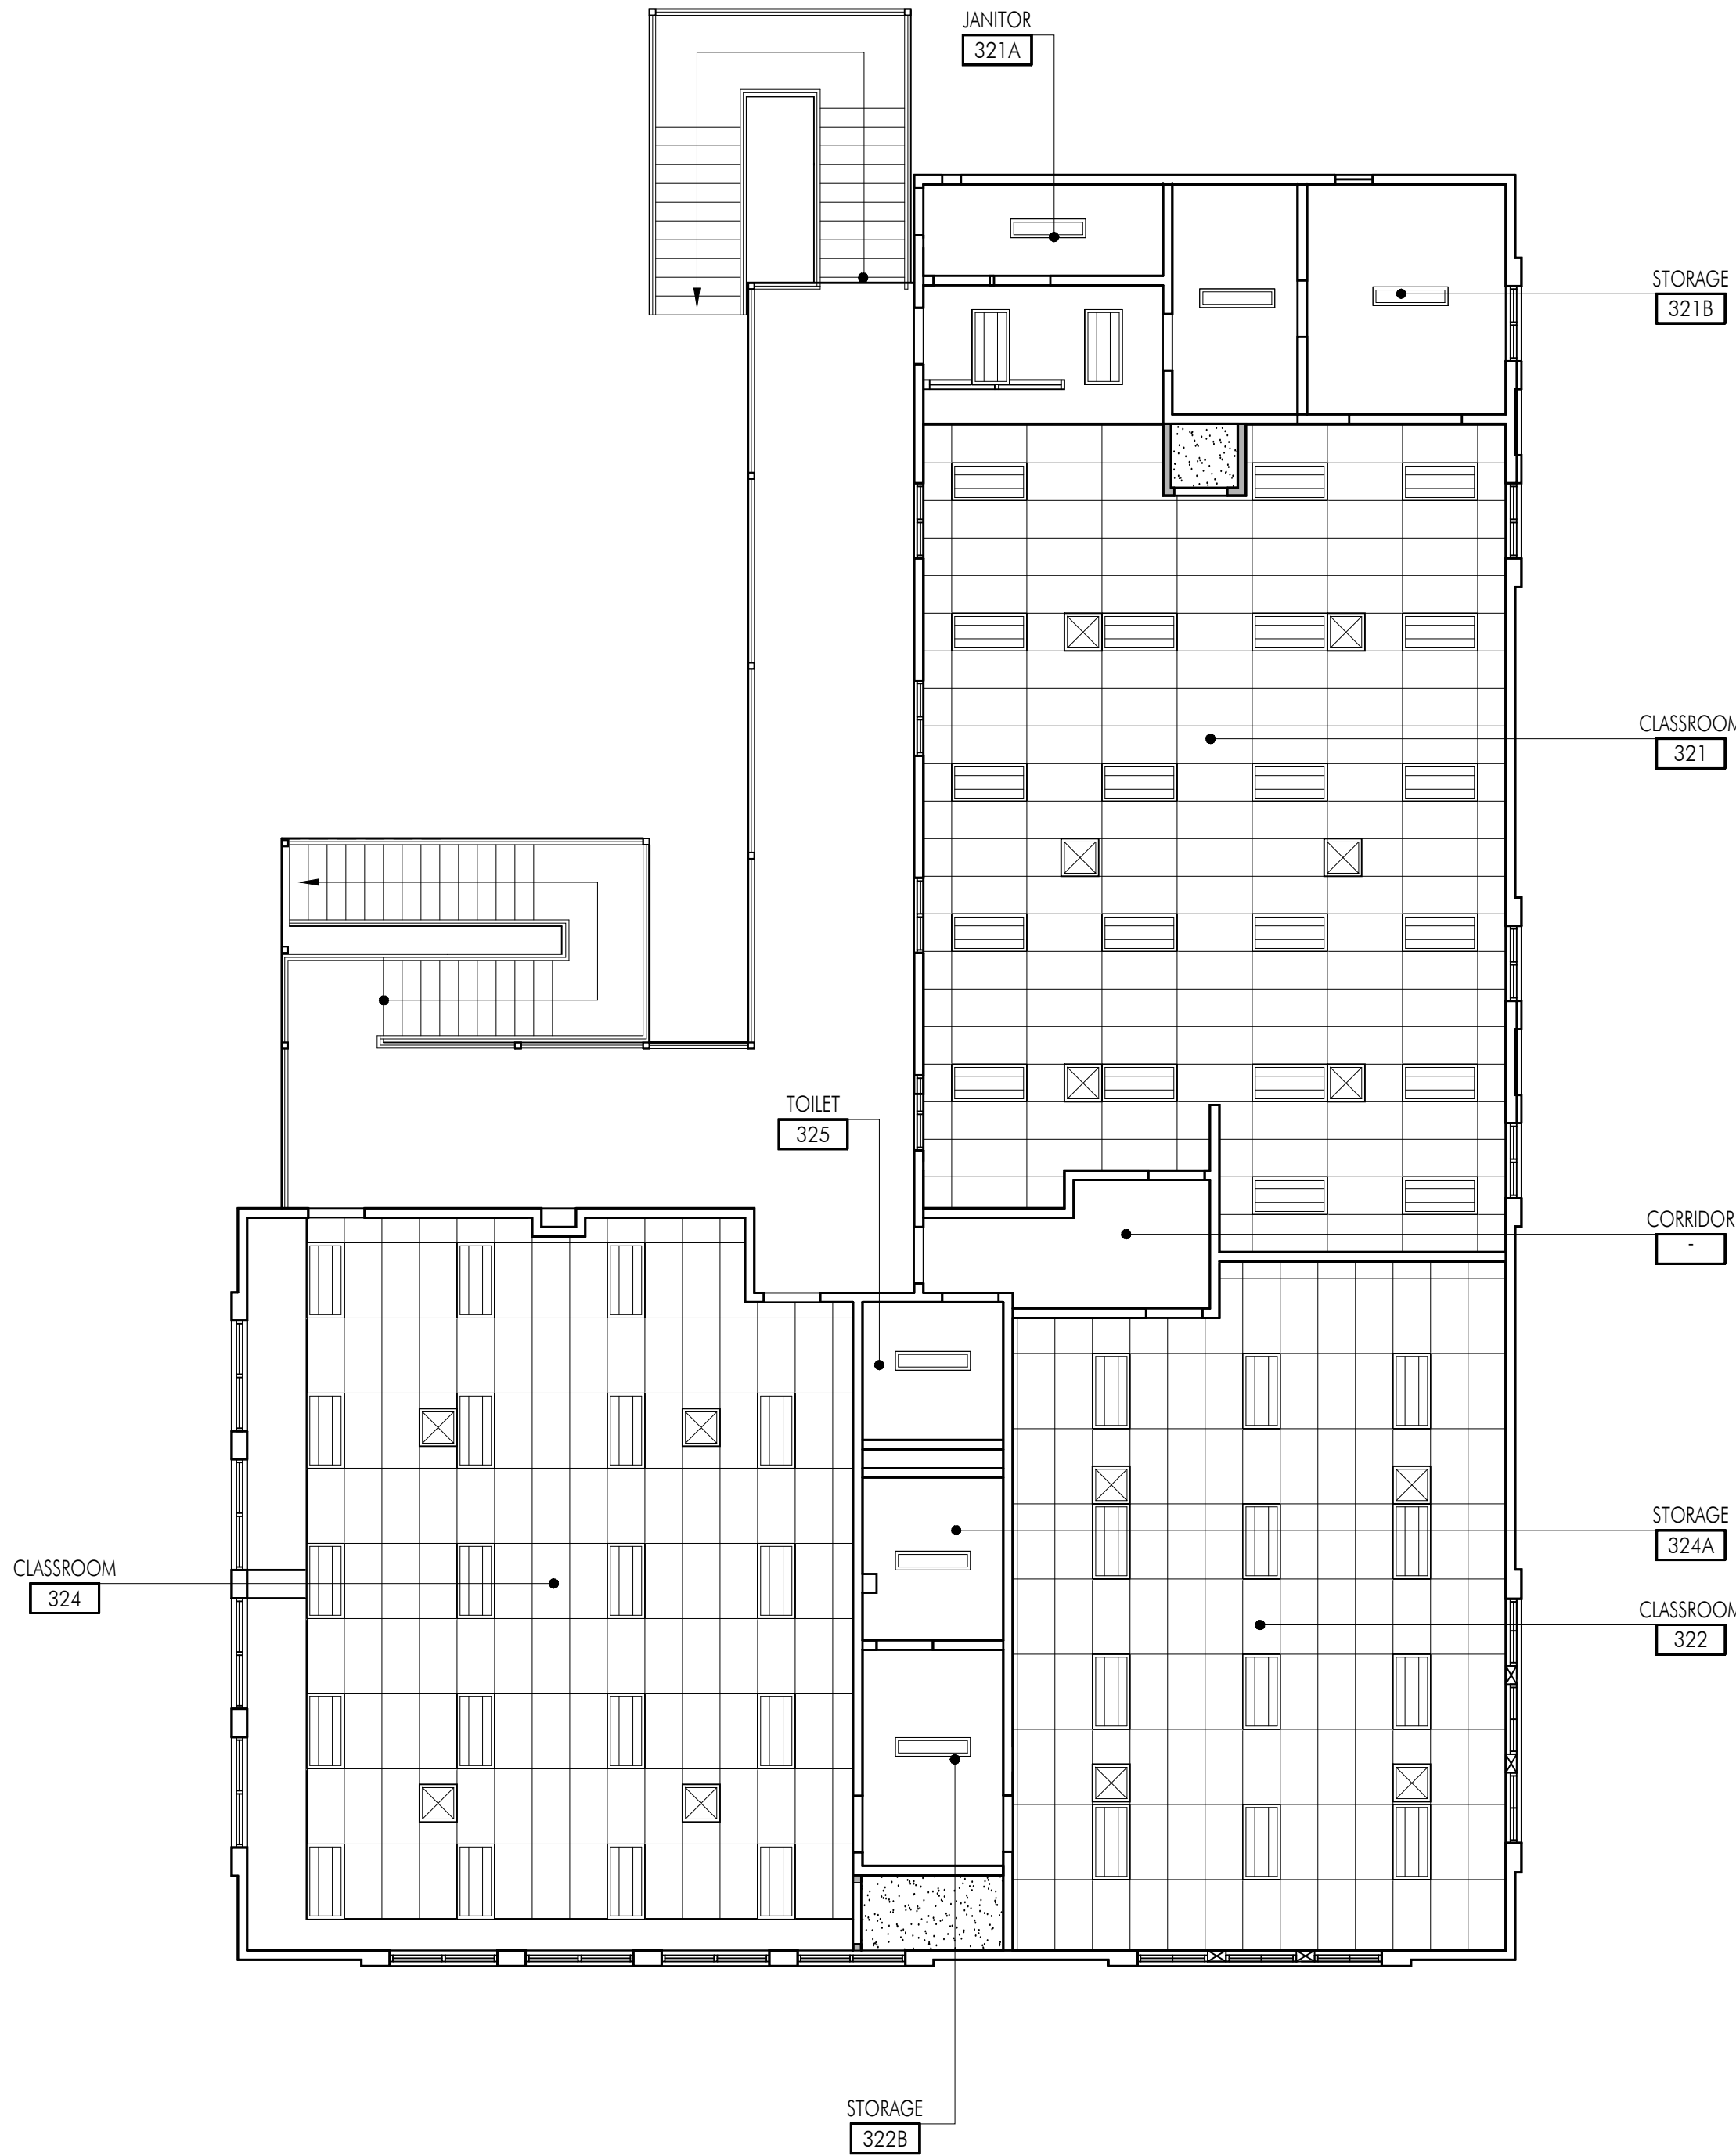
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Sheet Title

Building 'K' Second
Floor Demolition Plan
and Demolition
Reflected Ceiling Plan

Sheet Number

AK202



FLOOR PLAN LEGEND

SYMBOL	DESCRIPTION
	(E) WOOD STUD WALL OR PARTITION TO REMAIN.
	METAL STUD WALL ASSEMBLY. REFER TO WALL TYPE AND TYPICAL DETAILS ON A711 FOR MORE INFORMATION.
	NEW DOOR AND FRAME. SEE DOOR SCHEDULE ON A611 FOR MORE INFORMATION.
	WALL TYPE. SEE A711 FOR MORE INFORMATION.
	EXISTING SUSPENDED T-BAR CEILING SYSTEM TO REMAIN, UNLESS NOTED OTHERWISE.
	EXISTING GLUE ON ACOUSTIC TILE TO REMAIN, UNLESS NOTED OTHERWISE.
	EXISTING LIGHT FIXTURE TO REMAIN. SEE ELECTRICAL FOR MORE INFORMATION.
	RELOCATED LIGHT FIXTURE. SEE ELECTRICAL FOR MORE INFORMATION.
	FRAMED GYPSUM BOARD CEILING SEE XXXX FOR ADDITIONAL INFORMATION AND REFERENCED DETAIL ON PLAN FOR SOFFIT CONDITIONS AS OCCURS. PAINT P-1
	AIR SUPPLY REGISTER
	RETURN AIR GRILLE
	EXHAUST GRILLE

FLOOR PLAN GENERAL NOTES

1. REMOVE EXISTING GYPSUM BOARD, TILE AND BACKER BOARD OR PLASTER TO ACCOMMODATE REMOVAL AND REPLACEMENT OF PIPING, ELECTRICAL AND FOR THE INSTALLATION OF SUPPORT BLOCKING AND MECHANICAL EQUIPMENT. PATCH BACK TO MATCH ADJACENT SURFACE.
2. REFER TO MECHANICAL, PLUMBING, ELECTRICAL AND FIRE ALARM DRAWINGS FOR ADDITIONAL SCOPE OF WORK IN EACH ROOM.
3. ALL WALLS SHALL BE FULL HEIGHT TO THE ROOF DECK UNLESS NOTED OTHERWISE, AND SHALL BE CLOSED AND SEALED PER WALL TYPE AND AS DETAILED ON A711.
4. UNSCHEDULED CUTTING, REMOVING OR TRIMMING OF EXISTING CONCRETE, MASONRY OR WOOD FRAMED WALLS IS NOT PERMITTED, UNLESS NOTED OTHERWISE ALL DOORS SHALL BE FITTED WITHIN EXISTING WALL OPENINGS WITHOUT ENLARGING OR TRIMMING HEAD OR JAMBS.

KEYNOTES

NO.	DESCRIPTION
201	MECHANICAL CLOSET SEE WALL TYPE AS REFERENCED AND PLAN FOR DIMENSIONS. SEE MECHANICAL DRAWINGS FOR MORE INFORMATION.

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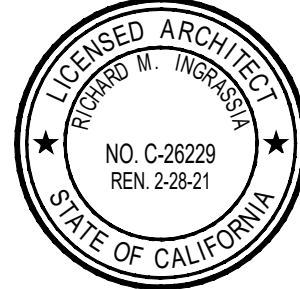
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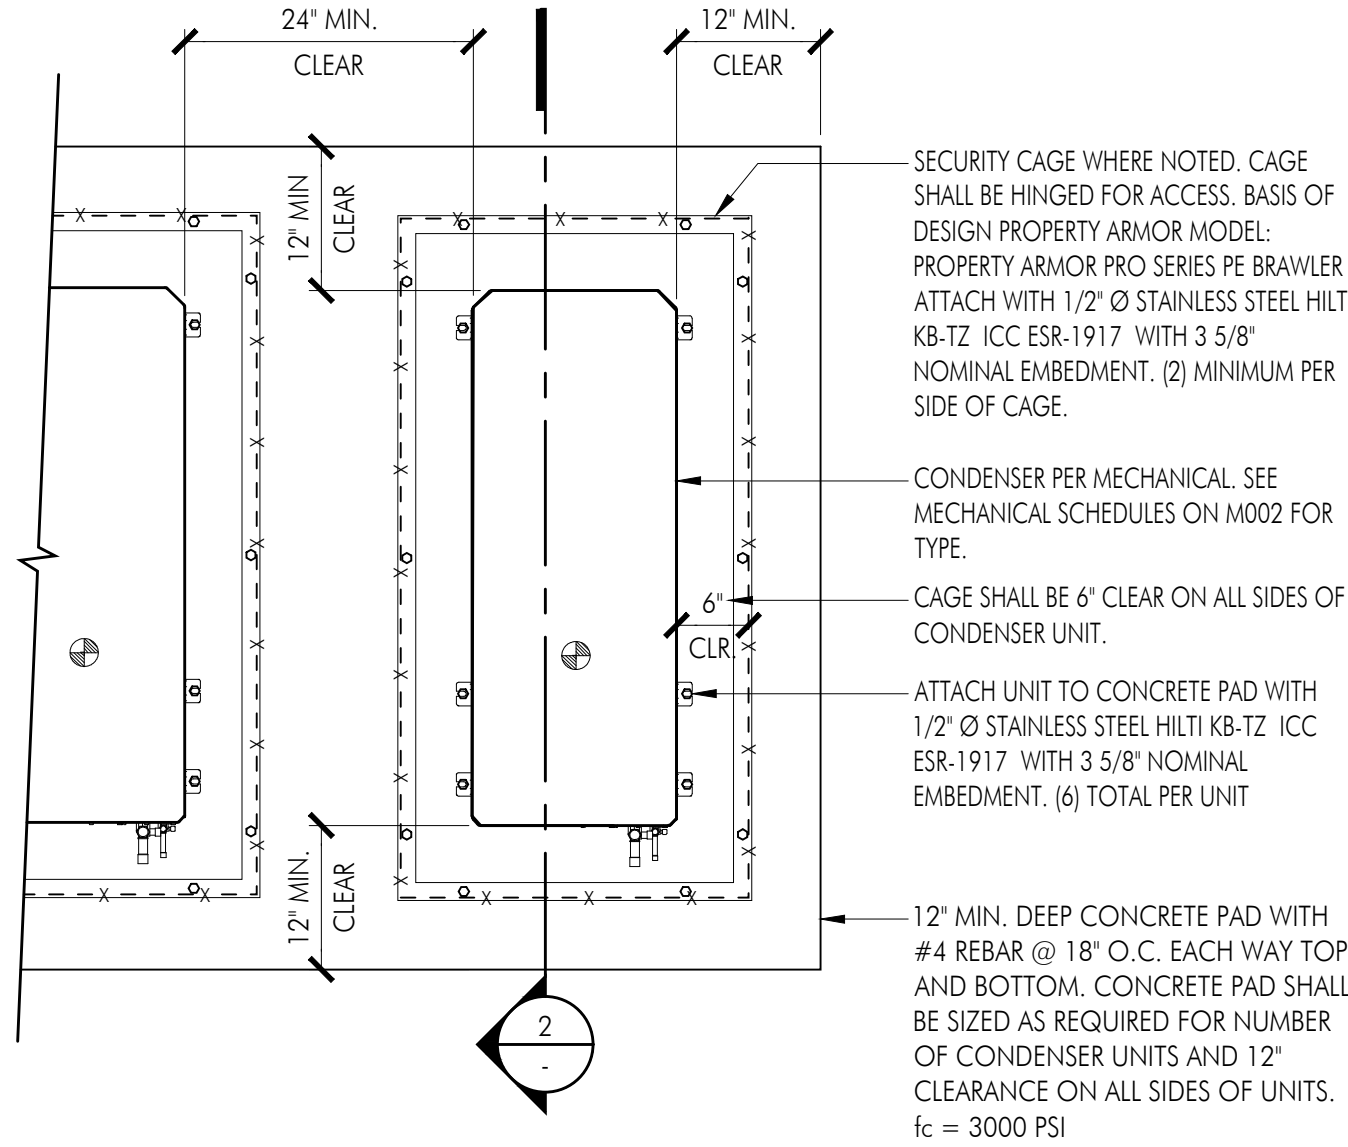


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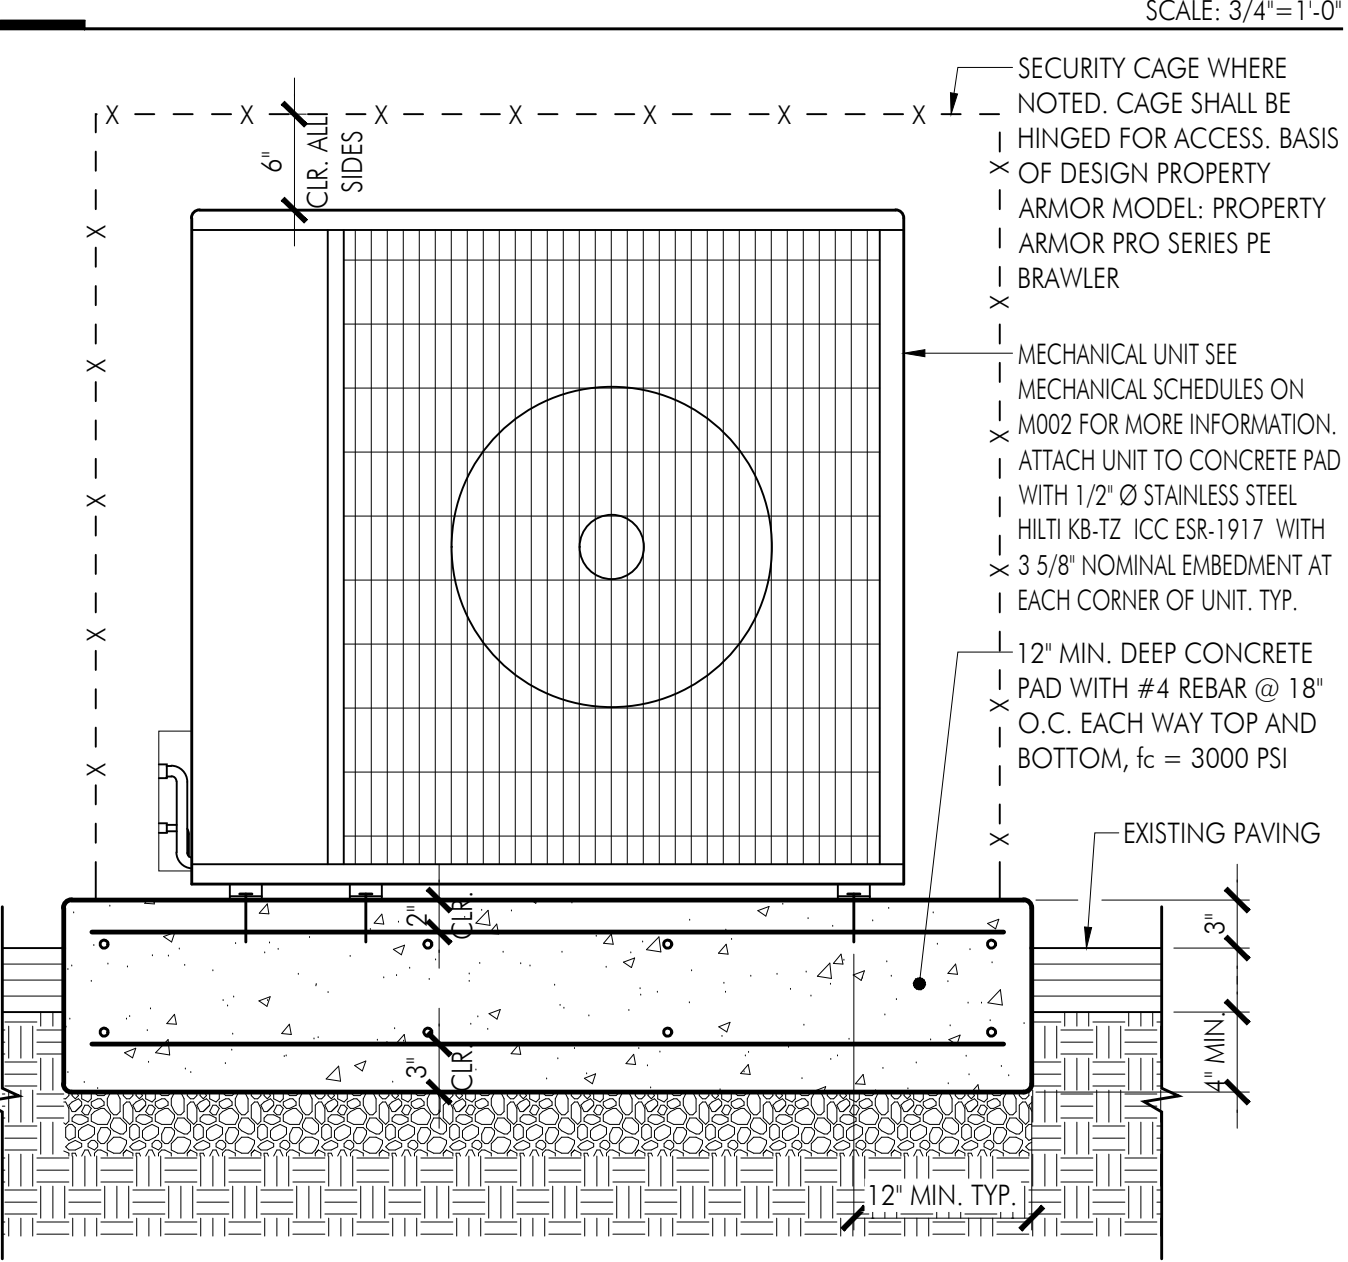
Sheet Title
Building 'K' Second
Floor Plan and
Reflected Ceiling Plan

Sheet Number

AK212



1 CONDENSER UNIT PLATFORM



2 CONCRETE PAD AT MECH. CONDENSER

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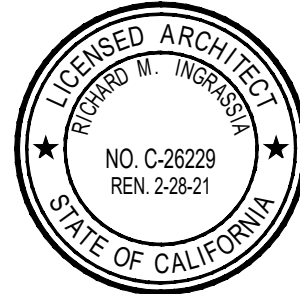
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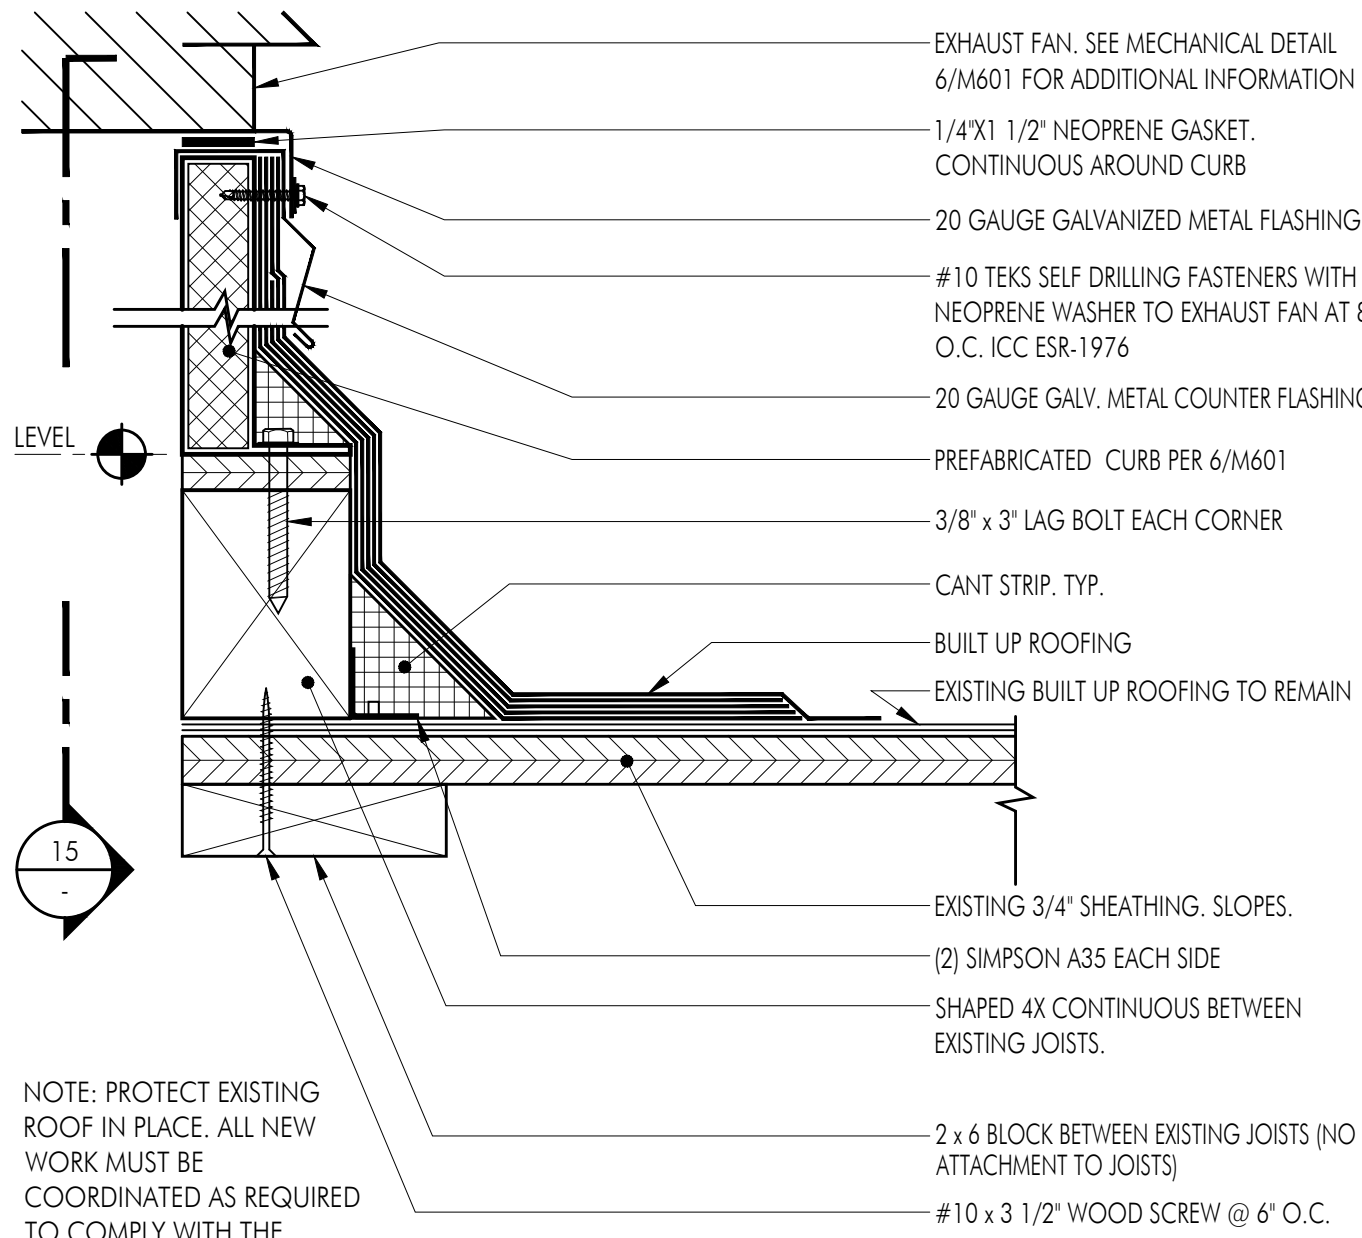


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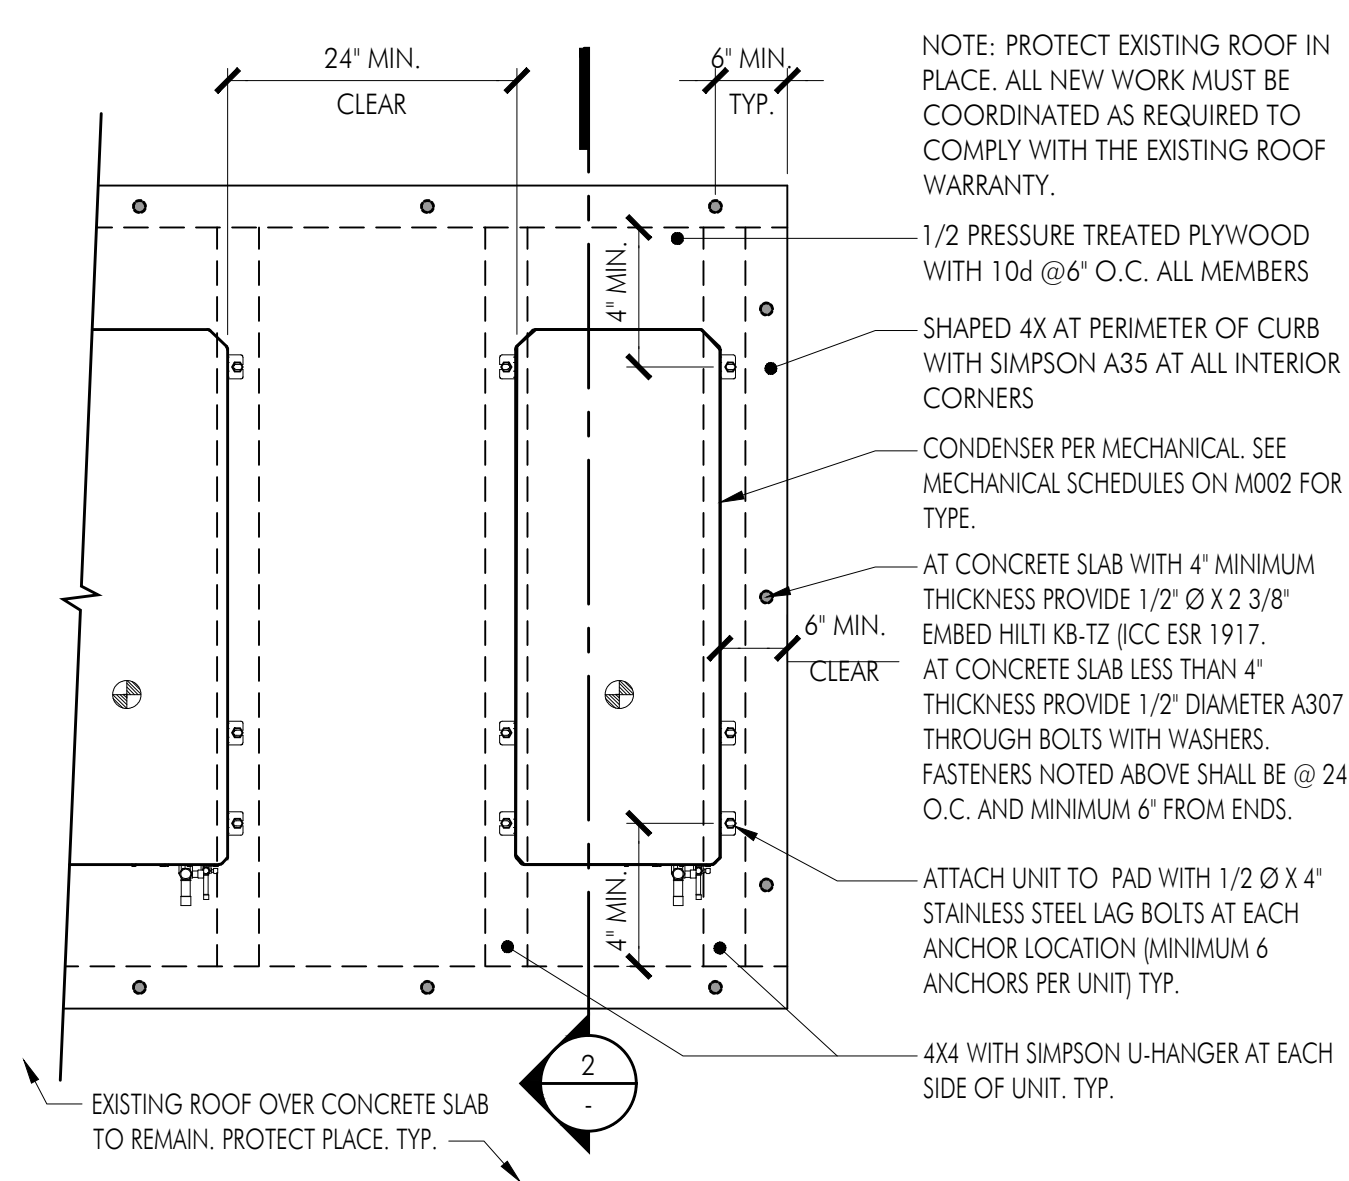
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A811




6 EXHAUST FAN CURB

SCALE: 3/4"=1'-0"




1 CONDENSER UNIT PLATFORM ON ROOF

SCALE: 3/4"=1'-0"

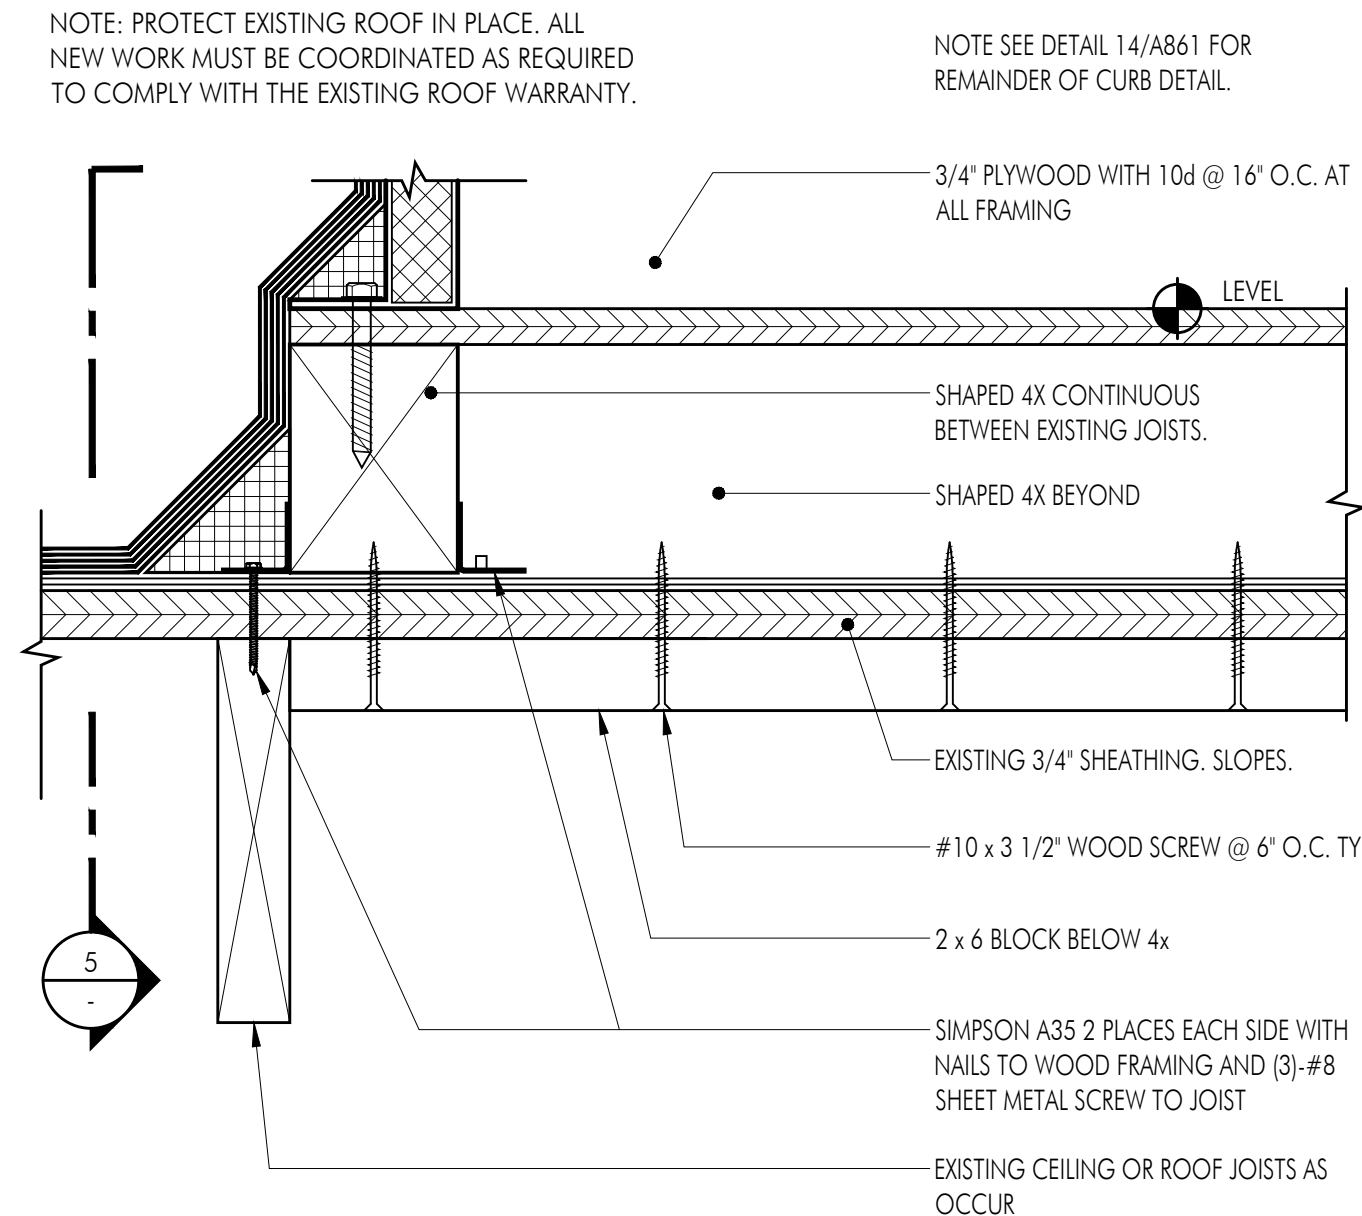


6 EXHAUST FAN CURB

SCALE: 3/4"=1'-0"

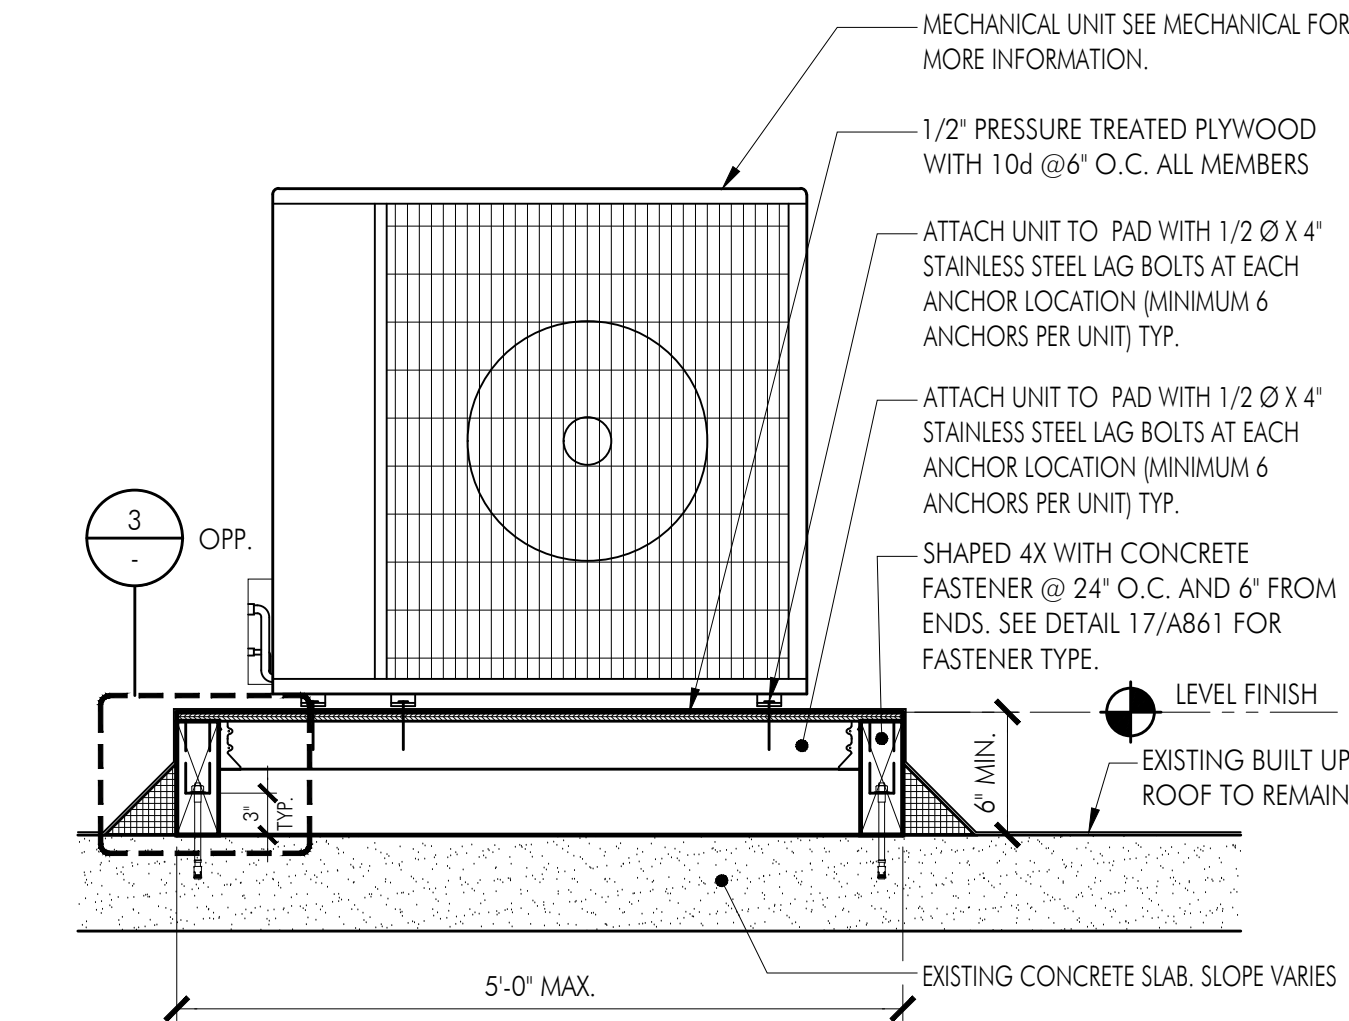

2 CONDENSER UNIT PLATFORM ON ROOF

SCALE: 3/4"=1'-0"

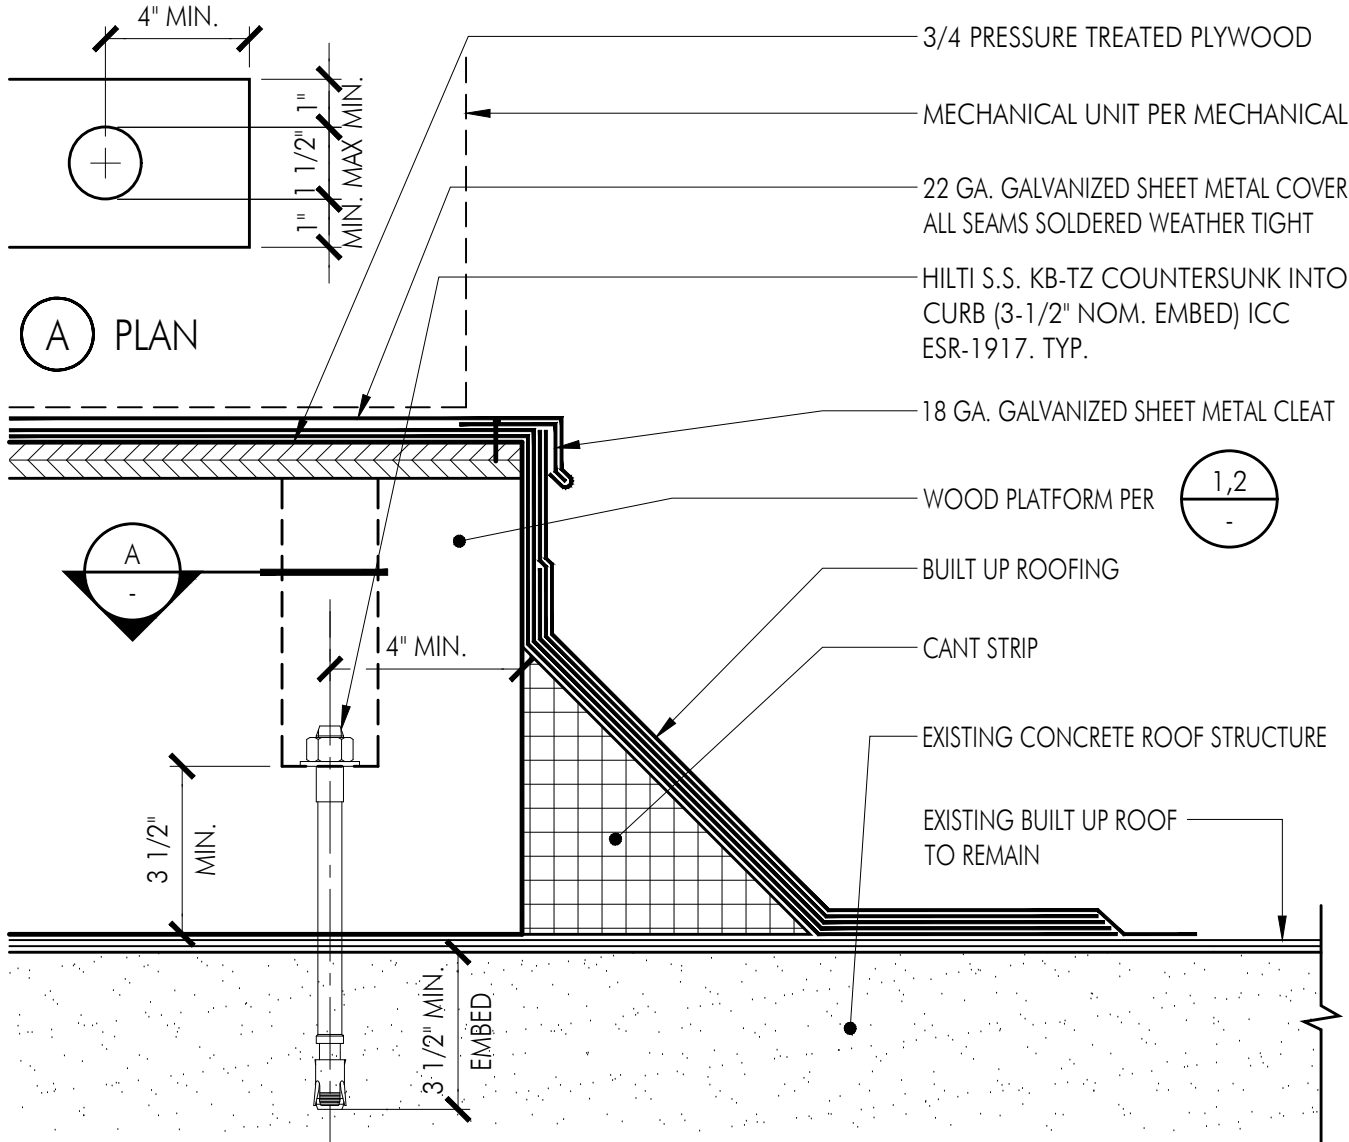

3 ROOFING AT CONCRETE PLATFORM

SCALE: 3/4"=1'-0"

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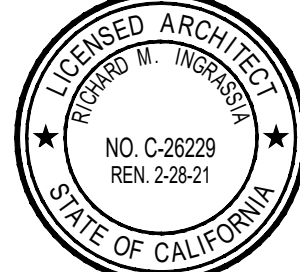
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Sheet Title

Roof Details

Sheet Number

A831

MEP COMPONENT ANCHORAGE NOTES

MEP Component Anchorage Note

All mechanical, Plumbing and electrical components shall be anchored and installed per the details on the DSA approved construction documents. Where no detail is indicated, the following components shall be anchored or braced to meet the force and displacement requirements prescribed in the 2016 CBC, Sections 1616A.1.18 through 1616A.1.26 and ASCE 7-10 Chapter 13, 26 and 30.

1) All permanent equipment and components.

2) Temporary or movable equipment that is permanently attached (e.g. hard wired) to the building utility services such as electricity, gas or water.

3) Movable equipment which is stationed in one place for more than 8 hours and heavier than 400 pounds aer required to be anchored with temporary attachments.

For those elements that do not require details on the approved drawings, the installation shall be subject to the approval of the design professional in general responsible charge or structural engineer delegated responsibility and the DSA District Structural Engineer. The project inspector will verify that all components and equipment have been anchored in accordance with above requirements.

Piping, Ductwork and Electrical Distribution System Bracing Note

Piping, ductwork and electrical distribution systems shall be braced to comply with the forces and displacements prescribed in ASCE 7-10 Section 13.3 as defined in ASCE 7-10 Section 13.6.5.6, 13.6.7, 13.6.8 and 2016 CBC, Sections 1616A.1.23, 1616A.1.24, 1616A.1.25 and 1616A.1.26.

The method of showing bracing and attachments to the structure for the identified distribution system are as noted below. When bracing and attachments are based on a preapproved installation guide (e.g., SMACNA or OSHPD OPM), copies of the bracing system installation guide or manual shall be available on the jobsite prior to the start of and during the hanging and bracing of the distribution systems. The Structural Engineer of Record shall verify the adequacy of the structure to support the hangar and brace loads.

Mechanical Piping (MP), Mechanical Ducts (MD), Plumbing Piping (PP), Electrical Distribution Systems (E):

MP□MD□PP□E□ - Option 1: Detailed on the approved drawings with project specific notes and details.

MP[X]MD[X]PP□E□ - Option 2: shall comply with the applicable OSHPD Pre-Approval (OPM) # OPM-0043-13 MASON WEST.

MP□MD□PP□ - Option 3: Shall comply with the SMACNA Seismic Restraint Manual, OSHPD Edition (2009), Including any addenda. Fasteners and other attachments not specifically identified in the SMACNA Seismic Restraint Manual, OSHPD Edition, are detailed on the approved drawings with project specific notes and details. The details shall account for the applicable Seismic Hazard Level_____and Connection Level_____for the project and conditions.

NOTES FOR CCR T24 MANDATORY MEASURES

1. GENERAL: ALL EQUIPMENT AND SYSTEMS INSTALLED IN THIS PROJECT SHALL COMPLY WITH THE 2016 ENERGY EFFICIENCY STANDARDS FOR NON RESIDENTIAL BUILDINGS, HIGH-RISE BUILDINGS, AND HOTELS/MOTELS AS PUBLISHED BY THE STATE OF CALIFORNIA.

2. EQUIPMENT AND SYSTEMS EFFICIENCY

A ANY CENTRAL AIR CONDITIONERS AND HEATERS MAY BE INSTALLED ONLY IF THE MANUFACTURER HAS CERTIFIED TO THE CALIFORNIA ENERGY COMMISSION, AS SPECIFIED IN THOSE REGULATIONS, THAT THE APPLIANCE COMPLIES WITH THE APPLICABLE STANDARD FOR THAT APPLIANCE.

B PIPING, EXCEPT THOSE CONVEYING FLUIDS AT TEMPERATURES BETWEEN 60 DEG F AND 105 DEF F, OR WITHIN HVAC EQUIPMENT SHALL BE INSULATED IN ACCORDANCE WITH ENERGY EFFICIENCY STANDARD 123.

C AIR HANDLING DUCT SYSTEMS SHALL BE CONSTRUCTED, INSTALLED, SEALED AND INSULATED AS PROVIDED IN CHAPTER 6 OF THE UNIFORM MECHANICAL CODE.

3. VENTILATION

A CONTROLS SHALL BE PROVIDED TO ALLOW OUTSIDE AIR DAMPERS OR DEVICES TO BE OPERATED AT THE VENTILATION RATES AS SPECIFIED IN THESE PLANS.

B GRAVITY OR AUTOMATIC DAMPERS INTERLOCKED AND CLOSED ON FAN SHUTDOWN SHALL BE PROVIDED ON THE OUTSIDE AIR INTAKES AND DISCHARGES OF ALL SPACE CONDITIONING AND EXHAUST SYSTEMS.

C ALL GRAVITY VENTILATING SYSTEMS SHALL BE PROVIDED WITH AUTOMATIC OR READILY ACCESSIBLE MANUALLY OPERATED DAMPERS IN ALL OPENINGS TO THE OUTSIDE, EXCEPT FOR COMBUSTION AIR OPENINGS.

D AIR BALANCING: ALL SPACE CONDITIONING AND VENTILATION SYSTEMS SHALL BE BALANCED IN THE QUANTITIES SPECIFIED IN THESE PLANS, IN ACCORDANCE WITH THE ASSOCIATED AIR BALANCE (AABC) NATIONAL STANDARDS.

E OUTSIDE AIR CERTIFICATION: THE SYSTEM SHALL PROVIDE THE MINIMUM OUTSIDE AIR AS SHOWN ON THE MECHANICAL DRAWINGS, AND SHALL BE MEASURED AND CERTIFIED BY THE INSTALLING LICENSED C-20 MECHANICAL CONTRACTOR.

4. BEFORE THE BUILDING MAY BE OCCUPIED, INSTALLATION CERTIFICATES FOR MANUFACTURED DEVICES REGULATED BY THE APPLIANCE STANDARDS OR PART 6, SHALL BE POSTED ADJACENT TO THE BUILDING PERMIT(S). CERTIFICATES SHALL:

A IDENTIFY FEATURES REQUIRED TO VERIFY COMPLIANCE WITH THE APPLIANCE STANDARDS AND PART 6.

B INCLUDE A STATEMENT THAT THE INSTALLED DEVICES CONFORM TO THE APPLIANCE STANDARDS AND PART 6 AND THE REQUIREMENTS FOR SUCH DEVICES GIVEN IN THE PLANS AND SPECIFICATIONS ARE APPROVED BY LOCAL ENFORCEMENT AGENCY.

C STATE THE BUILDING PERMIT NUMBER UNDER WHICH THE CONSTRUCTION OR INSTALLATION WAS PERFORMED.

5. THE BUILDER SHALL PROVIDE THE BUILDING OWNER, MANAGER, AND ORIGINAL OCCUPANTS THE FOLLOWING:

A A LIST OF THE HEATING, COOLING, WATER HEATING, AND LIGHTING SYSTEM & FEATURES, MATERIALS COMPONENTS, AND MECHANICAL DEVICES, CONSERVATION OR SOLAR DEVICES INSTALLED IN THE BUILDING, AND INSTRUCTIONS ON HOW TO USE THEM EFFICIENTLY.

B REQUIRED ROUTINE MAINTENANCE ACTION SHALL BE CLEARLY STATED AND INCORPORATED ON A READILY ACCESSIBLE LABEL. THE LABEL MAY BE LIMITED TO IDENTIFYING MAINTENANCE MANUAL, EXCEPTON: RESIDENTIAL OCCUPANCIES.

C A DESCRIPTION OF THE QUANTITIES OF OUTDOOR AND RECIRCULATED AIR THAT THE VENTILATION SYSTEM IS DESIGN TO PROVIDE TO EACH AREA, EXCEPTON: RESIDENTIAL OCCUPANCIES.

GENERAL NOTES

1. UNLESS OTHERWISE NOTED, THE WORK DESCRIBED ON THE PLANS AND SPECIFICATIONS SHALL INCLUDE THE FURNISHING AND INSTALLATION OF ALL LABOR AND MATERIALS NECESSARY FOR A COMPLETE AND OPERATIONAL HVAC SYSTEMS.

2. ALL WORK SHALL BE IN ACCORDANCE WITH ALL CODES, RULES, AND REGULATIONS OF GOVERNING AGENCIES AND SHALL COMPLY WITH THE REQUIREMENTS OF THE SERVING UTILITY COMPANIES.

3. ALL DUCTWORK, INSULATION, EQUIPMENT AND INSTALLATION SHALL CONFORM TO THE LATEST EDITION OF CALIFORNIA ADMINISTRATIVE CODE TITLE 24 AND C.M.C. DUCT MATERIALS AND CONSTRUCTION SHALL BE PER CHAPTER 6 OF C.M.C.

4. ALL EQUIPMENT, DUCTWORK AND PIPING INSTALLATION SHALL BE SEISMICALLY BRACED IN ACCORDANCE WITH THE LATEST EDITION OF S.M.A.C.N.A. (SEISMIC HAZARD LEVEL AA AND CONNECTION LEVEL 2), CALIFORNIA BUILDING AND MECHANICAL CODES.

5. PER CALIFORNIA MECHANICAL CODE SECTION 608, CONTRACTOR SHALL PROVIDE SHUTOFF FOR SMOKE CONTROL FOR ALL AIR-MOVING SYSTEMS SUPPLYING AIR IN EXCESS OF 2,000 CUBIC FEET PER MINUTE TO ENCLOSED SPACES WITHIN BUILDINGS. AUTOMATIC SHUTOFF SHALL BE ACCOMPLISHED BY INTERRUPTING THE POWER SOURCE OF THE AIR-MOVING EQUIPMENT UPON DETECTION OF SMOKE IN THE MAIN SUPPLY AIR DUCT SERVED BY SUCH EQUIPMENT. SMOKE DETECTORS WHICH WILL DETECT PRODUCTS OF COMBUSTION OTHER THAN HEAT AND WHICH COMPLY WITH THE CALIFORNIA BUILDING CODE, SHALL BE LABELED BY AN APPROVED AGENCY FOR AIR-DUCT INSTALLATION AND SHALL BE INSTALLED IN ACCORDANCE WITH THE MANUFACTURER'S INSTALLATION INSTRUCTIONS. SUCH DEVICES SHALL BE COMPATIBLE WITH THE OPERATING VELOCITIES, PRESSURES, TEMPERATURES AND HUMIDITIES OF THE SYSTEM, WHERE FIRE DETECTION OR ALARM SYSTEMS ARE PROVIDED FOR THE BUILDING, THE SMOKE DETECTORS REQUIRED BY THIS SECTION SHALL BE SUPERVISED BY SUCH SYSTEMS AND SHALL ACTIVATE THE FIRE ALARM SYSTEM. REFER TO THE DDC CONTROL DOCUMENTS FOR SMOKE CONTROL AND SPECIFIC REQUIREMENTS AND CONTROLS FOR THIS SYSTEM

6. INFORMATION GIVEN ON THE DRAWING IS AS EXACT AS POSSIBLE. ABSOLUTE ACCURACY IS NOT GUARANTEED, AND THE CONTRACTOR SHALL OBTAIN AND VERIFY EXACT LOCATIONS, MEASUREMENTS, LEVEL, SPACE REQUIREMENTS, POTENTIAL CONFLICTS WITH OTHER TRADES AT THE SITE AND SHALL SATISFACTORILY ADAPT HIS WORK TO ACTUAL CONDITIONS AT THE BUILDING.

7. COORDINATE AND ADJUST ALL WORK BETWEEN TRADES IN ORDER TO ACCOMPLISH A COORDINATED, INTEGRATED AND EFFICIENT INSTALLATION.

8. COORDINATE EXACT LOCATION OF ALL CEILING DIFFUSERS, REGISTERS AND GRILLES WITH LIGHTING LAYOUT, CEILING TILE PATTERN AND WITH ARCHITECTURAL REFLECTED CEILING PLANS. IN CASE OF CONFLICT, ARCHITECTURAL REFLECTED CEILING PLANS WILL TAKE PRECEDENCE.

9. WHERE CEILING IS EXTREMELY TIGHT, CAREFULLY COORDINATE DUCT SIZES AND ROUTING WITH ARCHITECTURAL, STRUCTURAL, ELECTRICAL, PLUMBING AND FIRE PROTECTION SYSTEMS. WHERE INTERFERENCES EXIST TRANSITION TO SUITABLE RECTANGULAR DUCTWORK TO MAINTAIN REQUIRED CEILING HEIGHT.

10. FIELD COORDINATE THE EXACT LOCATION OF ALL TEMPERATURE SENSORS, THERMOSTATS WITH ANY EQUIPMENT, SHELVING, RACKS, CABINETS OR OTHER FACILITY SUPPLIED FURNITURE AND EQUIPMENT, BASED ON THE ARCHITECTURAL DRAWINGS.

11. UNLESS SPECIFICALLY SHOWN ON THESE PLANS, NO STRUCTURAL MEMBER SHALL BE CUT, DRILLED OR NOTCHED WITHOUT WRITTEN AUTHORIZATION FROM THE STRUCTURAL ENGINEER AND ARCHITECT.

12. PROVIDE MANUAL VOLUME DAMPER UPSTREAM OF EACH AIR INLET/OUTLET TO FACILITATE PROPER BALANCE, WHETHER SHOWN OR NOT. VOLUME DAMPER AT DIFFUSERS AND REGISTERS SHALL NOT BE USED FOR AIR BALANCING.

13. SEAL ALL OPENINGS AROUND PIPING AND DUCTWORK PENETRATING FIRE RESISTIVE RATED WALLS AND FLOORS TO MAINTAIN RATING INTEGRITY.

14. CONTRACTOR SHALL COORDINATE DEVICES REQUIRING ACCESS. PROVIDE CEILING, WALL OR FLOOR ACCESS PANELS FOR TERMINAL BOXES, VALVES, COMBINATION SMOKE/FIRE DAMPERS AND VOLUME DAMPERS, ACTUATORS, BACK-DRAFT DAMPERS AS REQUIRED. COORDINATE WITH ARCHITECT FOR EXACT LOCATION OF ACCESS PANELS. MINIMUM SIZE OF ACCESS PANELS SHALL BE 18" X 18".

15. INSTALL EQUIPMENT IN ACCESSIBLE LOCATIONS AND PROVIDE ADEQUATE SERVICE CLEARANCE FOR NORMAL MAINTENANCE WITHOUT REMOVING ARCHITECTURAL, ELECTRICAL OR STRUCTURAL ELEMENTS.

16. FLEXIBLE DUCT LENGTH SHALL NOT EXCEED 6'-0". MINIMUM RADIUS SHALL BE 1-1/2 DIAMETER OF DUCT. FLEXIBLE DUCT SHALL NOT BE USED IN SYSTEM UTILIZED AS PART OF THE BUILDING SMOKE CONTROL.

17. PROVIDE ISOLATION VALVES AND UNIONS ON PIPING ADJACENT TO ALL CONTROL VALVES AND OTHER APPURTENANCES OR EQUIPMENT. LOCATE VALVES SO THAT EQUIPMENT CAN BE REMOVED WITHOUT DISMANTLING ANY BRANCH LINES.

18. PROVIDE CONCEALED MANUAL VOLUME DAMPER REGULATOR AT ALL ACCESSIBLE LOCATIONS.

19. ALL CURBS, ROOF JACKS AND EQUIPMENT SUPPORT PADS SHALL BE COMPATIBLE WITH ROOFING SYSTEM.

20. REFER TO PLUMBING DRAWINGS OR ALL CONDENSATE DRAIN PIPING.

21. A MAINTENANCE LABEL SHALL BE AFFIXED TO MECHANICAL EQUIPMENT. A MAINTENANCE MANUAL SHALL BE PROVIDED FOR THE OWNERS USE. LABEL EACH ROOF MOUNTED EQUIPMENT TO IDENTIFY THE AREA IT SERVES. SEE SPECIFICATIONS.

22. ALL DUCTWORK AND EQUIPMENT WHICH IS EXPOSED SHALL BE APPLIED WITH PRIMER AND ENAMEL PAINT. COLOR SHALL BE SELECTED BY THE ARCHITECT. ALL DUCTWORK EXPOSED UNDER THE CEILING SHALL BE PAINTED WITH PRIMER AND ENAMEL PAINT TO MATCH THE SURROUNDINGS.

23. PROVIDE SHEET METAL WEATHER HOOD COVER FOR ALL DAMPER ACTUATORS, SMOKE DETECTOR, MOTORS LOCATED OUTDOORS.

24. WHERE ATTIC IS TO BE USED AS RETURN PLENUM, IT SHALL CONTAIN NO COMBUSTIBLE MATERIALS LIKE SLEEVES GAS PIPE, PLASTIC PIPE OR RUBBER INSULATION. ALL CEILING MATERIALS SHALL BE NON-COMBUSTIBLE UNLESS APPROVED IN PLENUM INSTALLATION.

25. PROVIDE WALL OPENING ABOVE CEILING LEVEL FOR RETURN AIR IN EACH ROOM AS REQUIRED.

26. FIRE DAMPERS INSTALLED IN DUCTWORK SYSTEM WITHOUT AUTOMATIC SHUT-DOWN SHALL BE U.L. LISTED DYNAMIC TYPE (SPRING LOADED).

27. PROVIDE SECURITY BARS ON ALL EXHAUST FAN OPENINGS AND GRAVITY VENT OPENINGS THROUGH HE ROOF GREATER THAN 16"x16".

28. AIR HANDLING DUCT SYSTEM, EXCEPT GREASE EXHAUST DUCT SYSTEM, SHALL BE CONSTRUCTED, INSTALLED AND INSULATED AS PROVIDED IN CHAPTER 6 OF 2016 CMC.

29. ALL WORK SHALL BE IN ACCORDANCE WITH IAQ GUIDELINES FOR OCCUPIED BUILDINGS UNDER CONSTRUCTION SECOND EDITION.

ABBREVIATIONS			
AFF	ABOVE FINISHED FLOOR	EER	ENERGY EFFICIENCY RATIO
AHU	AIR HANDLING UNIT	EF	EXHAUST FAN
AMB.	AMBIENT	ENT	ENTERING
ARCH	ARCHITECT OR ARCHITECTURAL	ESP	EXTERNAL STATIC PRESSURE
B	BOILER	EXH	EXHAUST
BHP	BRAKE HORSE POWER	"F OR F	DEGREES FAHRENHEIT
BTUH	BRITISH THERMAL UNIT PER HOUR	FCU	FAN COIL UNIT
CAV	CONSTANT AIR VOLUME	FLA	FULL LOAD AMP.
CF	CAPPED FOR FUTURE	FPI	FINS PER INCH
CD	CEILING DIFFUSER	FFM	FEET PER MINUTE
CFM	CUBIC FEET PER HOUR	GAL.	GALLON
CFM	CUBIC FEET PER MINUTE	HP	HORSEPOWER
CLG	CEILING	HZ	HERTZ
COP	COEFFICIENT OF PERFORMANCE	IN. W.G.	INCH OF WATER COLUMN
CV	CONSTANT VOLUME	IN. W.G.	INCH OF WATER GAUGE
DB	DRY-BULB	KBTUH	THOUSAND BTU PER HOUR
DIFF	DIFFUSER	LBS	POUNDS
DN	DOWN	MAX.	MAXIMUM
DS	DUCT SILENCER	MCA	MINIMUM CIRCUIT AMP
DWG	DRAWING	MCC	MOTOR CONTROL CENTER
(E)	EXISTING	MIN.	MINIMUM
EAG	EXHAUST AIR GRILLE		
		(N)	NEW
		NC	NOISE CRITERIA
		OA	OUTSIDE AIR
		OPNG	OPENING
		P	PUMP
		QTY.	QUANTITY
		RA	RETURN AIR
		RAG	RETURN AIR GRILLE
		RLA	RUNNING LOAD AMP
		RFM	REVOLUTIONS PER MINUTE
		SA	SUPPLY AIR
		SAP	SUPPLY AIR GRILLE
		SG	STATIC PRESSURE
		SF	SQUARE FEET
		ST	SOUND TRAP
		TG	TRANSFER GRILLE
		TYP	TYPICAL
		UNO	UNLESS NOTED OTHERWISE
		UTR	UP THROUGH ROOF
		VAV	VARIABLE AIR VOLUME
		VTR	VENT THROUGH ROOF

2016 CALIFORNIA GREEN BUILDING STANDARDS CODE

5.410.4 TESTING, ADJUSTING AND BALANCING: DURING CONSTRUCTION TAPE/BLANK OFF AND SEAL HVAC EQUIPMENT OPENINGS FROM CONSTRUCTION DEBRIS, DUST, AND WATER. CLOSE GRILLES, AIR OPENINGS, AND FIN COILS TO PREVENT CONTAMINATION INSIDE/OUTSIDE TO THE EQUIPMENT, TO THE FILTERS, AND THE DUCTWORK. DO NOT OPERATE THE EQUIPMENT AND DUCTWORK DURING THE CONSTRUCTION PERIOD UNTIL AFTER APPROVED CLEAN-UP IS COMPLETE. COVER EQUIPMENT AND PANELS TO PREVENT WEATHER, SPLASH AND WATER ENTRY. ANY ELECTRICAL PANELS AND COMPONENTS EXPOSED TO WATER OR DUST WILL NEED TO BE REPLACED AT NO COST TO THE OWNER.

5.410.4.2 SYSTEMS: PROCEDURE FOR TESTING, ADJUSTING, BALANCING AND COMMISSIONING OF PACKAGED ROOFTOP GAS ELECTRIC AIR CONDITIONERS/AIR ECONOMIZERS AND RESTROOM/JANITOR ROOM EXHAUST, FANS SHALL BE IN ACCORDANCE WITH AABC PUBLISHED STANDARDS.

5.410.4.3 PROCEDURES: VERIFY POINT TO POINT ALL FUNCTIONS ARE OPERATIONAL INCLUDING START/STOP, TEMPERATURE CONTROL SETPOINTS PER T24, AIR ECONOMIZER SETPOINTS LOW/HIGH LIMIT, SMOKE DETECTOR SHUTDOWN AND ALARM, GAS HEATING OPERATION AND FAN CONTROL, COOLING OPERATION WITH EVAPORATOR AIRFLOW AND CONDENSER AIRFLOW AND TEMPERATURE AND REFRIGERANT PRESSURE READINGS. CHECK DUCT STATIC PRESSURE IN/OUT OF UNITS AND FANS. CHECK BACKDRAFT DAMPER OPERATION OPEN/CLOSE ON UNIT START/SHUTDOWN. CHECK CONDENSATE TRAP IS FLOWING WITH NO WATER STANDING IN THE PAN UNDER ALL OPERATING CONDITIONS INCLUDING DIRTY FILTER.

5.410.4.3.1 HVAC BALANCING: CHECK FILTERS ARE INSTALLED PROPERLY AND ARE CORRECT MERV RATING FOR THE APPLICATION PER PLANS. CHECK MOTOR SPEED AND AMPS; FAN SPEED, ADJUST ACCORDINGLY. CHECK TIME/CLOCK IS FUNCTIONAL AND SET PROPERLY. AC AND EXHAUST FANS SHALL RUN CONTINUOUSLY DURING OCCUPIED HOURS 6AM TO 9PM. VERIFY OUTSIDE AIR SETTINGS ARE IN ACCORDANCE WITH DESIGN QUANTITIES ON PLANS. CHECK ALL AIR OUTLETS AND AIR INLETS ARE SET IN ACCORDANCE WITH AIR QUANTITIES ON THE PLANS.

5.410.4.4 REPORTING: DELIVER WRITTEN POINT TO POINT COMMISSIONING FUNCTIONALITY REPORT AND TEST AND BALANCE REPORT.

5.410.4.5 OPERATION AND MAINTENANCE MANUALS: MANUFACTURER'S OPERATION AND MAINTENANCE MANUALS AND SPARE PARTS LISTS ENCLOSED UNDER A SINGLE PROPERLY LABELED LAMINATED BINDER FOR INSPECTOR REVIEW.

5.410.4.5.1 INSPECTIONS AND REPORTS: INSPECTIONS AND REPORTS DOCUMENTING THE ENTIRE SYSTEM HAS BEEN INSPECTED AND APPROVED BY THE ENFORCING AGENCY.

5.504.1.3 TEMPORARY VENTILATION. IF THE HVAC SYSTEM IS USED DURING CONSTRUCTION, USE RETURN AIR FILTERS WITH A MERV OF 8, BASED ON ASHRAE 52.2-1999, OR AN AVERAGE EFFICIENCY OF 30% BASED ON ASHRAE 52.1-1992. REPLACE ALL FILTERS IMMEDIATELY PRIOR TO OCCUPANCY. APPLIES TO ADDITIONS OR ALTERATIONS.

5.504.3 COVERING OF DUCT OPENINGS AND PROTECTION OF MECHANICAL EQUIPMENT DURING CONSTRUCTION AT THE TIME OF ROUGH INSTALLATION AND DURING STORAGE ON THE CONSTRUCTION SITE AND UNTIL FINAL STARTUP OF THE HEATING, COOLING AND VENTILATING EQUIPMENT, ALL DUCT AND OTHER RELATED AIR DISTRIBUTION COMPONENT OPENINGS SHALL BE COVERED WITH TAPE, PLASTIC, SHEET/METAL OR OTHER METHODS ACCEPTABLE TO THE ENFORCING AGENCY TO REDUCE THE AMOUNT OF DUST, WATER AND DEBRIS WHICH MAY ENTER THE SYSTEM.

5.504.5.3 FILTERS. IN MECHANICALLY VENTILATED BUILDINGS, PROVIDE REGULARLY OCCUPIED AREAS OF THE BUILDING WITH AIR FILTRATION MEDIA FOR OUTSIDE AND RETURN AIR THAT PROVIDES AT LEAST A MERV OF 8. MERV 8 FILTERS SHALL BE INSTALLED PRIOR TO OCCUPANCY, AND RECOMMENDATIONS FOR MAINTENANCE WITH FILTERS OF THE SAME VALUE SHALL BE INCLUDED IN THE OPERATION AND MAINTENANCE MANUAL. EXCEPTIONS:

1. AN ASHRAE 10-PERCENT TO 15-PERCENT EFFICIENCY FILTER SHALL BE PERMITTED FOR AN HVAC UNIT MEETING THE 2016 CALIFORNIA ENERGY CODE HAVING 60,000 BTU/H OR LESS CAPACITY PER FAN COIL, IF THE ENERGY USE OF THE AIR DELIVERY SYSTEM IS 0.4 W/CFM OR LESS AT DESIGN AIR FLOW.

2. EXISTING MECHANICAL EQUIPMENT.



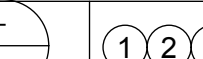

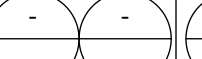
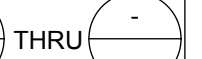
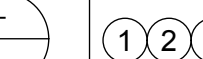







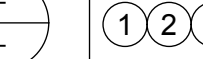



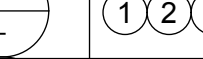



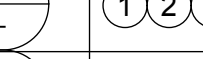


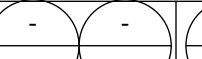
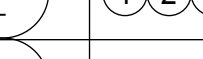
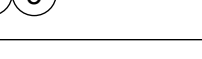
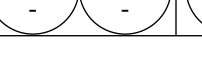




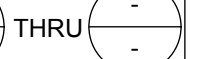
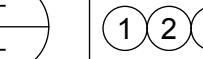

5.504.5.3.1 LABELING. INSTALLED FILTERS SHALL BE CLEARLY LABELED BY THE MANUFACTURER INDICATING THE MERV RATING.

5.506.1 OUTSIDE AIR DELIVERY: FOR MECHANICALLY OR NATURALLY VENTILATED SPACES IN BUILDINGS, MEET THE MINIMUM REQUIREMENTS OF SECTION 121 OF THE CA ENERGY CODE AND CHAPTER 4 OF CCR, TITLE 8 OR THE APPLICABLE LOCAL CODE, WHICHEVER IS MORE STRINGENT.



APPLICABLE CODES	
2016 CALIFORNIA BUILDING STANDARDS ADMINISTRATIVE CODE, PART 1, TITLE 24 C.C.R.	
2016 CALIFORNIA BUILDING CODE, PART 2, TITLE 24 C.C.R. (2015 INTERNATIONAL BUILDING CODE WITH 2016 CALIFORNIA AMENDMENTS)	
2016 CALIFORNIA ELECTRICAL CODE, PART 3, TITLE 24 C.C.R. (2014 NATIONAL ELECTRICAL CODE WITH 2016 CALIFORNIA AMENDMENTS)	
2016 CALIFORNIA MECHANICAL CODE, PART 4, TITLE 24 C.C.R. (2015 UNIFORM MECHANICAL CODE WITH 2016 CALIFORNIA AMENDMENTS)	
2016 CALIFORNIA PLUMBING CODE, PART 5, TITLE 24 C.C.R. (2015 UNIFORM PLUMBING CODE WITH 2016 CALIFORNIA AMENDMENTS)	
2016 CALIFORNIA ENERGY CODE, PART 6, TITLE 24 C.C.R.	
2016 CALIFORNIA FIRE CODE, PART 9, TITLE 24 C.C.R. (2015 INTERNATIONAL FIRE CODE AND 2016 CALIFORNIA AMENDMENTS)	
2016 CALIFORNIA GREEN BUILDING STANDARDS CODE, PART 11, TITLE 24 C.C.R.	
2016 CALIFORNIA REFERENCE STANDARDS CODE, PART 12, TITLE 24 C.C.R.	

SYMBOL		ABBREV.	DESCRIPTION
DOUBLE	SINGLE		
		SA	C
		SA	C
DOUBLE	SINGLE	EXH	E
		EXH	E
		EXH	E
DOUBLE	SINGLE	RA	R
		RA	R
		RA	R
DOUBLE	SINGLE	48X24(L)	48X24(L)
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

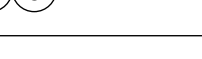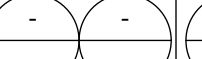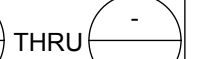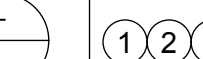
P GAS ELECTRIC PACKAGED UNIT SCHEDULE

ROOF TOP GAS ELECTRIC PACKAGED UNIT SCHEDULE																																										
TAG	MANUFACTURER		TONS	ELECTRICAL FOR RTU				ELECTRICAL FOR POWER EXHAUST (P.E)					ECONOMIZER	SUPPLY FAN		MIN OSA CFM	COOLING CAPACITY				EVAPORATOR COIL				HEATING			WEIGHT (LBS)				MOUNT'G DETAIL	SEISMIC DETAILS	CONTROL DETAIL	REMARKS							
	MAKE	MODEL		POWER	BHP	MCA	MOCP	MAKE MODEL & TYPE	INT SP IN.WG.	HP	FLA	MCA		MOCP	POWER		MAKE & MODEL	CFM	TOTAL SP IN.WG.	TOTAL (MBH)	SENSIBLE (MBH)	EER/IEER	SEER	EDB (°F)	EWB (°F)	LDB (°F)	LWB (°F)	INPUT (MBH)	OUTPUT (MBH)	EFF % (AFUE)	RTU					CURB	P.E/ECON	TOTAL				
BUILDING C																																										
RTU-2-1	CARRIER	48LCD008A2A6-0A0A0	7.5	460V-3Ø-60HZ	1.69	23	25	CANFAB MODEL 1178-MHPE 015	0.75	1.5	3.2	4.0	7.2	460V-3Ø-6Ø	CANFAB MODEL 1178-MHPE 015	3000	1.0	-	-	-	-	-	80.0	67.0	58.3	57.2	150.0	120.0	80.0	1651	475	340	2466			THRU			1 2 3 4 5			
RTU-2-2	CARRIER	48GCLM06A2A6-0A0A0	5	460V-3Ø-60HZ	0.95	13	15	CANFAB MODEL 1120-MHPE 010	0.75	1.0	2.4	3.0	5.4	460V-3Ø-6Ø	CANFAB MODEL 1120-MHPE 010	2000	1.0	-	-	-	-	-	80.0	67.0	57.6	57.1	60.0	49.0	82.0	600	310	200	1110			THRU			1 2 3 4 5			
RTU-2-3	CARRIER	48LCD008A2A6-0A0A0	7.5	460V-3Ø-60HZ	1.69	23	25	CANFAB MODEL 1178-MHPE 015	0.75	1.5	3.2	4.0	7.2	460V-3Ø-6Ø	CANFAB MODEL 1178-MHPE 015	3000	1.0	-	-	-	-	-	80.0	67.0	58.3	57.2	150.0	120.0	80.0	1651	475	340	2466			THRU			1 2 3 4 5			
RTU-2-4	CARRIER	48GCLM05A2A6-0A0A0	4	460V-3Ø-60HZ	0.69	11	15	(NONE)							CANFAB MODEL 1105-HCE	1600	1.0	-	-	-	-	-	80.0	67.0	58.6	57.2	60.0	49.0	82.0	555	310	140	1005			THRU			1 2 3 5 6			
RTU-2-5	CARRIER	48LCD008A2A6-0A0A0	7.5	460V-3Ø-60HZ	1.69	23	25	CANFAB MODEL 1178-MHPE 015	0.75	1.5	3.2	4.0	7.2	460V-3Ø-6Ø	CANFAB MODEL 1178-MHPE 015	3000	1.0	-	-	-	-	-	80.0	67.0	58.3	57.2	150.0	120.0	80.0	1651	475	340	2466			THRU			1 2 3 4 5			
RTU-2-6	CARRIER	48LCD008A2A6-0A0A0	7.5	460V-3Ø-60HZ	1.69	23	25	CANFAB MODEL 1178-MHPE 015	0.75	1.5	3.2	4.0	7.2	460V-3Ø-6Ø	CANFAB MODEL 1178-MHPE 015	3000	1.0	-	-	-	-	-	80.0	67.0	58.3	57.2	150.0	120.0	80.0	1651	475	340	2466			THRU			1 2 3 4 5			
RTU-2-7	CARRIER	48GCLM06A2A6-0A0A0	5	460V-3Ø-60HZ	0.95	13	15	CANFAB MODEL 1120-MHPE 010	0.75	1.0	2.4	3.0	5.4	460V-3Ø-6Ø	CANFAB MODEL 1120-MHPE 010	2000	1.0	-	-	-	-	-	80.0	67.0	57.6	57.1	60.0	49.0	82.0	600	310	200	1110			THRU			1 2 3 4 5			
RTU-2-8	CARRIER	48GCLM05A2A6-0A0A0	4	460V-3Ø-60HZ	0.69	11	15	(NONE)							CANFAB MODEL 1105-HCE	1600	1.0	-	-	-	-	-	80.0	67.0	58.6	57.2	60.0	49.0	82.0	555	310	140	1005			THRU			1 2 3 5 6			
BUILDING G																																										
RTU-1-1	CARRIER	48GCLM05A2A5-0A0A0	4	2Ø8V-3Ø-60HZ	0.84	26	30	(NONE)							CANFAB MODEL 1178-MHPE030	1600	1.0	-	-	-	-	-	80.0	67.0	58.6	57.2	60.0	49.0	81.0	555	127	185	867			THRU			1 2 3 5 6			
REMARKS	① PROVIDE DUCT SMOKE DETECTOR ON SA DUCT PER FIRE ALARM DRAWINGS. PROVIDE CO MONITORS PER 2016 CBC 915. SEE FA SHEETS E8-3 THROUGH E8-11 AND 2/M701 FOR FURTHER INFORMATION.							② PROVIDE 2" MERV 11 FILTER, PROGRAMMABLE THERMOSTAT TIED TO RTU AND 1" ISOLATION ADJUSTABLE / PITCHED ROOF CURB.							③ PROVIDE ALL NECESSARY CONTROLS, EQUIPMENT, PROGRAMMING, WIRING AND CONDUITS FOR CONNECTION EXISTING CAMPUS EMS.							④ PROVIDE 0-100% FULLY MODULATING ECONOMIZER AND INTEGRAL POWER EXHAUST WITH DRY-BULB INTEGRATED CONTROL MOUNTED AT THE SHORT END OF THE AC UNIT. PROVIDE DUAL, SEPARATE POWER TO UNIT AND POWER EXHAUST. PROVIDE CARBON DIOXIDE (CO2) SENSOR FOR DCV CONTROL.							⑤ PROVIDE ISOLATION ROOF CURB.							⑥ PROVIDE 0-100% FULLY MODULATING ECONOMIZER WITH DRY-BULB INTEGRATED CONTROL AND BAROMETRIC RELIEF. PROVIDE CARBON DIOXIDE (CO2) SENSOR FOR DCV CONTROL.						


SUPPLY AIR GRILLES

SIDEWALL SUPPLY REGISTER SCHEDULE						
SUPPLY AIR GRILLES						
MARK OR SYMBOL ^③	TYPE	NECK SIZE ^①	FACE DIM ^②	CFM RANGE	DUCT CONN SIZE ^④	REMARKS
<div>SWS CFM</div> <div> →</div> <div>ONE WAY FLOW</div> <div></div> <div>TWO WAY FLOW</div>	LOWERED FACE DIFFUSERS WITH DIRECTIONAL AIR PATTERN AND FINISHED WITH SQUARE TO ROUND TRANSITION INLET COLLAR FOR EASY DUCT CONNECTION. FOR EASY D					

SUPPLY AIR DIFFUSERS










<p>FLOW</p>  <p>TWO WAY FLOW</p> <p>CORNER FLOW</p>	<p>LOWERED FACE DIFFUSERS WITH DIRECTIONAL AIR PATTERN & VOLUME DAMPER IN BRANCH DUCT.</p> <p>MANUFACTURER TITUS MCD-AA (U.N.O.)</p>
<p>THREE WAY FLOW</p>  <p>FOUR WAY FLOW</p> 	

RETURN & EXHAUST REGISTERS / GRILLES


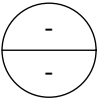

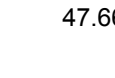
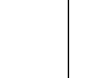
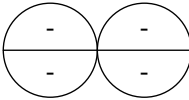

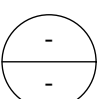

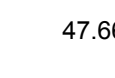
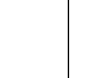
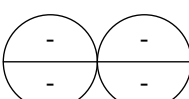
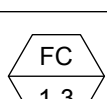
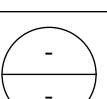
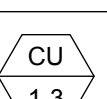
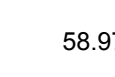
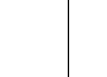
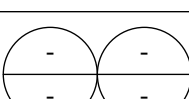
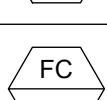
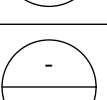
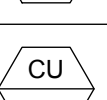
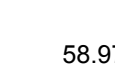
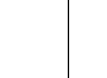




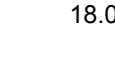
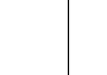
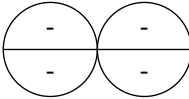

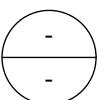

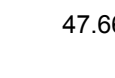
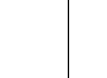
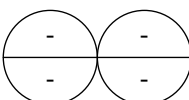

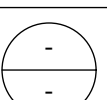
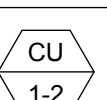
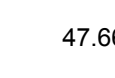
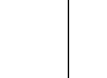
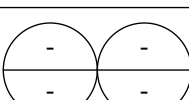

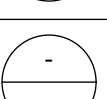
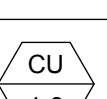
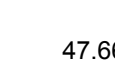
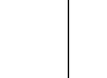

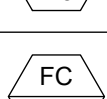
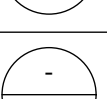
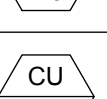
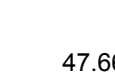
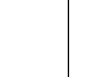
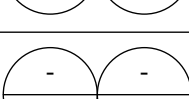

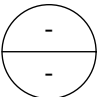

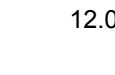
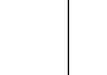
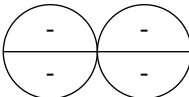

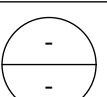

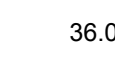
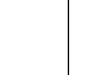
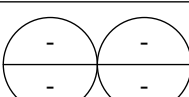
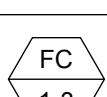
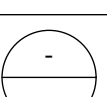
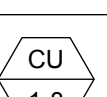

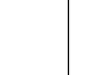
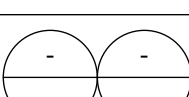
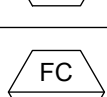
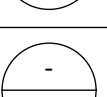
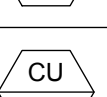
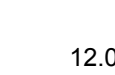
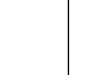
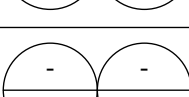
EG	OR		EG
			CFM
			OR
			RG
			CFM


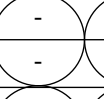
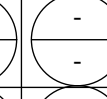

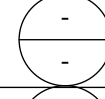

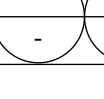
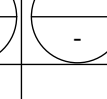
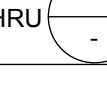
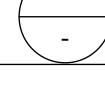
PERFORATED FACE EXHAUST OR RETURN GRILL WITH VOLUME DAMPER IN BRANCH DUCT.

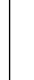MARK			
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<p>REMARKS:</p> <p>① MAXIMUM OFFICES A</p> <p>② ALL EXPO DRAWINGS</p>								

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SPLIT HEAT PUMP SCHEDULE - INDOOR UNIT														SPLIT HEAT PUMP SCHEDULE - OUTDOOR UNIT																
SYMBOL	MANUFACTURER AND MODEL NO.	ROOM SERVED	AIRFLOW CFM	ESP IN	AMBIENT DB- °F.	LVG. AIR DB/WB °F.	ELECTRICAL				OPERATING WEIGHT (LBS.)	ANCHORAGE DETAIL	REMARKS	SYMBOL	MANUFACTURER AND MODEL NO.	COOLING CAPACITY (MBH)	HEATING CAPACITY (MBH)	SEER	EER	HSPF	ELECTRICAL				REFRIGERANT LINES		OPERATING WEIGHT (LBS.)	ANCHORAGE DETAIL	REMARKS	
							FLA	MCA	MCOP	V-Ø-HZ											FLA	MCA	MCOP	V-Ø-HZ	SUCTION	LIQUID				
BUILDING A																														
	CARRIER FV4CNB006L00	-	1600	0.85	80	<div>58.92 57.67</div>	6.8	8.5	15	208-1-60	210		1 2		CARRIER 25HHA448A005	47.66	47.09	15	12.0	8.5	-	18.6	30	208-3-60			280		2 3	
	CARRIER FV4CNB006L00	-	1600	0.85	80	<div>58.92 57.67</div>	6.8	8.5	15	208-1-60	210		1 2		CARRIER 25HHA448A005	47.66	47.09	15	12.0	8.5	-	18.6	30	208-3-60			280		2 3	
	CARRIER FV4CNB006L00	-	1840	1.0	80	<div>57.23 56.87</div>	6.8	8.5	15	208-1-60	210		1 2 9		CARRIER 25HHA460A005	58.97	56.94	14	11.0	8.2	-	22.9	40	208-3-60			290		2 3	
	CARRIER FV4CNB006L00	-	1840	1.0	80	<div>57.23 56.87</div>	6.8	8.5	15	208-1-60	210		1 2 9		CARRIER 25HHA460A005	58.97	56.94	14	11.0	8.2	-	22.9	40	208-3-60			290		2 3	
BUILDING B																														
	SAMSUNG AR18NSWCWKNCV	-	550	-	-	<div>- -</div>	-	-	-	-	32		1 6		SAMSUNG AR18NSWCWKXCV	18.0	20.6	20.0	13.0	10.0	-	19.0	30	208-1-60			124			
BUILDING CDC																														
	CARRIER FV4CNB006L00	-	1600	0.85	80	<div>58.92 57.67</div>	6.8	8.5	15	208-1-60	210		1 2		CARRIER 25HHA448A005	47.66	47.09	15	12.0	8.5	-	18.6	30	208-3-60			280		2 3	
	CARRIER FV4CNB006L00	-	1600	0.85	80	<div>58.92 57.67</div>	6.8	8.5	15	208-1-60	210		1 2		CARRIER 25HHA448A005	47.66	47.09	15	12.0	8.5	-	18.6	30	208-3-60			280		2 3	
	CARRIER FV4CNB006L00	-	1600	0.85	80	<div>58.92 57.67</div>	6.8	8.5	15	208-1-60	210		1 2		CARRIER 25HHA448A005	47.66	47.09	15	12.0	8.5	-	18.6	30	208-3-60			280		2 3	
	CARRIER FV4CNB006L00	-	1600	0.85	80	<div>58.92 57.67</div>	6.8	8.5	15	208-1-60	210		1 2		CARRIER 25HHA448A005	47.66	47.09	15	12.0	8.5	-	18.6	30	208-3-60			280		2 3	
BUILDING D																														
	SAMSUNG AR12MSWCWKNCV	-	350	-	-	<div>- -</div>	-	-	-	-	23		1 6		SAMSUNG AR12MSWCWKXCV	12.0	13.6	19.5	11.4	9.5	-	11.1	15	208-1-60			73			
	SAMSUNG AC036NN4DCH/AA	-	1020	-	-	<div>- -</div>	-	-	-	-	55		1 6		SAMSUNG AC036JXADCH/AA	36.0	40.0	20.5	12.1	9.5	-	22.08	35	208-1-60			194			
	SAMSUNG AR12MSWCWKNCV	-	350	-	-	<div>- -</div>	-	-	-	-	23		1 6		SAMSUNG AR12MSWCWKXCV	12.0	13.6	19.5	11.4	9.5	-	11.1	15	208-1-60			73			
	SAMSUNG AR12MSWCWKNCV	-	350	-	-	<div>- -</div>	-	-	-	-	23		1 6		SAMSUNG AR12MSWCWKXCV	12.0	13.6	19.5	11.4	9.5	-	11.1	15	208-1-60			73			
1	PROGRAMMABLE THERMOSTAT, SECONDARY DRAIN FACTORY KIT																													
2	COMPLETE WITH DOWNFLOW BASE KIT AND PIPE STRAP																													
3	GROSS COOLING CAPACITY BASED ON 95° F TEMPERATURE OF AIR ENTERING CONDENSER.																													
4	REFRIGERANT PIPING SHALL BE INSULATED WITH SHEET METAL JACKETS																													
5	REFRIGERANT PIPING TO BE SIZED BY HEAT PUMP MANUFACTURER PROVIDE LONG LINE ACCESSORIES AS NEEDED																													
6	POWERED FROM OUTDOOR UNIT																													
7	PROVIDE OSA CONNECTION KIT																													
8	PROVIDE OVERFLOW SWITCH AND CONDENSATE PUMP AND INTERLOCKED WITH FAN COIL UNIT.																													
8	PROVIDE MIXIGN BOX AT BOTTOM OF THE FAN COIL UNIT.-PROVIDE SEPARATE POWER FOR MIXING BOX.																													

ROOF TOP HEAT PUMP PACKAGED UNIT SCHEDULE																																							
TAG	MANUFACTURER		TONS	ELECTRICAL FOR RTU				ELECTRICAL FOR POWER EXHAUST (P-E)						ECONOMIZER	SUPPLY FAN		MIN OSA CFM	COOLING CAPACITY				EVAPORATOR COIL				HEATING (HEAT PUMP)			WEIGHT (LBS)				MOUNT'G DETAIL	SEISMIC DETAILS	CONTROL DETAIL	REMARKS			
	MAKE	MODEL		POWER	BHP	MCA	MOCP	MAKE, MODEL & TYPE	INT SP IN.WG.	HP	FLA	MCA	MOCP	POWER	MAKE & MODEL	CFM		TOTAL SP IN.WG.	TOTAL (MBH)	SENSIBLE (MBH)	EER/IEER	SEER	EDB (°F)	EWB (°F)	LDB (°F)	LWB (°F)	INPUT (MBH)	OUTPUT (MBH)	EFF % (COP)	RTU	CURB	P.E/ECON					TOTAL		
BUILDING D (CAFETERIA)																																							
	CARRIER	50HCQD12A2A5-0A0G0	10	230V-3Ø-60HZ	1.67	49.0	60.0	CANFAB MODEL 1178-MHPE030	0.75	3.0	10.8	13.5	24.3	230V-3Ø-60	CANFAB MODEL 1178-MHPE030	4000	1.00	600	123.51	93.78	12.30/13.6	-	80.0	67.0	57.7	58.3	111.39	148.0	3.5	1455	212	340	2.007			THRU			①②③④⑤
	CARRIER	50HCQD12A2A5-0A0G0	10	230V-3Ø-60HZ	1.67	49.0	60.0	CANFAB MODEL 1178-MHPE030	0.75	3.0	10.8	13.5	24.3	230V-3Ø-60	CANFAB MODEL 1178-MHPE030	4000	1.00	600	123.51	93.78	12.30/13.6	-	80.0	67.0	57.7	58.3	111.39	148.0	3.5	1455	212	340	2.007			THRU			①②③④⑤
REMARKS	① PROVIDE DUCT SMOKE DETECTOR ON SA DUCT PER FIRE ALARM DRAWINGS. PROVIDE CO MONITORS PER 2016 CBC 915. SEE FA SHEETS E8-3 THROUGH E8-11 AND 2M701 FOR FURTHER INFORMATION.							② PROVIDE 2" MERV 11 FILTER, PROGRAMMABLE THERMOSTAT TIED TO RTU.							③ PROVIDE ALL NECESSARY CONTROLS, EQUIPMENT, PROGRAMMING, WIRING AND CONDUITS FOR CONNECTION EXISTING CAMPUS EMS.							④ PROVIDE 0-100% FULLY MODULATING COMBO ECONOMIZER AND INTEGRAL POWER EXHAUST WITH DRY-BULB INTEGRATED CONTROL AND BAROMETRIC RELIEF. PROVIDE DUAL, SEPARATE POWER TO UNIT AND COMBO P/E/ECONOMIZER. PROVIDE CARBON DIOXIDE (CO2) SENSOR FOR DCV CONTROL.							⑤ 11" HIGH ADJUSTABLE / PITCHED ROOF CURB.										
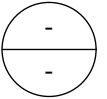
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VARIABLE REFRIGERANT FLOW (VRF) SYSTEM HEAT PUMP OUTDOOR CONDENSING UNIT SCHEDULE																				
SYMBOL	MFGR.	MODEL	TONS	SERVICE	LOCATION	COOLING CAPACITY (BTUH)	EER	HEATING CAPACITY (BTUH)	HSPF	ELECTRICAL				SUCTION LINE SIZE	LIQUID LINE SIZE	WEIGHT (LBS)	REF TYPE	ANCHORAGE	ACCESSORIES	REMARKS
										POWER V/Ø-HZ	TOTAL FLA	MCA	MOCP							
BUILDING A																				
OU 1-1	SAMSUNG	AM048FXMDCH1AA	4	FC 1-5 THRU FC 1-8	GROUND	48,000	-	54,000	-	208V-3Ø-60	-	29	50	③	③	220	R410A	-	①	① ② ③
BUILDING CDC																				
OU 1-1	SAMSUNG	AM072FXVAFH2AA	6	FC 1-5 THRU FC 1-11	ROOF	72,000	-	81,000	-	208V-3Ø-60	-	28	35	③	③	450	R410A	-	①	① ② ③
BUILDING E																				
OU 1-1	SAMSUNG	AM096FXVAFH2AA	8	FC 1-14 THRU FC 1-17	ROOF	96,000	-	108,000	-	208V-3Ø-60	-	37.8	50	③	③	685	R410A	-	①	① ② ③
OU 1-2	SAMSUNG	AM096FXVAFH2AA	8	FC 1-18 THRU FC 1-23	ROOF	96,000	-	108,000	-	208V-3Ø-60	-	37.8	50	③	③	685	R410A	-	①	① ② ③
OU 1-3	SAMSUNG	AM096FXVAFH2AA	8	FC 1-6 THRU FC 1-13	ROOF	96,000	-	108,000	-	208V-3Ø-60	-	37.8	50	③	③	685	R410A	-	①	① ② ③
ACCESSORIES:																				
① COMPLETE WITH HIGH/LOW PRESSURE SWITCH, START CAPACITOR, COMPRESSOR SHORT CYCLE PROTECTOR, AND LOW AMBIENT CONTROLLER .																				
REMARKS:																				
① COOLING CAP OF OUTDOOR CONDENSING UNIT PER INDOOR UNIT SCHEDULE THIS SHEET. ② REFER TO SHEET M7.04 FOR REFRIGERANT PIPE SIZE, PIPE QUANTITY AND ROUTING. VRF MANUFACTURER TO CHECK AND APPROVE VRF PIPING LAYOUT, PIPING QUANTITY, SIZING AND CONNECTION PRIOR TO INSTALLATION. ③ WIND BAFFLE ACCESSORIES.																				

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EXHAUST AND SUPPLY FAN SCHEDULE															
SYMBOL	MANUFACTURER AND MODEL NO.	SERVICE	LOCATION	BLOWER			MOTOR				SONES	OPERATING WEIGHT LBS	SUPPORT DETAIL	ACCESSORIES	REMARKS
				CFM	TSP IN. WC.	RPM	HP	RPM	POWER V-PH-HZ	DRIVE					
BUILDING B															
EF 1-1	COOK GC-542	RESTROOM	CEILING	313	0.5	1600	111 WATTS	-	115-1-60	CEILING FAN	-	37	-	1 2 3	3
EF 1-2	COOK GC-542	RESTROOM	CEILING	313	0.5	1600	111 WATTS	-	115-1-60	CEILING FAN	-	37	-	1 2 3	3
BUILDING C															
EF 2-1	COOK 100C1DEC	ROOM 263	ROOF	450	0.75	1710	1/4	1725	115-1-60	DIRECT	8.8	60	-	1 2 3	-
EF 2-2	COOK 120 CPV	CLASSROOM 262	ROOF	1600	0.5	1783	1/2	1725	115-1-60	BELT	-	330	-	3 9 10 11	2
EF 2-3	COOK 165 CPS	CLASSROOM 264	ROOF	2700	0.5	1264	3/4	1725	115-1-60	BELT	-	490	-	3 9 10 11	2
EF 2-4	COOK 180 CPV	CLASSROOM 261	ROOF	3500	0.5	1059	3/4	1725	115-1-60	BELT	-	530	-	3 9 10 11	2
EF 2-5	COOK 135 CPV	CLASSROOM 265	ROOF	2300	0.5	1756	3/4	1725	115-1-60	BELT	-	380	-	3 9 10 11	2
EF 2-6	COOK 180 CPV	CLASSROOM 259	ROOF	3500	0.5	1059	3/4	1725	115-1-60	BELT	-	530	-	3 9 10 11	2
EF 2-7	COOK 120 CPV	CLASSROOM 258	ROOF	1600	0.5	1783	1/2	1725	115-1-60	BELT	-	330	-	3 9 10 11	2
EF 2-8	COOK 100C1DEC	ROOM 257	ROOF	450	0.75	1710	1/4	1725	115-1-60	DIRECT	8.8	60	-	1 2 3	-
EF 2-9	COOK 150 CPV	CLASSROOM 256	ROOF	2600	0.5	1531	3/4	1725	115-1-60	BELT	-	425	-	3 9 10 11	2
EF 2-10	COOK 150 CPS	CLASSROOM 255	ROOF	2400	0.5	1474	3/4	1725	115-1-60	BELT	-	425	-	3 9 10 11	2
EF 2-11	COOK 120C15D	GIRL'S RESTROOM & BOY'S RESTROOM	ROOF	1440	0.5	1550	1/4	1550	115-1-60	DIRECT	-	78	-	1 2 3	3
SF 2-1	KLEAN AIRE P-2	CLASSROOM 262	ROOF	1600	1.5	-	2	-	460-3-60	DIRECT	-	430	-	5 6	1
SF 2-2	KLEAN AIRE P-3	CLASSROOM 264	ROOF	2700	1.5	-	3	-	460-3-60	DIRECT	-	500	-	5 7	1
SF 2-3	KLEAN AIRE P-4	CLASSROOM 261	ROOF	3500	1.5	-	3	-	460-3-60	DIRECT	-	580	-	5 8	1
SF 2-4	KLEAN AIRE P-3	CLASSROOM 265	ROOF	2300	1.5	-	3	-	460-3-60	DIRECT	-	500	-	5 7	1
SF 2-5	KLEAN AIRE P-4	CLASSROOM 259	ROOF	3500	1.5	-	3	-	460-3-60	DIRECT	-	580	-	5 8	1
SF 2-6	KLEAN AIRE P-3	CLASSROOM 258	ROOF	1600	1.5	-	2	-	460-3-60	DIRECT	-	430	-	5 6	1
SF 2-7	KLEAN AIRE P-3	CLASSROOM 256	ROOF	2600	1.5	-	3	-	460-3-60	DIRECT	-	500	-	5 7	1
SF 2-8	KLEAN AIRE P-3	CLASSROOM 255	ROOF	2400	1.5	-	3	-	460-3-60	DIRECT	-	500	-	5 7	1
BUILDING CDC															
SF 1-1	COOK 90SQN12D	OFFICE & KITCHEN	CORRIDOR	250	0.5	1600	1/6	1200	115-1-60	DIRECT	-	80	-	1 2 3 4	-
EF 1-1	COOK GC-168	LOCKER ROOM	CEILING	150	0.35	1160	55 WATTS	-	115-1-60	CEILING FAN	-	25	-	1 2 3	3
EF 1-2	COOK GC-146	RESTROOM	CEILING	60	0.35	900	35 WATTS	-	115-1-60	CEILING FAN	-	25	-	1 2 3	3
EF 1-3	COOK GC-148	RESTROOM	CEILING	100	0.35	1075	46 WATTS	-	115-1-60	CEILING FAN	-	25	-	1 2 3	3
EF 1-4	COOK GC-148	RESTROOM	CEILING	100	0.35	1075	46 WATTS	-	115-1-60	CEILING FAN	-	25	-	1 2 3	3
BUILDING D															
EF 1-1	COOK 300V08D	KITCHEN HOOD	ROOF	8,600	1.65	799	5.0	0860	208-3-60	DIRECT	19.9	621	-	1 2 3	BMS INTERLOCK WITH EC 1-1.
EF 1-2	COOK GC-148	LOCKER ROOM	CEILING	122	0.5	1075	46 WATTS	-	115-1-60	CEILING FAN	-	29	-	1 2 3	3
EF 1-3	COOK GC-146	RESTROOM	CEILING	79	0.5	900	35 WATTS	-	115-1-60	CEILING FAN	-	29	-	1 2 3	3
ACCESSORIES: 1 VARI GREEN EC MOTOR WITH 0-10 VDC INPUT SIGNAL. 2 DISCONNECT BY ELECTRICAL. 3 BACKDRAFT DAMPER. 4 FILTER BOX. 5 PROVIDE COASTAL ENTIRE UNIT COATING. 6 (1) 24"x24"x2" MERV 13 PANEL FILTER 7 (1) 24"x24"x2", (1) 12"x24"x2" MERV 13 PANEL FILTER 8 (2) 24"x24"x2" MERV 13 PANEL FILTER 9 BIRD SCREEN. 10 ISOLATION SPRINGS. 11 PROVIDE VFD.															
REMARKS: 1 NEMA-1 TOGGLE SWITCH 2 SIDE DISCHARGE 3 REPLACE IN KIND; CONTRACTOR TO VERIFY MODEL #, HP, CFM, AND STATIC PRESSURE BEFORE DEMOLITION WORK, AND REBALANCE NEW FAN TO THE PRE-READ CFM QUANTITIES AND STATIC PRESSURES.															

EXHAUST AND SUPPLY FAN SCHEDULE															
SYMBOL	MANUFACTURER AND MODEL NO.	SERVICE	LOCATION	BLOWER			MOTOR				SONES	OPERATING WEIGHT LBS	SUPPORT DETAIL	ACCESSORIES	REMARKS
				CFM	TSP IN. WC.	RPM	HP	RPM	POWER V-PH-HZ	DRIVE					
BUILDING E															
SF 1-1	COOK 90SQN12D	ADMIN AREA	ADMIN AREA	200	0.5	1600	1/6	1200	115-1-60	DIRECT	-	80	-	1 2 3 4	-
SF 1-2	COOK 90SQN12D	ADMIN AREA	ADMIN AREA	200	0.5	1600	1/6	1200	115-1-60	DIRECT	-	80	-	1 2 3 4	-
SF 1-3	COOK 90SQN12D	ADMIN AREA	ADMIN AREA	200	0.5	1600	1/6	1200	115-1-60	DIRECT	-	80	-	1 2 3 4	-
SF 1-4	COOK 90SQN12D	ADMIN AREA	ADMIN AREA	200	0.5	1600	1/6	1200	115-1-60	DIRECT	-	80	-	1 2 3 4	-
SF 2-1	KLEAN AIRE P-3	CLASSROOM 222	ROOF	3000	1.5	-	3	-	460-3-60	DIRECT	-	500	-	5 7	1
SF 2-2	KLEAN AIRE P-3	CLASSROOM 220	ROOF	3000	1.5	-	3	-	460-3-60	DIRECT	-	500	-	5 7	1
SF 2-3	KLEAN AIRE P-3	CLASSROOM 216	ROOF	3000	1.5	-	3	-	460-3-60	DIRECT	-	500	-	5 7	1
SF 2-4	KLEAN AIRE P-4	CLASSROOM 216	ROOF	3500	1.5	-	3	-	460-3-60	DIRECT	-	580	-	5 8	1
SF 2-5	KLEAN AIRE P-4	CLASSROOM 212	ROOF	3500	1.5	-	3	-	460-3-60	DIRECT	-	580	-	5 8	1
SF 2-6	KLEAN AIRE P-3	CLASSROOM 210	ROOF	2500	1.5	-	3	-	460-3-60	DIRECT	-	500	-	5 7	1
EF 1-1	COOK GC-740	RESTROOM	CEILING	675	0.5	1625	316 WATTS	-	115-1-60	CEILING FAN	-	25	-	1 2 3	3
EF 1-2	COOK GC-146	RESTROOM	CEILING	90	0.25	900	35 WATTS	-	115-1-60	CEILING FAN	-	25	-	1 2 3	3
EF 1-3	COOK GC-128	RESTROOM	CEILING	63	0.25	750	29 WATTS	-	115-1-60	CEILING FAN	-	20	-	1 2 3	3
EF 1-4	COOK GC-148	RESTROOM	CEILING	135	0.25	1075	246 WATTS	-	115-1-60	CEILING FAN	-	25	-	1 2 3	3
EF 1-5	COOK GC-822	RESTROOM	CEILING	770	0.5	910	196 WATTS	-	115-1-60	CEILING FAN	-	102	-	1 2 3	3
EF 1-6	COOK 120C15D	RESTROOM	ROOF	1100	0.5	1322	1/4	1550	115-1-60	DIRECT	-	90	-	1 2 3	3
EF 1-7	COOK 100C15DH	RESTROOM	ROOF	550	0.5	1548	1/8	1550	115-1-60	DIRECT	-	55	-	1 2 3	3
EF 2-1	COOK 180C10D	CLASSROOM 222	ROOF	3000	0.5	990	3/4	1075	115-1-60	DIRECT	-	135	-	1 2 3	
EF 2-2	COOK 180C10D	CLASSROOM 220	ROOF	3000	0.5	990	3/4	1075	115-1-60	DIRECT	-	135	-	1 2 3	
EF 2-3	COOK 180C10D	CLASSROOM 216	ROOF	3000	0.5	990	3/4	1075	115-1-60	DIRECT	-	135	-	1 2 3	
EF 2-4	COOK 180C10D	CLASSROOM 216	ROOF	3500	0.5	1058	3/4	1075	115-1-60	DIRECT	-	155	-	1 2 3	
EF 2-5	COOK 180C10D	CLASSROOM 212	ROOF	3500	0.5	1058	3/4	1075	115-1-60	DIRECT	-	155	-	1 2 3	
EF 2-6	COOK 180C10D	CLASSROOM 210	ROOF	2500	0.5	1374	3/4	1550	115-1-60	DIRECT	-	95	-	1 2 3	
EF 2-7	COOK GC-622	RESTROOM	CEILING	470	0.25	1400	141 WATTS	-	115-1-60	CEILING FAN	-	55	-	1 2 3	3
EF 2-8	COOK GC-148	RESTROOM	CEILING	110	0.25	1075	46 WATTS	-	115-1-60	CEILING FAN	-	30	-	1 2 3	3
EF 2-9	COOK GC-642	RESTROOM	CEILING	520	0.25	1500	183 WATTS	-	115-1-60	CEILING FAN	-	55	-	1 2 3	3
BUILDING H															
EF 1-1	COOK 165 CPV	GYMNASIUM	ROOF	3000	0.5	1339	1	1725	230-1-60	BELT	-	400	-	1 2 3	-
EF 1-2	COOK 120C13D	LOCKER ROOM	ROOF	1100	0.35	1300	1/4	1300	115-1-60	DIRECT	-	75	-	1 2 3	-
EF 1-3	COOK 120C13D	LOCKER ROOM	ROOF	1100	0.35	1300	1/4	1300	115-1-60	DIRECT	-	75	-	1 2 3	-
EF 1-4	COOK 100C10DH	RESTROOM	ROOF	235	0.35	1050	1/25	1050	115-1-60	DIRECT	-	60	-	1 2 3	3
EF 1-5	COOK 90C15DL	RESTROOM	ROOF	300	0.35	1715	1/8	1550	115-1-60	DIRECT	-	60	-	1 2 3	3
EF 1-6	COOK GC-148	JANITOR	CEILING	100	0.25	1075	46 WATTS	-	115-1-60	CEILING FAN	-	25	-	1 2 3	3
EF 1-7	COOK 90C10DM	RESTROOM	ROOF	240	0.25	1100	1/25	1050	115-1-60	DIRECT	-	60	-	1 2 3	3
SF 1-1	COOK 70SQN-B	OFFICES	CEILING	100	0.3	1151	1/6	1140	115-1-60	DIRECT	-	127	-	1 2 3 4	-
BUILDING K															
EF 1-1	COOK GC-138	ELECTRICAL 311A	CEILING	150	0.35	1160	55 W	-	115-1-60	DIRECT	3.5	16	-	1 2 3	-
EF 1-2	COOK GC-146	RESTROOM	CEILING	75	0.35	900	35 WATTS	-	115-1-60	CEILING FAN	-	25	-	1 2 3	3
EF 2-1	COOK GC-148	JANITOR	CEILING	120	0.35	1075	46 WATTS	-	115-1-60	CEILING FAN	-	25	-	1 2 3	3
EF 2-2	COOK GC-146	RESTROOM	CEILING	75	0.35	900	35 WATTS	-	115-1-60	CEILING FAN	-	25	-	1 2 3	3
ACCESSORIES:															
① VARI GREEN EC MOTOR WITH 0-10 VDC INPUT SIGNAL. ② DISCONNECT BY ELECTRICAL. ③ BACKDRAFT DAMPER. ④ FILTER BOX. ⑤ PROVIDE COASTAL ENTIRE UNIT COATING. ⑥ (1) 24"x24"x2" MERV 13 PANEL FILTER															
⑦ (1) 24"x24"x2", (1) 12"x24"x2" MERV 13 PANEL FILTER ⑧ (2) 24"x24"x2" MERV 13 PANEL FILTER ⑨ BIRD SCREEN. ⑩ ISOLATION SPRINGS. ⑪ PROVIDE VFD.															
REMARKS:															
① NEMA-1 TOGGLE SWITCH ② SIDE DISCHARGE ③ REPLACE IN KIND; CONTRACTOR TO VERIFY MODEL #, HP, CFM, AND STATIC PRESSURE BEFORE DEMOLITION WORK, AND REBALANCE NEW FAN TO THE PRE-READ CFM QUANTITIES AND STATIC PRESSURES.															

GRAVITY RELIEF VENTILATOR SCHEDULE											
SYMBOL	MANUFACTURER AND MODEL NO.	SERVICE	LOCATION	VOLUME CFM	SP IN. WC.	CURB (IN.) (W x L)		OPERATING WEIGHT LBS	SUPPORT DETAIL	ACCESSORIES	REMARKS
BUILDING B											
GR 1-1	COOK 12x36GR	AUDITORIUM STAGE/STORAGE	ROOF	1500	0.051	32	32	166	-	①②③	
GR 1-2	COOK 20 TR	AUDITORIUM STAGE/STORAGE	ROOF	1586	0.050	31	51	251	-	①②③	
BUILDING											
							</				

GRAVITY INTAKE VENTILATOR SCHEDULE											
SYMBOL	MANUFACTURER AND MODEL NO.	SERVICE	LOCATION	VOLUME CFM	SP IN. WC.	CURB (IN.) (W x L)		OPERATING WEIGHT LBS	SUPPORT DETAIL	ACCESSORIES	REMARKS
BUILDING C											
GI 2-1	GREENHECK GRSI-24	ROOM 263	ROOF	375	0.002	34	34	57	-	1 2 3	
GI 2-2	GREENHECK GRSI-24	ROOM 257	ROOF	375	0.002	34	34	57	-	1 2 3	
BUILDING E											
GI 2-1	COOK 12 TR	CLASSROOM 222	ROOF	550	0.125	20	20	50	-	1 2 3	
GI 2-2	COOK 12 TR	CLASSROOM 220	ROOF	550	0.125	20	20	50	-	1 2 3	
GI 2-3	COOK 12 TR	CLASSROOM 216	ROOF	550	0.125	20	20	50	-	1 2 3	
GI 2-4	COOK 12 TR	CLASSROOM 216	ROOF	600	0.125	20	20	50	-	1 2 3	
GI 2-5	COOK 12 TR	CLASSROOM 212	ROOF	600	0.125	20	20	50	-	1 2 3	
GI 2-6	COOK 8 TR	CLASSROOM 210	ROOF	500	0.125	20	20	50	-	1 2 3	
ACCESSORIES:											
1 BACKDRAFT DAMPER. 2 ROOF CURB. 3 BIRD SCREEN.											
REMARKS:											

FORCED AIR FURNACE UNIT SCHEDULE																					
SYMBOL	MANUFACTURER & MODEL NO.	AREA SERVED	LOCATION	BMS INTERLOCK WITH	SUPPLY AIR BLOWER								HEATING FURNACE				FILTER	AREA SMOKE DETECTOR SHUT DOWN	OPER. WEIGHT (LBS.)	ANCHORAGE DETAIL REFERENCE	REMARKS
					CFM	TSP (°WC)	TSP (°WC)	BHP	RPM	MOTOR			INPUT MBH	OUTPUT MBH	GAS CONN	EFF					
										HP	VOLTAGE	MCA									
BUILDING H																					
FAU 1-1	REZNOR PDH-125	GIRL'S LOCKER	GIRL'S LOCKER	(N/A)	1,250	0.574	0.5	-	866	1/3	240-1-60	-	-	-	101	-	81%	-	590	⌀ M	① ②
FAU 1-2	REZNOR RDH-300	GYMNASIUM	ROOF	EF	3,000	0.82	0.6	-	900	1.5	208-3-60	-	-	-	243	-	81%	-	1,350	⌀ M	① ②
① INTERLOCK MAF-1 WITH EF-. SEE KITCHEN DWG K-702 FOR ADDITIONAL PROVISIONS.					② ROOF CURB ARE BY MANUFACTURE. VERIFY SLOPE OF ROOF WITH ARCHITECTURAL ROOF PLANS.					③ VERTICAL DISCHARGE AND TWO STAGE GAS VALVE.											

EVAPORATIVE COOLER SCHEDULE																							
SYMBOL	MANUFACTURER & MODEL NO.	AREA SERVED	LOCATION	BMS INTERLOCK WITH	SUPPLY AIR BLOWER								PUMP ④					FILTER PAD DIMS (INCHES)			OPER. WEIGHT (LBS.)	ANCHORAGE DETAIL REFERENCE	REMARKS
					CFM	TSP (°WC)	TSP (°WC)	BHP	RPM	MOTOR		MODEL	VOLTAGE	AMPS	WATTS	GPM	NO. REQ'D	HEIGHT	WIDTH				
										HP	VOLTAGE												
BUILDING D																							
EC 1-1	CHAMPION ASPEN COOLER MODEL 10/12 SD	KITCHEN HOOD	ROOF	EF 1-1	7,500	1.00	0.50	1.5	354	1.5	208-3-60	6.6	110467	115-1-60	1.2	73	4.6	3	27	22	769	① M-	① ② ③
① COMPLETE WITH 1039 INTERFACE CONTROL PANEL FOR BLOWER/EVAPORATIVE COOLER AND MOTOR STARTER.					② ROOF CURB ARE BY MANUFACTURE. VERIFY SLOPE OF ROOF WITH ARCHITECTURAL ROOF PLANS.					③ SIDE DISCHARGE UNIT.					④ PROVIDE SEPARATE POWER TO PUMP.								

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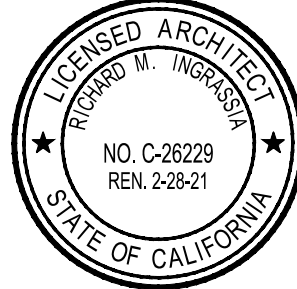
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Lincoln Middle School HVAC Replacement Project
Lincoln Middle School
1501 California Avenue
Santa Monica, California 90403

Rev	Date	Issue
1	07.22.19	-

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Project No. 19009




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Mechanical
Schedules


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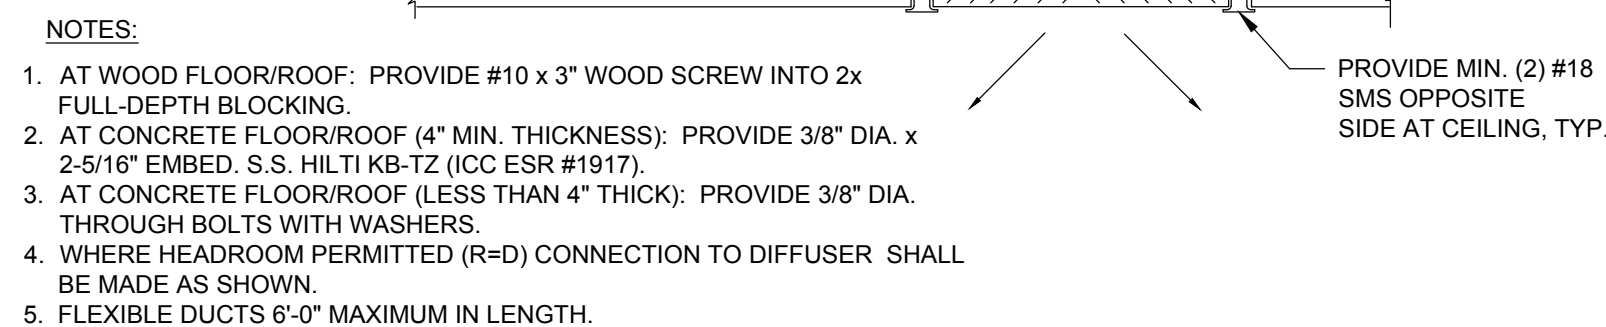


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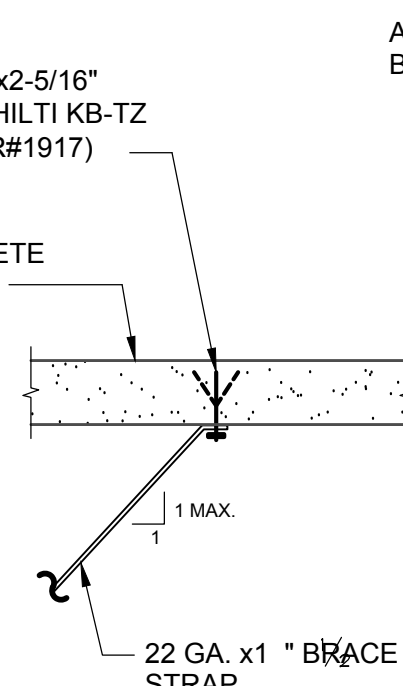
- NOTE:**
1. INSTALL HANGERS PER TABLE ABOVE (2016 CMC 603.5).
 2. STRAP HANGERS ARE PROVIDED AT 8 FOOT SPACING.
 3. INSTALL SEISMIC BRACING AS APPLICABLE PER MASON WEST OPM-0043-13
 4. SEE MEP COMPONENT ANCHORAGE NOTES ON SHEET, M001.

8

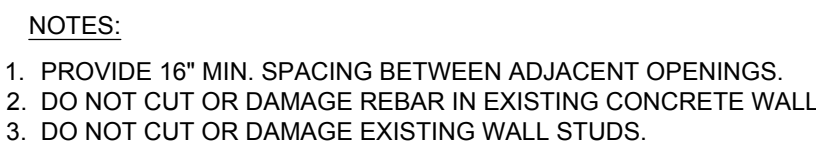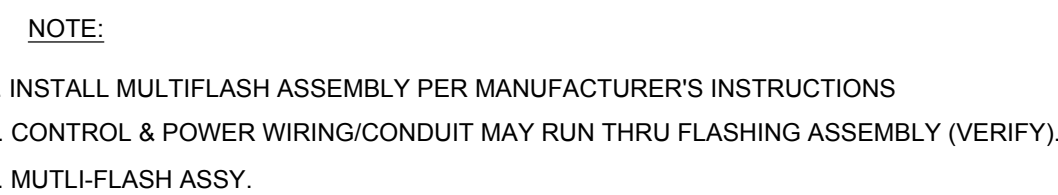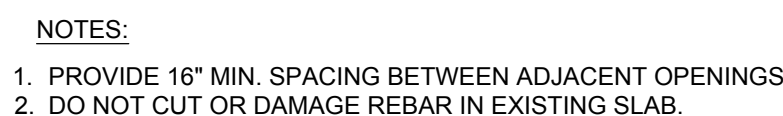


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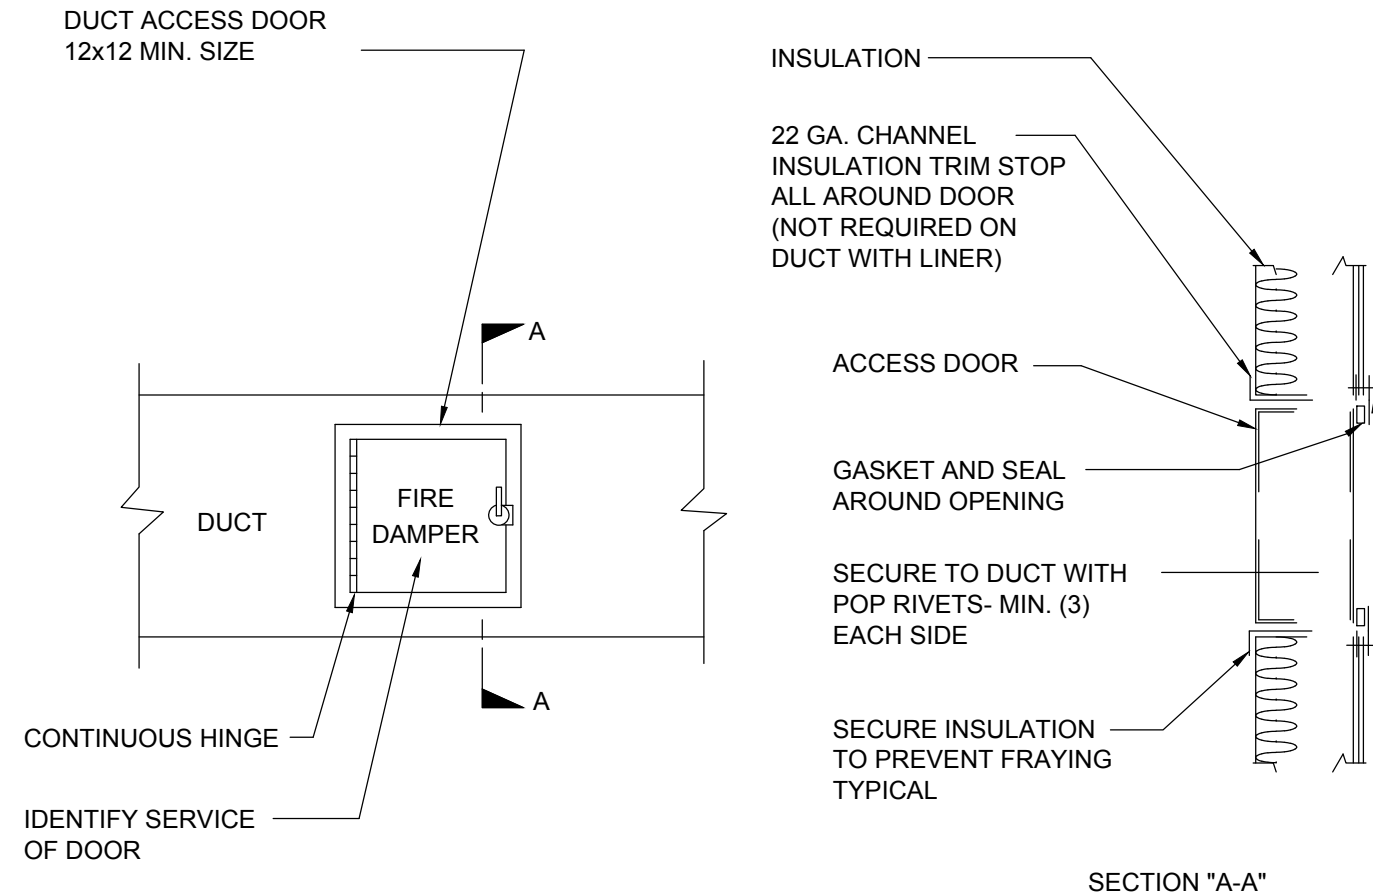
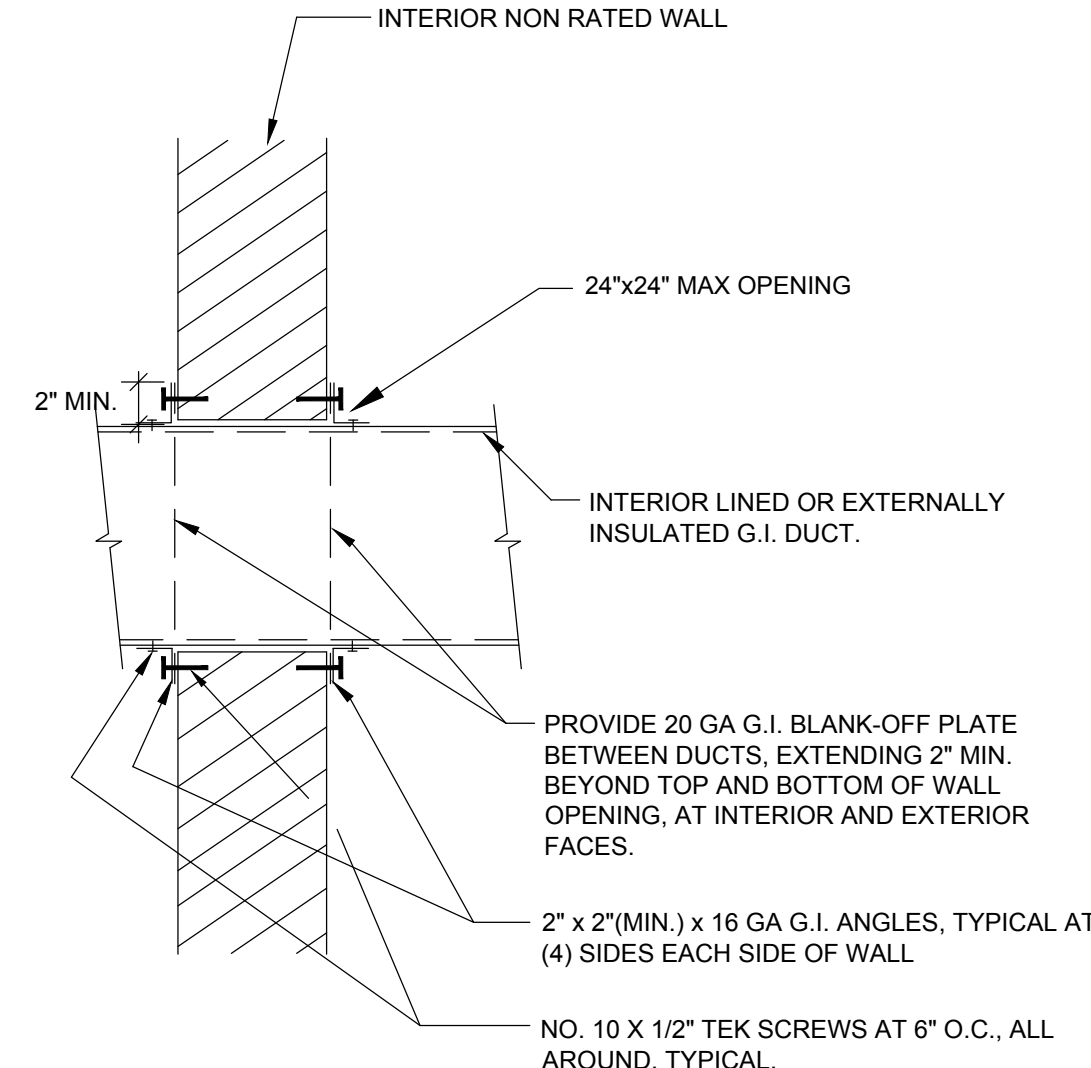
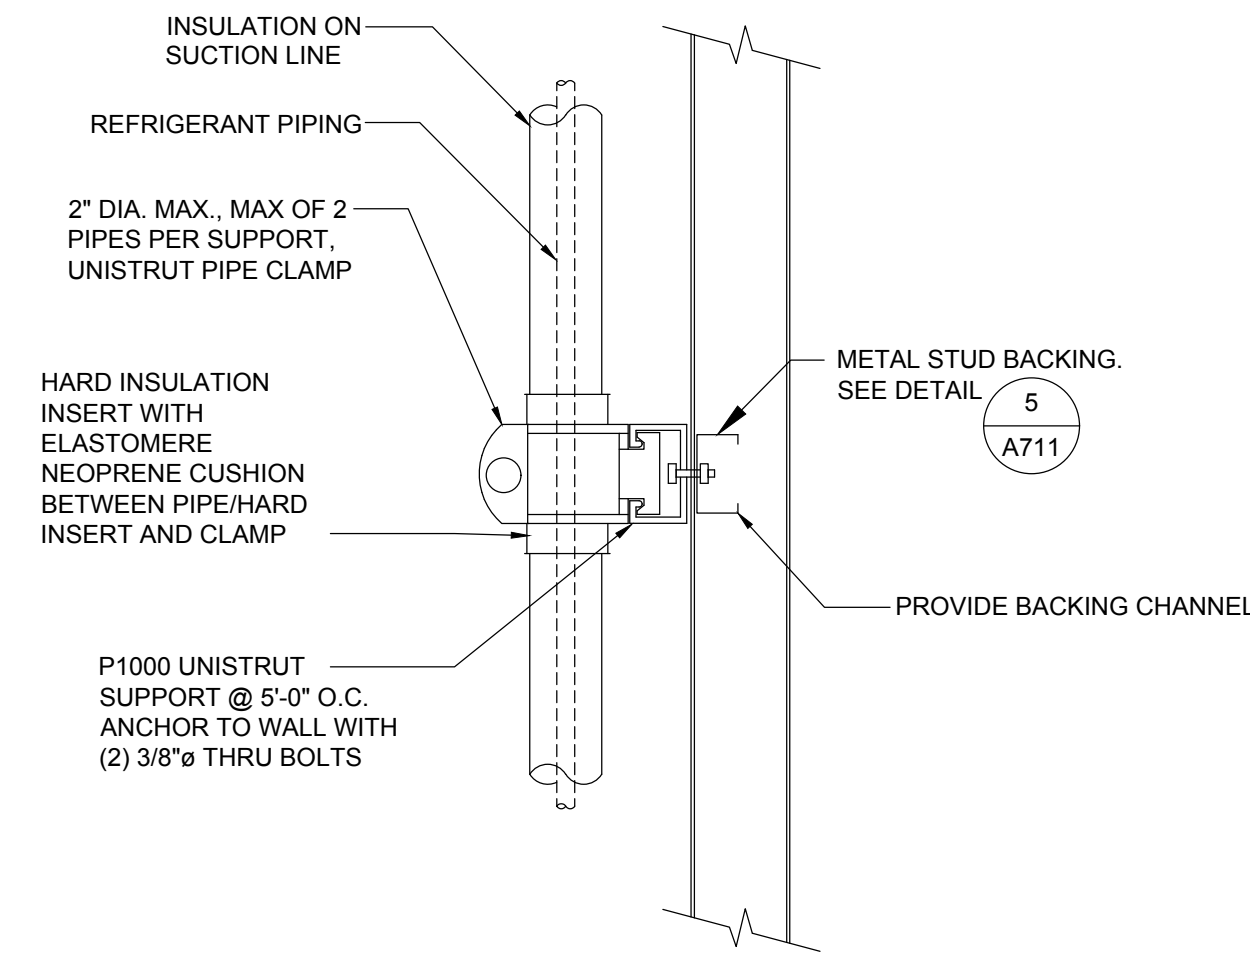
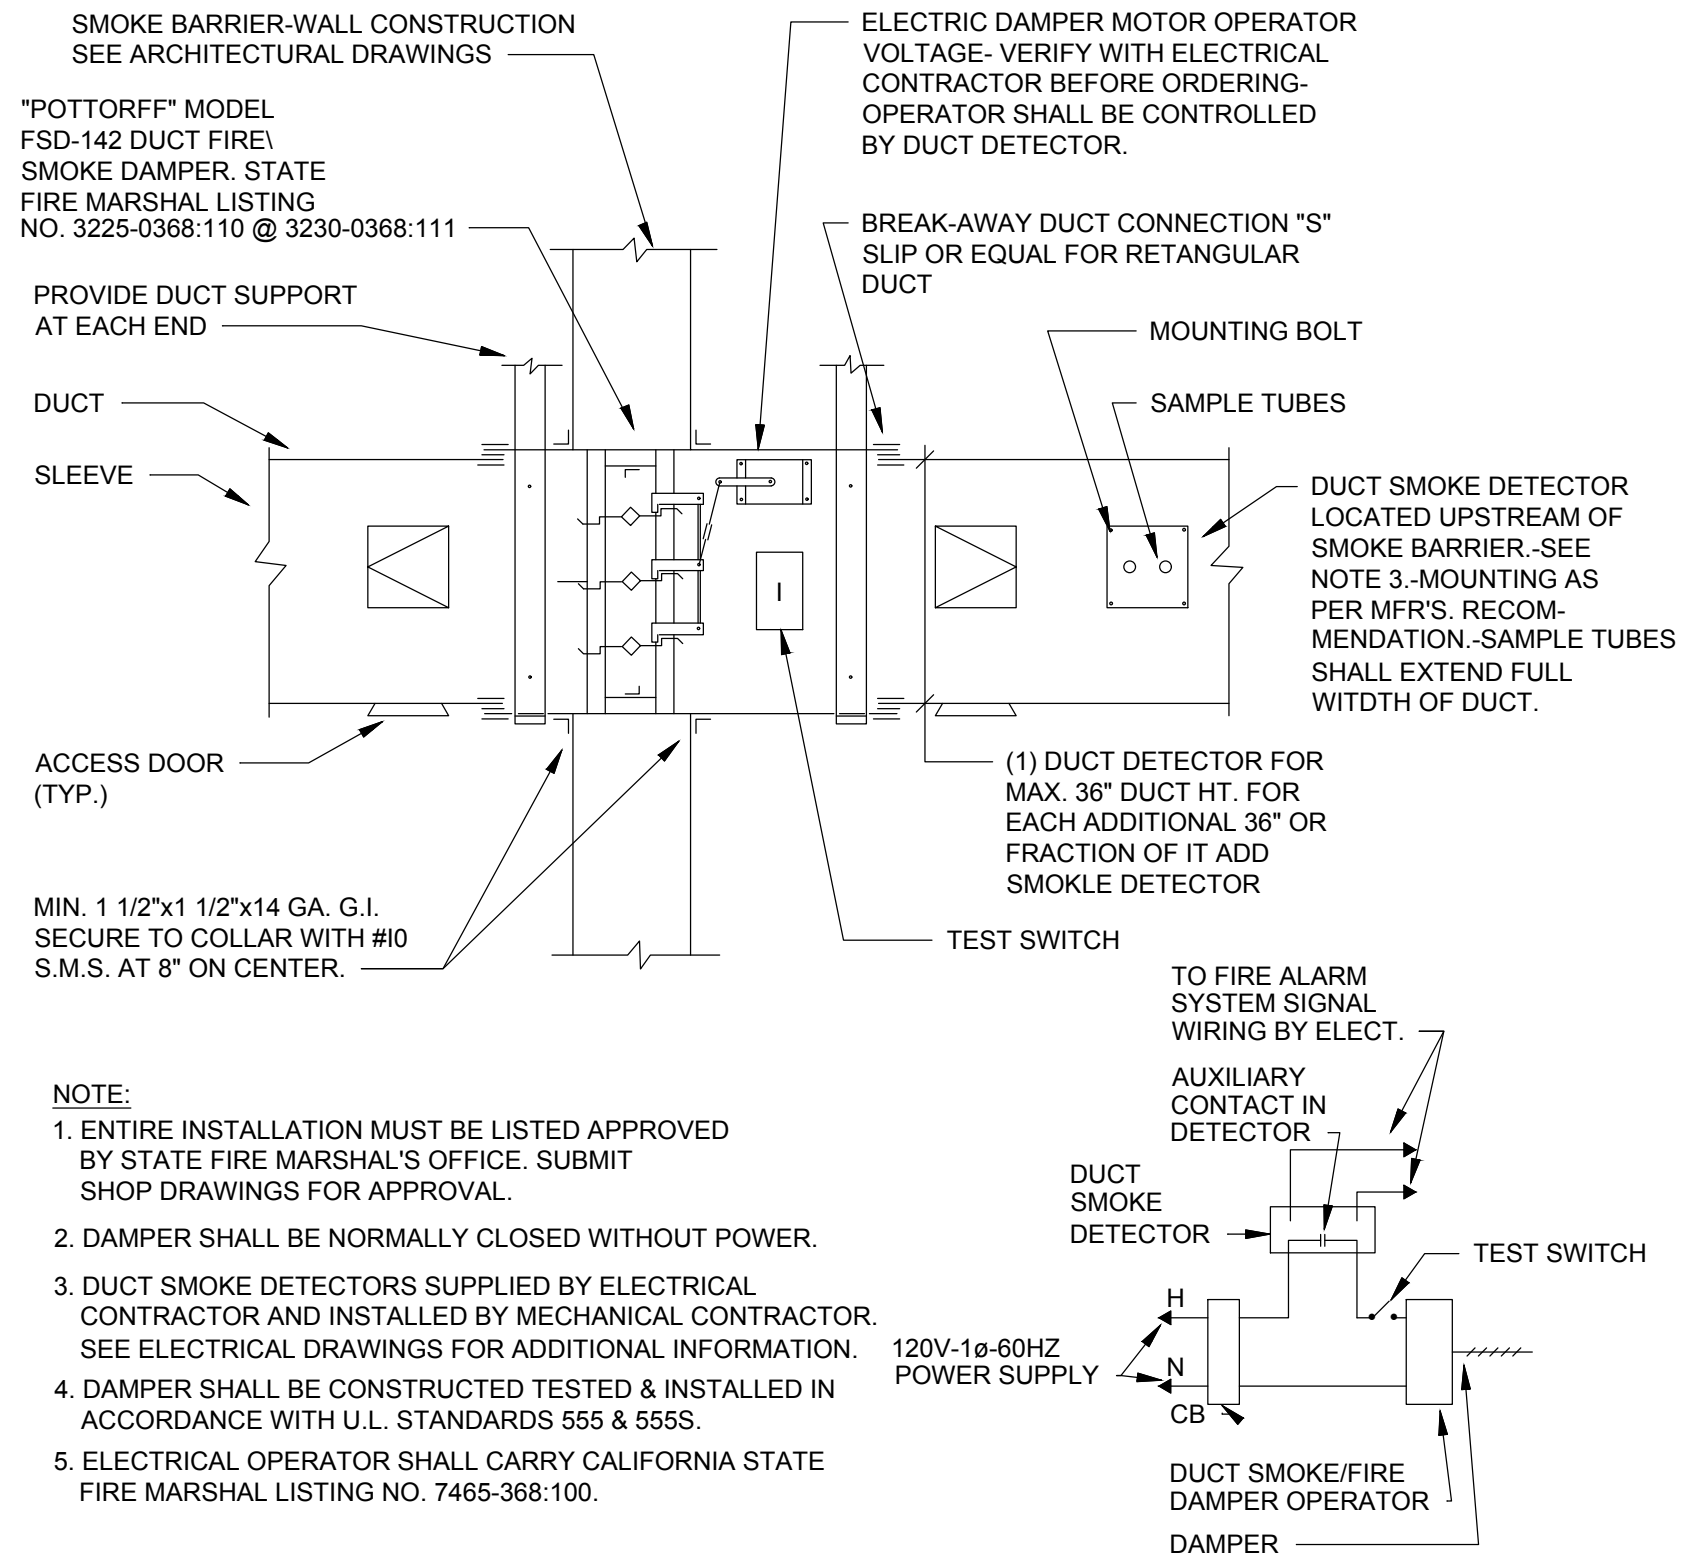
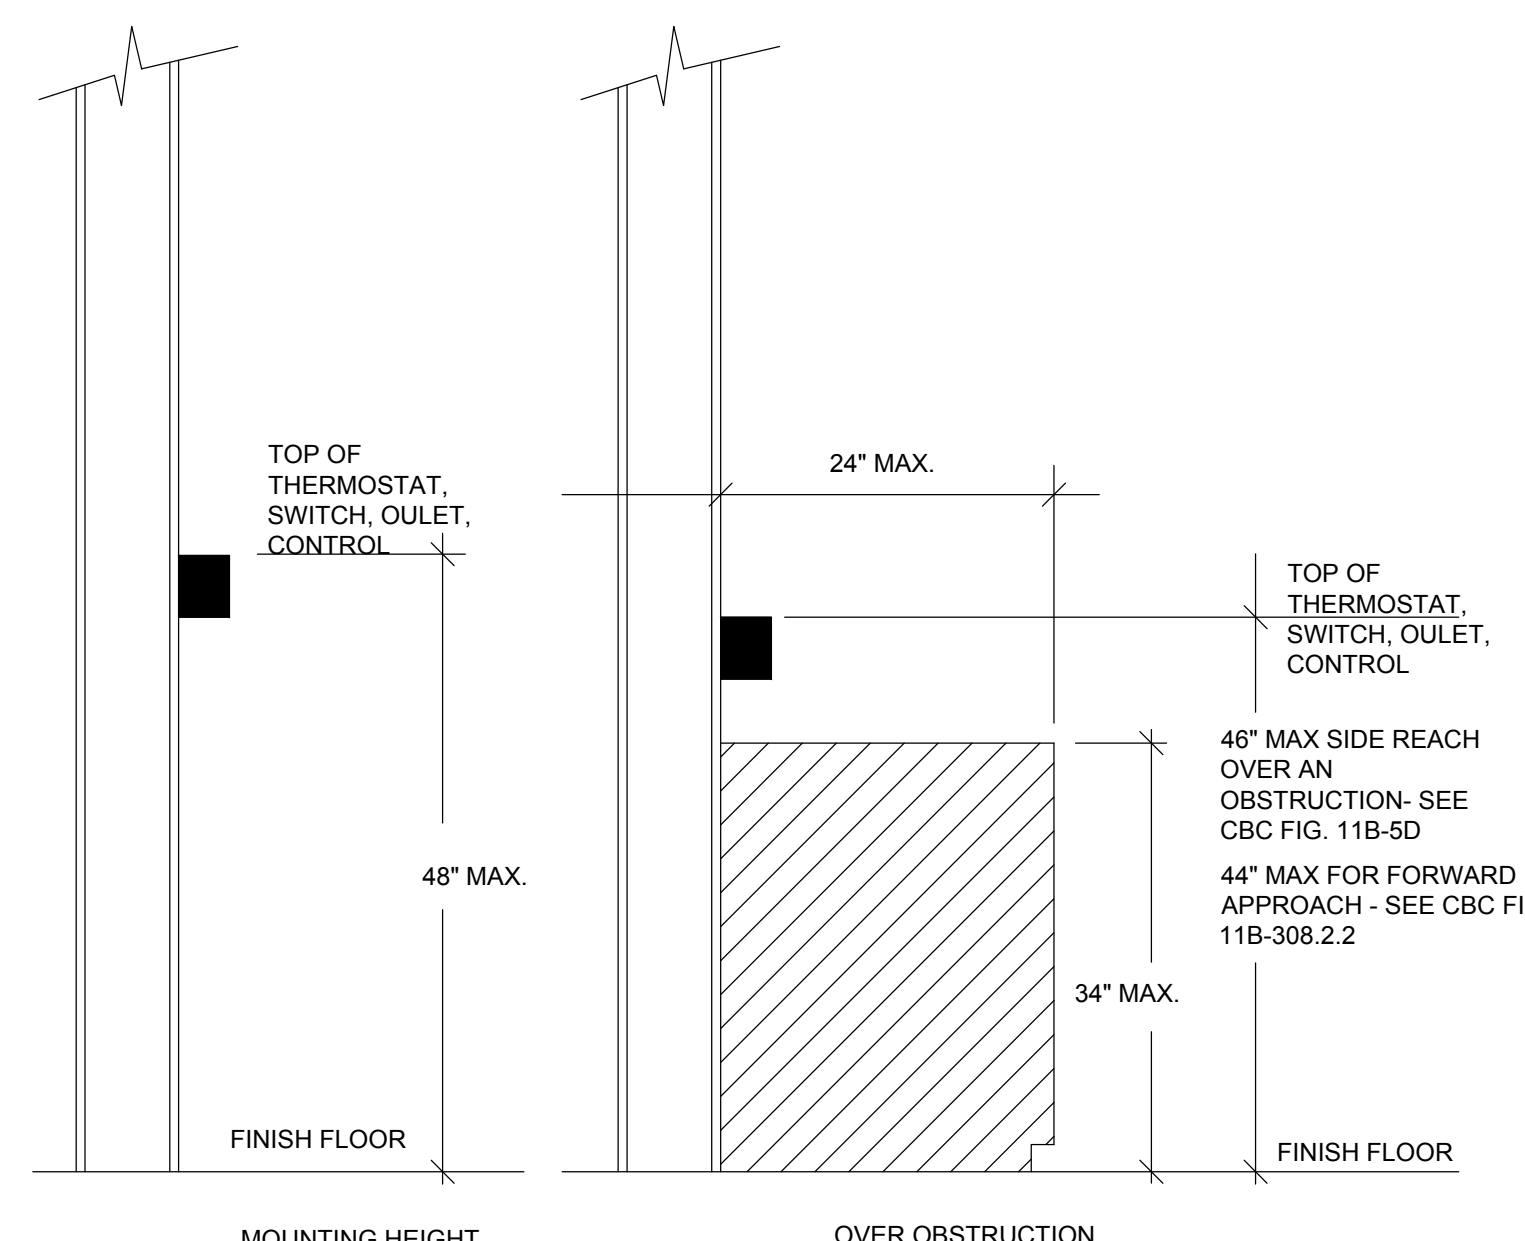
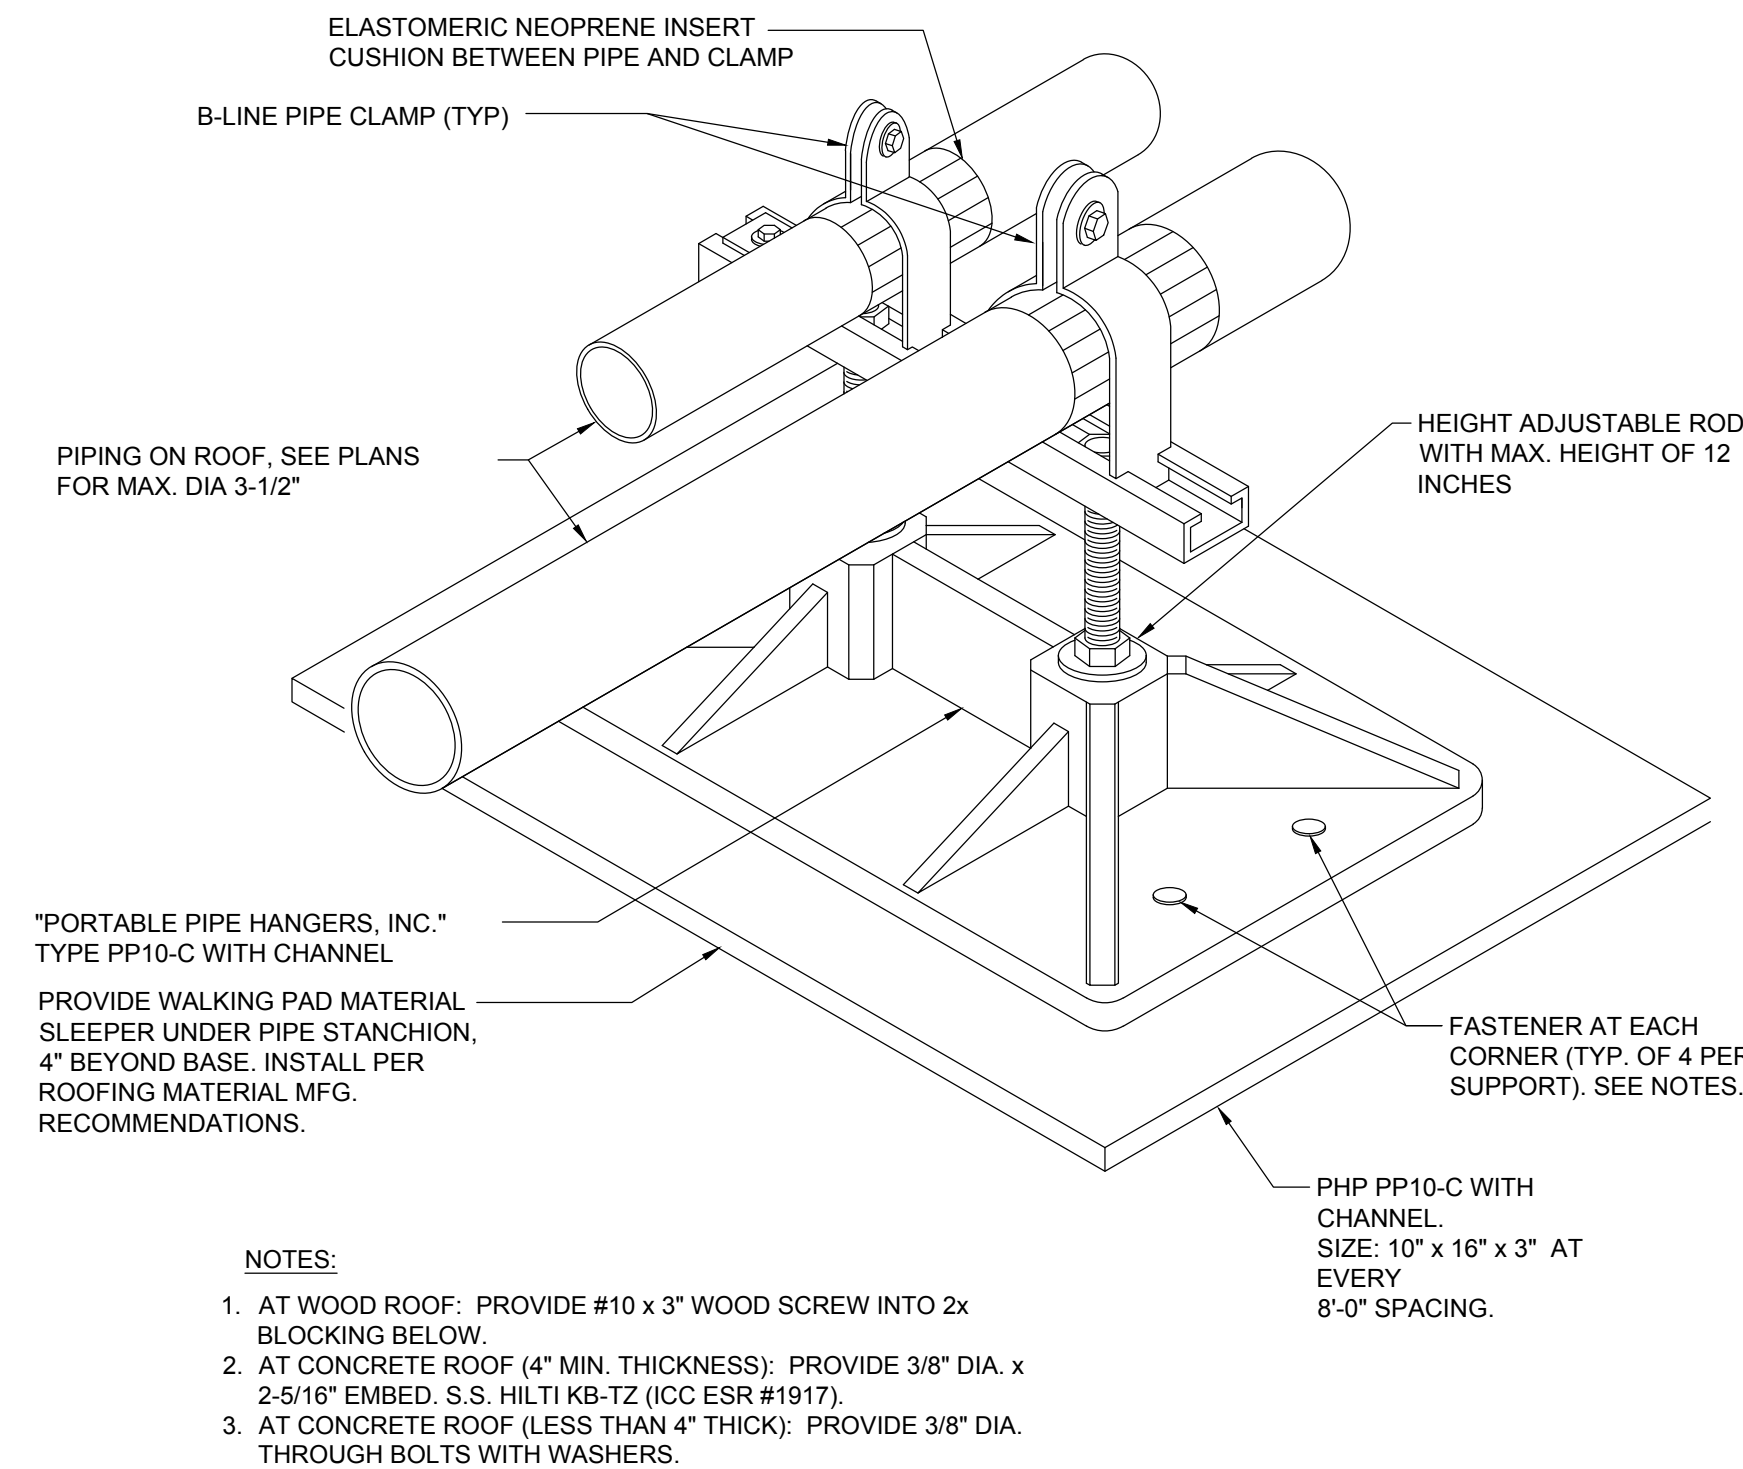
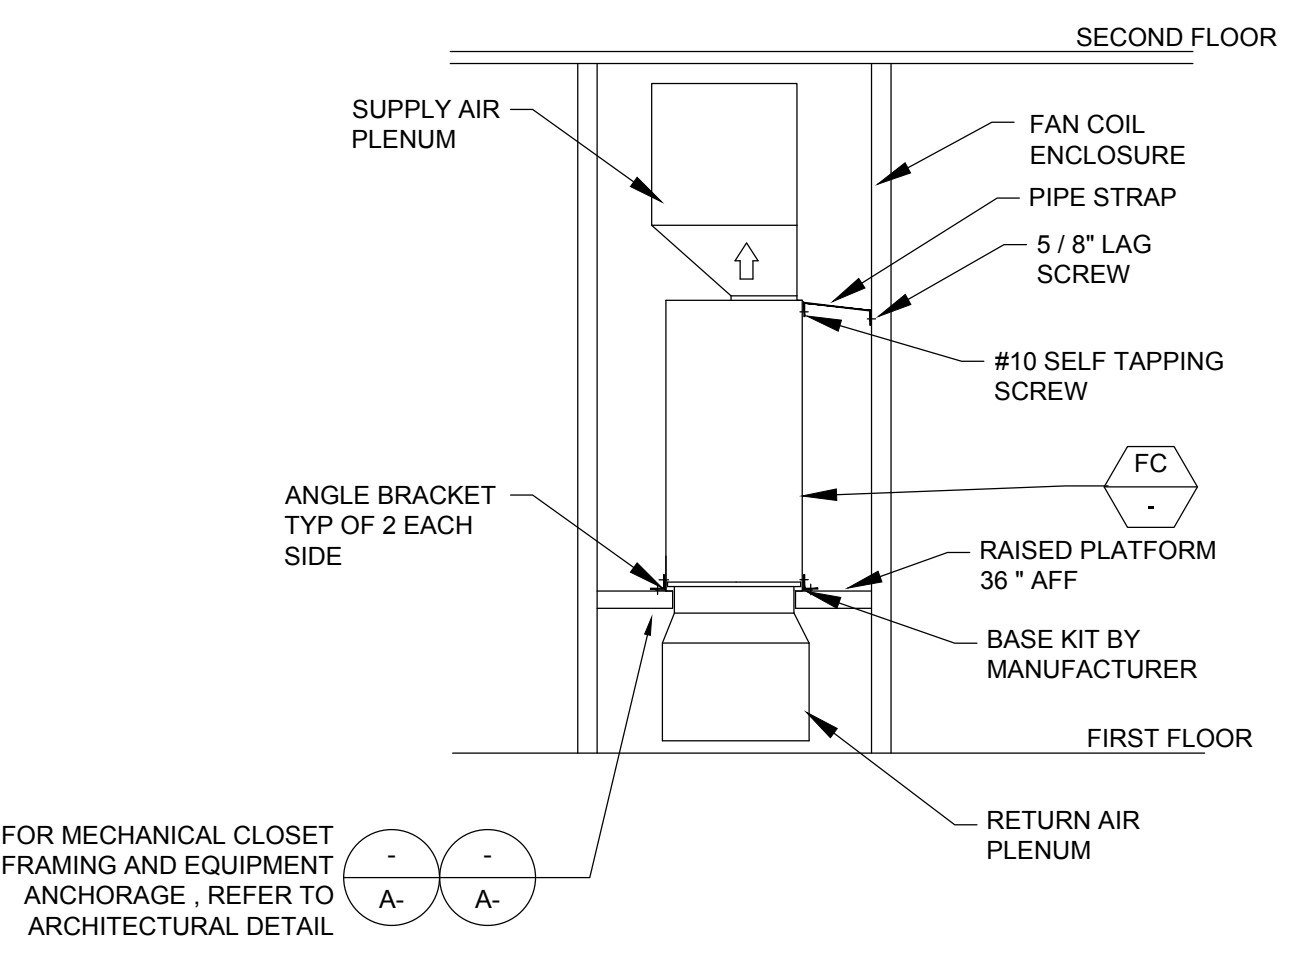
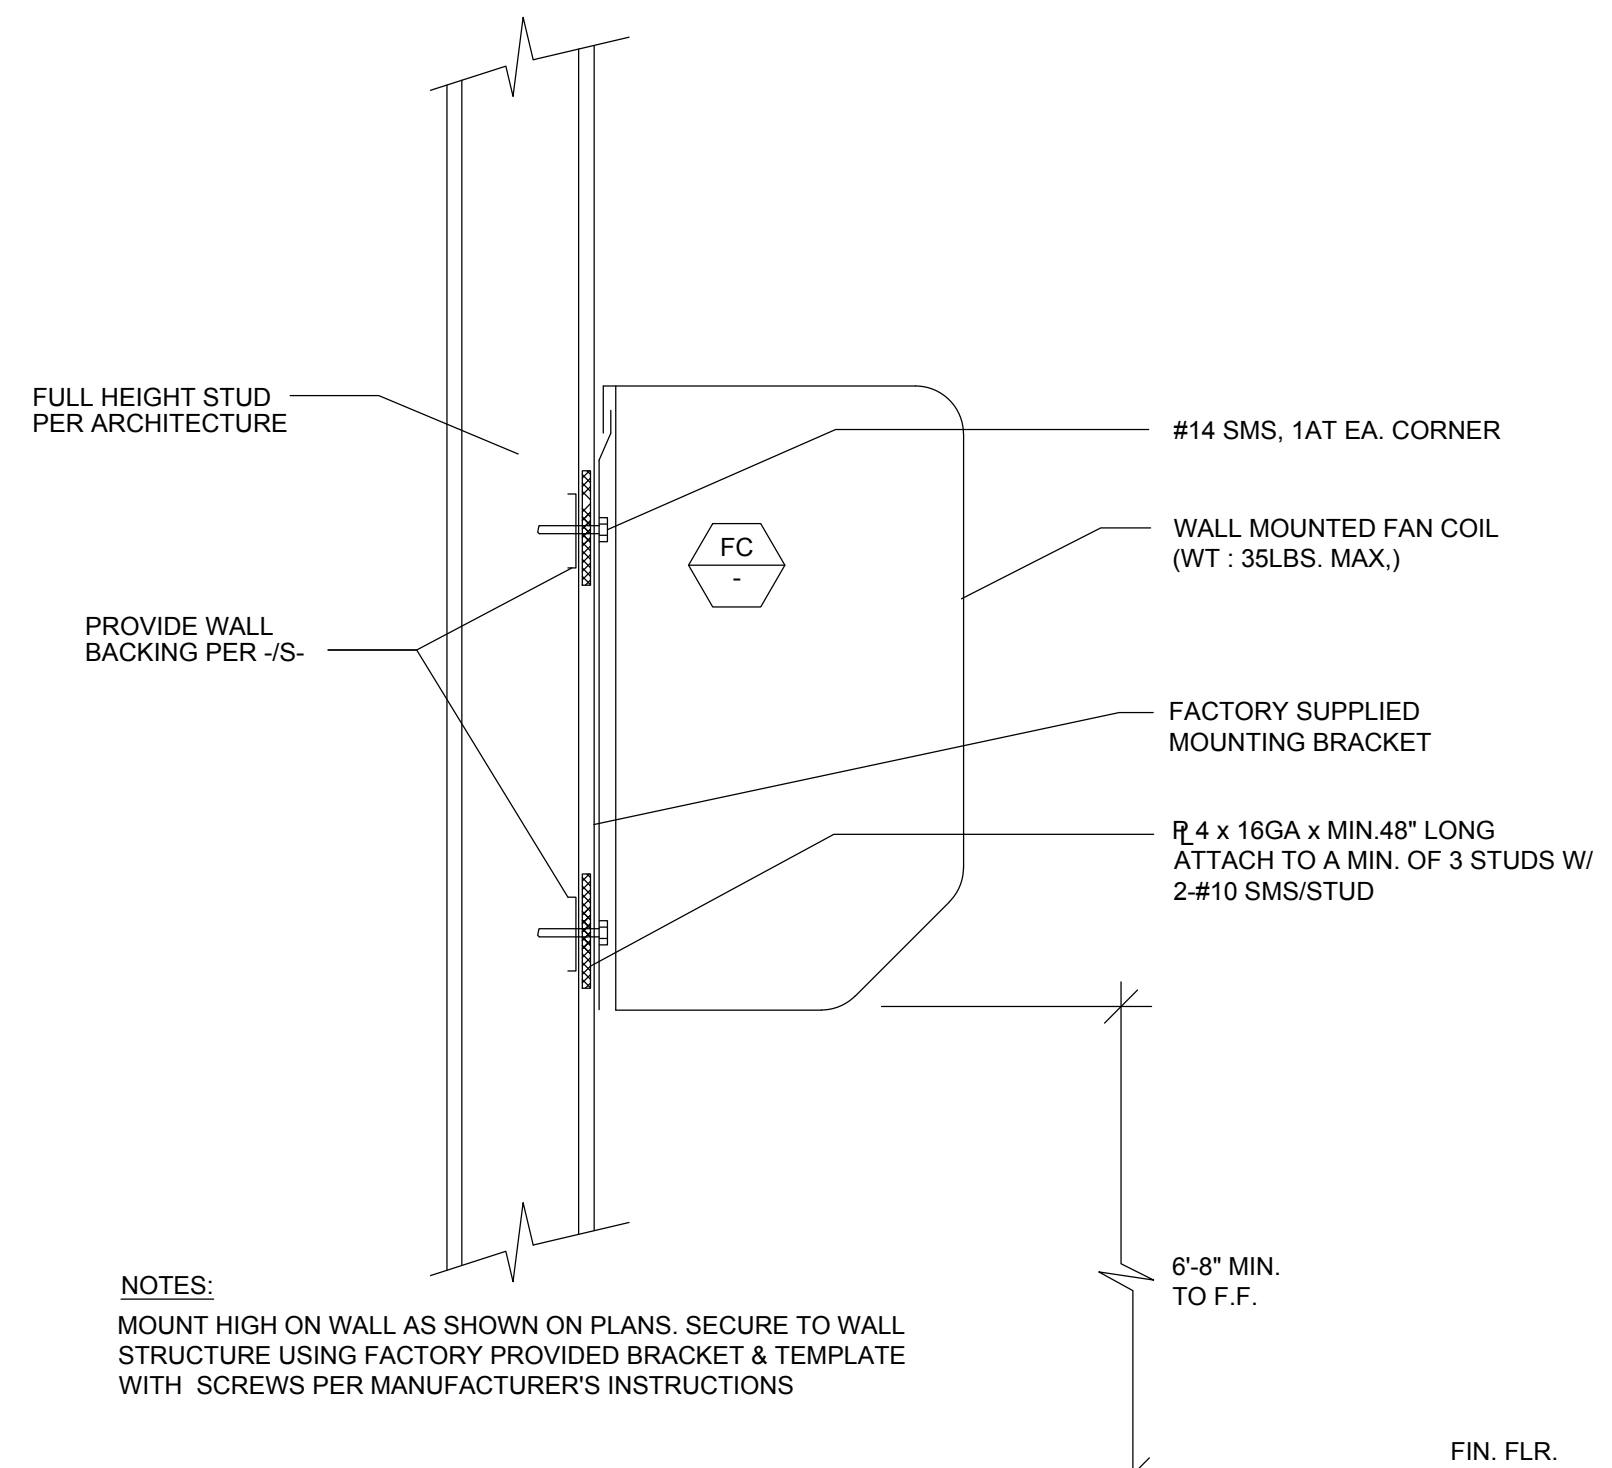
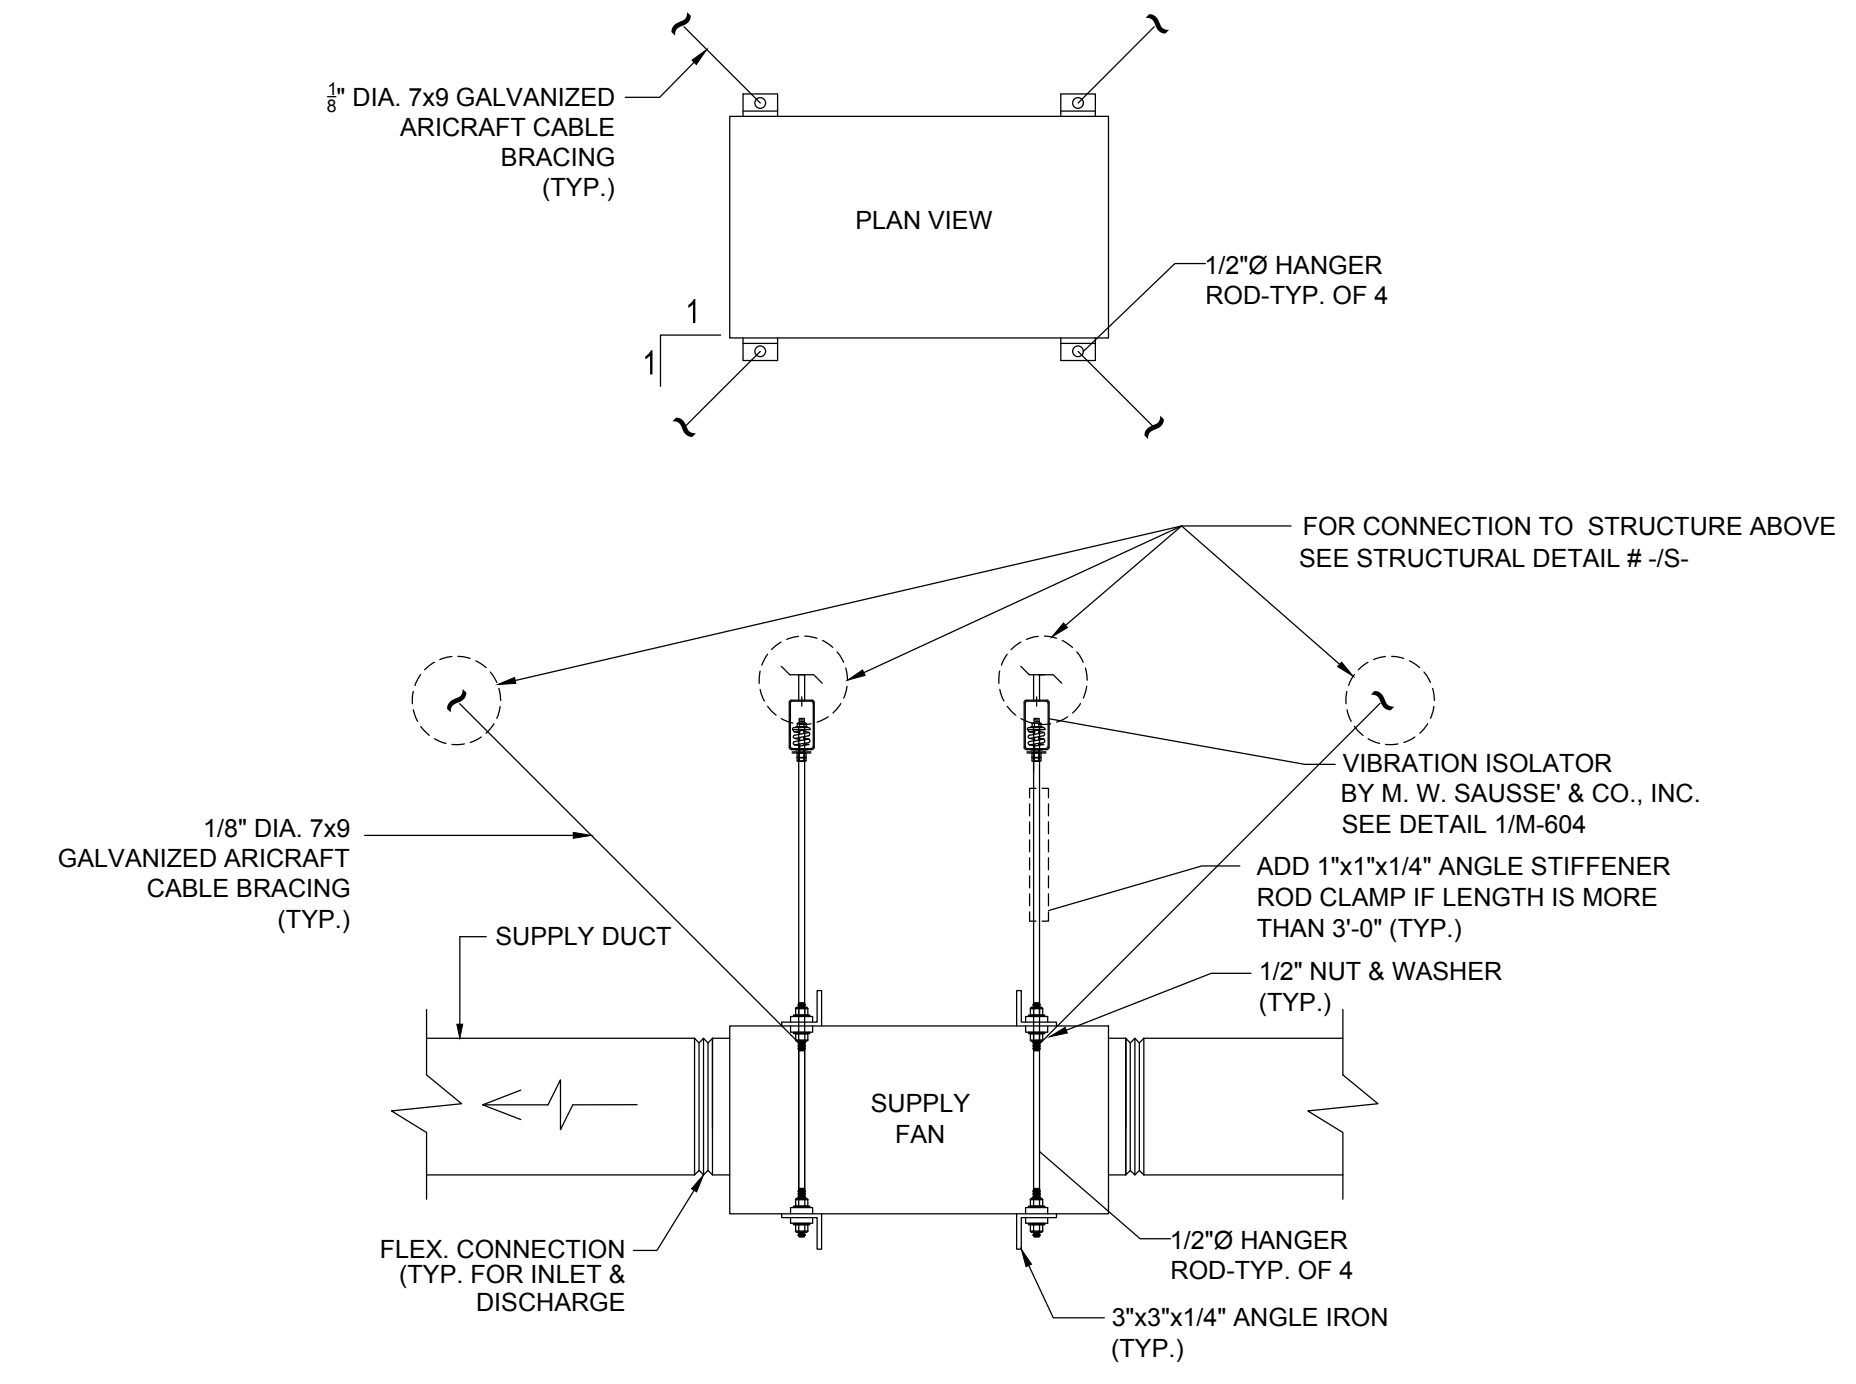

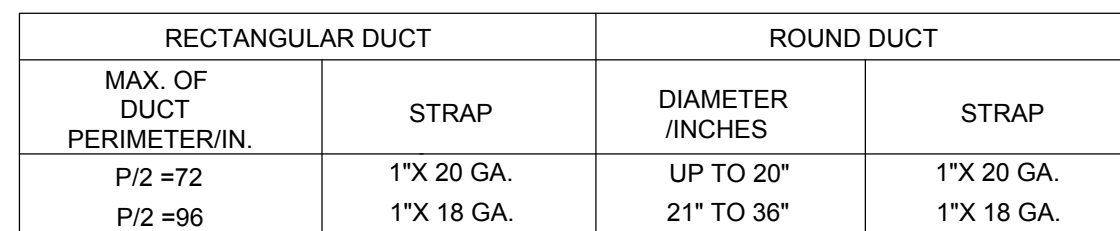
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ACCESS DOOR DETAIL			SCALE NONE	9	DUCT THRU NON-RATED WALL			SCALE NONE	6	REFRIGERANT PIPE SUPPORT ON WALL			SCALE NONE	3
			SCALE NONE	8				SCALE NONE	5				SCALE NONE	2
COMBINATION SMOKE FIRE DAMPER DETAIL			SCALE NONE	8	THERMOSTAT MOUNTING DETAIL			SCALE NONE	5	REFRIGERANT PIPE ON ROOF SUPPORT			SCALE NONE	2
			SCALE NONE	7				SCALE NONE	4				SCALE NONE	1
SPLIT SYSTEM INDOOR UNIT MOUNTING DETAIL			SCALE NONE	7	DETAIL			SCALE NONE	4	SUPPLY FAN (SF) MOUNTING DETAIL			SCALE NONE	1

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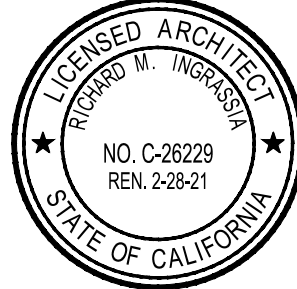
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Lincoln Middle School
1501 California Avenue
Santa Monica, California 90403

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Project No. 19009

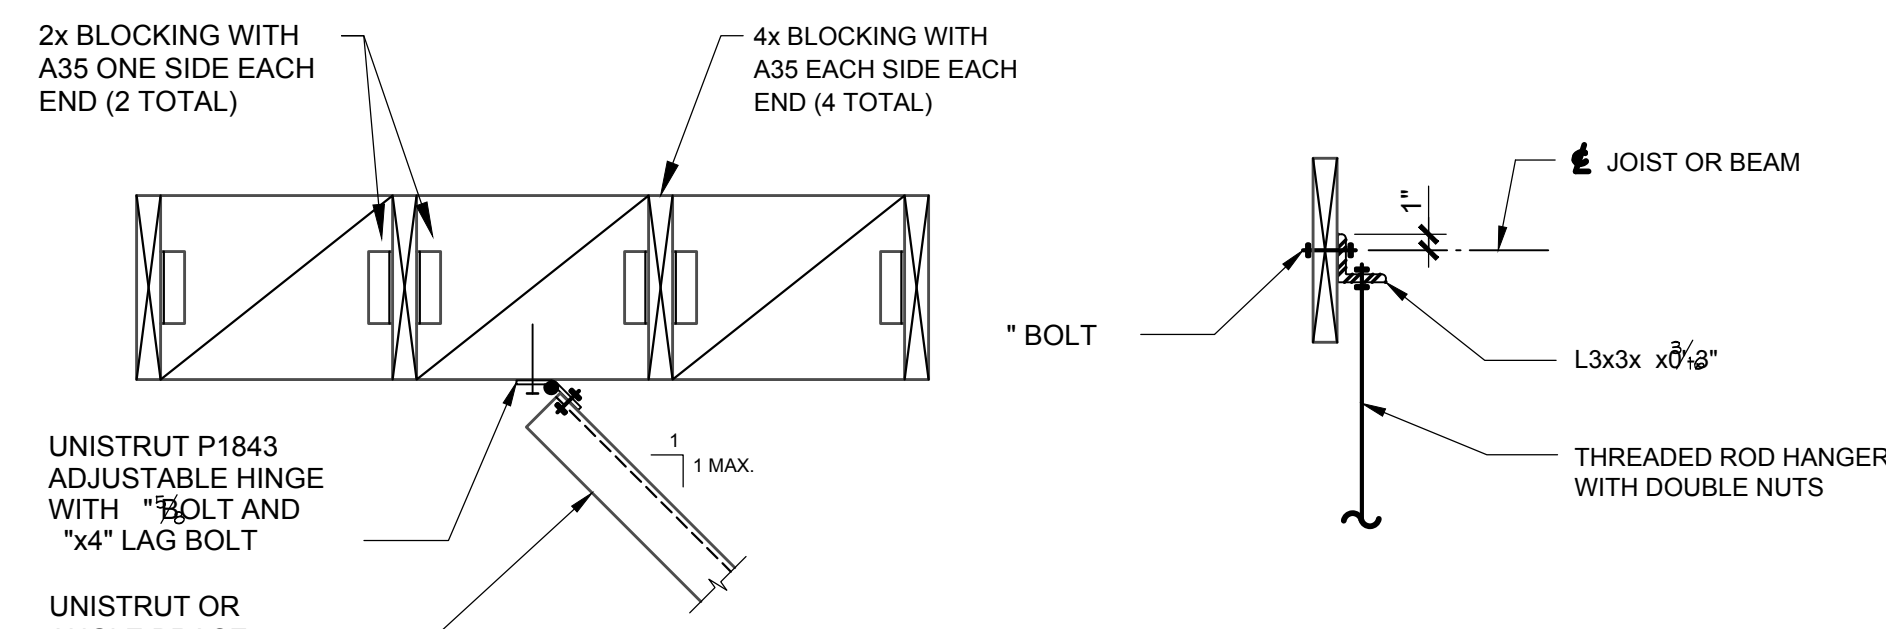Sheet Title

Mechanical Details

Sheet Number

M602

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DETAIL	SCALE NONE	9	DETAIL	SCALE NONE	6	DETAIL	SCALE NONE	3		
DETAIL	SCALE NONE	8	DETAIL	SCALE NONE	5	MAKE-UP AIR UNIT ON ROOF SUPPORT DETAIL				
DETAIL	SCALE NONE	7	(VRF) SYSTEM HEAT PUMP OUTDOOR CONDENSING UNIT MOUNTING DETAIL			SCALE NONE	4	ROOF MOUNTED EXHAUST FAN SUPPORT DETAIL		

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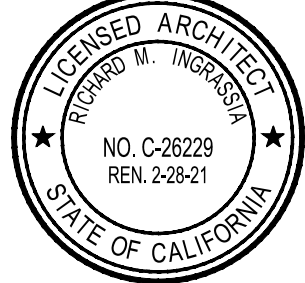
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Sheet Title

Mechanical Details

Sheet Number

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ROOF TOP GAS ELECTRIC PACKAGED UNIT MOUNTING DETAIL FOR CARRIER 48LCD008

ROOF TOP GAS ELECTRIC PACKAGED UNIT MOUNTING DETAIL FOR CARRIER 48GCLM05 & 06

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Architect




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Lincoln Middle School
1501 California Avenue
Santa Monica, California 90403

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Project No. 19009

Sheet Title

Mechanical Details

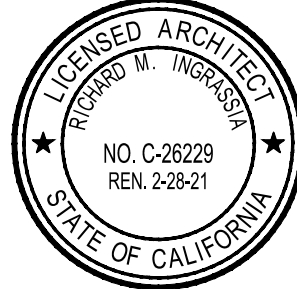Sheet Number

M604

Architect




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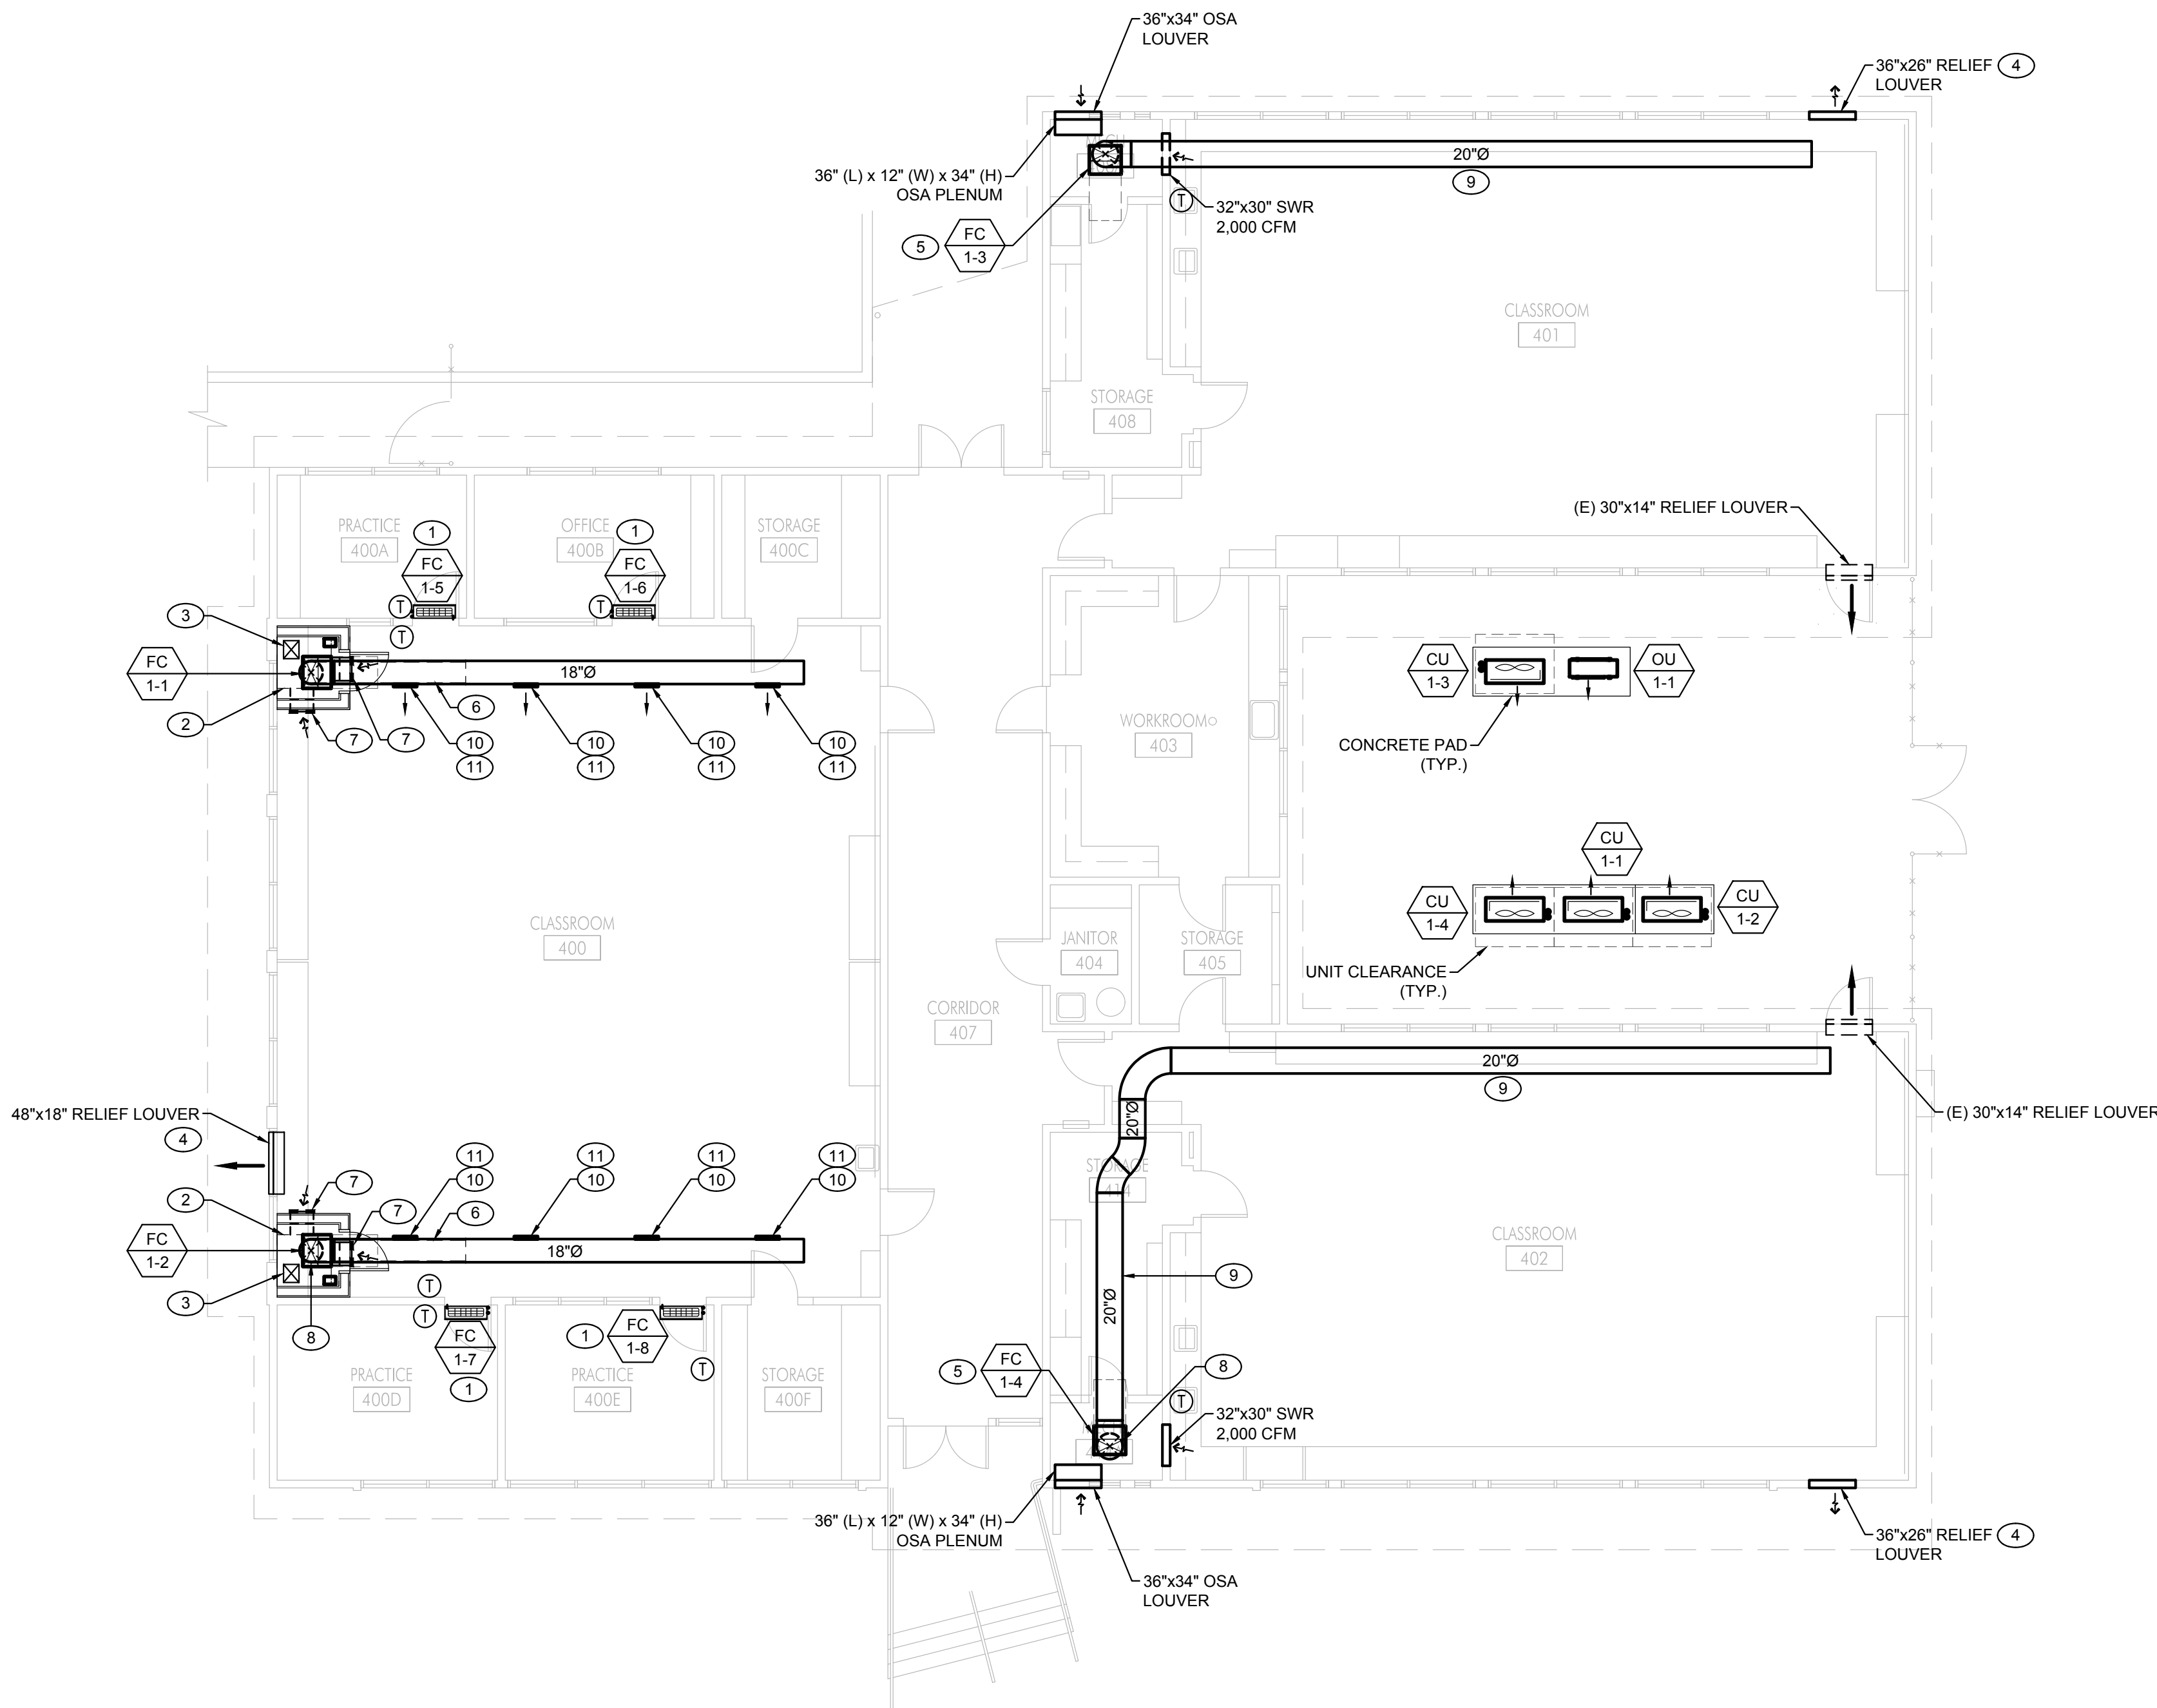
Sheet Title
Building 'A'
Mechanical Plan

Sheet Number

MA201


KEYNOTES

- 1 WALL MOUNTED FAN COIL UNIT. INSTALL PER MANUFACTURER'S RECOMMENDATIONS. COORDINATE LOCATION W/ ALL OTHER TRADES. ENSURE PROPER ACCESS SPACE FOR MAINTENANCE. FOR MOUNTING DETAIL SEE -JM-. RUN REFRIGERANT LINES TO CORRESPONDING CONDENSER UNIT PER MANUFACTURER RECOMMENDATION.
- 2 3'-4"x3'-6" RETURN AIR PLENUM BELOW FAN COIL UNIT.
- 3 12"x10" OSA DUCT W/ 1" LINING UP, DUCT OFFSET & UP THRU ROOF. PROVIDE ROOF JACK WITH WIRE MESH SCREEN.
- 4 PROVIDE BAROMETRIC RELIEF AIR DAMPER. SET DAMPER TO OPEN AT 0.05" PRESSURE.
- 5 PROVIDE MIXING BOX AT BOTTOM OF THE UNIT.
- 6 PROVIDE 1" DUCT LINER FOR FIRST 10'-0".
- 7 18x14 SWR AND CONNECT TO RETURN AIR PLENUM BELOW FAN COIL UNIT. PRICE \$50, \$75 CFM.
- 8 20"Ø SA DUCT DN & CONNECT TO FAN COIL UNIT
- 9 REUSE EXISTING DUCTWORK IN LIEU OF NEW DUCTWORK IF EXISTING DUCTWORK IN ORDER TO ACCOMMODATE WITH NEW UNIT. SEE DEMOLITION PLAN MAD201.
- 10 18"x6" SAG 400 CFM (TYP 4.)
- 11 PRICE SDG MODEL WITH AIR SCOOP (AS), DOUBLE DEFLECTION, (TYP.)

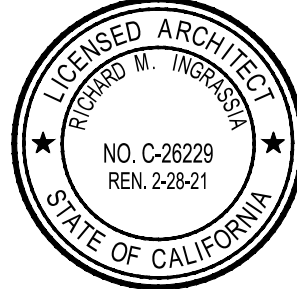


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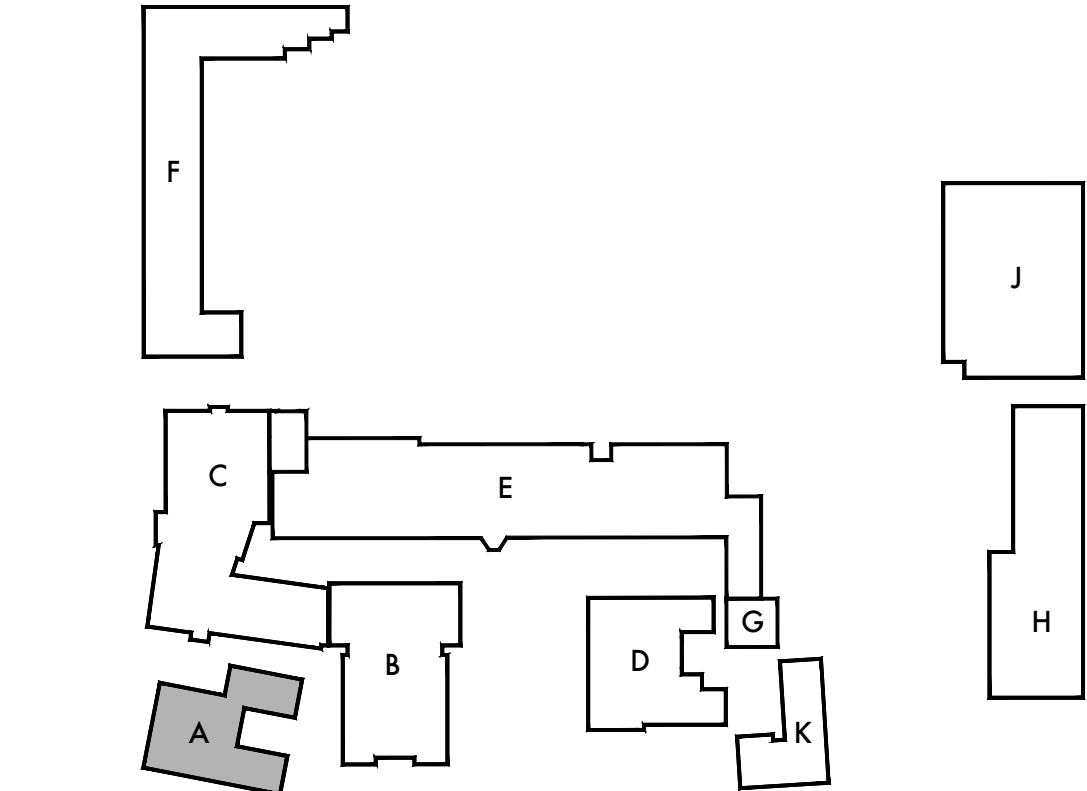
KEY PLAN

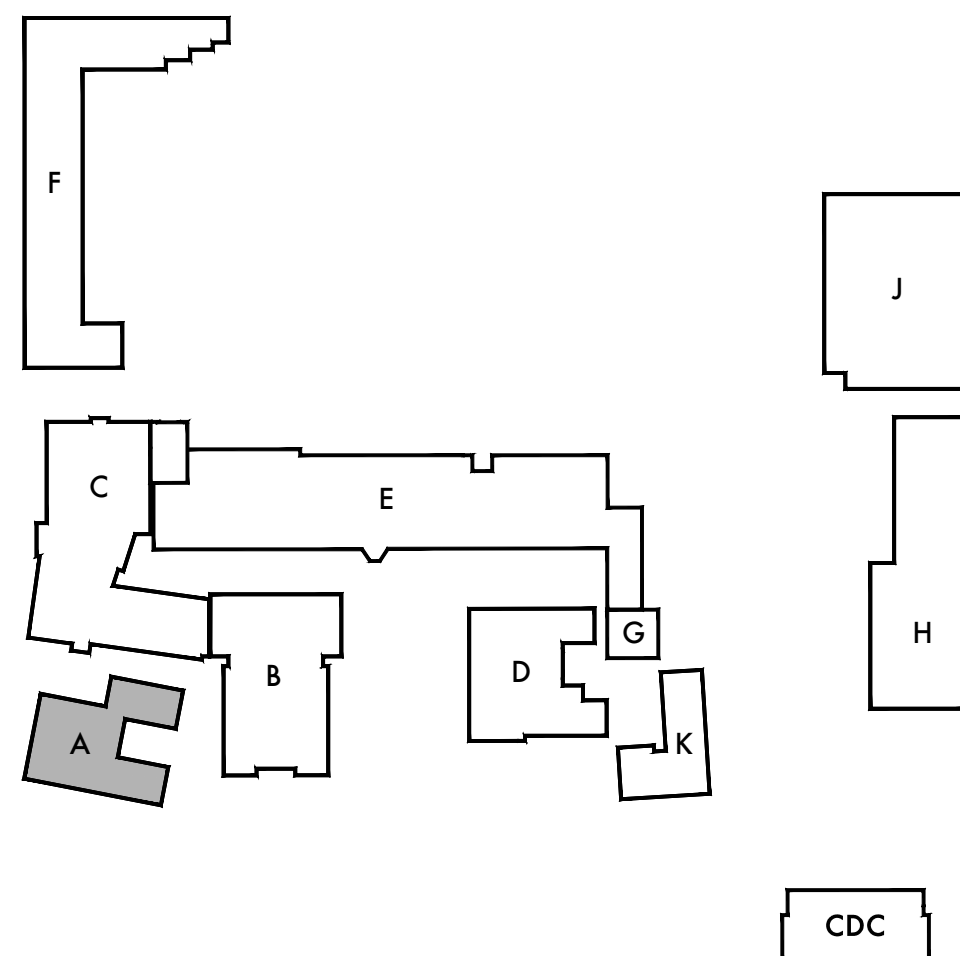

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KEY PLAN

KEYNOTES

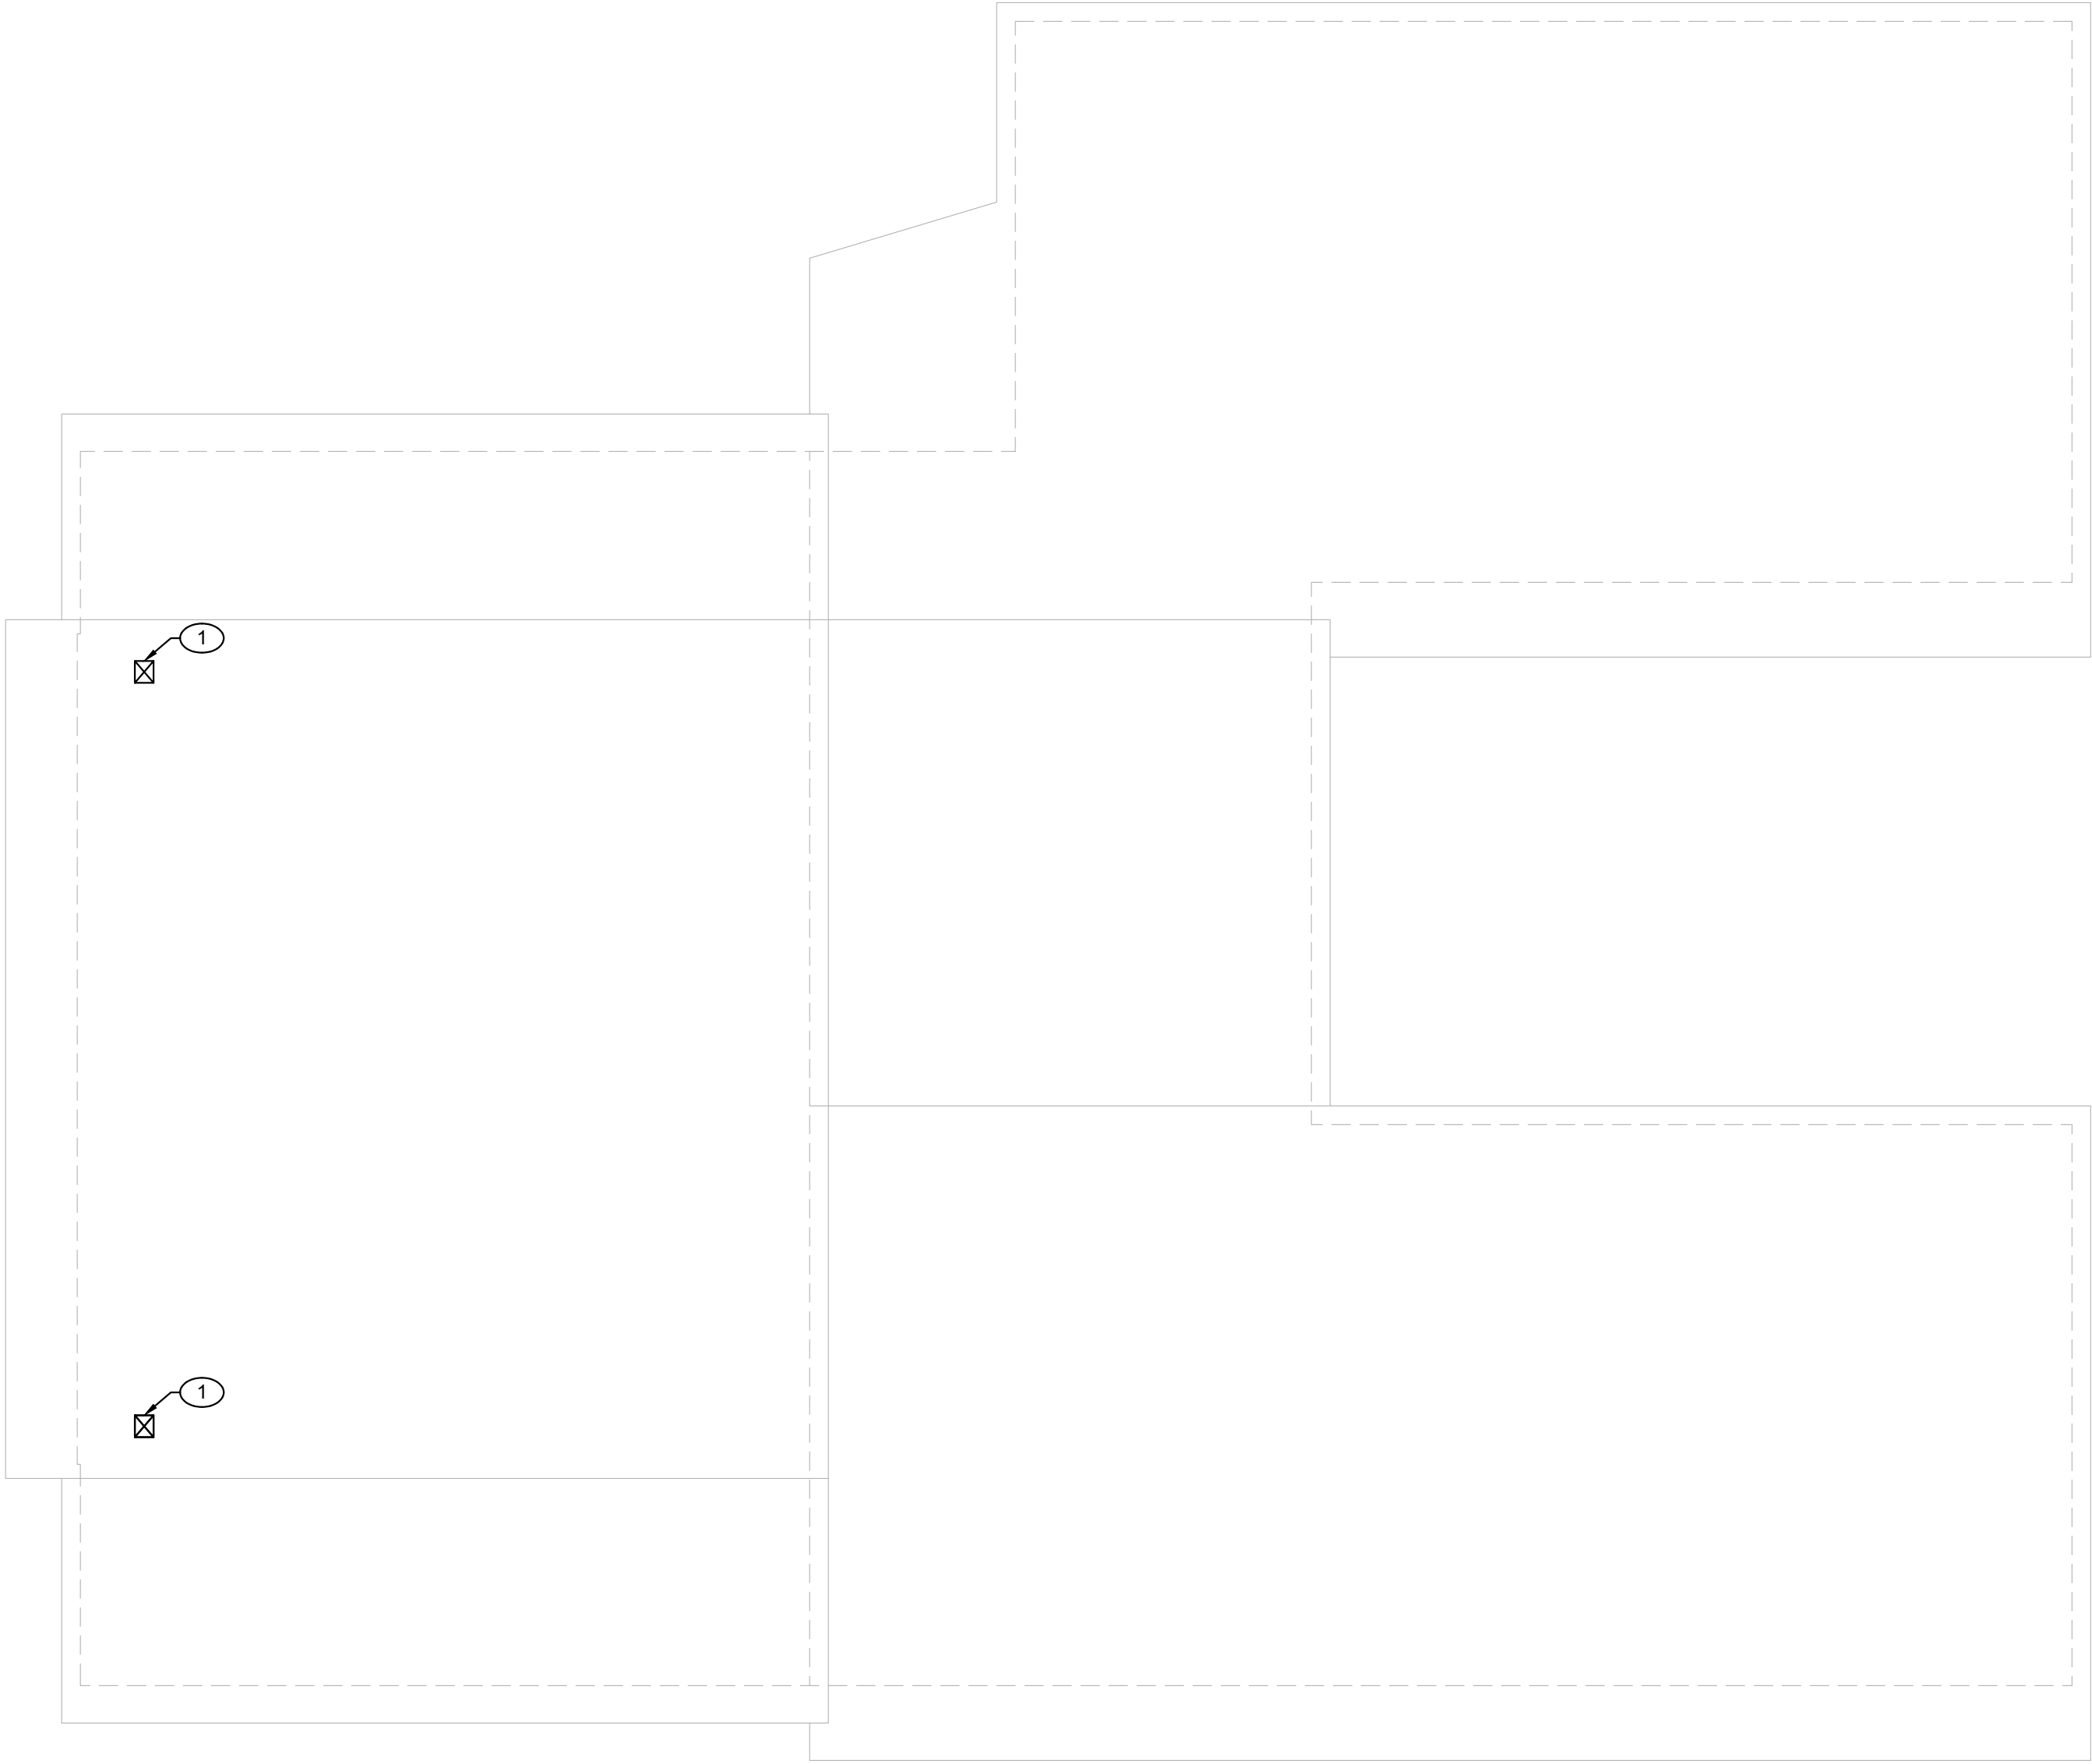- 1 12"x10" OSA DUCT W/ 1" LINING DN THRU ROOF, OFFSET DUCT & CONNECT TO RETURN AIR PLENUM. PROVIDE ROOF JACK WITH WIRE MESH SCREEN.

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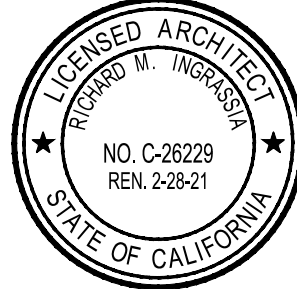
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Lincoln Middle School
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Santa Monica, California 90403

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Sheet Title
Building 'A'
Mechanical
Roof Plan

Sheet Number

MA202

DEMOLITION GENERAL NOTES

1. CONTRACTOR SHALL VISIT THE SITE PRIOR TO SUBMISSION OF BID AND CONDUCT A THOROUGH FIELD INVESTIGATION TO VERIFY EXISTING CONDITIONS AND BE THOROUGHLY FAMILIAR WITH THE DEMOLITION SCOPE OF WORK. HE SHALL FURNISH ALL LABORS, SUPERVISION, MATERIALS, EQUIPMENT AND FACILITIES NECESSARY TO CARRY OUT THIS WORK AND SUBMIT ALL QUESTIONS IN WRITING PRIOR TO BID.
2. ANY EXISTING TO REMAIN EQUIPMENT AND DUCTWORK OUTSIDE OF DASHED LINES SCOPE OF WORK, SHALL BE REPAIRED, CLEANED AND PAINTED BY CONTRACTOR PER DISTRICT'S STANDARDS.
3. CONTRACTOR SHALL REPAIR, PATCH AND SEAL ALL UNUSED OR DAMAGED WALL AND ROOF OPENINGS/ PENETRATIONS TO BUILDING CAUSED BY DEMOLITION OF EQUIPMENT, PIPING, DUCTWORK, SUPPORTS, ETC.
4. CONTRACTOR SHALL REMOVE AND DISPOSE OF ALL EXISTING REGISTERS, DUCTWORK AND RELATED APPURTENANCES SHOWN WITHIN DASHED LINES SCOPE OF WORK. THEY MUST NOT BE ABANDONED IN PLACE UNLESS NOTED OTHERWISE
5. ALL DAMAGED, BROKEN OR INOPERABLE AIR DEVICES OR DAMPERS SHALL BE REPLACED BY CONTRACTOR WITH NEW LIKE SIZED COMPONENTS OR AIR DEVICES. CONTRACTOR SHALL CONDUCT A THOROUGH FIELD INVESTIGATION TO VERIFY EXISTING CONDITIONS PRIOR TO BIDDING. SUBMIT ALL QUESTIONS IN WRITING PRIOR TO BID.
6. CONTRACTOR SHALL INSTALL ALL EQUIPMENT AND DEVICES SUCH THAT COMPONENTS WILL BE ACCESSIBLE FOR MAINTENANCE.
7. FIRE PROTECTION DURING DEMOLITION / CONSTRUCTION SHALL BE IN ACCORDANCE WITH 2016 CBC, CHAPTER 33.


DEMOLITION KEYNOTES

- 1 REMOVE (E) HEATING SYSTEM, DUCTWORK SUPPORTS, FLUE, PAD, THERMOSTAT, CONTROL, AND ACCESSORIES WITHIN THE SCOPE OF WORK AREA UNLESS OTHERWISE NOTED. ALL ASSOCIATED APPURTENANCES AND DISPOSED OF PER OWNER'S DIRECTION. CONTRACTOR SHALL REPAIR, PATCH AND PAINT ALL ROOF, WALL, CEILING, FLOOR INCLUDING ANY ASSOCIATED OPENINGS OR PENETRATIONS TO MATCH ADJACENT SURFACES PER ARCHITECTURAL DRAWINGS.
- 2 REMAIN EXISTING DUCTWORK IF EXISTING DUCTWORK IN ORDER TO ACCOMMODATE WITH NEW UNIT.


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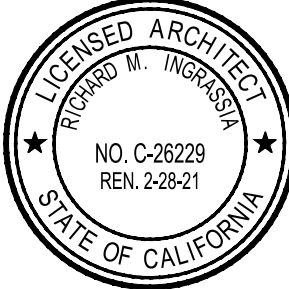


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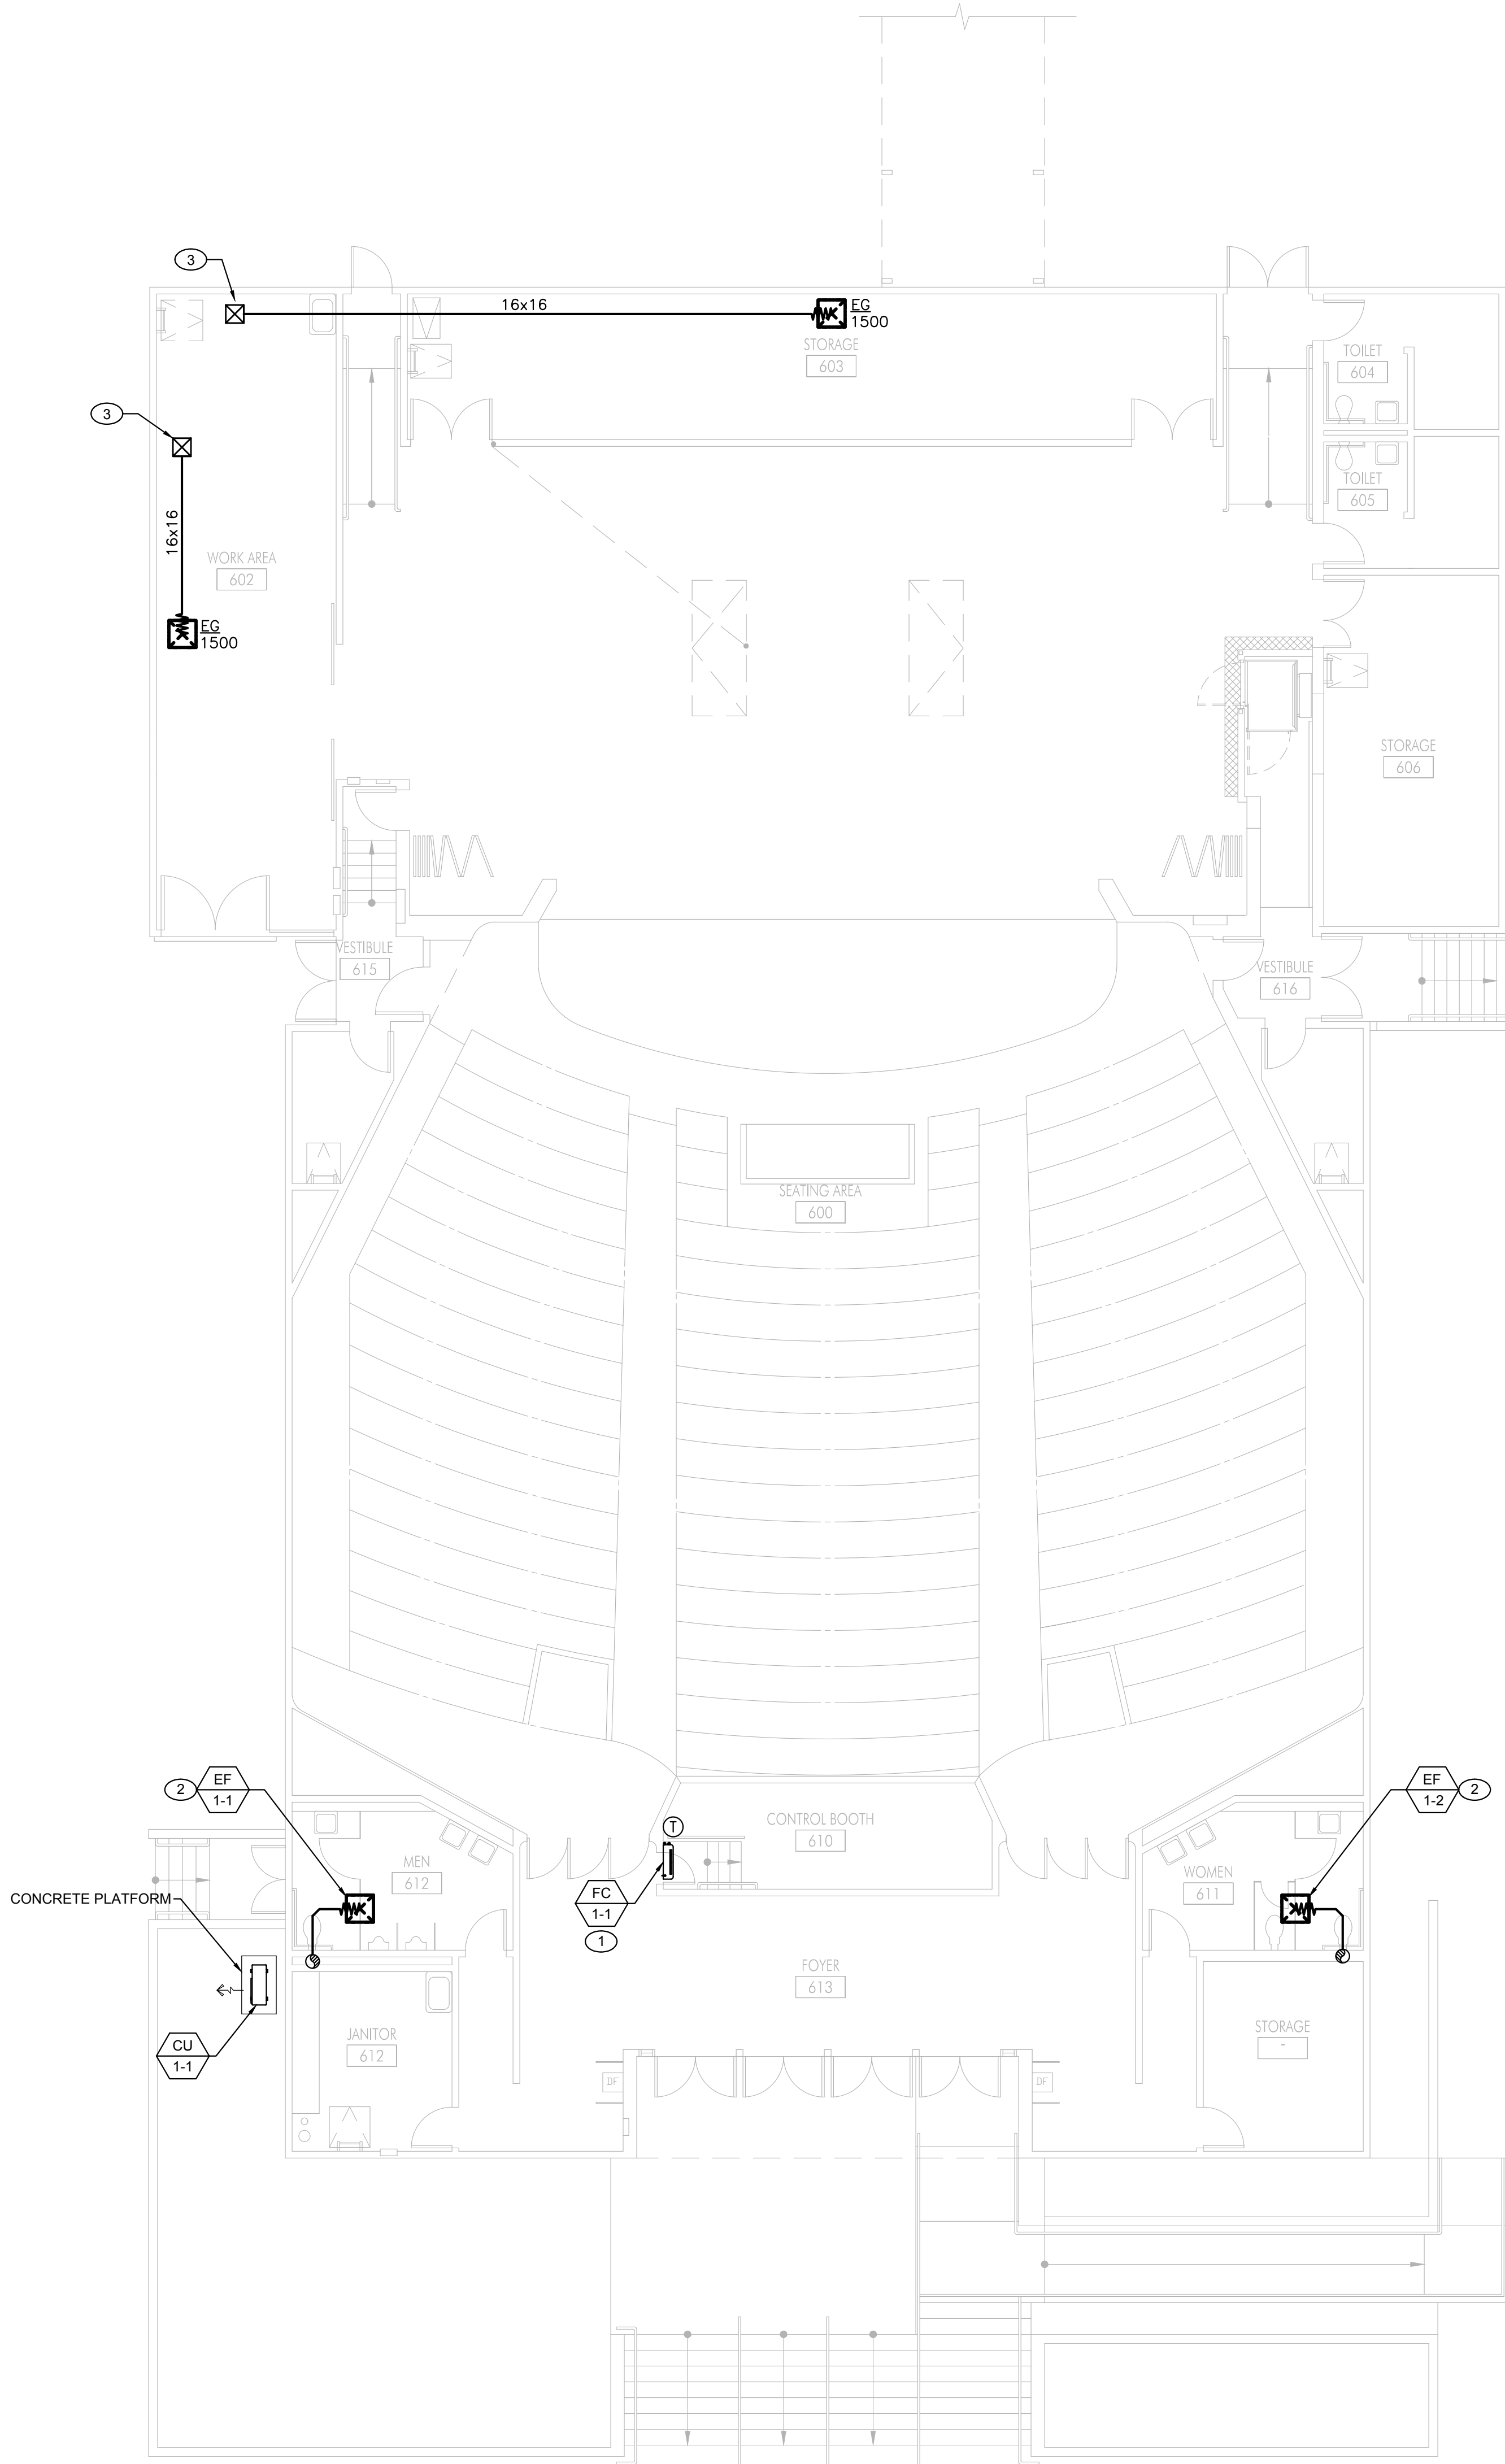


Sheet Title
Building 'A'
Mechanical
Demolition Plan

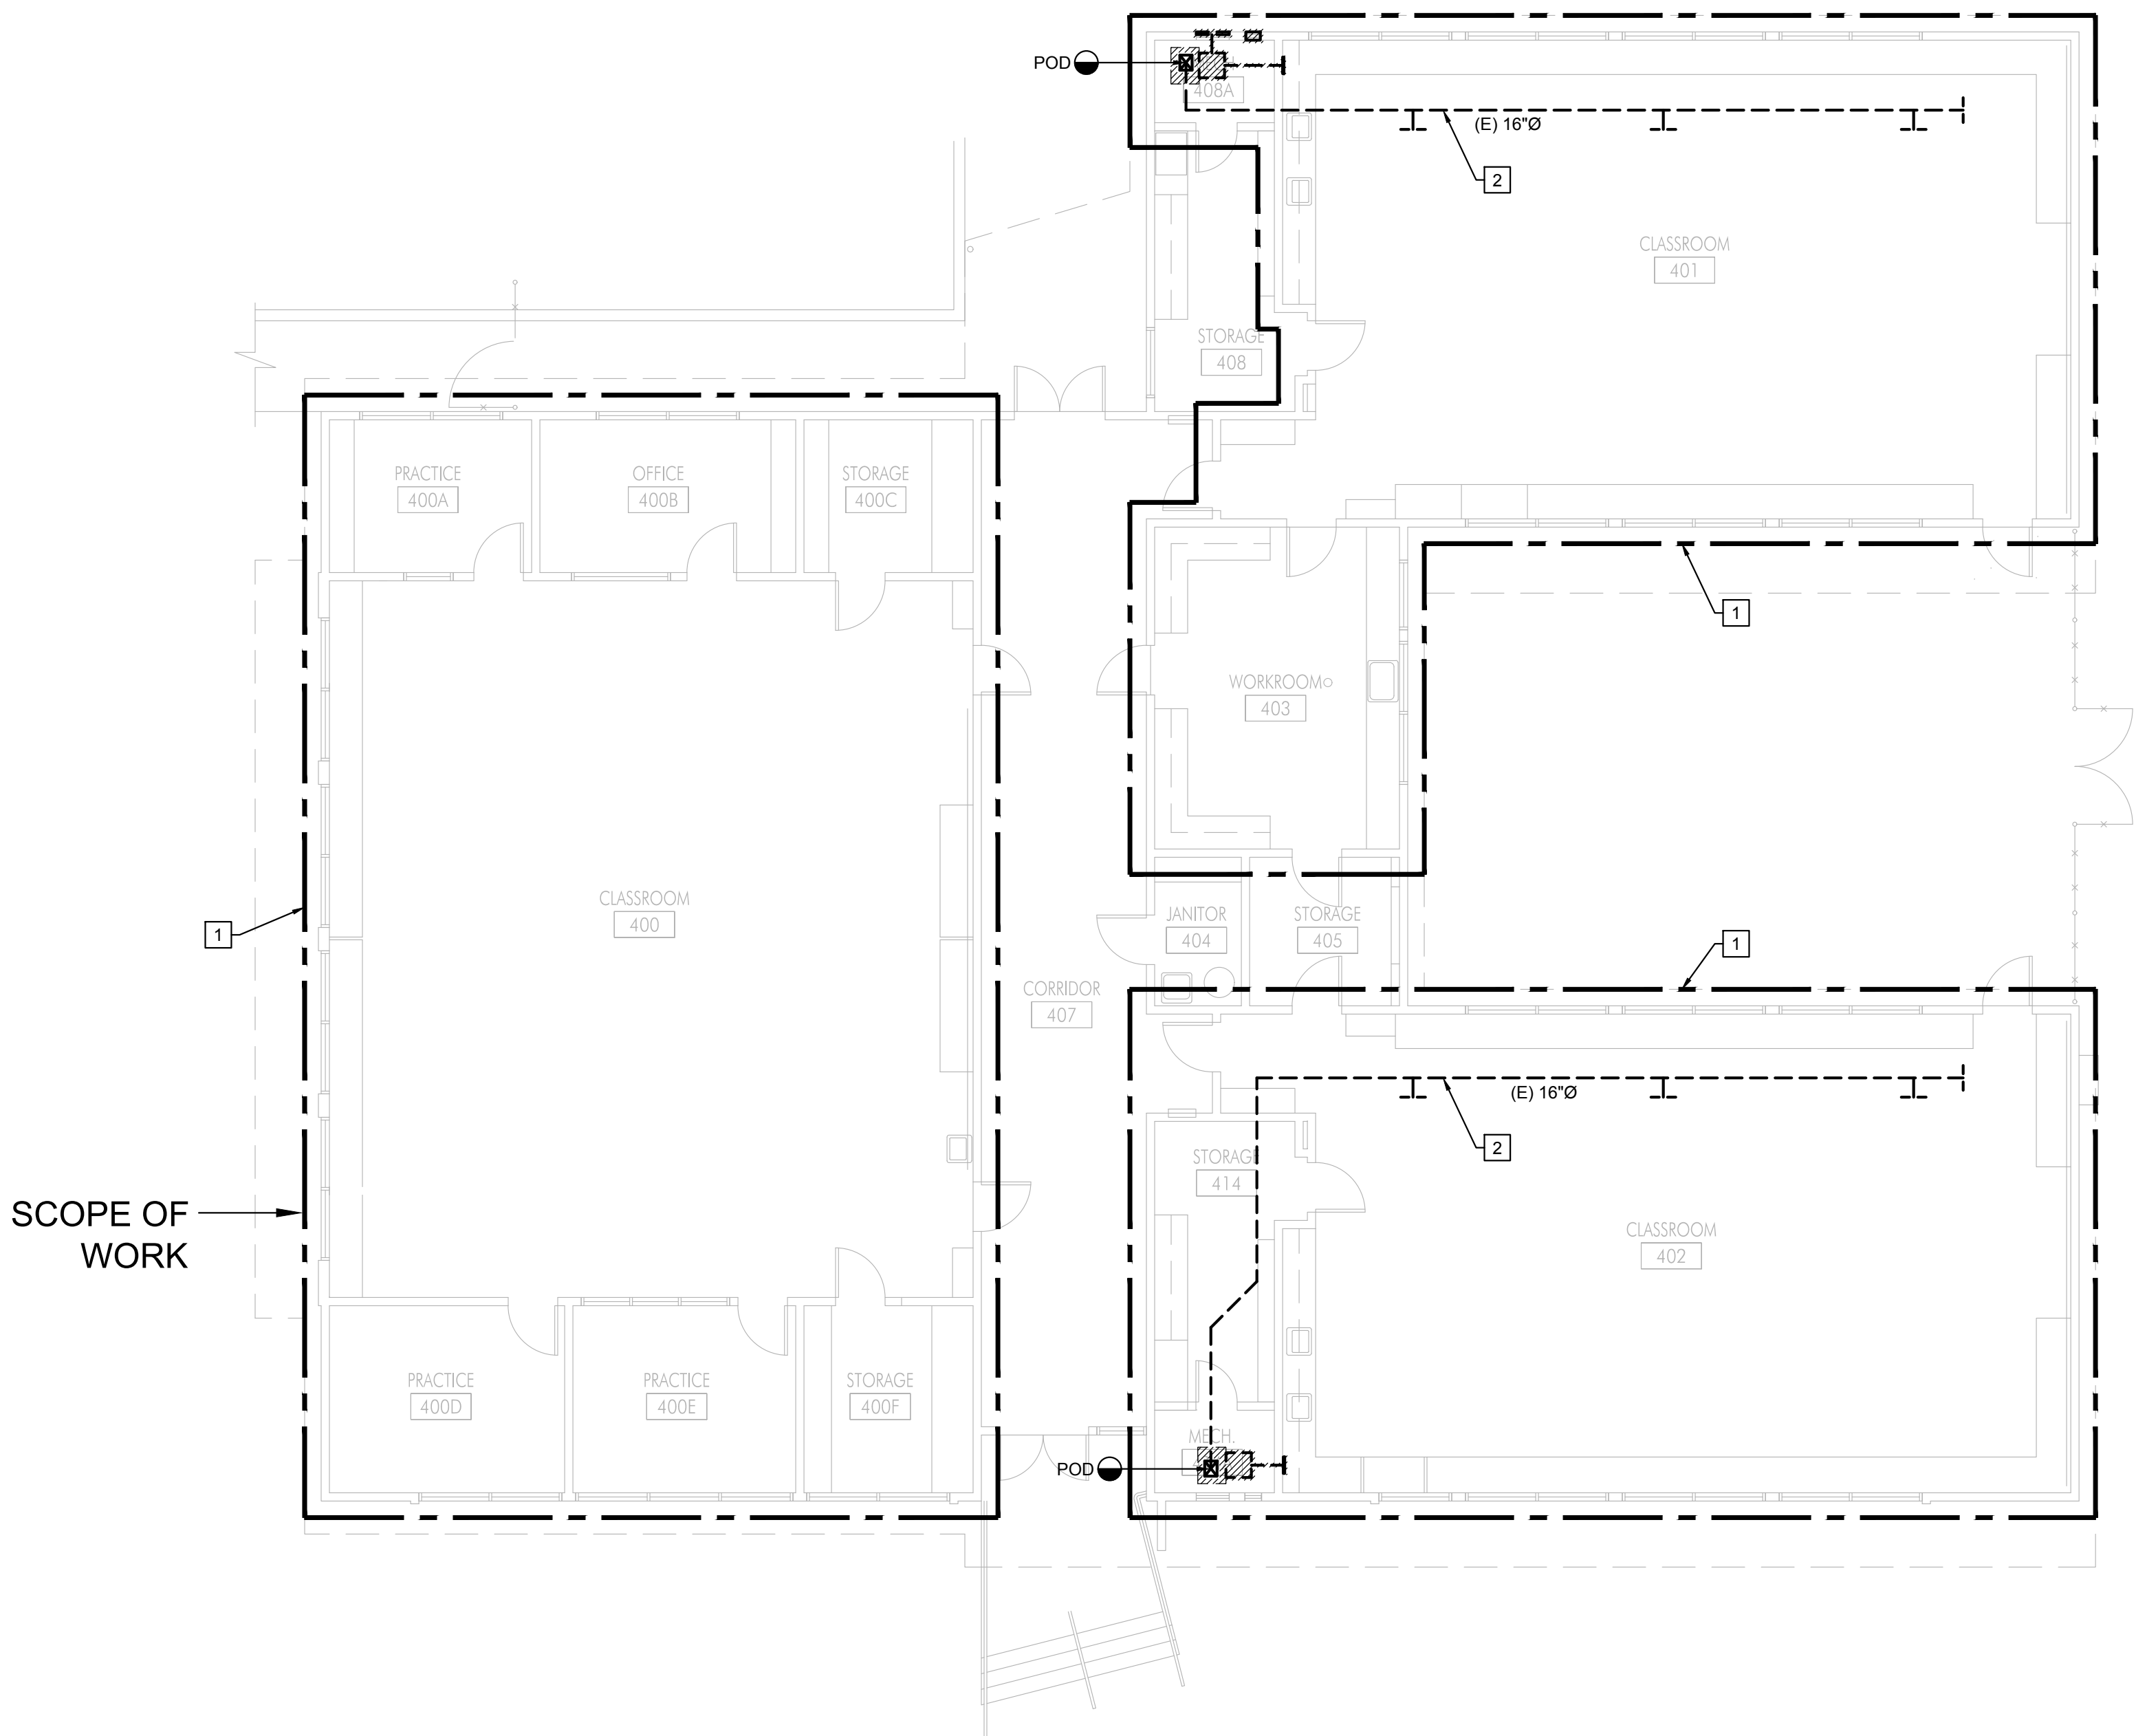Sheet Number

MAD201
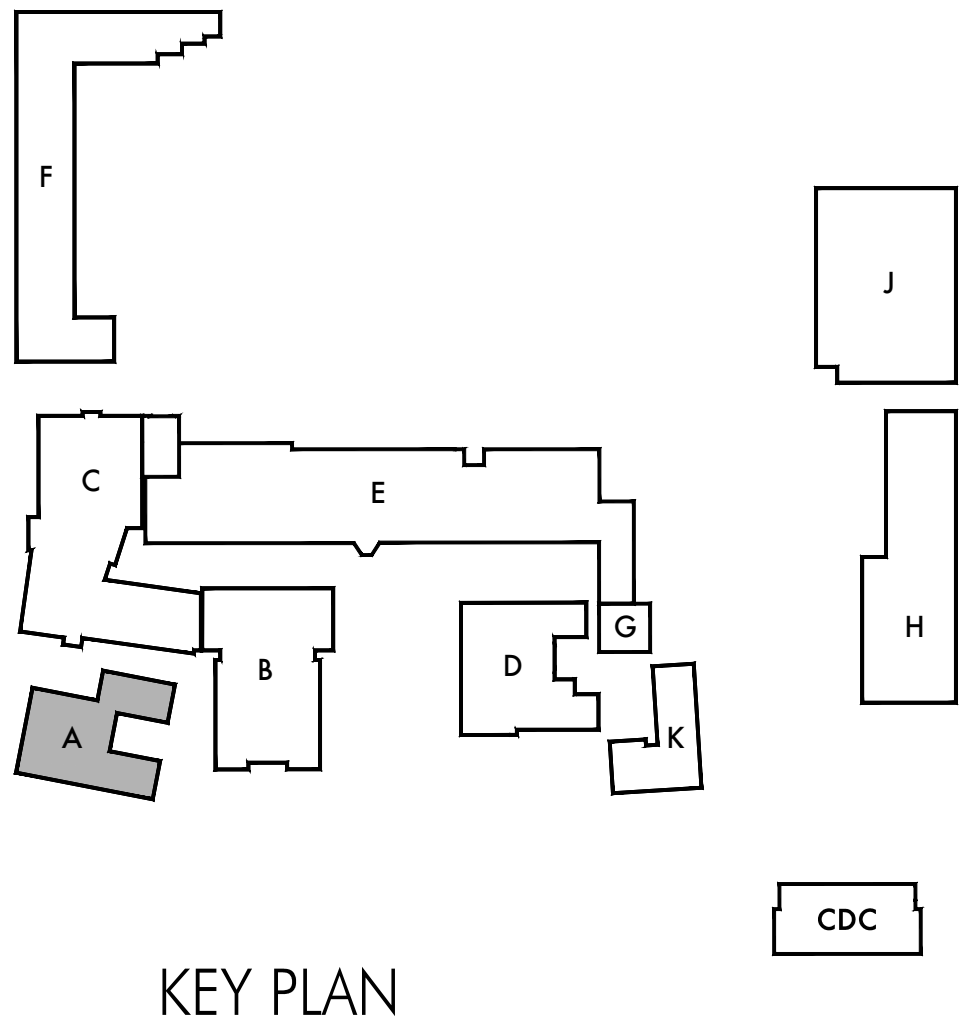
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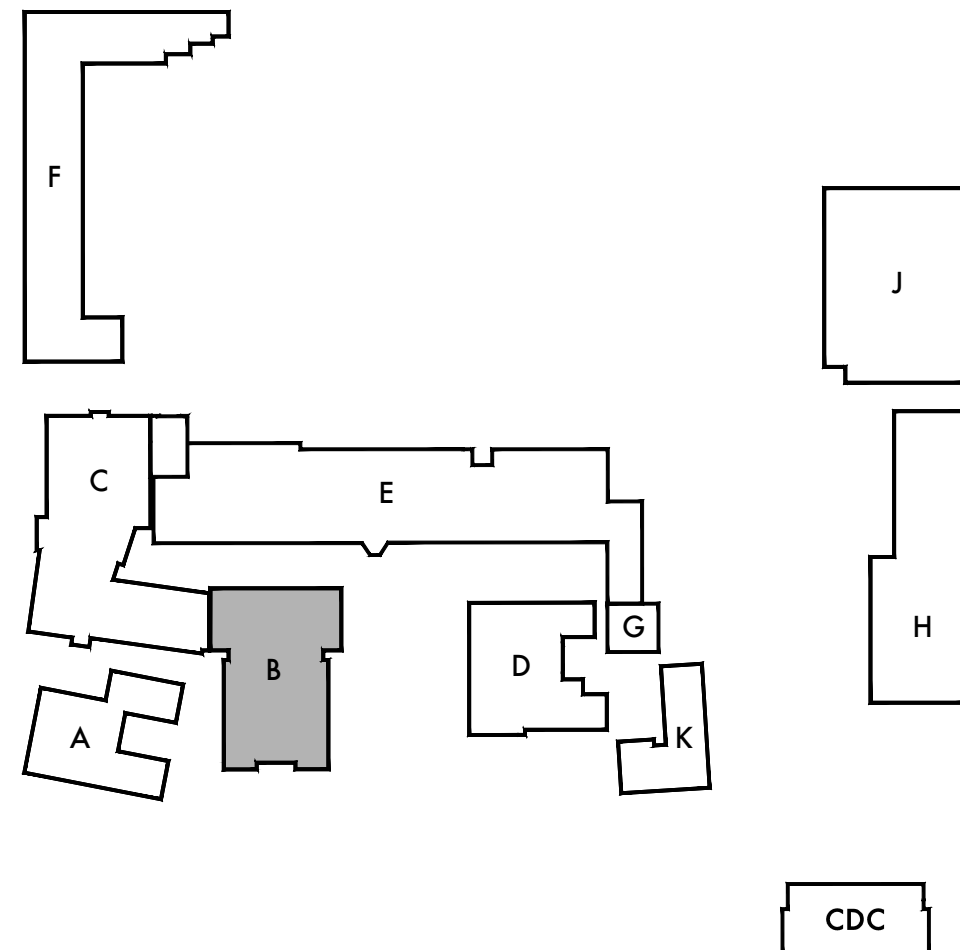


KEYNOTES

- 1 WALL MOUNTED FAN COIL UNIT. INSTALL PER MANUFACTURER'S RECOMMENDATIONS. COORDINATE LOCATION W/ ALL OTHER TRADES. ENSURE PROPER ACCESS SPACE FOR MAINTENANCE. FOR MOUNTING DETAIL SEE -M-. RUN REFRIGERANT LINES TO CORRESPONDING CONDENSER UNIT PER MANUFACTURER RECOMMENDATION.
- 2 CEILING EXHAUST FAN WITH 10"Ø DUCT VENT UP THRU ROOF WITH ROOF JACK, 330 CFM).
- 3 16x16 RELIEF DUCT VENT UP THRU ROOF TO ROOFTOP RELIEF VENTILATOR, 1500 CFMR.



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KEY PLAN

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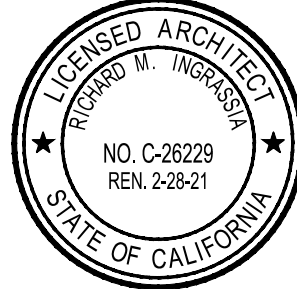
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Project No. 19009

Sheet Title
Building 'B'
Mechanical Plan

Sheet Number

MB201

Architect




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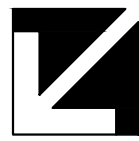
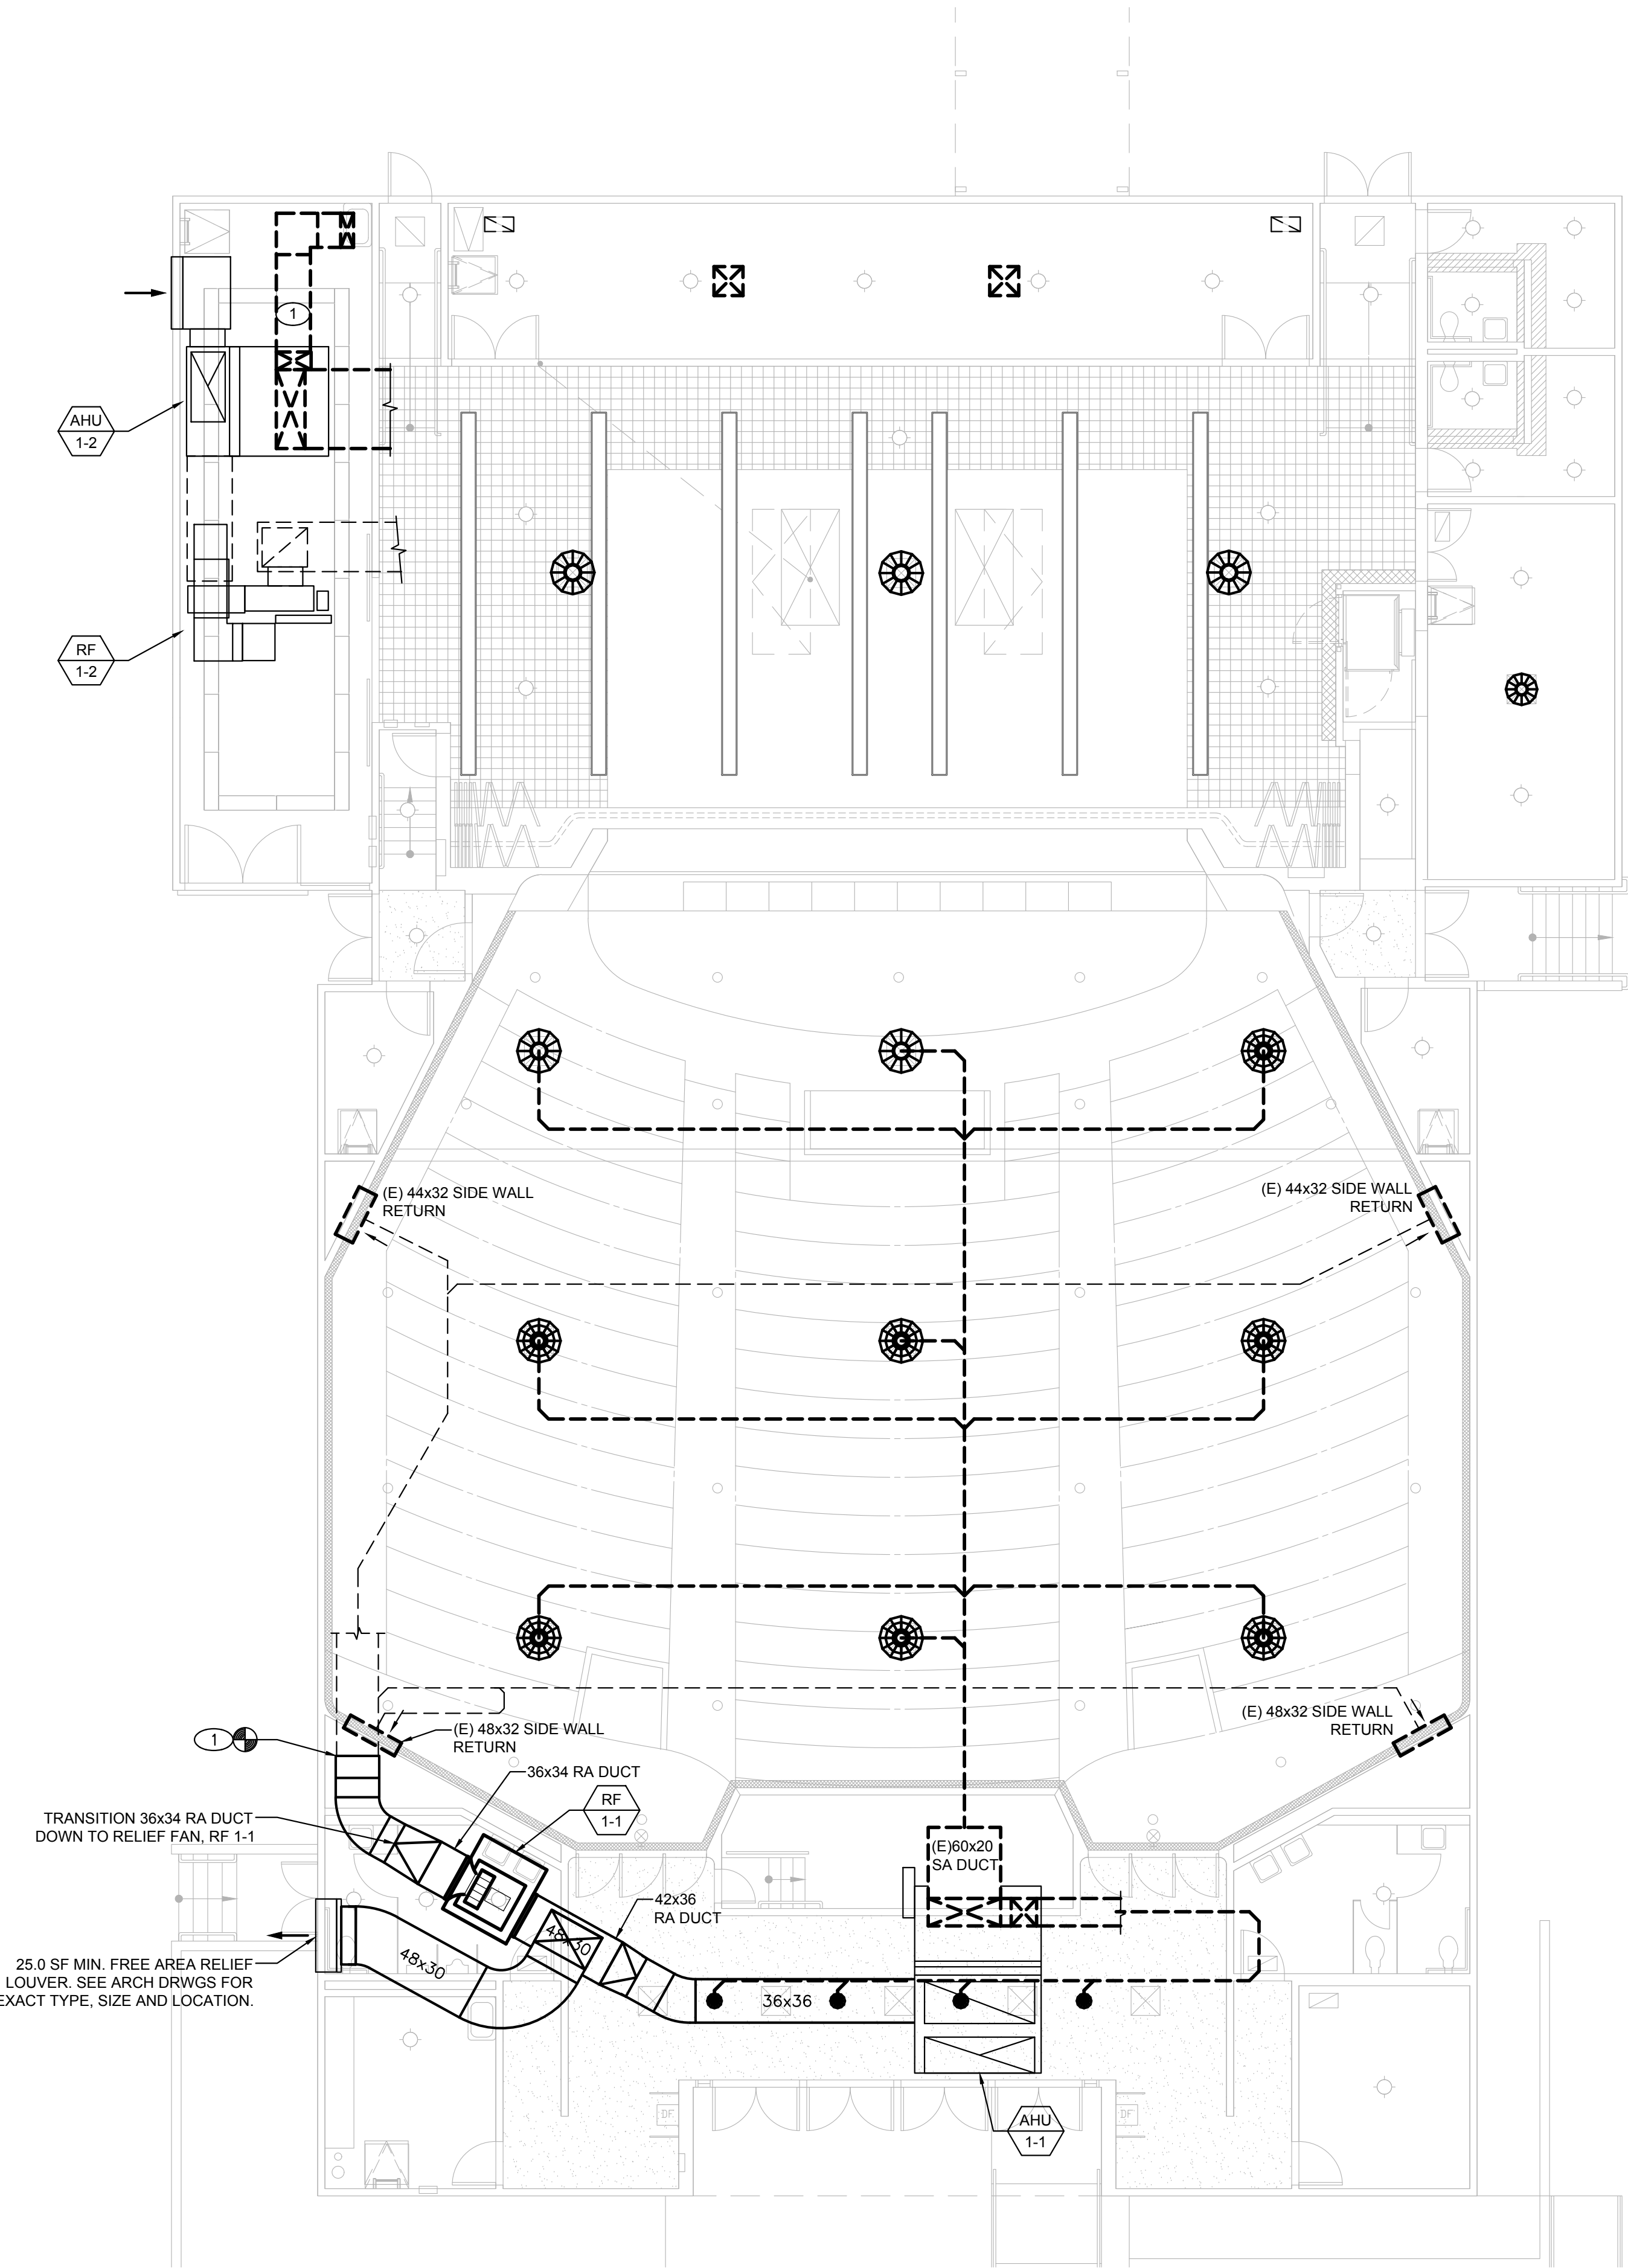
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Sheet Title

Buildings 'B'
Mechanical
Mezzanine Plan

Sheet Number

MB202

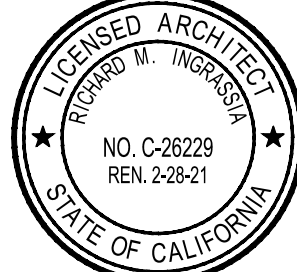

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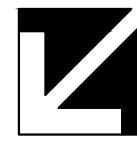
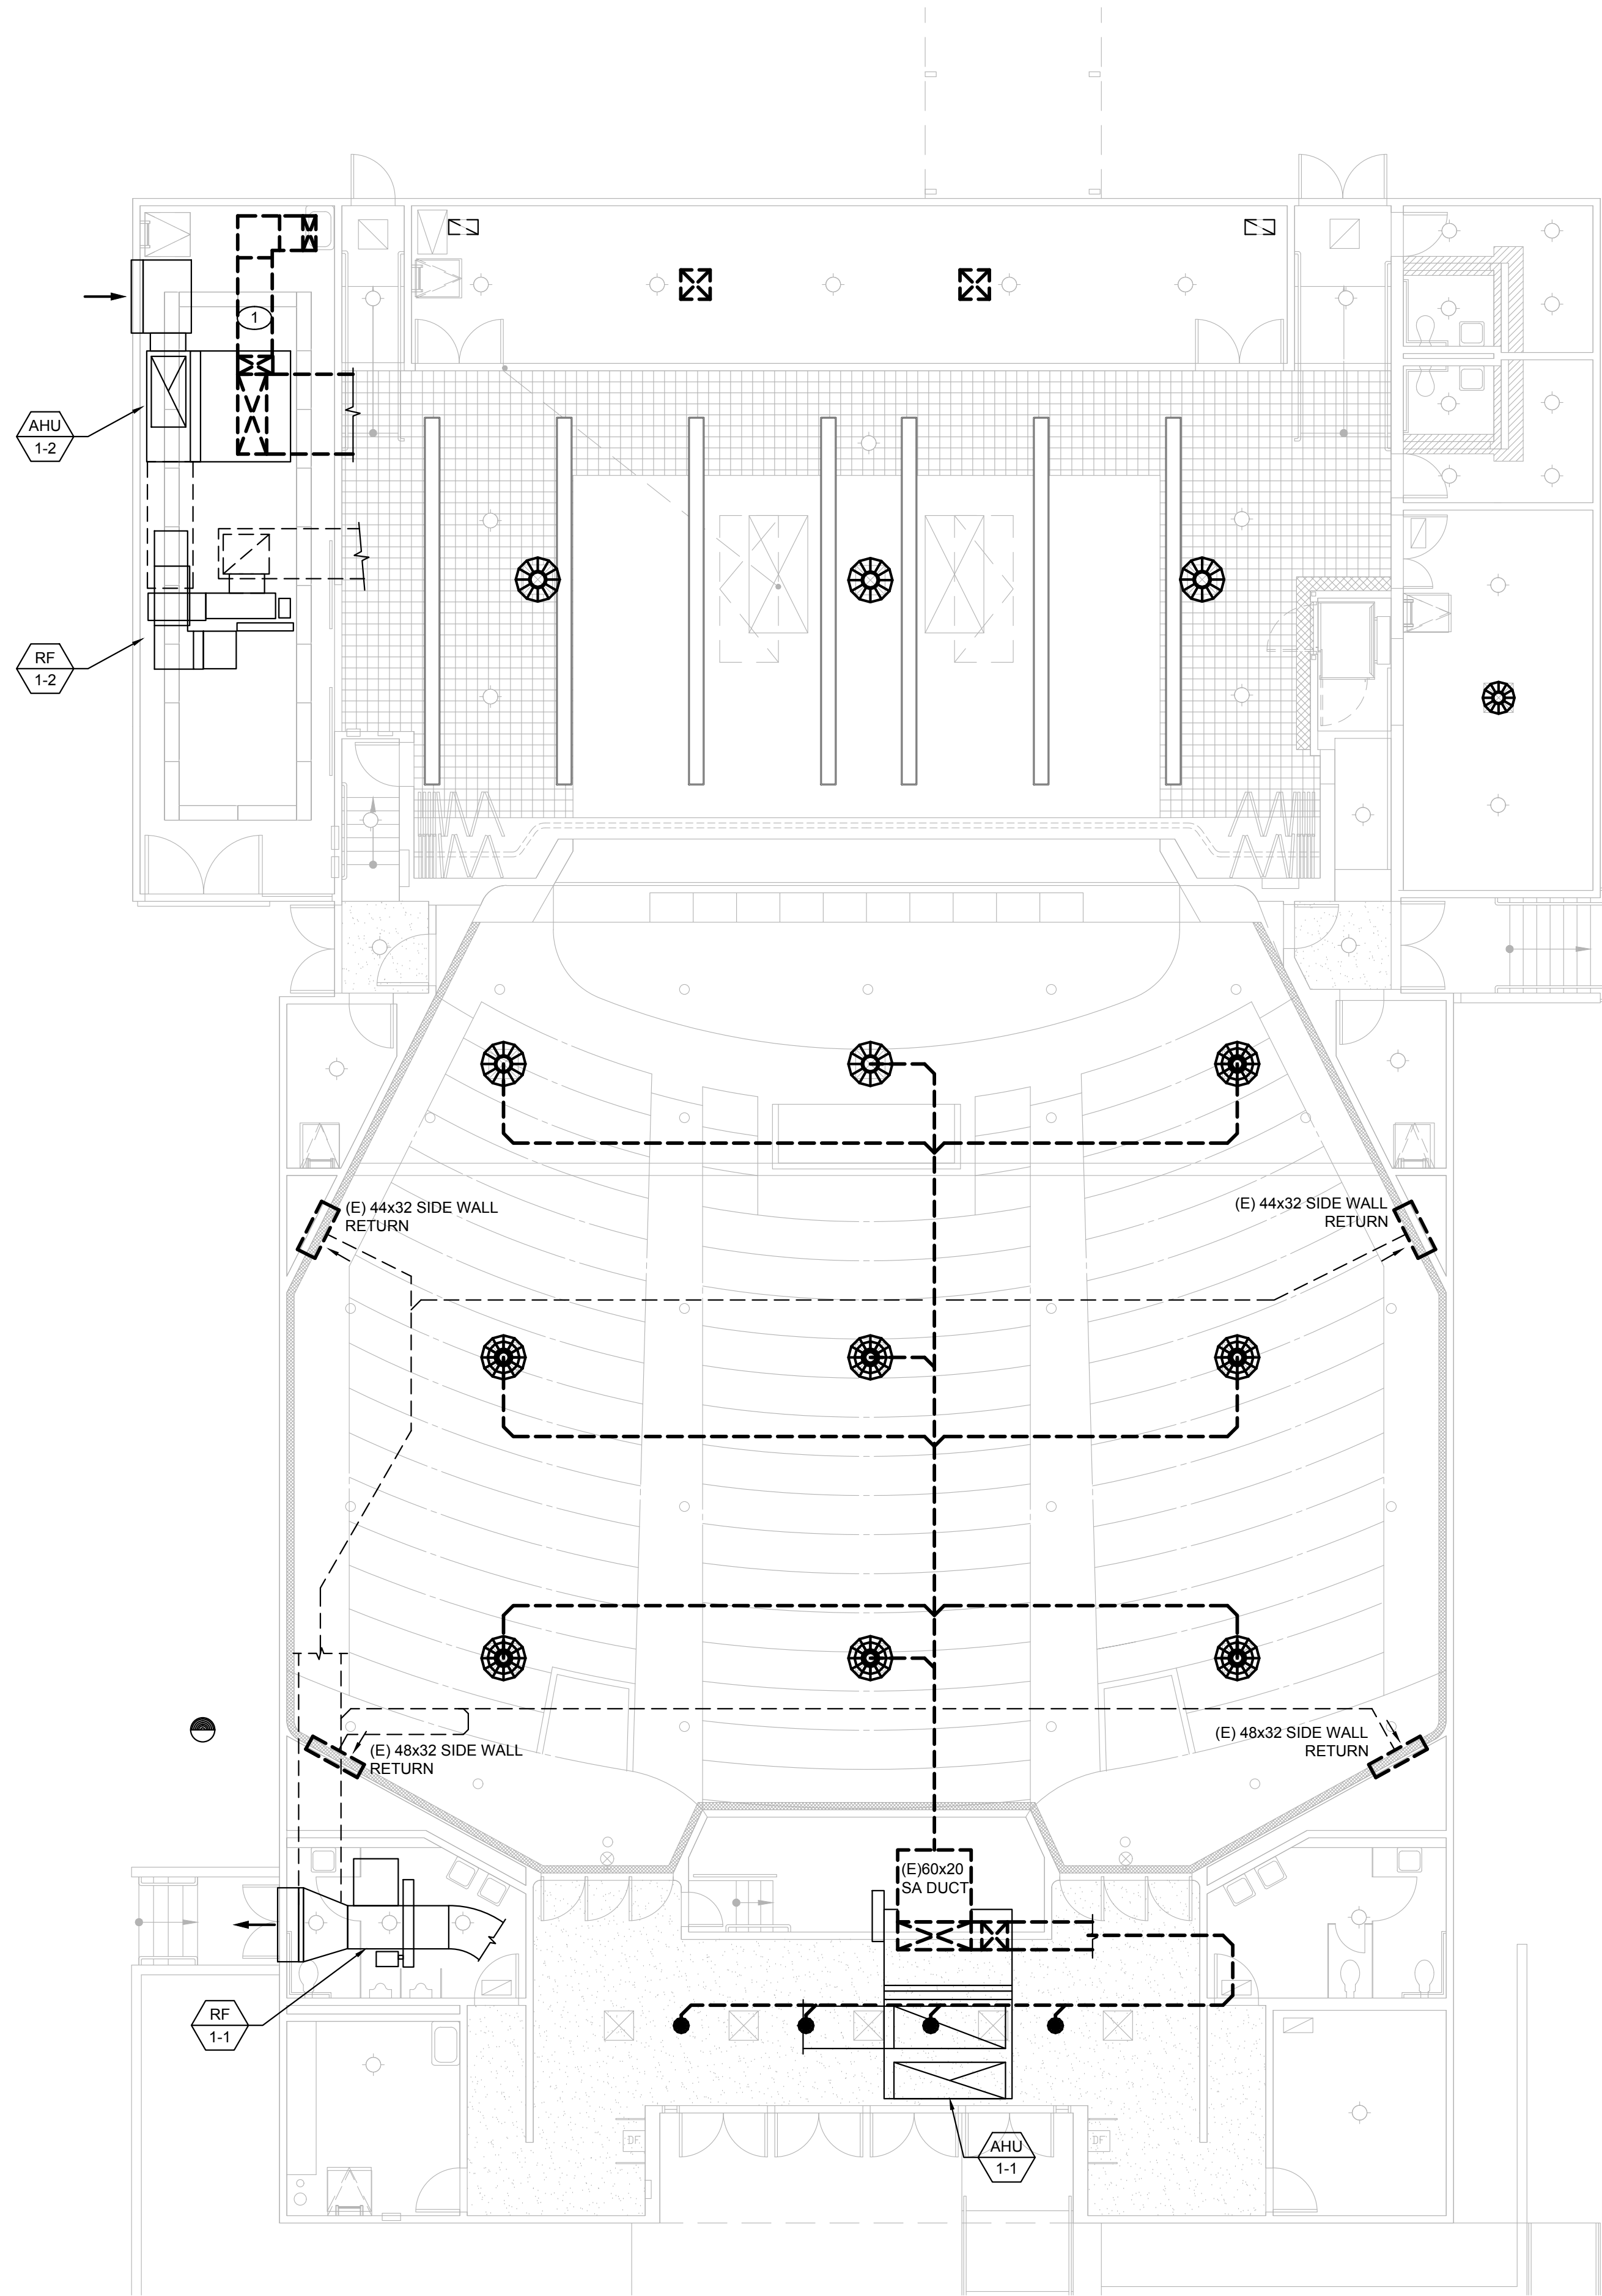
1 MECHANICAL MEZZANINE REMODEL PLAN

REMODEL GENERAL NOTES

- ALL MECHANICAL WORK NEED TO BE COORDINATED WITH ARCHITECTURAL PLANS. SEE ARCH PLANS FOR ADDITIONAL SCOPE OF WORK THAT MAY NOT BE ADDRESSED OR SHOWN ON MECHANICAL PLANS.
- SEE ARCHITECTURAL DRAWINGS INCLUDING REFLECTED CEILING PLANS AND INTERIOR ELEVATIONS FOR FURTHER DIMENSIONS AND LOCATIONS OF ALL THERMOSTATS, DIFFUSERS, GRILLES, REGISTERS, ETC.
- FOR CLASSROOMS, AUDITORIUM AND ROOMS WITH NEW HVAC REPLACEMENT, CONTRACTOR TO COORDINATE WITH SCHOOL DISTRICT REPRESENTATIVE FOR THERMOSTAT TYPE AND CONNECTIVITY TO ALLOW FOR SCHEDULING AND UNIT CONTROL.
- MAINTAIN A MINIMUM OF 10'-0" CLEARANCE BETWEEN ANY EXHAUST OUTLET AND OUTSIDE AIR INTAKE INTO THE BUILDING.
- FOR INDIVIDUAL EQUIPMENT DETAIL REFERENCE, SEE EQUIPMENT SCHEDULES ON SHEET M002 THRU M007.
- ALL EXPOSED DUCTWORK IN GYMNASIUM NEEDS TO BE FINISH APPEARANCE. SEE ARCHITECTURAL DRAWINGS FOR EXACT COLOR AND FINISHES.

REMODEL KEYNOTES

- WALL MOUNTED FAN COIL UNIT, INSTALL PER MANUFACTURER'S RECOMMENDATIONS. COORDINATE LOCATION W/ ALL OTHER TRADES. ENSURE PROPER ACCESS SPACE FOR MAINTENANCE. FOR MOUNTING DETAIL SEE -M-. RUN REFRIGERANT LINES TO CORRESPONDING CONDENSER UNIT PER MANUFACTURER RECOMMENDATION.
- 22x22(L) SA DUCT UP THRU ROOF TO RTU (4,000 CFMS). COORDINATE DUCT ROUTING BETWEEN EXISTING FRAMING.
- 22x22(L) RA DUCT UP THRU ROOF TO RTU (4,000 CFMR). COORDINATE DUCT ROUTING BETWEEN EXISTING FRAMING.
- 24x24 SIDEWALL SA GRILLE (SWS). REFER TO ARCHITECTURAL DRAWINGS FOR EXACT LOCATION, COLOR AND FINISH.
- 42(L)x24(H) SIDEWALL RA GRILLE (SWR). REFER TO ARCHITECTURAL DRAWINGS FOR EXACT LOCATION, COLOR AND FINISH.
- 24x12 SIDEWALL SA GRILLE (SWS). REFER TO ARCHITECTURAL DRAWINGS FOR EXACT LOCATION, COLOR AND FINISH.
- 28x28 SA DUCT UP THRU ROOF TO EC 1-1, 7500 CFMS. COORDINATE DUCT ROUTING BETWEEN EXISTING ROOF FRAMING.
- 24"Ø KITCHEN EXHAUST DUCT WITH 3M 2-HOUR RATED FIRE WRAP UP THRU ROOF TO EF 1-1. PROVIDE NEW ROOF OPENING AS REQUIRED. PATCH, SEAL AND PAINT ANY UNUSED ROOF OPENING TO MATCH ADJACENT ROOF.
- EXISTING KITCHEN HOOD TO REMAIN AND REFURBISHED TO LIKE NEW CONDITION.
- ROUND EXPOSED DIFFUSER (RS) WITH 14"Ø NECK SIZE AND VOL. DAMPER. SET AND BALANCE EACH RS TO 938 CFMS.



SCALE: 1/8"=1'-0"


2 MECHANICAL MEZZANINE DEMOLITION PLAN

DEMOLITION GENERAL NOTES


- CONTRACTOR SHALL VISIT THE SITE PRIOR TO SUBMISSION OF BID AND CONDUCT A THOROUGH FIELD INVESTIGATION TO VERIFY EXISTING CONDITIONS AND BE THOROUGHLY FAMILIAR WITH THE DEMOLITION SCOPE OF WORK. HE SHALL FURNISH ALL LABORS, SUPERVISION, MATERIALS, EQUIPMENT AND FACILITIES NECESSARY TO CARRY OUT THIS WORK AND SUBMIT ALL QUESTIONS IN WRITING PRIOR TO BID.
- ANY EXISTING TO REMAIN EQUIPMENT AND DUCTWORK OUTSIDE OF DASHED LINES SCOPE OF WORK, SHALL BE REPAIRED, CLEANED AND PAINTED BY CONTRACTOR PER DISTRICTS STANDARDS.
- CONTRACTOR SHALL REPAIR, PATCH AND SEAL ALL UNUSED OR DAMAGED WALL AND ROOF OPENINGS/ PENETRATIONS TO BUILDING CAUSED BY DEMOLITION OF EQUIPMENT, PIPING, DUCTWORK, SUPPORTS, ETC.
- CONTRACTOR SHALL REMOVE AND DISPOSE OF ALL EXISTING REGISTERS, DUCTWORK AND RELATED APPURTENANCES SHOWN WITHIN DASHED LINES SCOPE OF WORK. THEY MUST NOT BE ABANDONED IN PLACE UNLESS NOTED OTHERWISE.
- ALL DAMAGED, BROKEN OR INOPERABLE AIR DEVICES OR DAMPERS SHALL BE REPLACED BY CONTRACTOR WITH NEW LIKE SIZED COMPONENTS OR AIR DEVICES. CONTRACTOR SHALL CONDUCT A THOROUGH FIELD INVESTIGATION TO VERIFY EXISTING CONDITIONS PRIOR TO BIDDING. SUBMIT ALL QUESTIONS IN WRITING PRIOR TO BID.
- CONTRACTOR SHALL INSTALL ALL EQUIPMENT AND DEVICES SUCH THAT COMPONENTS WILL BE ACCESSIBLE FOR MAINTENANCE.
- FIRE PROTECTION DURING DEMOLITION/ CONSTRUCTION SHALL BE IN ACCORDANCE WITH 2016 CBC, CHAPTER 33.

DEMOLITION KEYNOTES


- DEMOLISH AND REMOVE ALL EXISTING HVAC EQUIPMENT AS SHOWN WITHIN DASHED LINES SCOPE OF WORK, INCLUDING BUT NOT LIMITED TO ALL EXISTING HVAC EQUIPMENT, DUCTWORK, AIR DEVICES, PIPING, SUPPORT, CONDUITS AND ALL ASSOCIATED APPURTENANCES AND DISPOSED OF PER OWNERS DIRECTION. CONTRACTOR SHALL REPAIR, PATCH AND PAINT ALL ROOF, WALL AND FLOOR OPENINGS OR PENETRATIONS TO BUILDING TO MATCH ADJACENT SURFACES PER ARCHITECTURAL DRAWINGS.
- CONTRACTOR SHALL COORDINATE WITH ALL TRADES TO PROVIDE A CLEAR AND OPERABLE AREA FOR FUTURE REMODEL WORK.
- EXISTING KITCHEN HOOD SHALL BE REPAIRED, CLEANED AND REFURBISHED TO LIKE NEW CONDITION BY CONTRACTOR PER DISTRICTS STANDARDS.

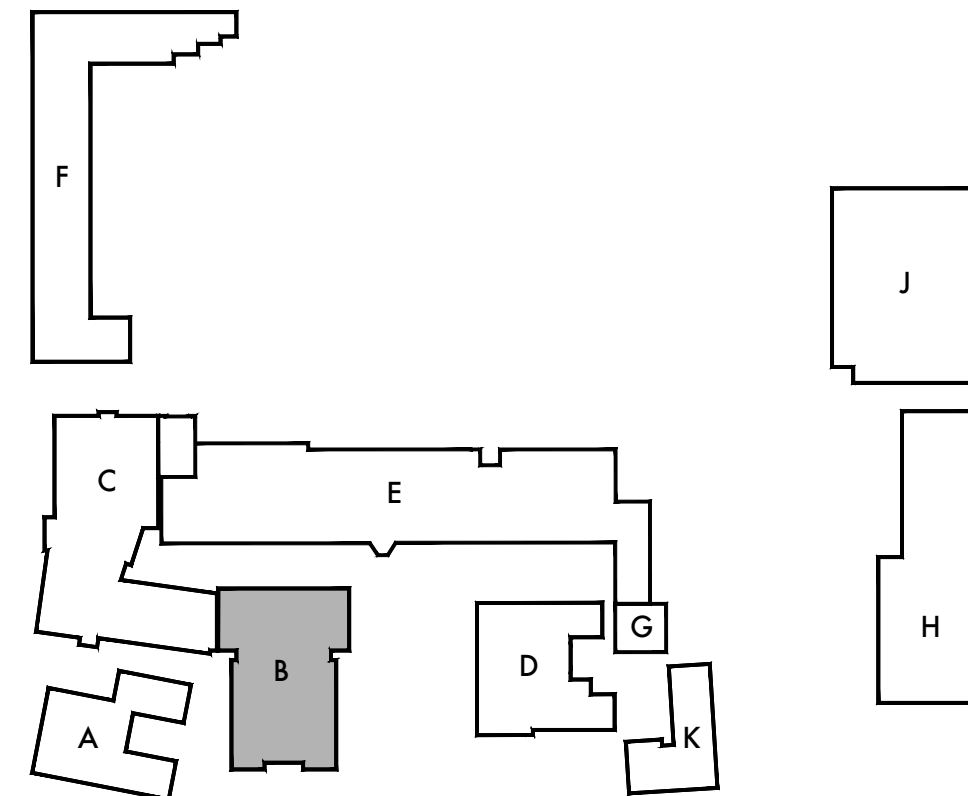

KEY PLAN

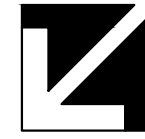

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KEYNOTES

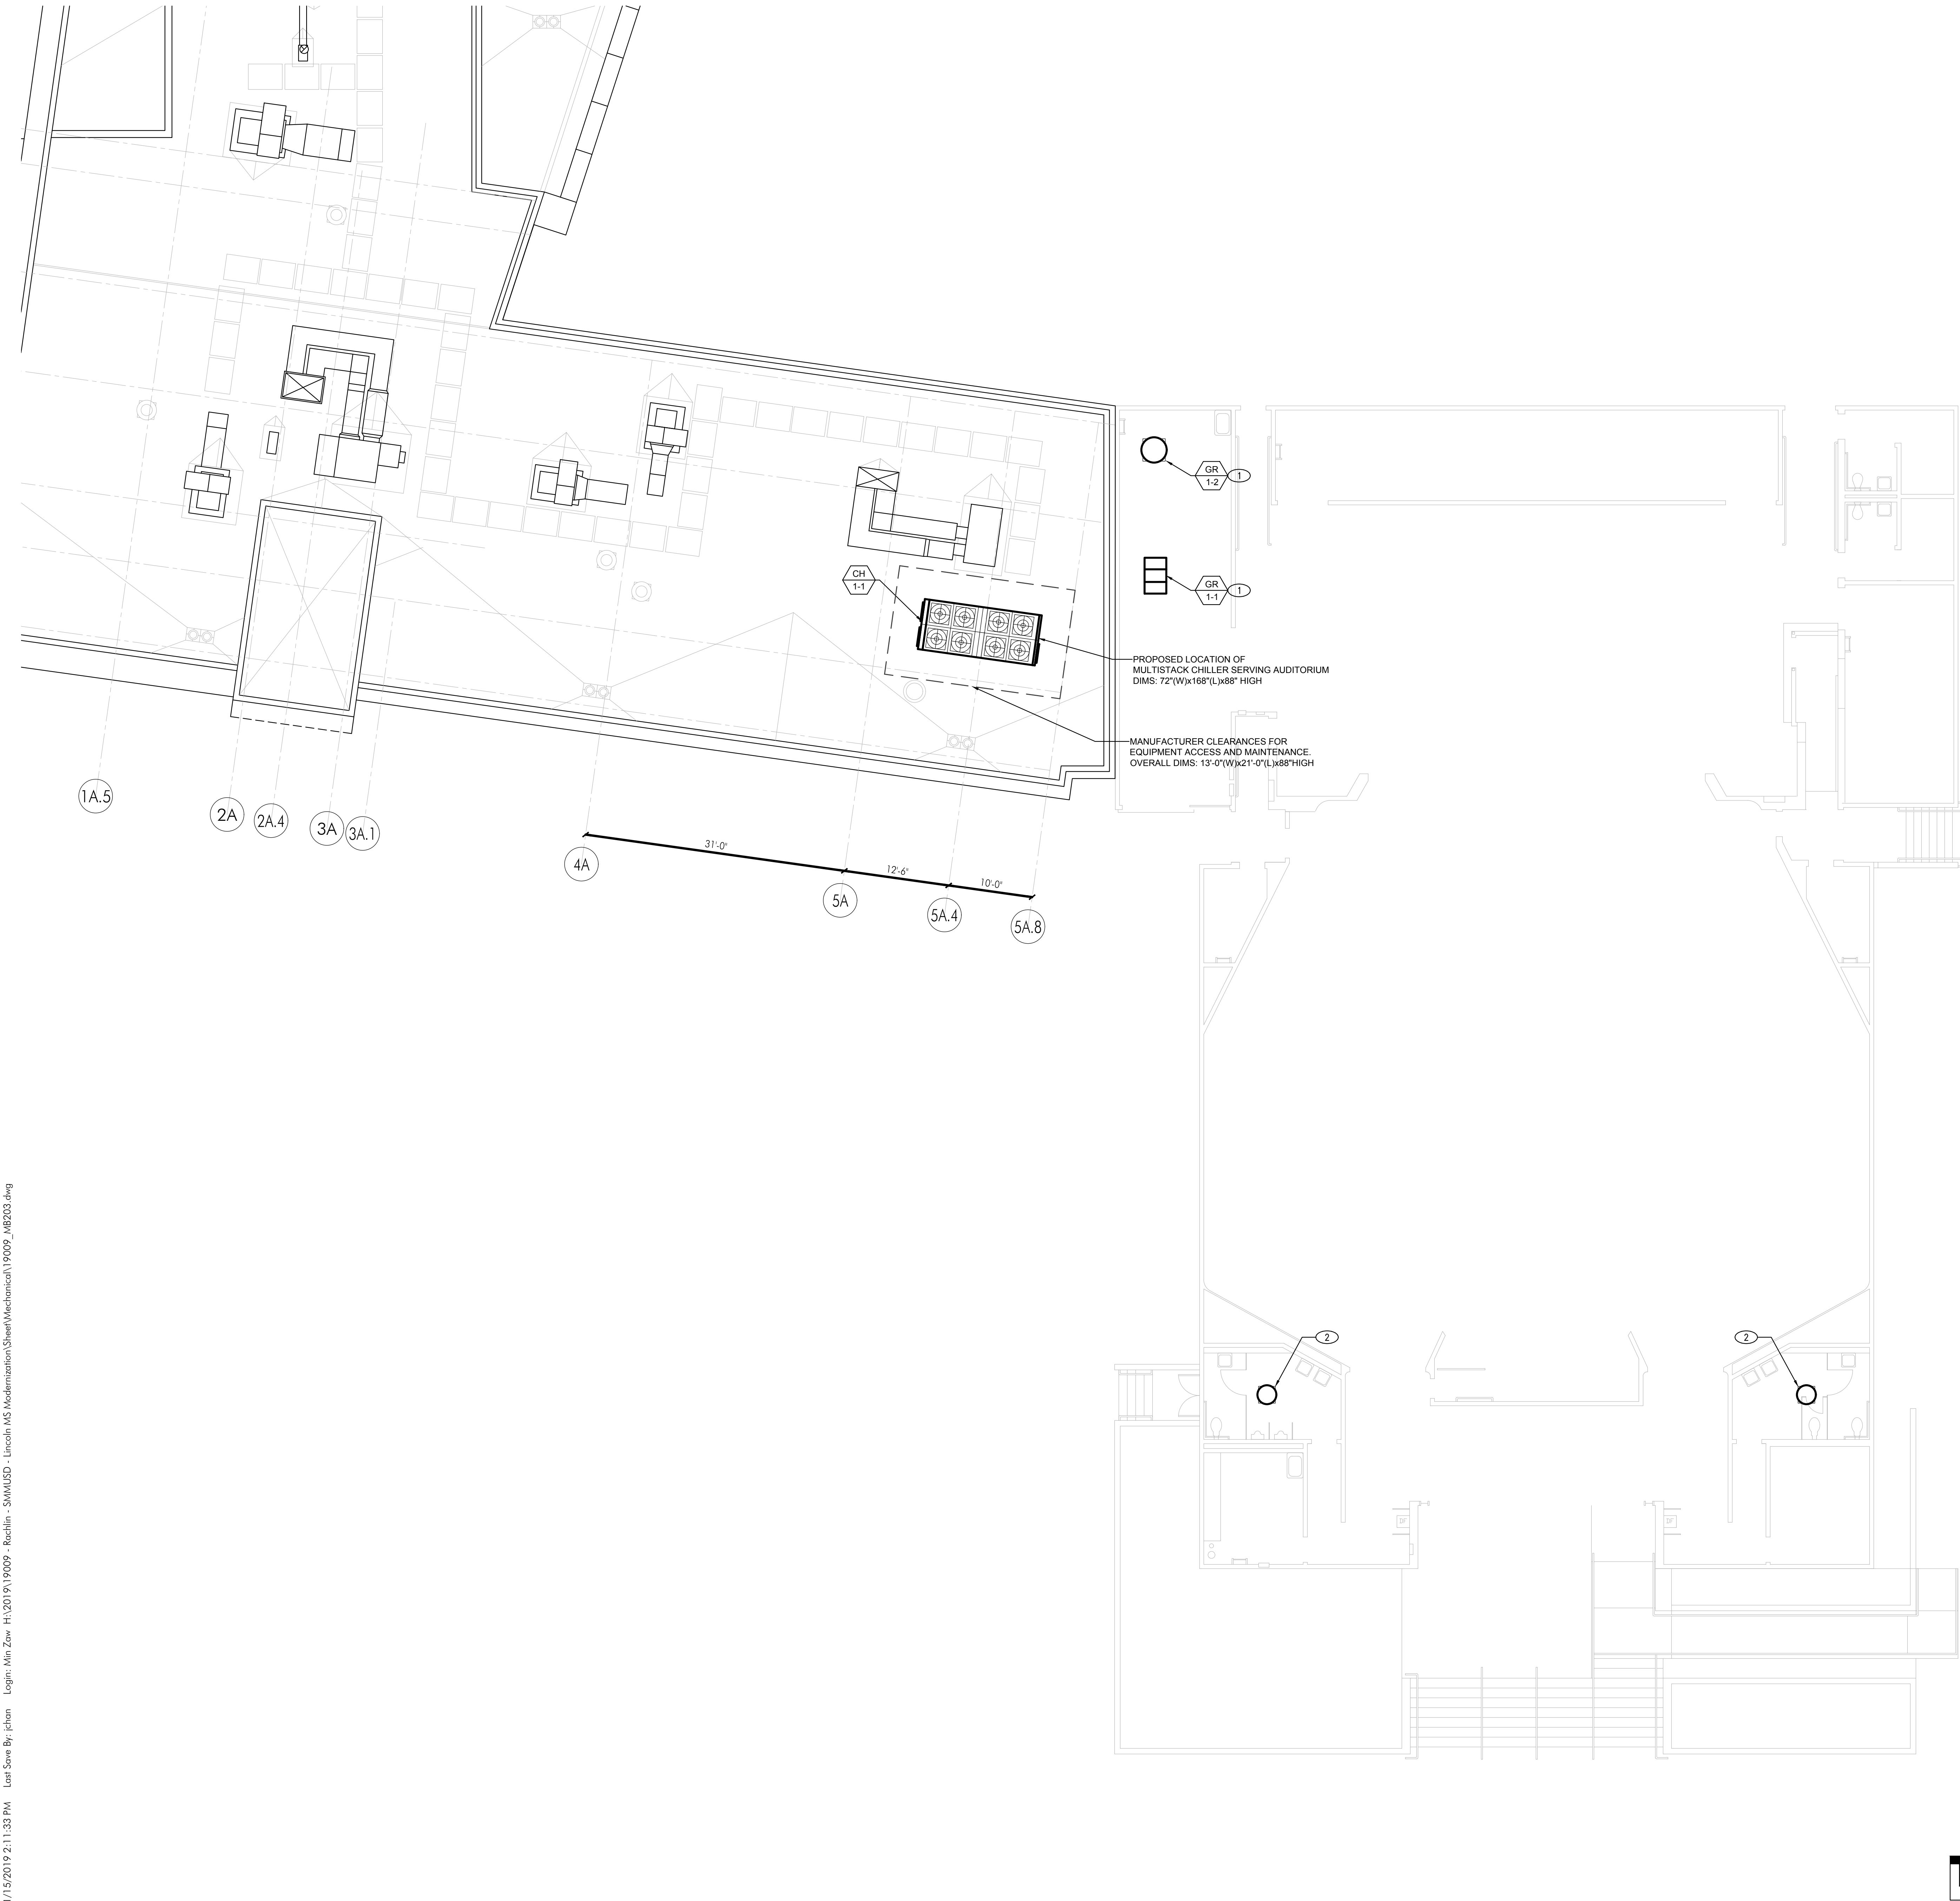- 1 GRAVITY RELIEF VENTILATOR TO REPLACE EXISTING UNIT. PROVIDE ALL DUCTWORK TRANSITION, FITTING, ACCESSORY TO CONNECT TO EXISTING VENTILATOR.
- 2 EXHAUST ROOF JACK SERVING CEILING EXHAUST FAN BELOW. LOCATE EXHAUST JACK MIN. 10'-0" AWAY FROM ANY INTAKE INTO BUILDING.

DSA Stamp

Architect




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Lincoln Middle School HVAC Replacement Project
Lincoln Middle School
1501 California Avenue
Santa Monica, California 90403

Rev	Date	Issue
1	07.22.19	-

Date:
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Drawn By: DH, RM
Checked By: RI

Architect / Engineer Stamp

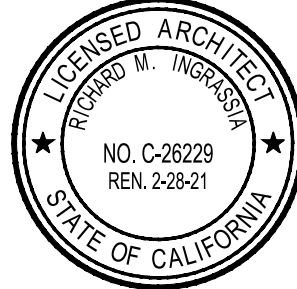

Consultants




Sheet Title

Buildings 'B'
Mechanical Roof
Plan


Sheet Number

MB203

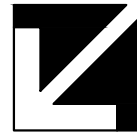

SCALE: 1/8"=1'-0"


KEY PLAN

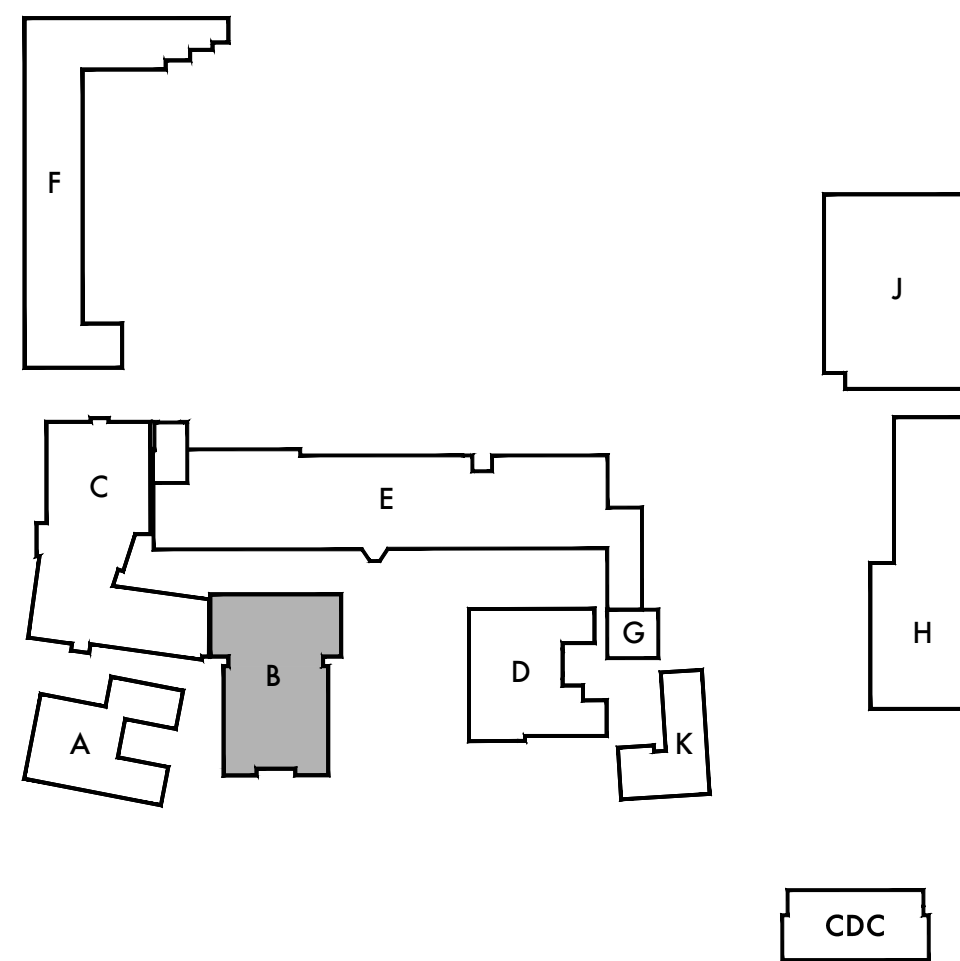


KEYNOTES

- 1
- REMOVE (E) FURNACE UNITS, SUPPORTS, THERMOSTAT, CONTROL AND ACCESSORIES WITHIN THE SCOPE OF WORK AREA UNLESS OTHERWISE NOTED. PATCH AND REPAIR EXISTING WALLS, CEILING, FLOORING AS NEEDED.

- 2
- REMOVE (E) PORTION OF DUCTWORK TO CONNECT NEW DUCTWORK FROM NEW AHU.

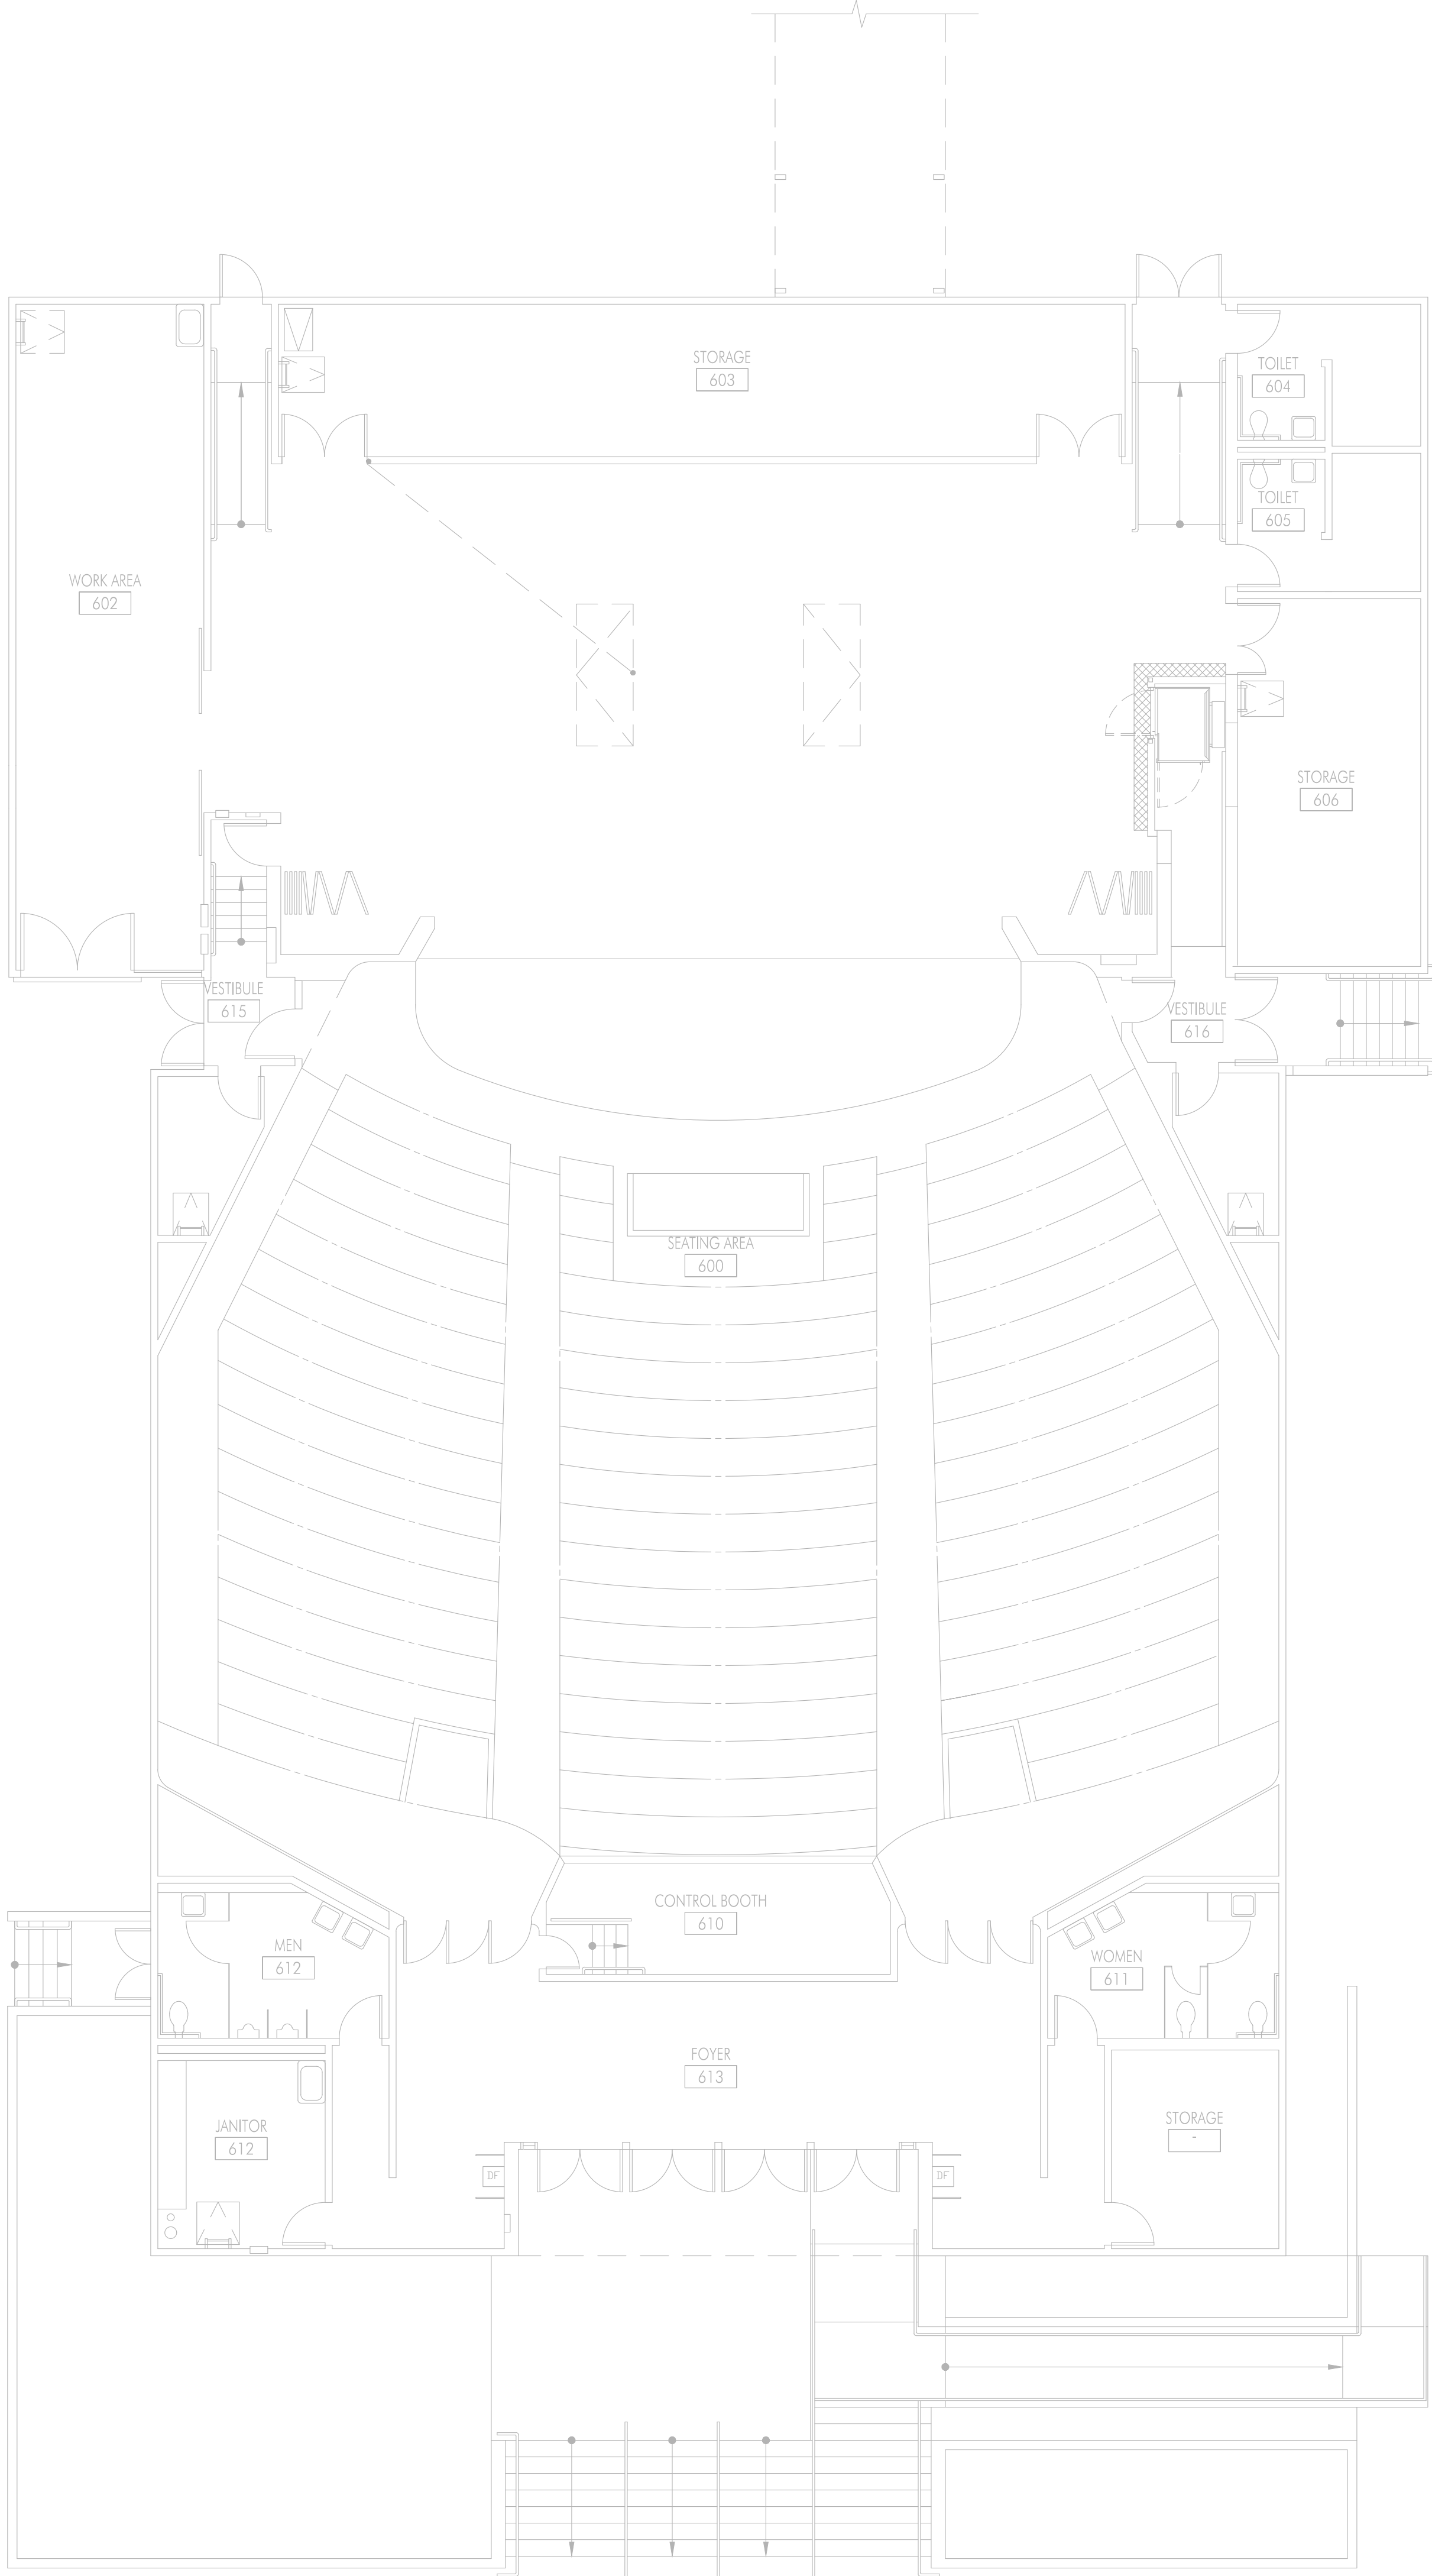

SCALE: 1/8"=1'-0"

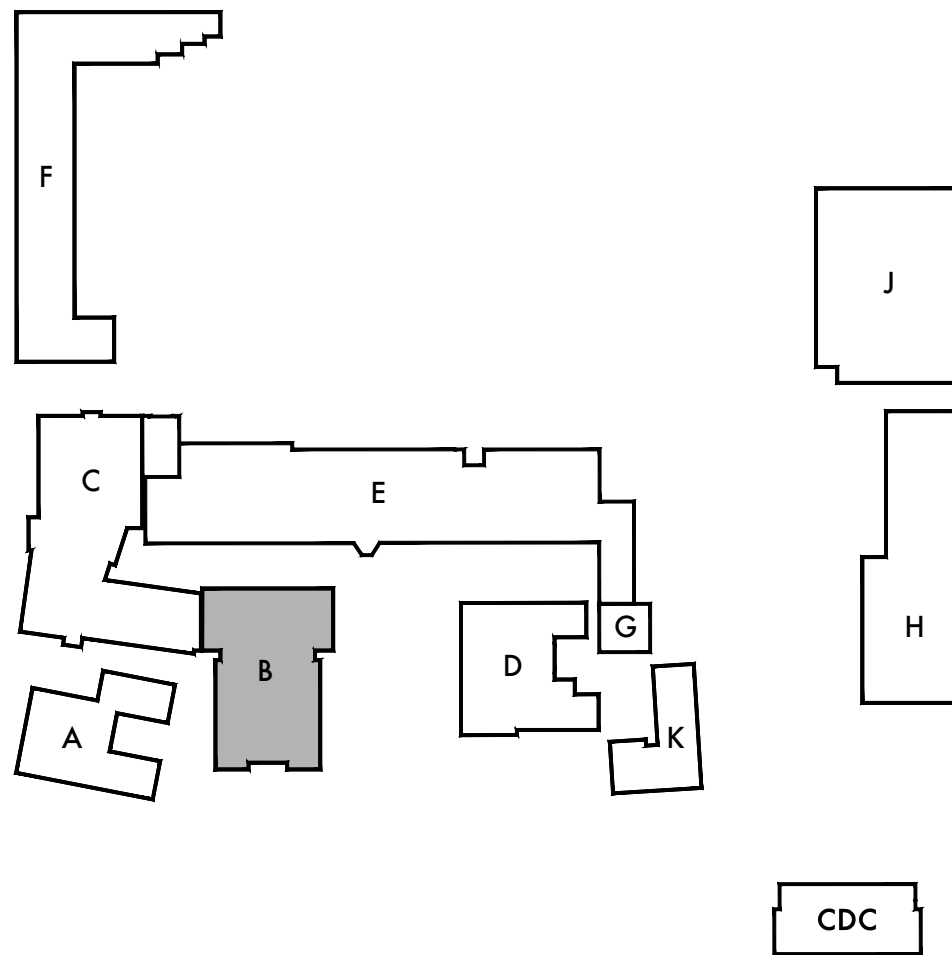

KEY PLAN

Architect




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Lincoln Middle School
1501 California Avenue
Santa Monica, California 90403

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Monrovia, California 91016
P: 626.930.1383 F: 626.930.1385
Project No. 19009

Sheet Title

Building 'B'
Mechanical
Demolition Plan

Sheet Number

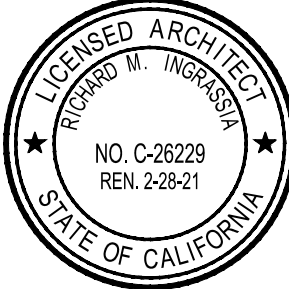MBD201

KEYNOTES

- 12'0" SA DUCT UP THRU ROOF.
- 20'0" SA DUCT UP THRU ROOF.
- 20"x20" RA DUCT UP THRU ROOF.
- 18"x18" RA DUCT UP THRU ROOF.
- 18'0" MAKE-UP AIR DUCT UP THRU ROOF.
- 18"x16" EA DUCT UP THRU ROOF.
- 16"x14" EA DUCT OPENING AT TOP OF THE DUCT. PROVIDE 2" WIRE MESH SCREEN.
- 18"x24" EA DUCT OPENING AT TOP OF THE DUCT. PROVIDE 2" WIRE MESH SCREEN.
- 22"x22" EA DUCT UP THRU ROOF.
- 22'0" MAKE-UP AIR DUCT UP THRU ROOF.
- PROVIDE 1" DUCT LINER THROUGHOUT.
- 24'0" MAKE-UP AIR DUCT UP THRU ROOF.
- 26"x26" EA DUCT UP THRU ROOF.
- 20'0" MAKE-UP AIR DUCT UP THRU ROOF.

Architect



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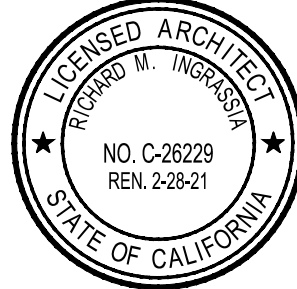
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Lincoln Middle School HVAC Replacement Project
Lincoln Middle School
1501 California Avenue
Santa Monica, California 90403

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Sheet Title

Building 'C'
Second Floor
Mechanical Plan

Sheet Number

MC202



SCALE: 1/8"=1'-0"

KEYNOTES

- 1

22"Ø SA DUCT DN THRU ROOF.
- 2

20"Ø SA DUCT DN THRU ROOF.
- 3

20"x20" RA DUCT DN THRU ROOF.
- 4

18"x18" RA DUCT DN THRU ROOF.
- 5

18"Ø MAKE-UP AIR DUCT DN THRU ROOF.
- 6

18"x16" EA DUCT DN THRU ROOF.
- 7

PROVIDE 1" DUCT LINER THROUGHOUT.
- 8

PROVIDE 2" DUCT LINER THROUGHOUT.
- 9

20"Ø MAKE-UP AIR DUCT DN THRU ROOF.
- 10

22"Ø MAKE-UP AIR DUCT DN THRU ROOF.
- 11

24"Ø MAKE-UP AIR DUCT DN THRU ROOF.
- 12

22"x22" EA DUCT DN THRU ROOF.
- 13

26"x26" EA DUCT DN THRU ROOF.
- 14

REPLACE IN KIND; CONTRACTOR TO VERIFY MODEL #, HP, CFM, AND STATIC PRESSURE BEFORE DEMOLITION WORK, AND REBALANCE NEW FAN TO THE PRE-READ CFM QUANTITIES AND STATIC PRESSURES.

Architect




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Lincoln Middle School
1501 California Avenue
Santa Monica, California 90403

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Monrovia, California 91016
P: 626.930.1383 F: 626.930.1385
Project No. 19009

Sheet Title


Building 'C'
Mechanical
Roof Plan

Sheet Number

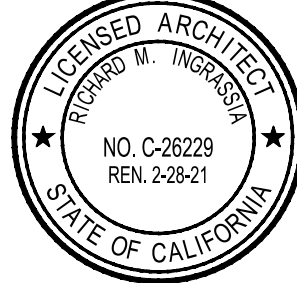MC203




SCALE: 1/8"=1'-0"

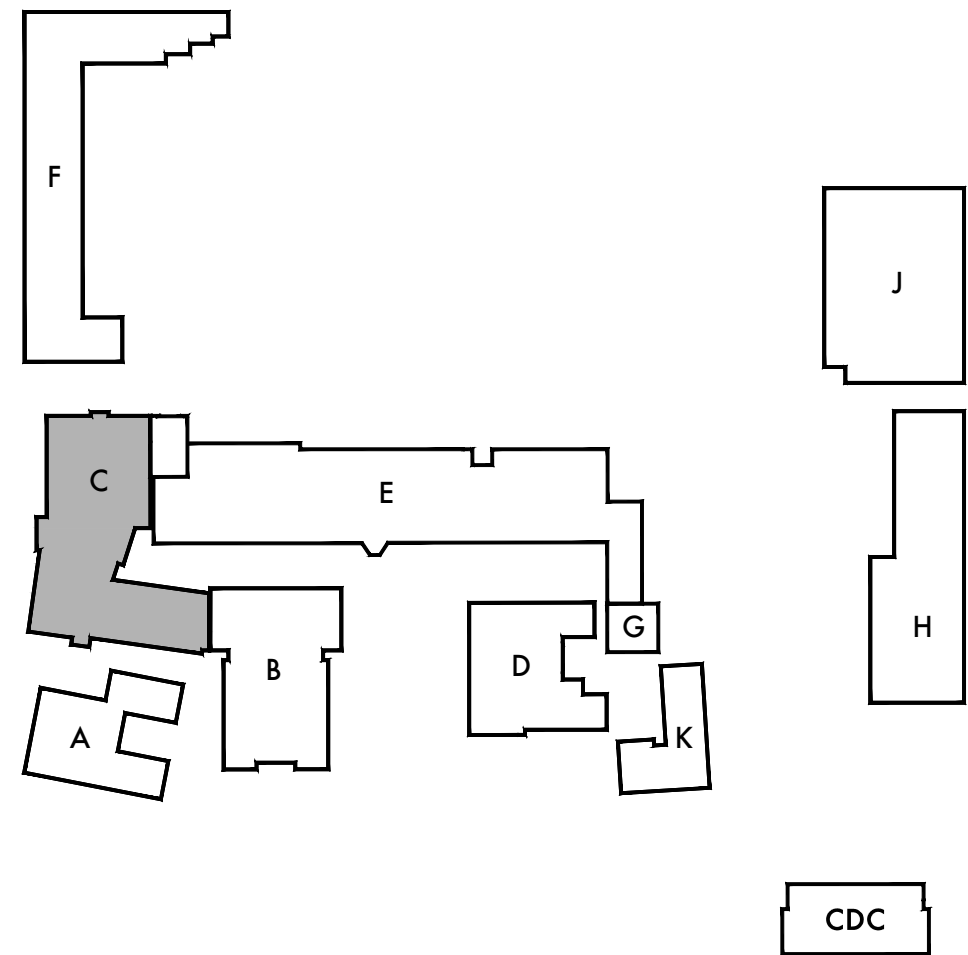

KEY PLAN


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- KEYNOTES
- 1 REMOVE (E) GAS FURNACE UNITS, GAS PIPES, SUPPORTS, ENTIRE ASSOCIATED COMBUSTION AIR AND FLUE PIPES UP THRU ROOF WITHIN THE SCOPE OF WORK AREA. PATCH AND REPAIR EXISTING WALLS, CEILING, ROOF AS NEEDED.
 - 2 REMOVE (E) MOTORIZED DAMPER, RECONNECT (E) DUCTWORK TO BE REUSED.
 - 3 REMOVE (E) EXHAUST DUCT UP THUR ROOF AND CAP MAIN DUCT TO REUSE.
 - 4 REMOVE (E) OA DUCT UP THUR ROOF.

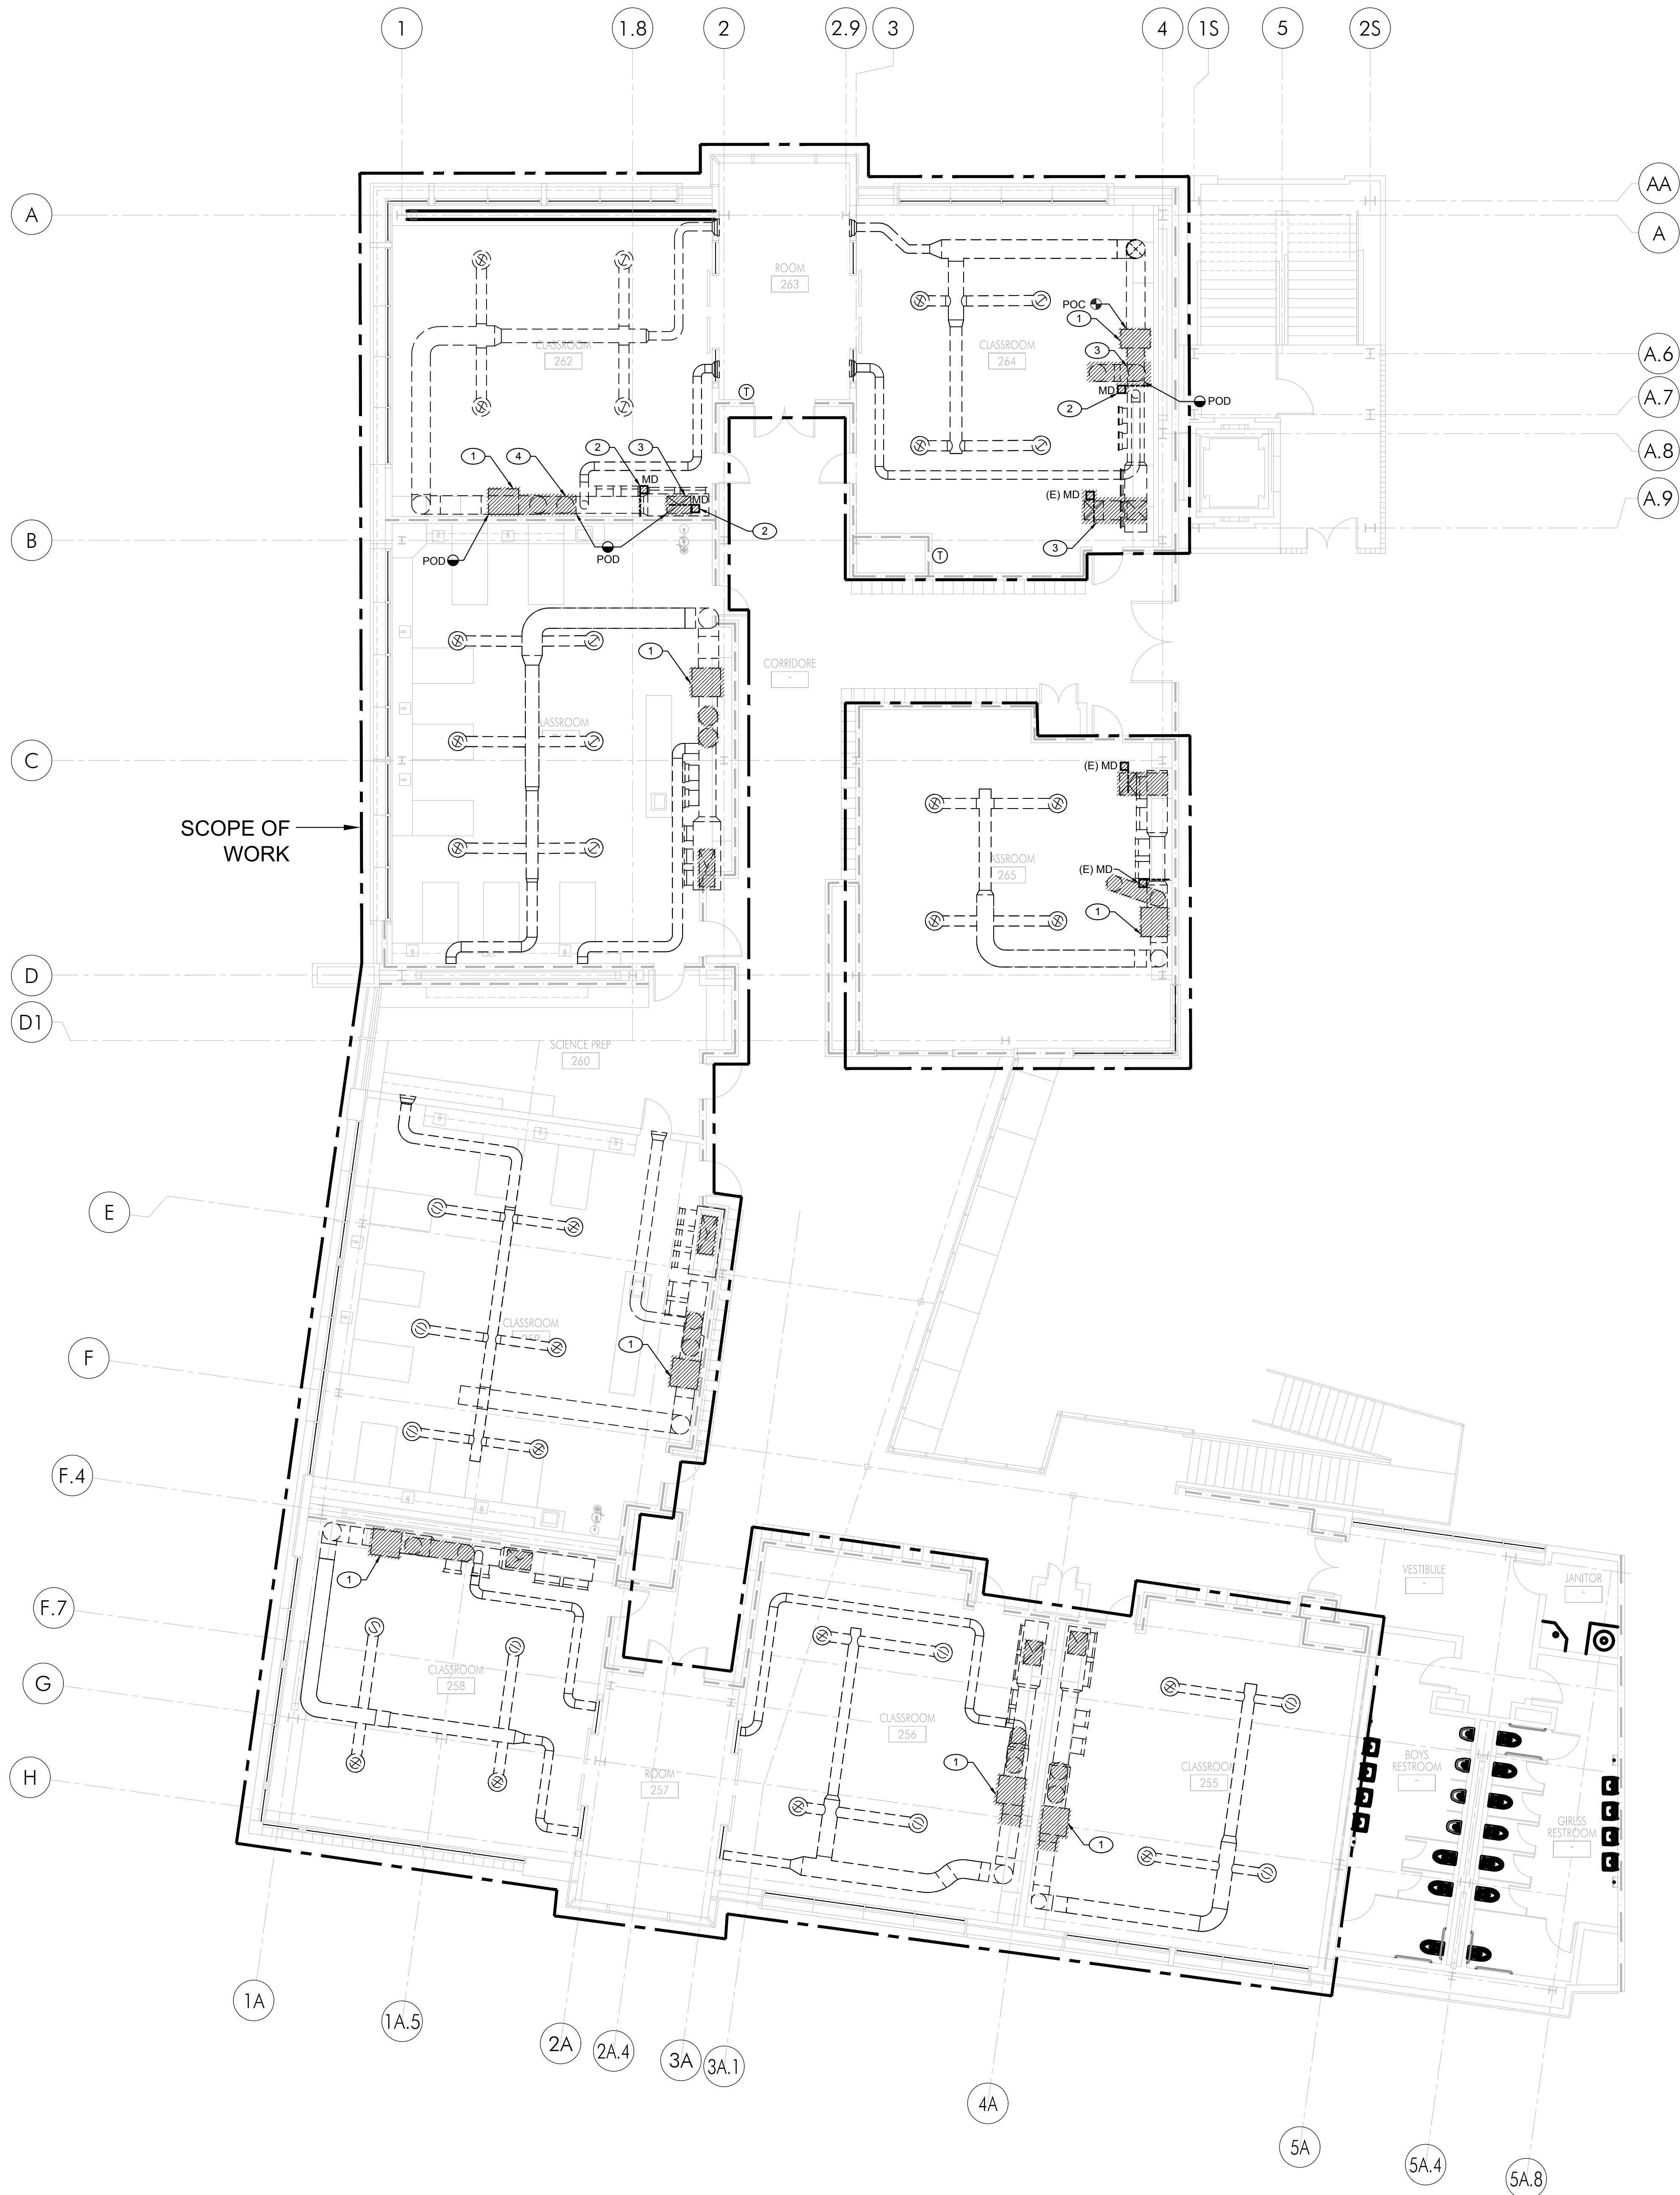

SCALE: 1/8"=1'-0"



KEY PLAN

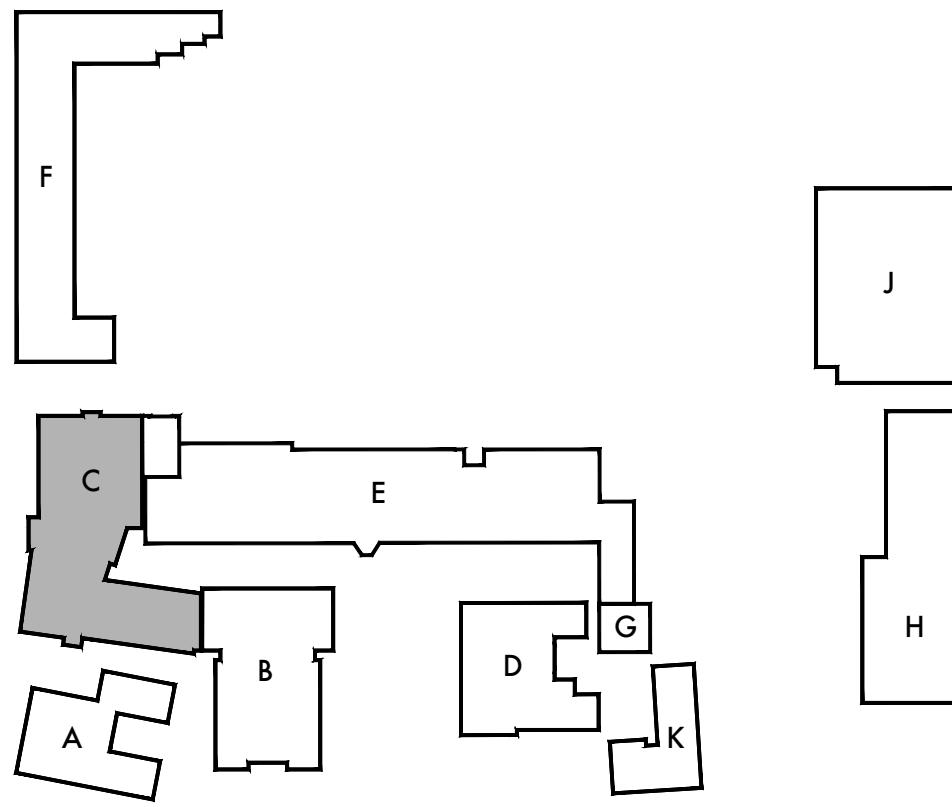DSA Stamp

Architect



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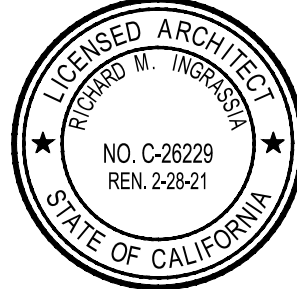
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Lincoln Middle School HVAC Replacement Project
Lincoln Middle School
1501 California Avenue
Santa Monica, California 90403

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Monrovia, California 91016
P: 626.930.1383 F: 626.930.1385
Project No. 19009

Sheet Title

Building 'C'
Second Floor
Mechanical
Demolition Plan

Sheet Number


MCD202

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KEYNOTES

- 1 REMOVE (E) VENTILATOR, DUCTWORK, SUPPORTS & PAD. (E) ROOF OPENING WILL BE USED FOR (N) DUCTWORK. PATCH AND REPAIR EXISTING ROOF AS NEEDED.
- 2 REMOVE (E) VENTILATOR, DUCTWORK, SUPPORTS & PAD. PATCH AND REPAIR EXISTING ROOF AS NEEDED.
- 3 REMOVE (E) EXHAUST FAN, DUCTWORK, SUPPORTS & PAD. (E) ROOF OPENING WILL BE USED FOR (N) DUCTWORK. PATCH AND REPAIR EXISTING ROOF AS NEEDED.
- 4 REPLACE IN KIND; CONTRACTOR TO VERIFY MODEL #, HP, CFM, AND STATIC PRESSURE BEFORE DEMOLITION WORK, AND REBALANCE NEW FAN TO THE PRE-READ CFM QUANTITIES AND STATIC PRESSURES.
- 5 REMOVE (E) ENTIRE ASSOCIATED COMBUSTION AIR, FLUE PIPES & SUPPORTS ON THE ROOF. PATCH AND REPAIR EXISTING ROOF AS NEEDED. REFER TO DEMOLITION PLAN MCD202 FOR REMOVING THE (E) GAS FURNANCE UNIT.



KEY PLAN

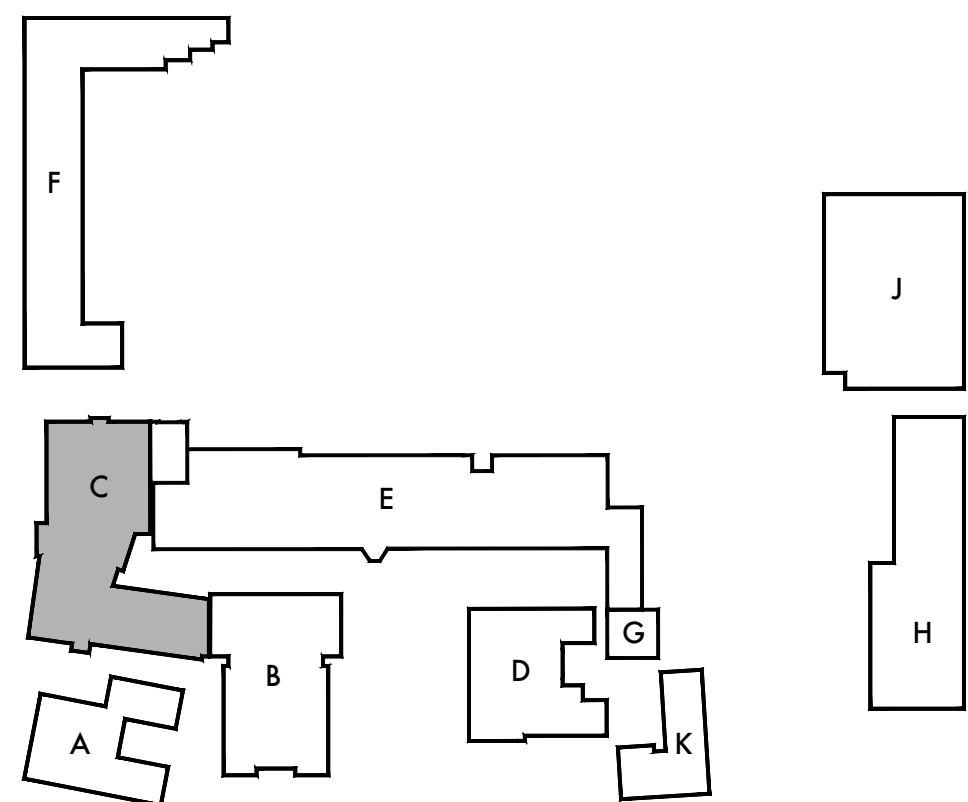

SCALE: 1/8"=1'-0"

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Architect



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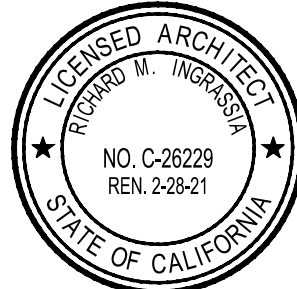
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Lincoln Middle School
1501 California Avenue
Santa Monica, California 90403

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Project No. 19009

Sheet Title


Building 'C'
Mechanical Roof
Demolition
Plan

Sheet Number

MCD203

KEYNOTES

- 1
- REMOVE (E) HEATING AND VENTILATION SYSTEM, DUCTWORK, PIPING SUPPORTS, THERMOSTAT, CONTROL AND ACCESSORIES WITHIN THE SCOPE OF WORK AREA UNLESS OTHERWISE NOTED. PATCH AND REPAIR EXISTING WALLS, CEILING, FLOOR AS NEEDED.

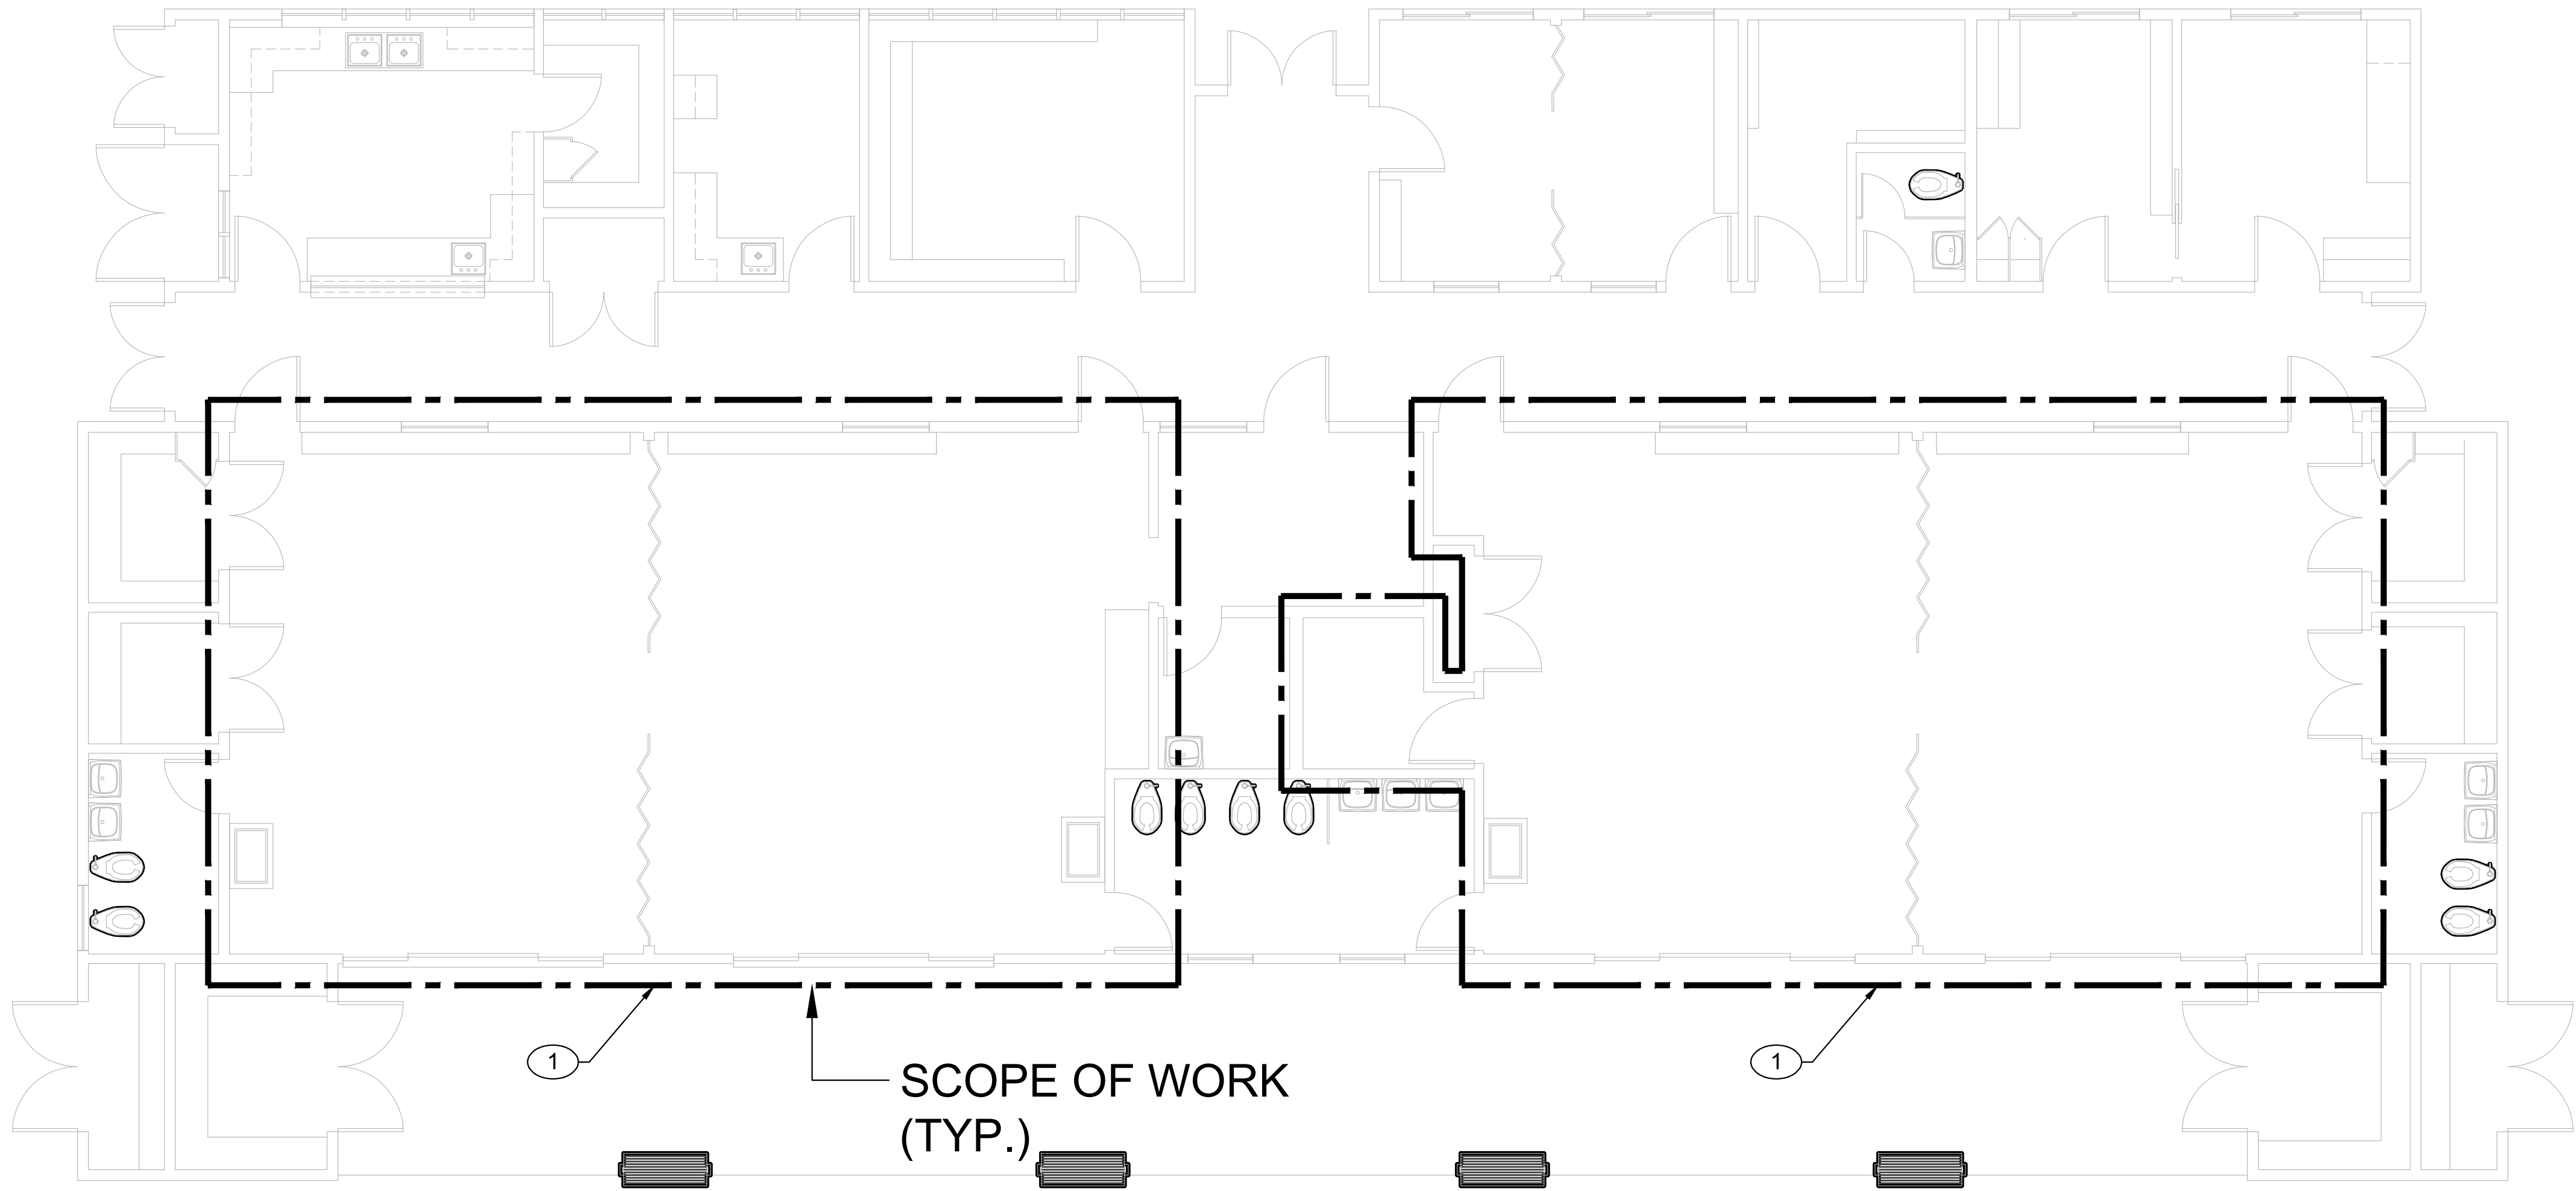


SCALE: 3/16"=1'-0"

2 MECHANICAL DEMOLITION PLAN

KEYNOTES

- 1
- WALL MOUNTED FAN COIL UNIT. INSTALL PER MANUFACTURER'S RECOMMENDATIONS. COORDINATE LOCATION W/ ALL OTHER TRADES. ENSURE PROPER ACCESS SPACE FOR MAINTENANCE. FOR MOUNTING DETAIL SEE -M-. RUN REFRIGERANT LINES TO CORRESPONDING CONDENSER UNIT PER MANUFACTURER RECOMMENDATION.
- 2
- 3'-4"x3'-6" RETURN AIR PLENUM BELOW FAN COIL UNIT.
- 3
- 18"x6" SAG 400 CFM (TYP 4.)
- 4
- PRICE SDG MODEL WITH AIR SCOOP (AS), DOUBLE DEFLECTION, (TYP.)
- 5
- 36"x14" SWR, PRICE 1000 CFM.
- 6
- 18"x14" SWR, PRICE 500 CFM.
- 7
- PROVIDE BAROMETRIC RELIEF AIR DAMPER. SET DAMPER TO OPEN AT 0.05" PRESSURE.
- 8
- 10"x10" OA DUCT UP THRU ROOF & PROVIDE ROOF CAP.
- 9
- 12"x10" MAKE-UP AIR DUCT UP THRU ROOF.
- 10
- 6"x6" SWS, PRICE 30 CFM.
- 11
- 6"x6" SWS, PRICE 60 CFM.
- 12
- 8"Ø EXHAUST DUCT UP THRU ROOF & PROVIDE ROOF CAP.

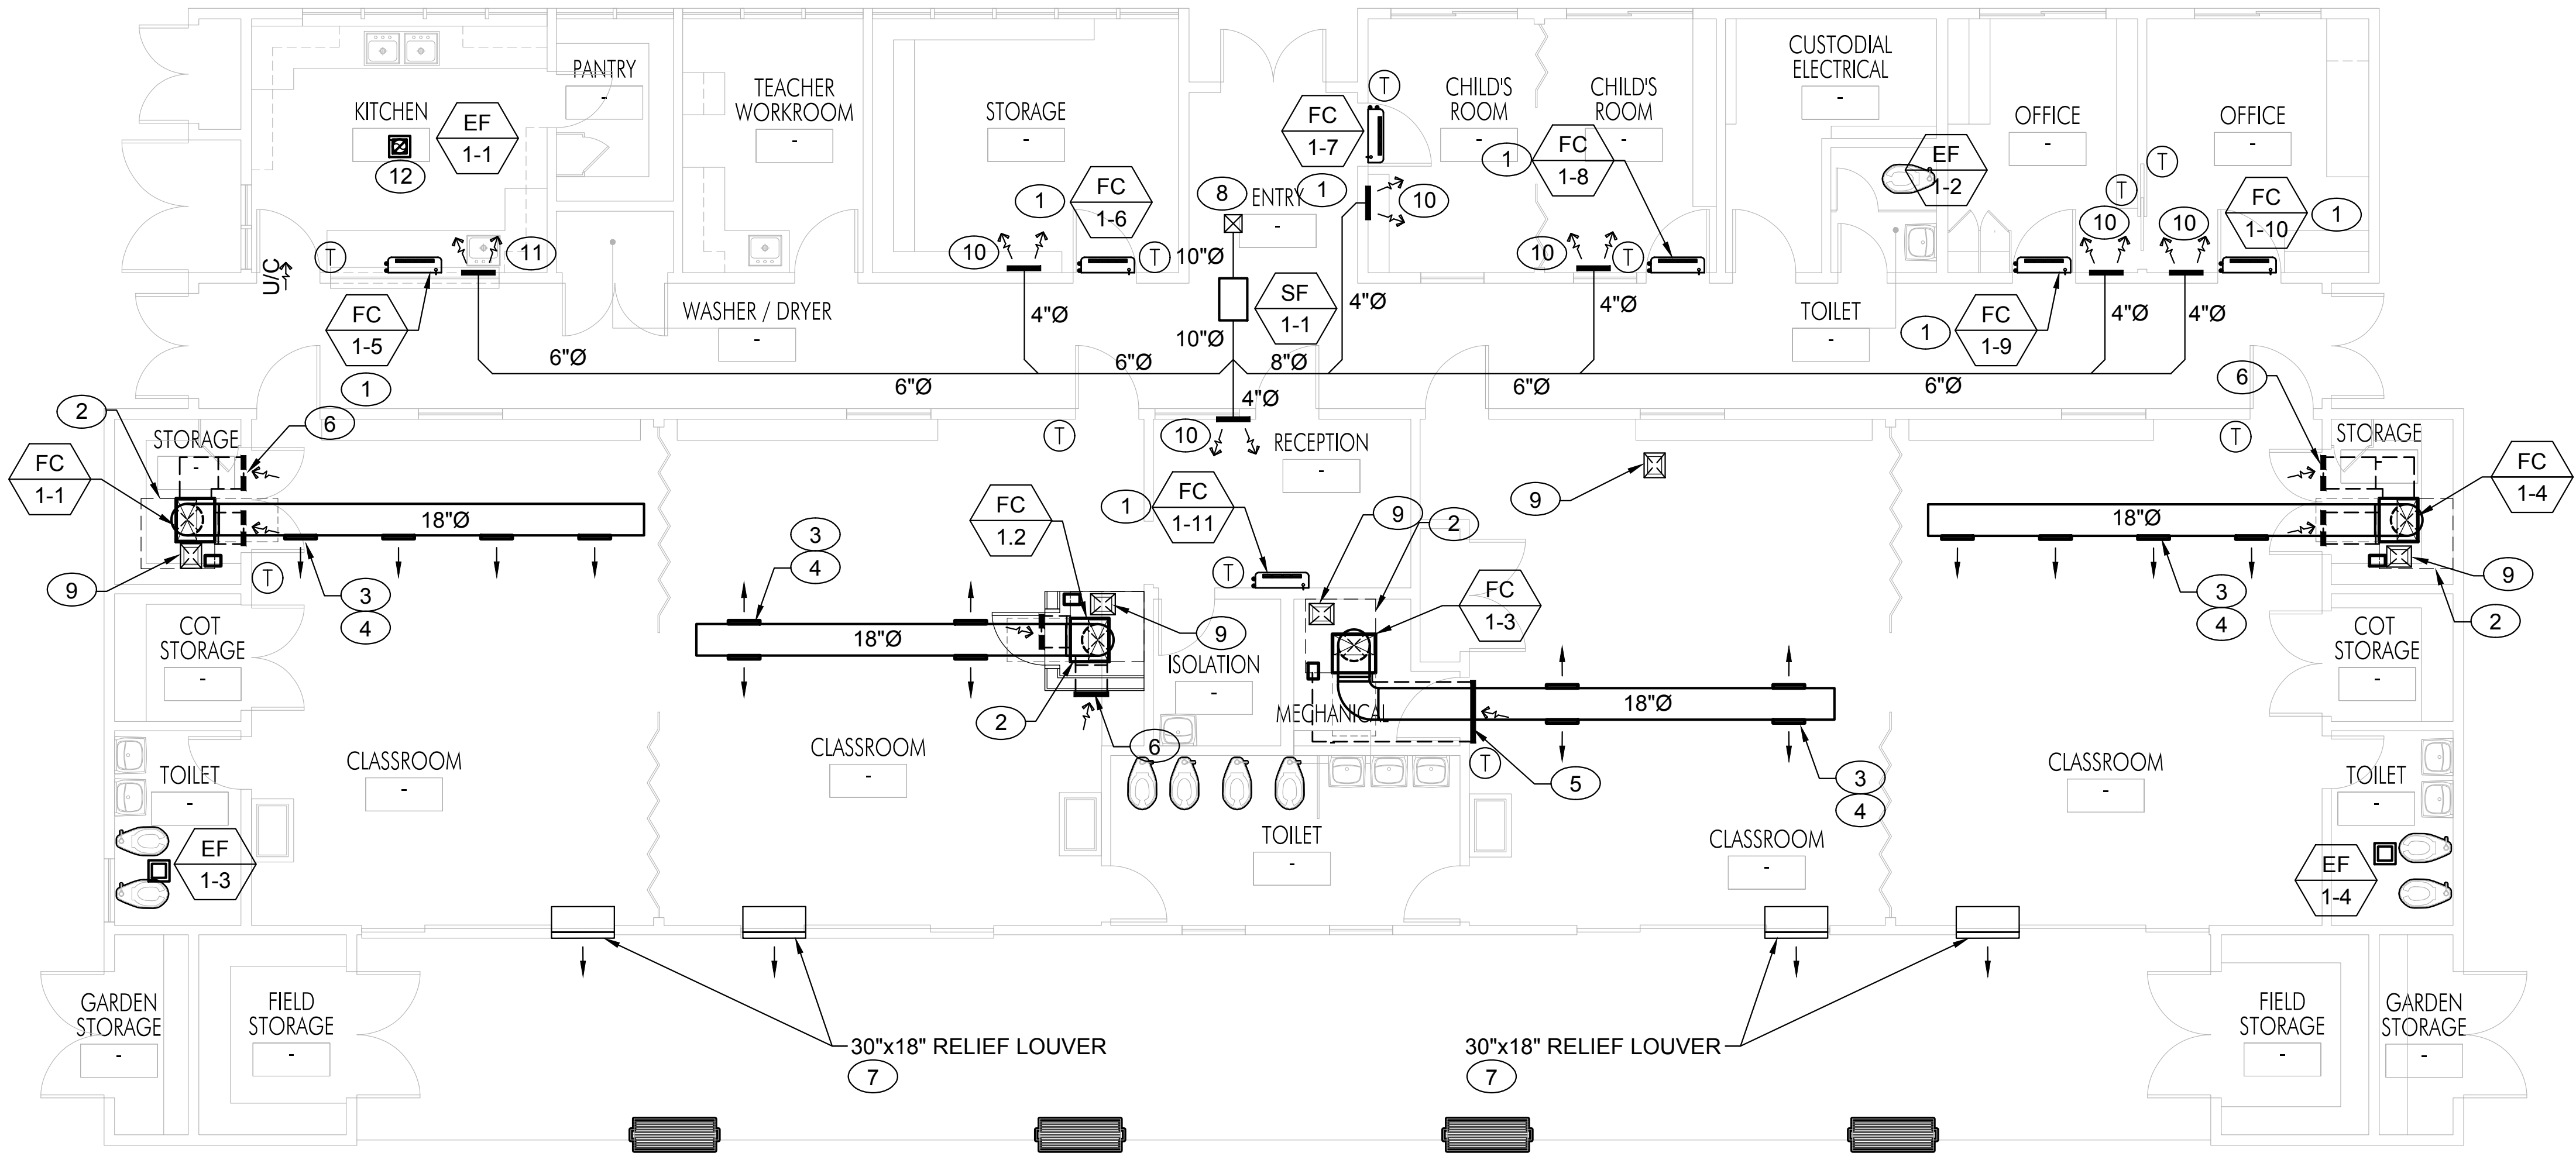

SCALE: 3/16"=1'-0"

1 MECHANICAL PLAN

Architect



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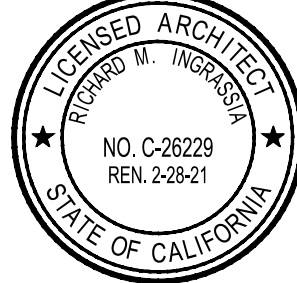
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Lincoln Middle School
1501 California Avenue
Santa Monica, California 90403

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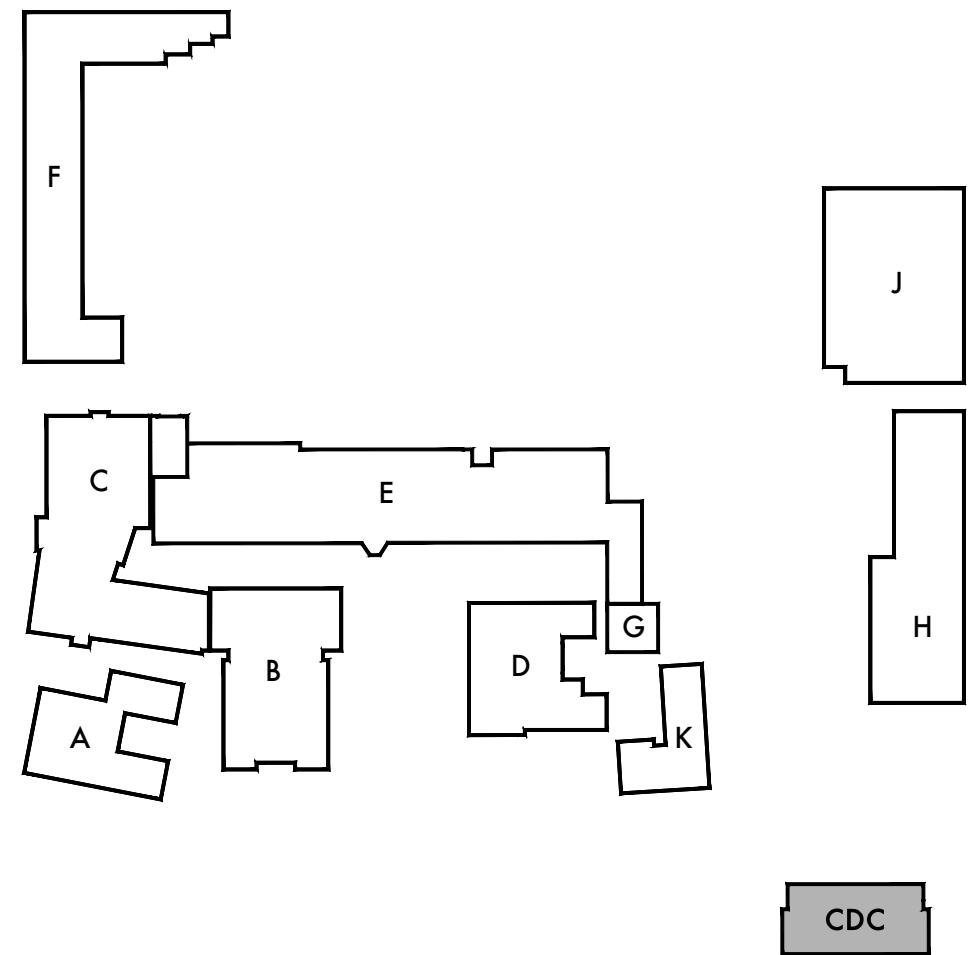


Sheet Title

Building 'CDC'
Mechanical Plans

Sheet Number

MCDC201



KEY PLAN


KEYNOTES

- 1
- 10"x10" OSA DUCT W/ 1" LINING DN THRU ROOF. PROVIDE ROOF JACK WITH WIRE MESH SCREEN.
- 2
- 12"x10" OSA DUCT W/ 1" LINING DN THRU ROOF. OFFSET DUCT & CONNECT TO RETURN AIR PLENUM. PROVIDE ROOF JACK WITH WIRE MESH SCREEN.
- 3
- 8"Ø EXHAUST DUCT DN THRU ROOF. PROVIDE ROOF CAP.

Architect



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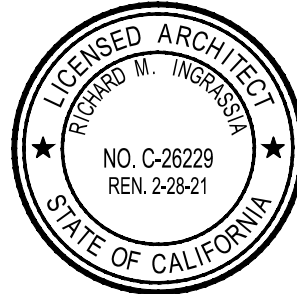

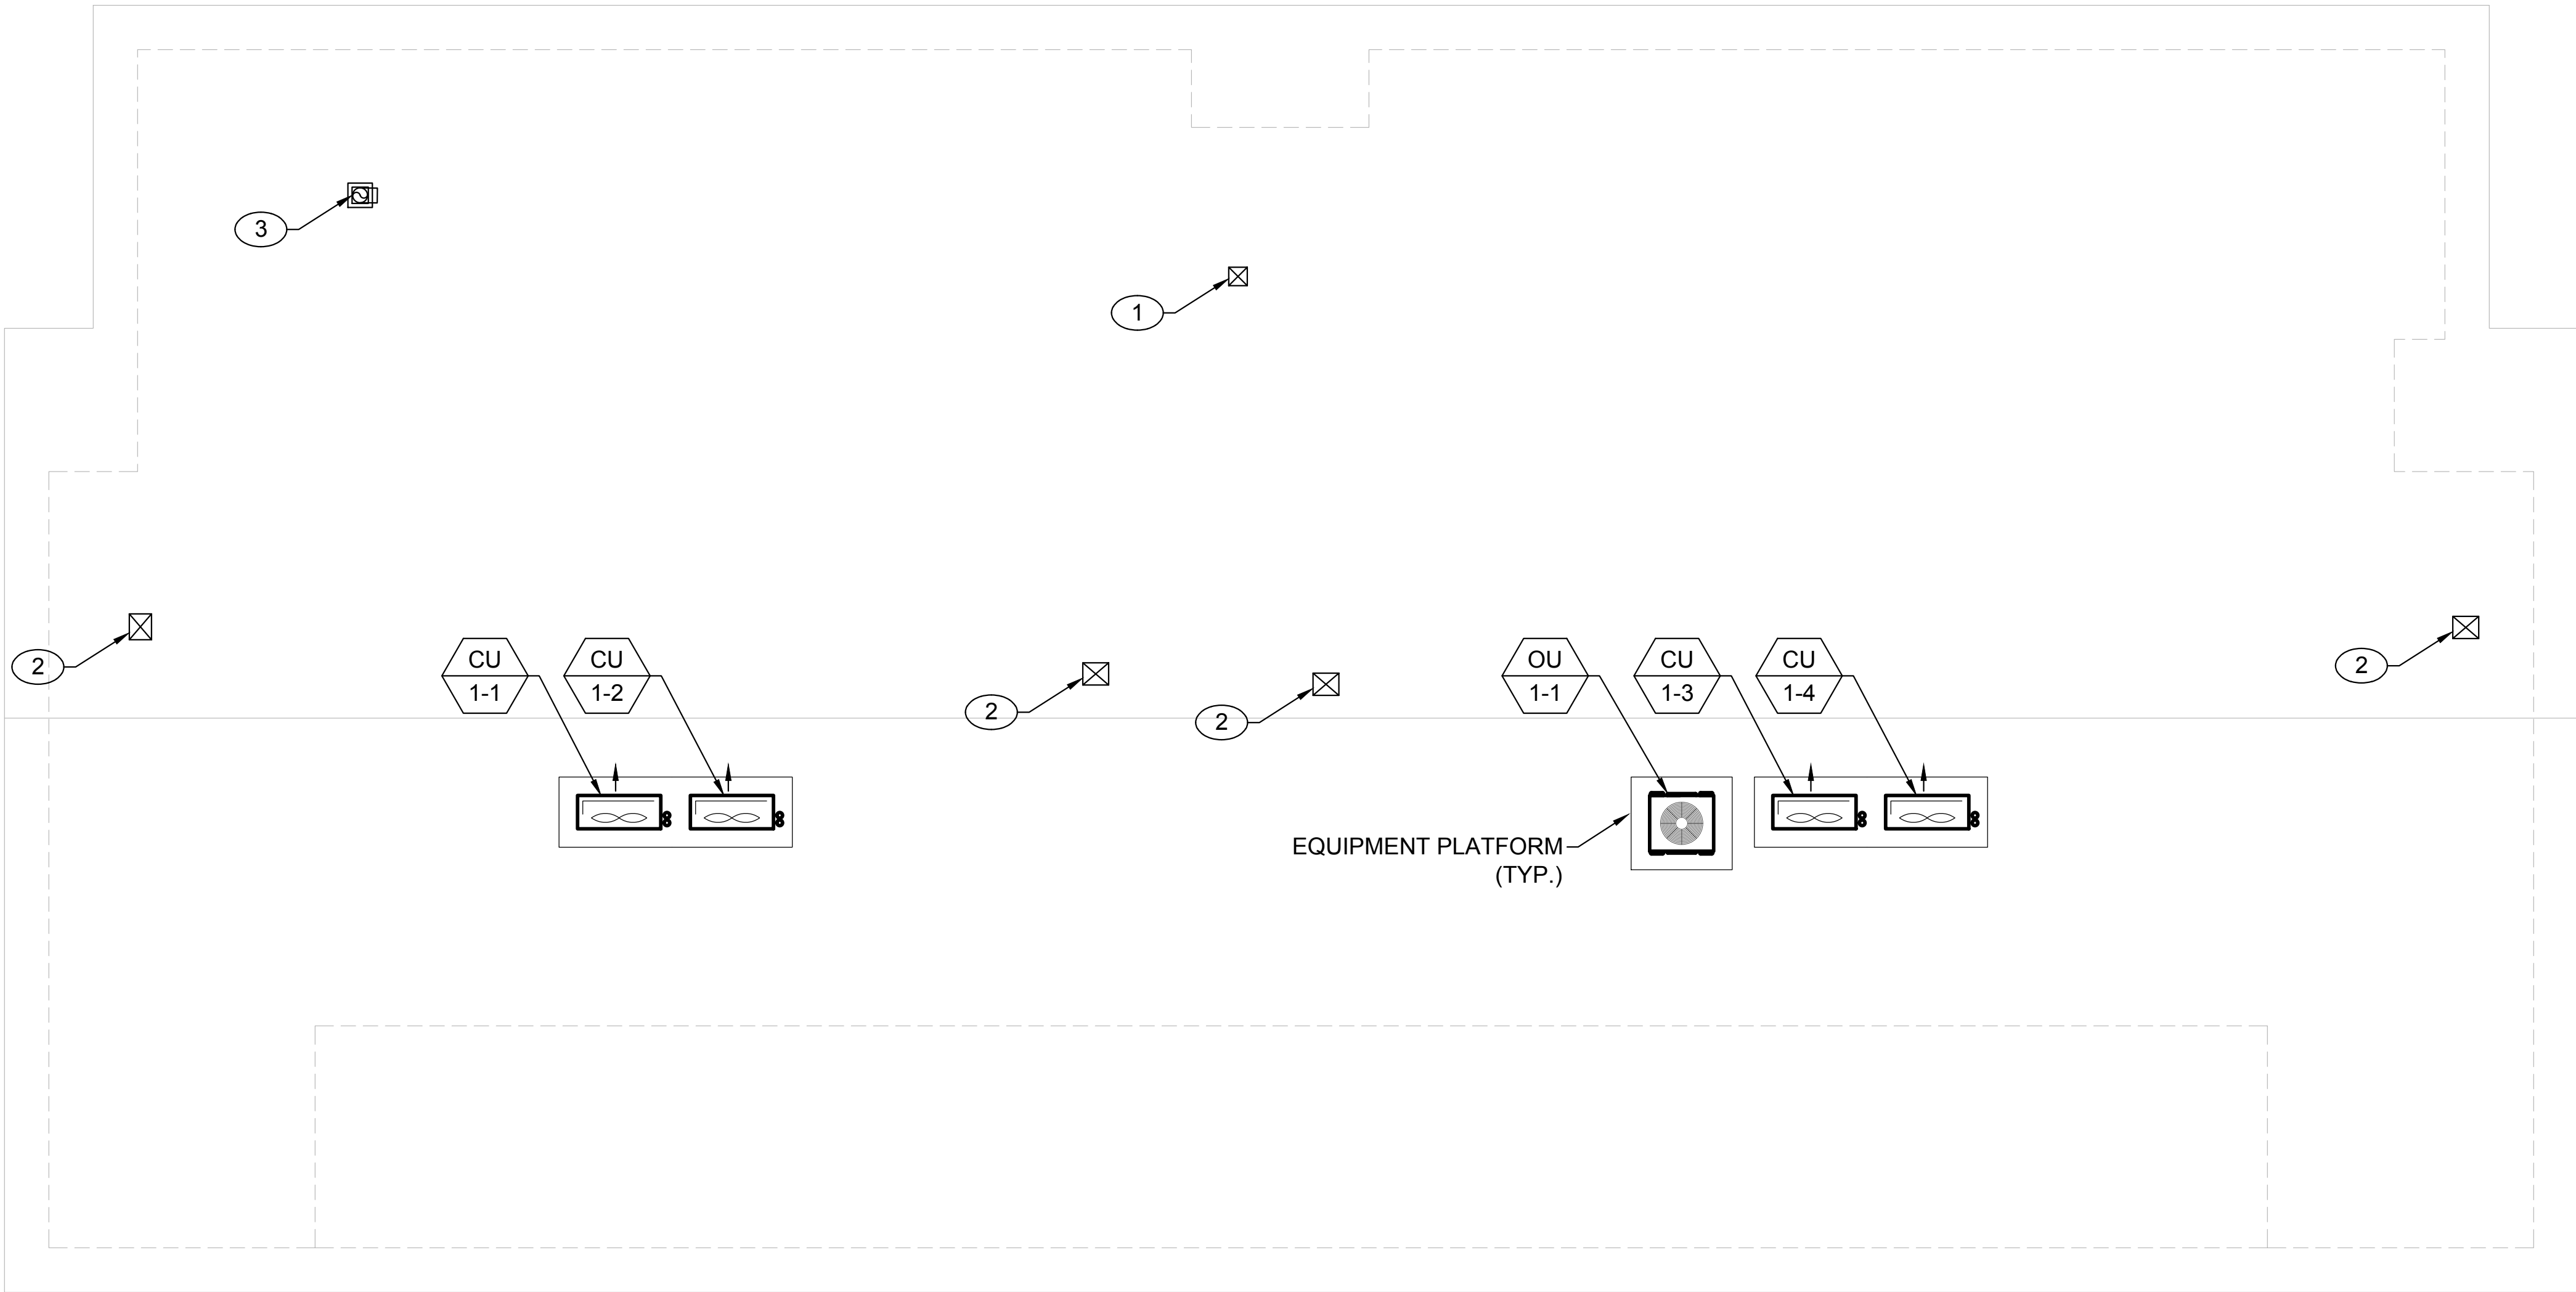
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Lincoln Middle School
1501 California Avenue
Santa Monica, California 90403

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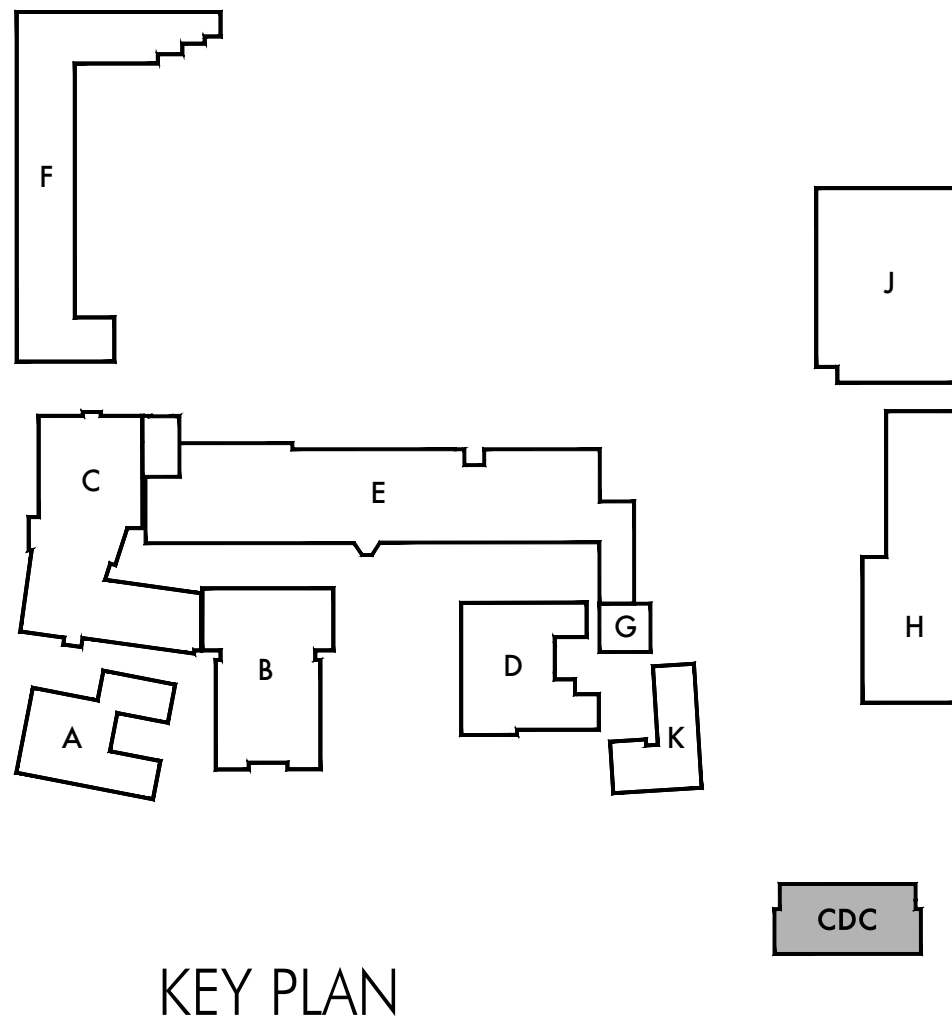
Sheet Title
Building 'CDC'
Mechanical
Roof Plan

Sheet Number

MCDC202




SCALE: 3/16"=1'-0"



1. ALL MECHANICAL WORK NEED TO BE COORDINATED WITH ARCHITECTURAL PLANS AND ENSURE THAT ALL EQUIPMENT, DUCTWORK, AIR DEVICES, PIPING, ETC. ARE COORDINATED WITH ALL ARCHITECTURAL ITEMS INCLUDING BUT NOT LIMITED TO LIGHTS, SPEAKERS, SPRINKLERS, ETC. AND ALSO MECHANICAL WORK AND ITEMS AS NEEDED. SEE ARCH PLANS FOR THE APPROPRIATE COORDINATION OF WORK THAT MAY NOT BE ADDRESSED OR SHOWN ON MECHANICAL PLANS.
2. SEE ARCHITECTURAL DRAWINGS INCLUDING REFLECTED CEILING PLANS AND INTERIOR ELEVATIONS FOR FURTHER DIMENSIONS AND LOCATIONS OF ALL THERMOSTATS, DIFFUSERS, GRILLES, REGISTERS, ETC.
3. FOR CLASSROOMS, AND OTHER SPACES WITH NEW HVAC REPLACEMENT, CONTRACTOR TO COORDINATE WITH SCHOOL DISTRICT REPRESENTATIVE FOR THE THERMOSTAT TYPE AND CONNECTIVITY TO ALLOW FOR SCHEDULING AND UNIT CONTROL.
4. MAINTAIN A MINIMUM OF 10' OF CLEARANCE BETWEEN ANY EXHAUST OUTLET AND OUTSIDE AIR INTAKE INTO THE BUILDING.
5. FOR INDIVIDUAL EQUIPMENT DETAIL, REFERENCE, SEE EQUIPMENT SCHEDULES ON SHEET 0002 THRU 0007.
6. ALL EXPOSED DUCTWORK IN GYMNASIUM NEEDS TO BE FINISH APPEARANCE. SEE ARCHITECTURAL DRAWINGS FOR EXACT COLOR AND FINISHES.

- 1 WALL MOUNTED FAN COIL UNIT. INSTALL PER MANUFACTURER'S RECOMMENDATIONS. COORDINATE LOCATION WITH ALL OTHER TRADES. ENSURE PROPER ACCESS TO UNIT FOR MAINTENANCE. FOR MOUNTING DETAIL SEE -IM- RUN REFRIGERANT LINES TO CORRESPONDING CONDENSER UNIT PER MANUFACTURER RECOMMENDATION.
- 2 22x22(L) RA DUCT UP THRU ROOF TO RTU (4,000 CFMS). COORDINATE DUCT ROUTING BETWEEN EXISTING FRAMING.
- 3 22x22(L) RA DUCT UP THRU ROOF TO RTU (4,000 CFMR). COORDINATE DUCT ROUTING BETWEEN EXISTING FRAMING.
- 4 24x24 SIDEWALL SA GRILLE (SWS). REFER TO ARCHITECTURAL DRAWINGS FOR EXACT LOCATION, COLOR AND FINISH.
- 5 42(L)X24(H) SIDEWALL RA GRILLE (SWR). REFER TO ARCHITECTURAL DRAWINGS FOR EXACT LOCATION, COLOR AND FINISH.
- 6 24x24 SIDEWALL SA GRILLE (SWS). REFER TO ARCHITECTURAL DRAWINGS FOR EXACT LOCATION, COLOR AND FINISH.
- 7 28x28 SA DUCT UP THRU ROOF TO EC 1-1, 7500 CFMS. COORDINATE DUCT ROUTING BETWEEN EXISTING ROOF FRAMING.
- 8 24" KITCHEN EXHAUST DUCT WITH 3H 2-HOUR RATED FIRE WRAP UP THRU ROOF TO EF 1-1. PROVIDE NEW ROOF OPENING AS REQUIRED. PAINT EX-1, AND PAINT ANY UNUSED ROOF OPENING TO MATCH ADJACENT ROOF.
- 9 EXISTING KITCHEN HOOD TO REMAIN AND REFINISHED TO LIKE NEW CONDITION. SEE DEMO GENERAL NOTES.
- 10 CEILING DIFFUSER (CD) WITH 14x14 NECK SIZE AND VOLUME. SET AND BALANCE EACH CD TO 940 CFMS.
- 11 8"Ø EXH DUCT SWITCH UP THRU ROOF.
- 12 CONTROL SWITCH FOR CEILING EXH FAN.

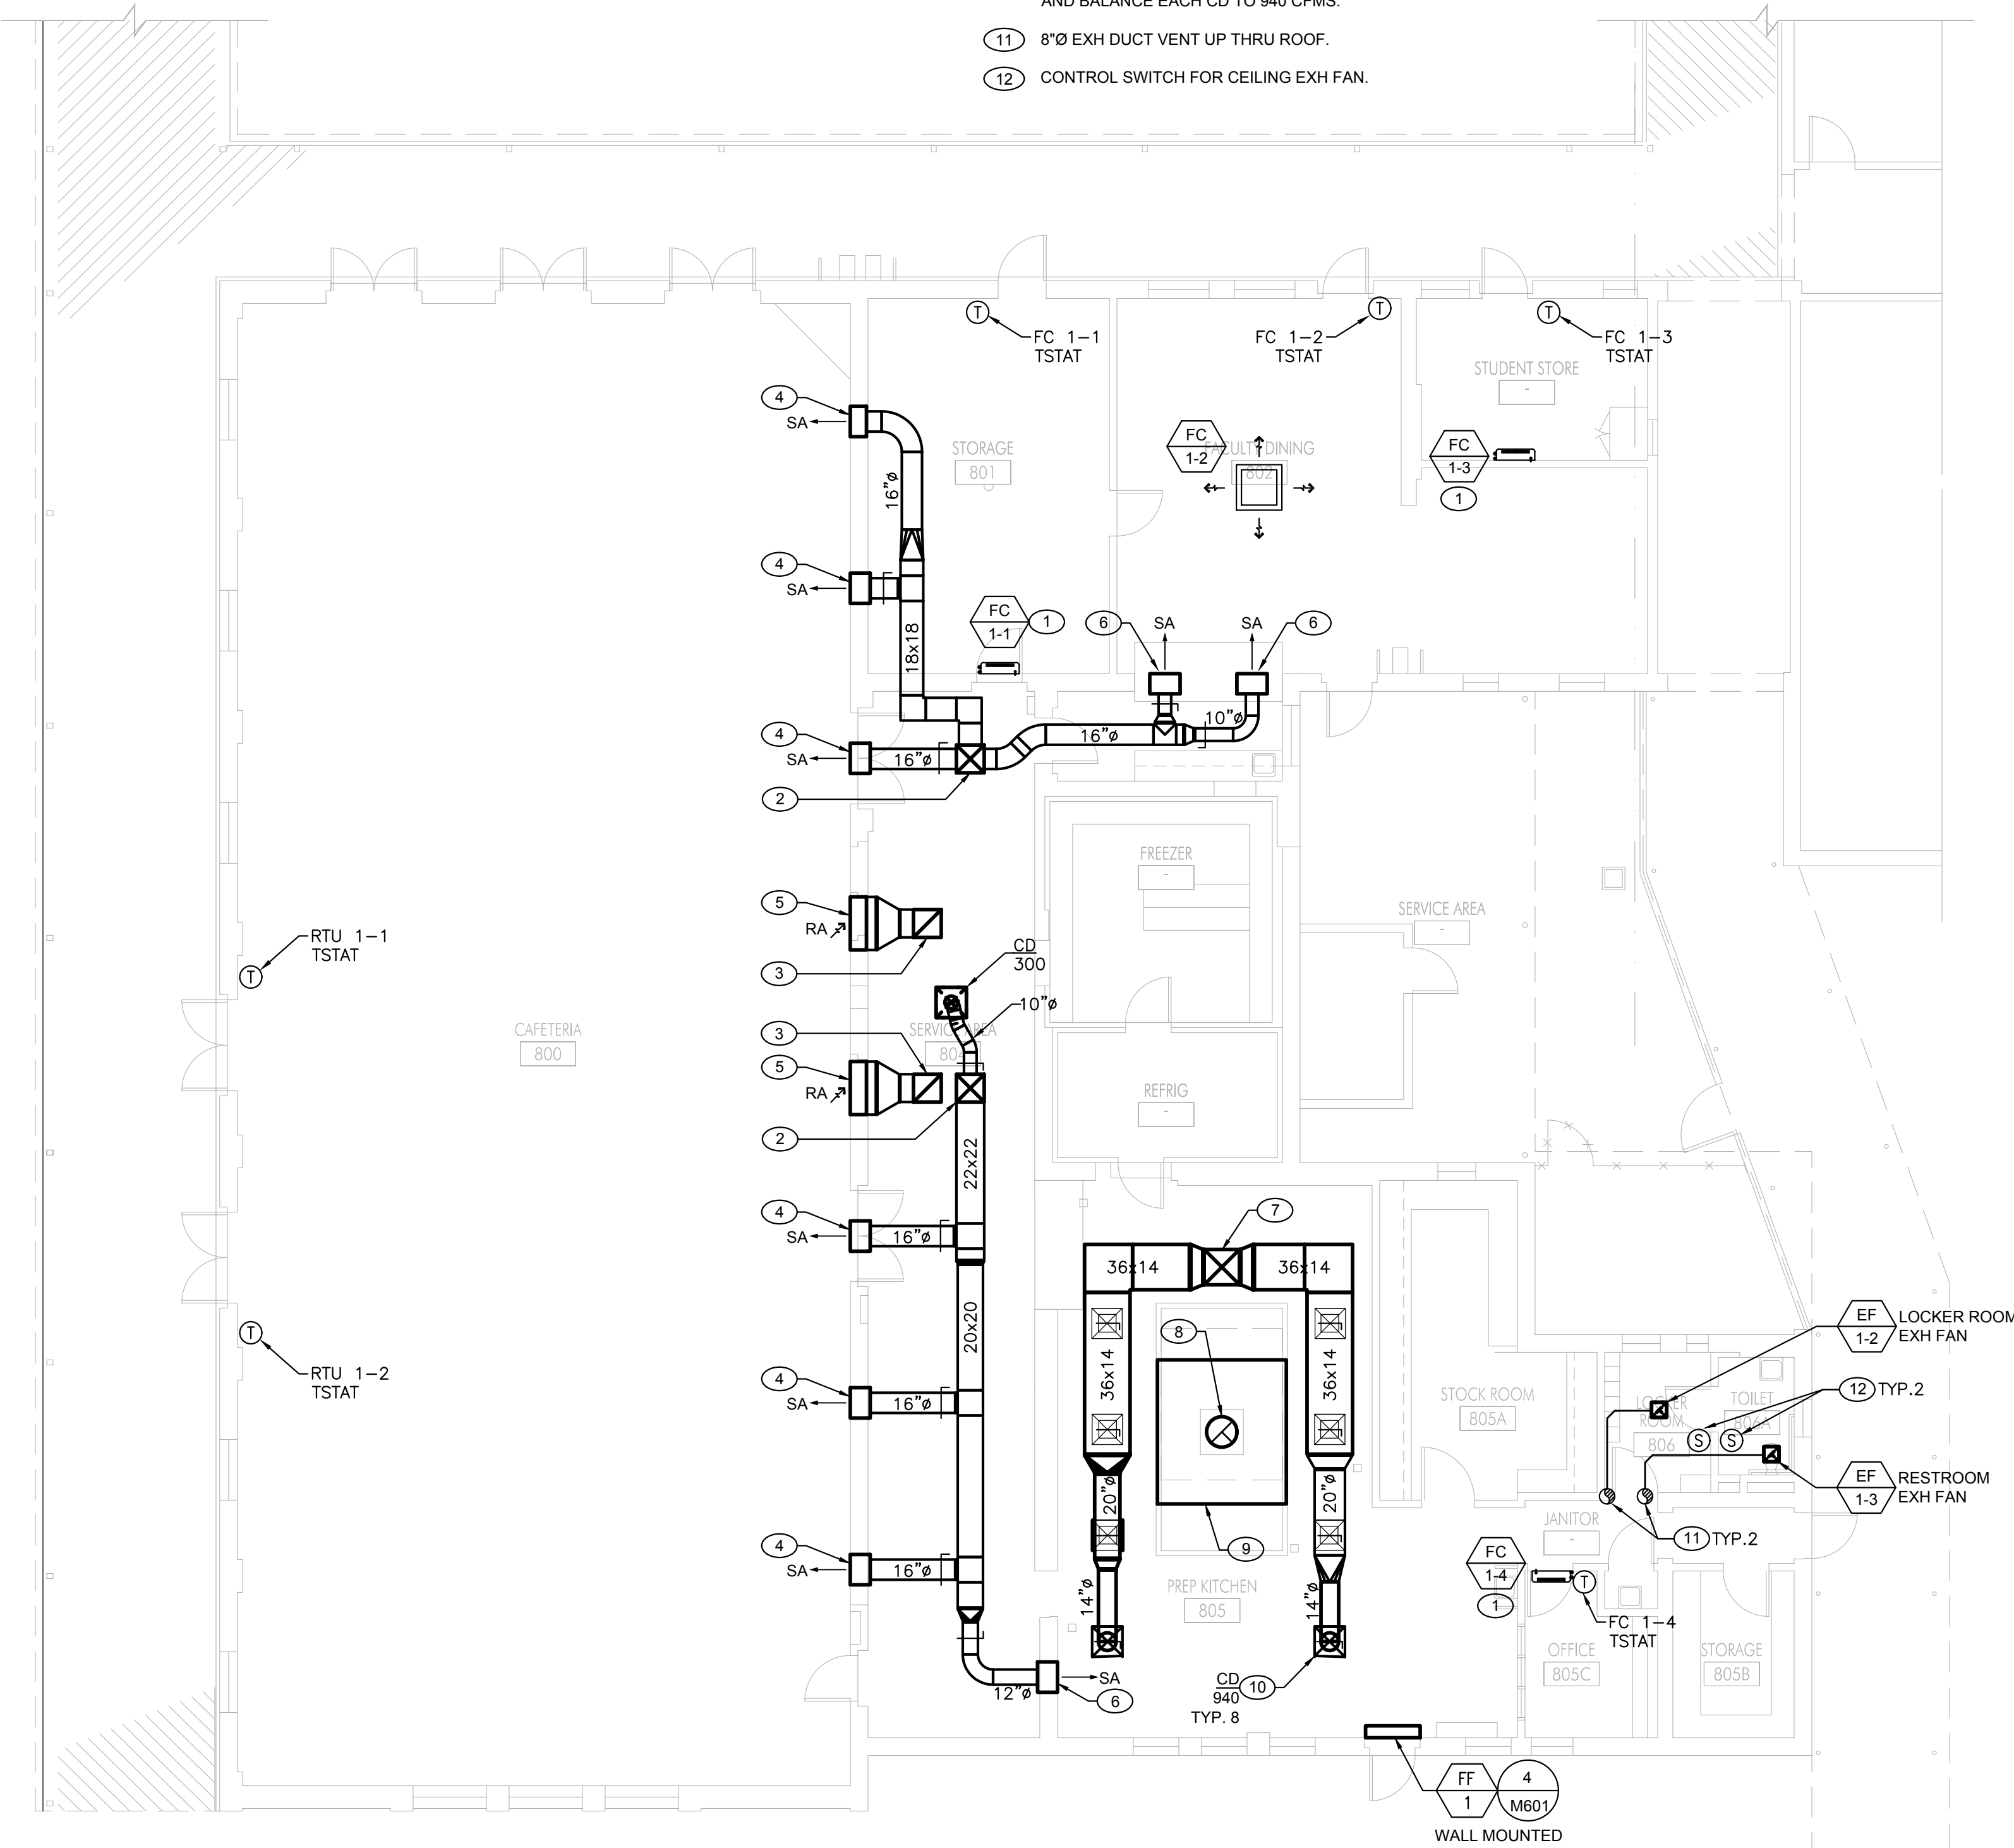


NORTH

SCALE: 1/8"=1'-0"

1. CONTRACTOR SHALL VISIT THE SITE PRIOR TO SUBMISSION OF BID AND CONDUCT A THOROUGH FIELD INVESTIGATION TO VERIFY EXISTING CONDITIONS AND BE THAT THE CONTRACTOR FAMILIAR WITH THE EXISTING CONDITIONS OF WORK. HE SHALL FURNISH ALL LABORS, SUPERVISION, MATERIALS, EQUIPMENT AND FACILITIES NECESSARY TO CARRY OUT THIS WORK AND SUBMIT ALL QUESTIONS IN WRITING PRIOR TO BID.
2. ANY EXISTING TO REMAIN EQUIPMENT AND DUCTWORK OUTSIDE OF DASHED LINE SCOPE OF WORK, SHALL BE REPAIRED, CLEANED AND PAINTED BY CONTRACTOR PER DISTRICT'S STANDARDS.


CONTRACTOR SHALL REPAIR, PATCH AND SEAL ALL UNUSED OR DAMAGED WALL, ROOF, ROOF OPENINGS AND PENETRATIONS TO BUILDINGS CAUSED BY DEMOLITION OF EQUIPMENT, PIPING, DUCTWORK, SUPPORTS, ETC.
4. CONTRACTOR SHALL REMOVE AND DISPOSE OF ALL EXISTING REGISTERS, DUCTWORK AND RELATED APPURTENANCES SHOWN WITHIN DASHED LINES SCOPE OF WORK. THEY MUST NOT BE ABANDONED IN PLACE UNLESS NOTED OTHERWISE
5. ALL DAMAGED, BROKEN OR INOPERABLE AIR DEVICES OR DAMPERS SHALL BE REPLACED BY CONTRACTOR WITH NEW LIKE SIZED COMPONENTS OR AIR DEVICES CONTRACTOR SHALL CONDUCT A THOROUGH FIELD INVESTIGATION TO VERIFY EXISTING CONDITIONS PRIOR TO BIDDING. SUBMIT ALL QUESTIONS IN WRITING PRIOR TO BID.
6. CONTRACTOR SHALL INSTALL ALL EQUIPMENT AND DEVICES SUCH THAT COMPONENTS WILL BE ACCESSIBLE FOR MAINTENANCE.
7. FIRE PROTECTION DURING DEMOLITION / CONSTRUCTION OF WORK SHALL BE IN ACCORDANCE WITH 2016 CBC, CHAPTER 33.

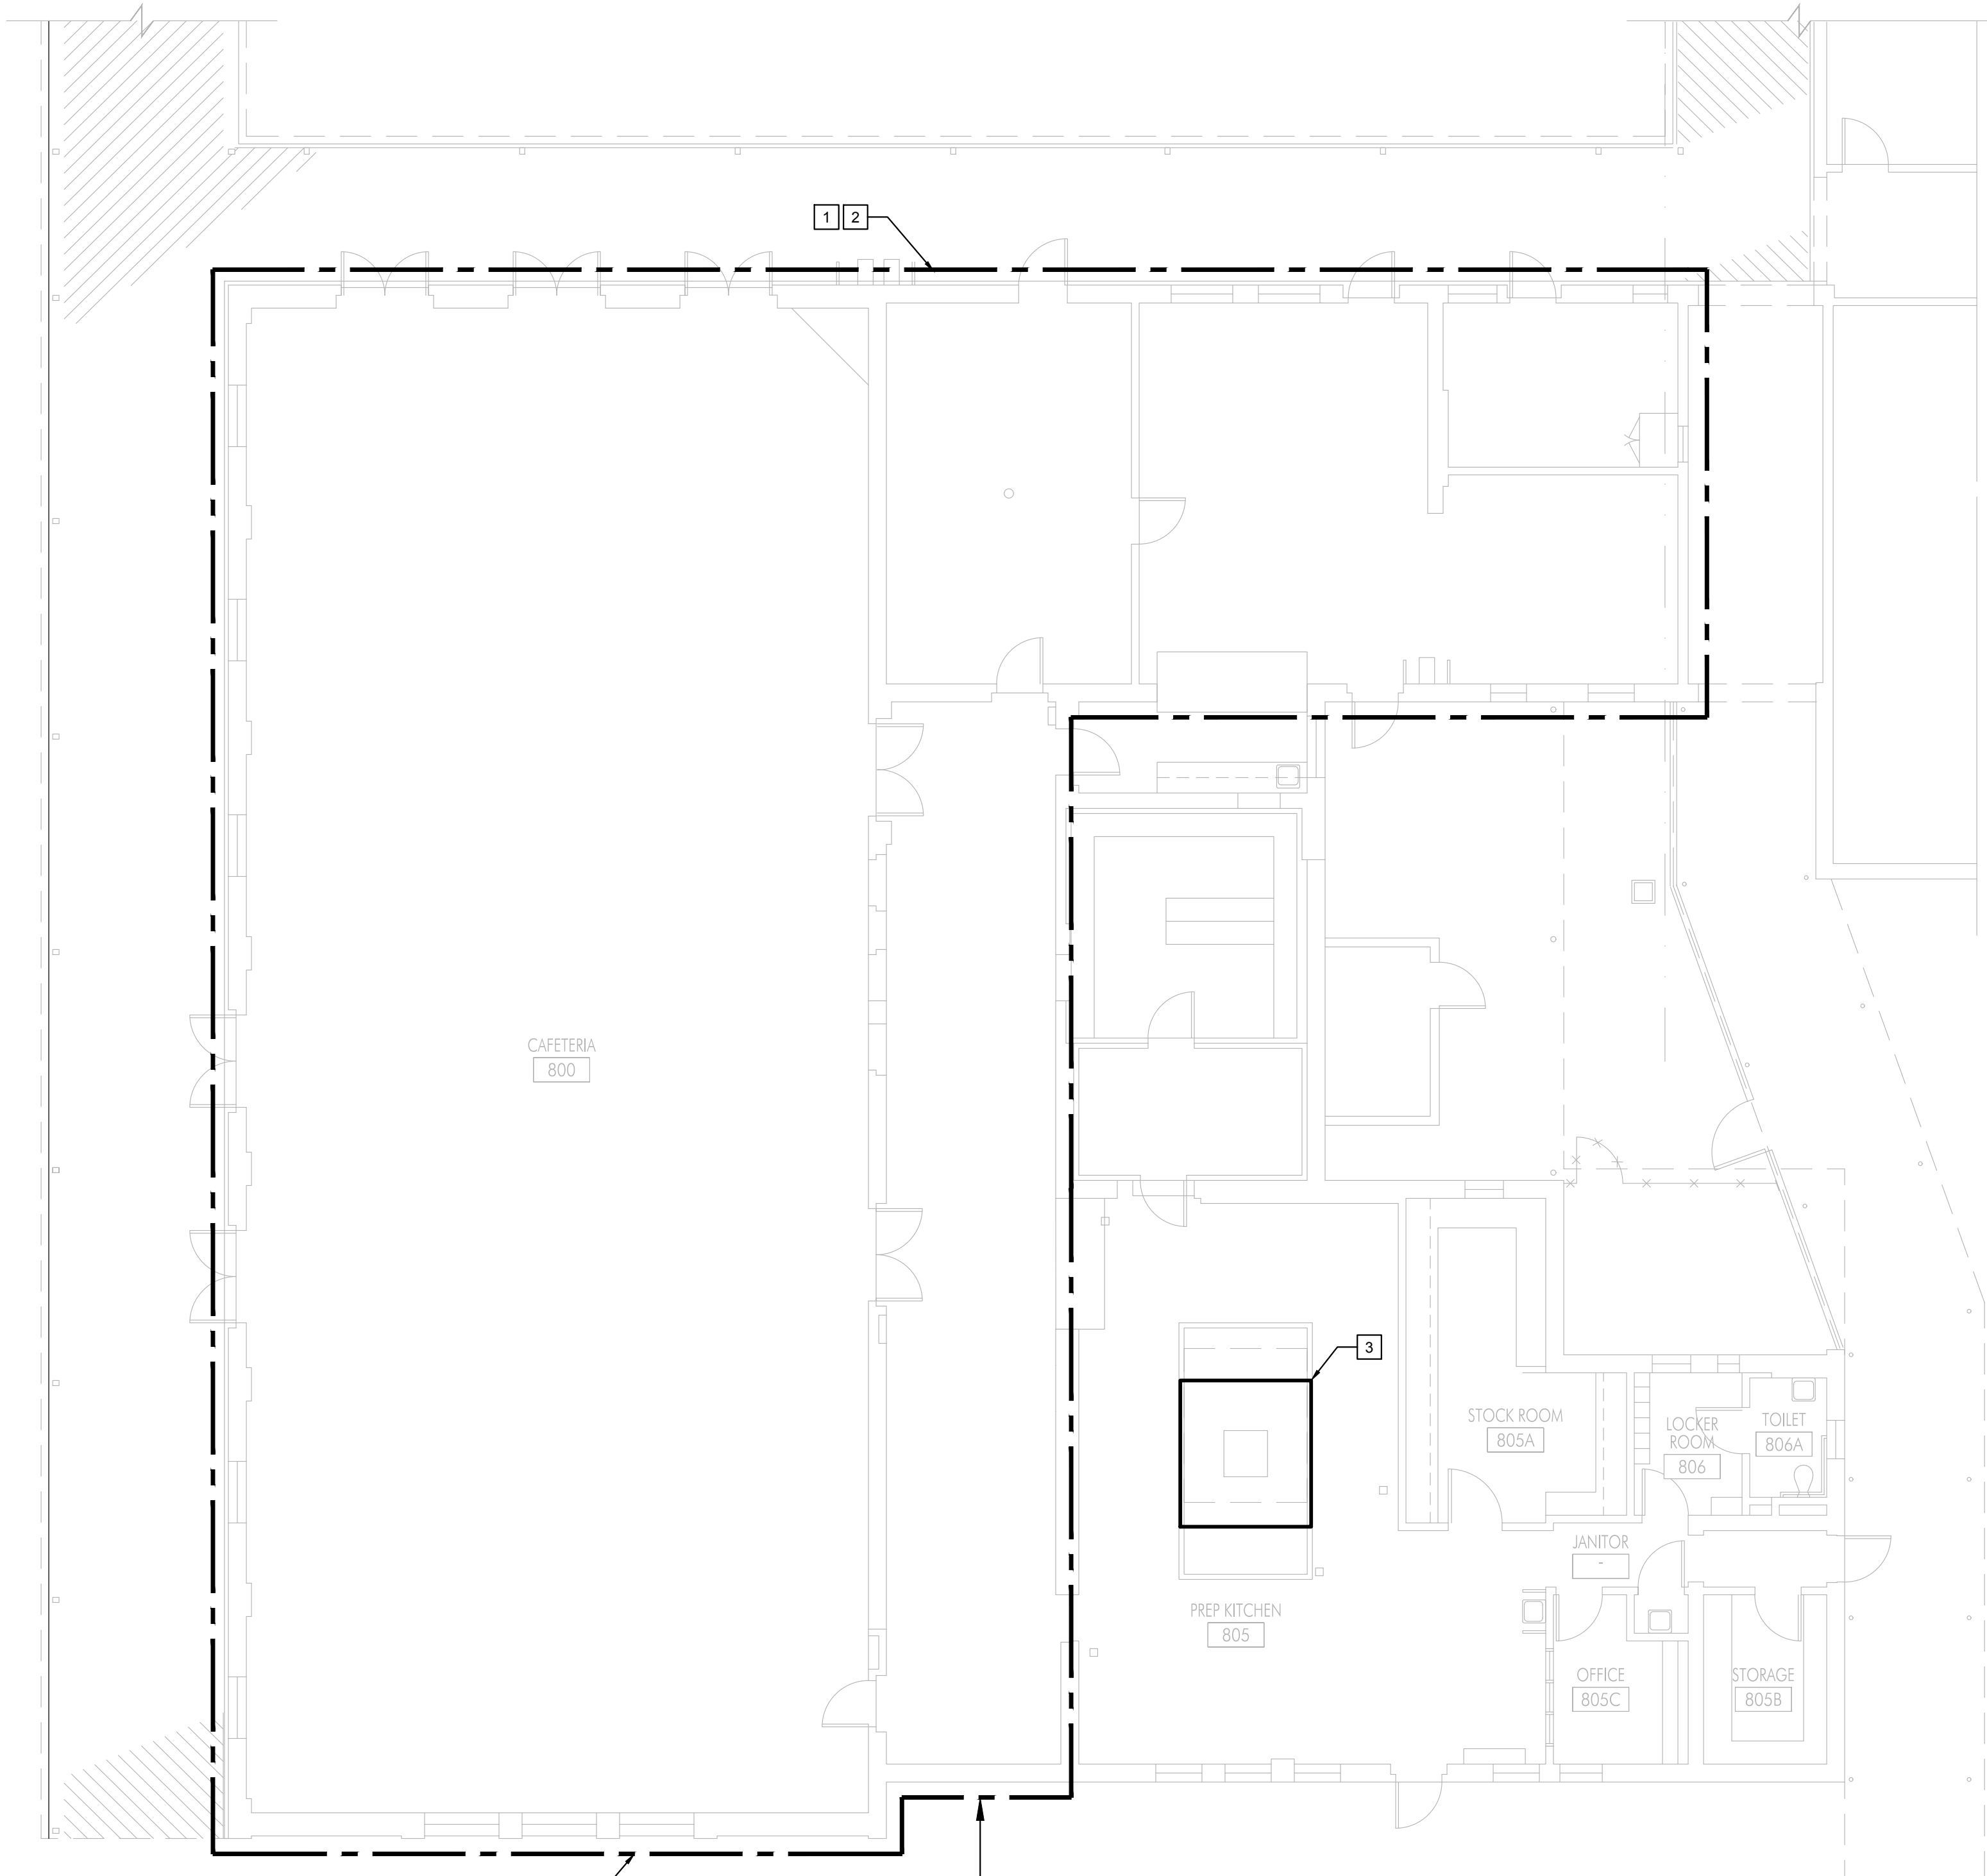

NORTH

SCALE: 1/8"=1'-0"

- 1 DEMOLISH AND REMOVE ALL EXISTING HVAC EQUIPMENT AS SHOWN WITHIN DASHED LINE'S SCOPE OF WORK, INCLUDING BUT NOT LIMITED TO ALL EXISTING HVAC EQUIPMENT, DUCTWORK, AIR DEVICES, PIPING, SUPPLY/ EXHAUST/ CONDENSATE/ REFRIGERANT ASSOCIATED WITH THE EQUIPMENT, AND/OR OF OTHER OWNERS. DIRECTION, CONTRACTOR SHALL REPAIR, PATCH AND PAINT ALL ROOF, WALL, CEILING, FLOOR INCLUDING ANY ASSOCIATED OPENINGS OR PENETRATIONS TO MATCH ADJACENT SURFACES PER ARCHITECTURAL DRAWINGS.
- 2 CONTRACTOR SHALL COORDINATE WITH ALL TRADES TO PROVIDE A CLEAR AND OPERABLE AREA FOR FUTURE REMODEL WORK.
- 3 EXISTING KITCHEN HOOD SHALL BE REPAIRED, CLEANED AND REFURBISHED TO LIKE NEW CONDITION BY CONTRACTOR PER DISTRICTS STANDARDS.

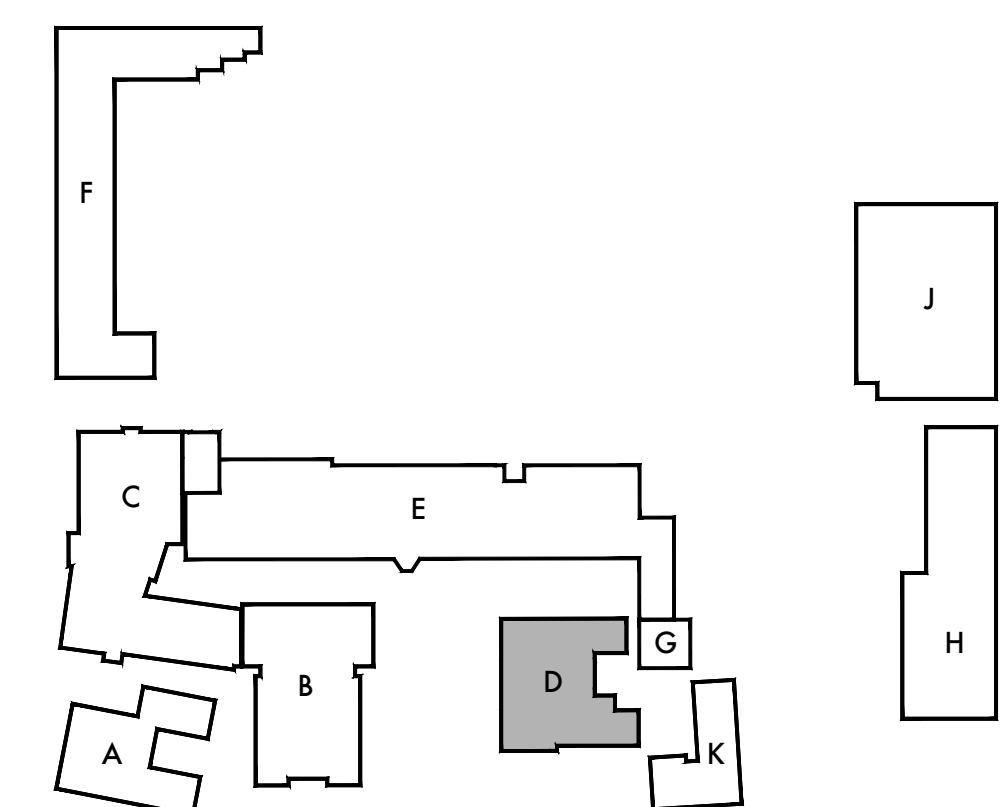

Architect



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Lincoln Middle School HVAC Replacement Project
Lincoln Middle School
1501 California Avenue
Santa Monica, California 90403

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Project No. 19009


Sheet Title

Building 'D'

Mechanical Plans

Sheet Number

MD201

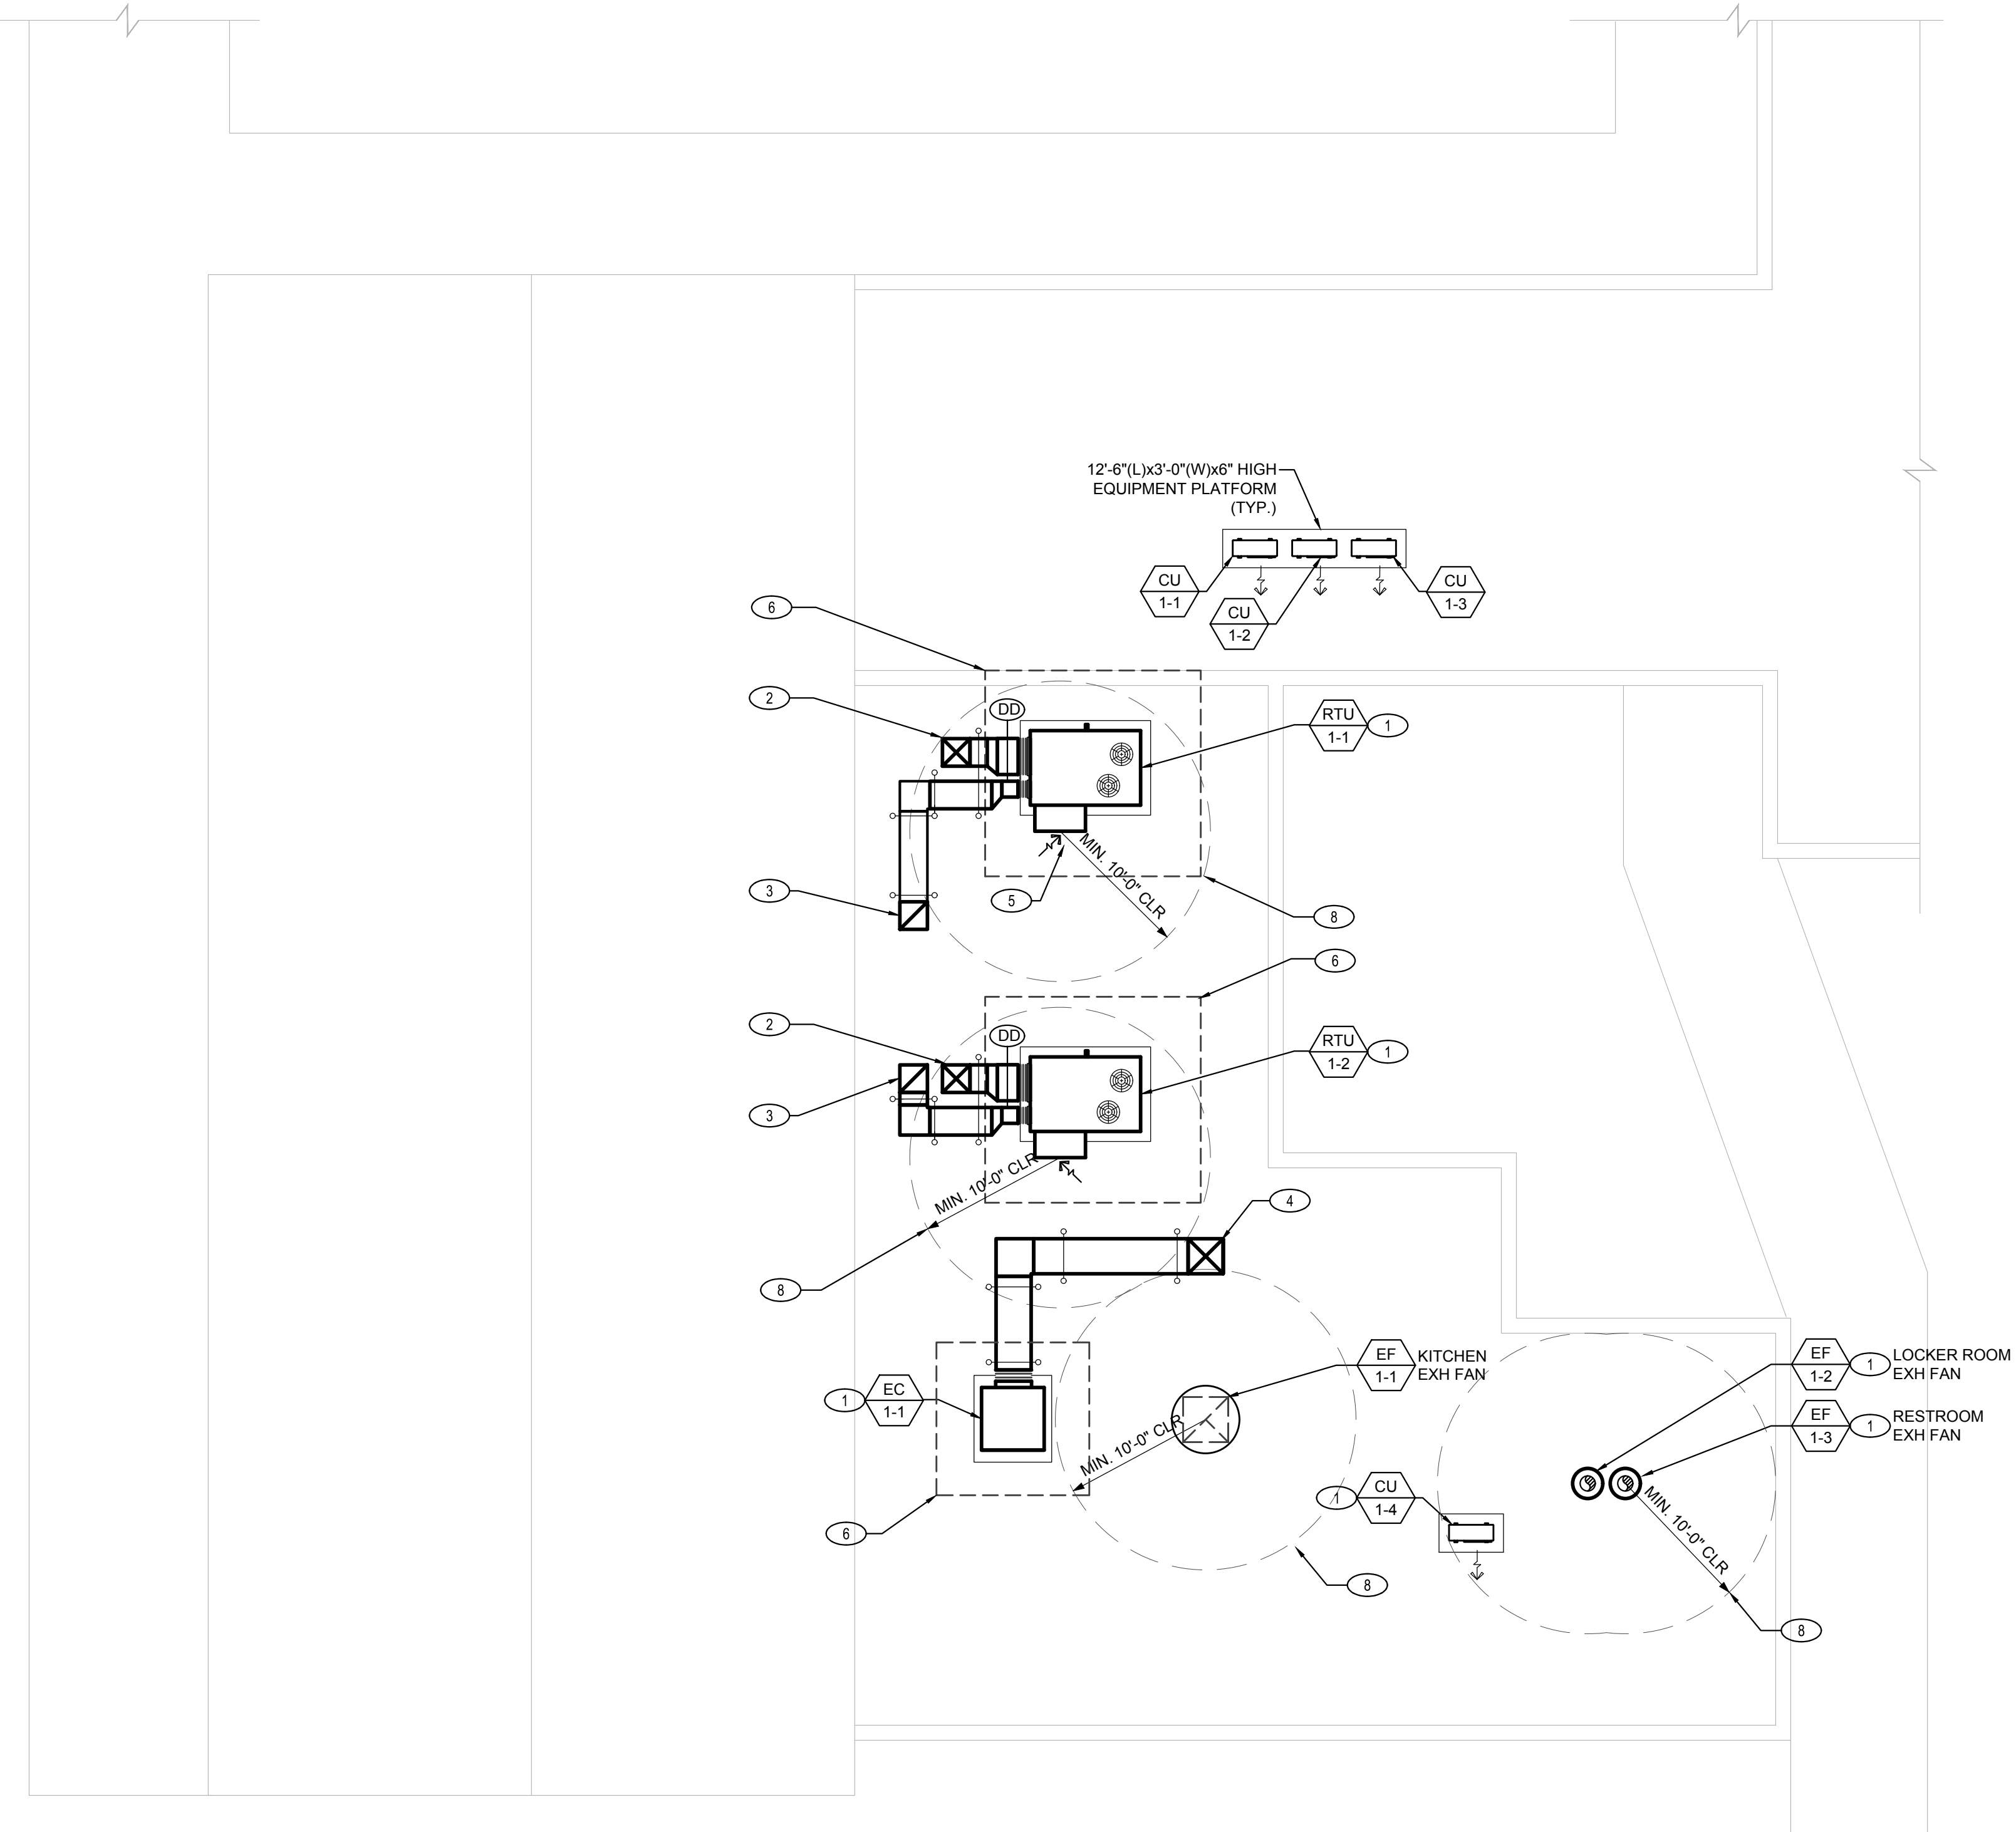

1 MECHANICAL ROOF PLAN

ROOF REMODEL KEYNOTES

- 1 HVAC EQUIPMENT MUST BE INSTALLED AT LEAST 10'-0" AWAY FROM PARAPET WALL.
- 2 22x22(L) SA DUCT DOWN THRU ROOF. COORDINATE DUCT ROUTING BETWEEN EXISTING ROOF FRAMING OR OPENINGS. SEE STRUCTURAL DRAWINGS FOR FRAMING OF OPENINGS.
- 3 22x22(L) RA DUCT DOWN THRU ROOF. COORDINATE DUCT ROUTING BETWEEN EXISTING ROOF FRAMING OR OPENINGS. SEE STRUCTURAL DRAWINGS FOR FRAMING OF OPENINGS.
- 4 28x28(L) MAKE-UP AIR DUCT DOWN THRU ROOF SERVING KITCHEN BELOW. COORDINATE DUCT ROUTING BETWEEN EXISTING ROOF FRAMING OR OPENINGS. SEE STRUCTURAL DRAWINGS FOR FRAMING OF OPENINGS.
- 5 RTU OSA INTAKE HOOD. MAINTAIN MINIMUM 10'-0" CLEARANCE BETWEEN OSA HOOD AND ANY EXHAUST FROM THE BUILDING. RELOCATE EQUIPMENT AS REQUIRED TO MEET THIS CODE REQUIRED CLEARANCE(S).
- 6 MINIMUM MANUFACTURER CLEARANCES ALL AROUND EACH RTU FOR EQUIPMENT MAINTENANCE AND ACCESS. REFER TO MANUFACTURER WRITTEN RECOMMENDATIONS FOR EXACT REQUIRED CLEARANCES.
- 7 SMOKE DUCT DETECTOR IN SUPPLY DUCT FOR RTUs SERVING IN SPACES WITH CUMULATIVE AIR SUPPLY QUANTITY IN EXCESS OF 2000 CFM.
- 8 MAINTAIN MINIMUM 10'-0" CLEARANCE BETWEEN ANY EXHAUST AND ANY FRESH AIR INTAKE INTO THE BUILDING. RELOCATE EQUIPMENT AS REQUIRED TO MEET THIS CODE REQUIRED CLEARANCE(S).
- 9 CONNECT REFRIGERANT PIPING BETWEEN FAN COIL AND OUTDOOR CONDENSING UNIT. SEE M0.2 AND DETAILS 3 & 4/M0.2 FOR FURTHER INFORMATION.

ROOF REMODEL GENERAL NOTES

1. CONTRACTOR SHALL VISIT THE SITE PRIOR TO SUBMISSION OF BID AND THOROUGHLY FAMILIARIZE HIMSELF WITH THE REMODEL SCOPE OF WORK. HE SHALL FURNISH ALL LABOR, SUPERVISION, MATERIALS, EQUIPMENT AND FACILITIES NECESSARY TO CARRY THIS WORK.
2. ALL ROOFTOP EQUIPMENTS MUST BE INSTALLED AT LEAST 10 FEET AWAY FROM ANY PARAPET WALL.
3. SEE ARCHITECTURAL DRAWINGS INCLUDING REFLECTED CEILING PLANS AND INTERIOR ELEVATIONS FOR FURTHER DIMENSIONS AND LOCATIONS OF ALL THERMOSTATS, DIFFUSERS, GRILLES, REGISTERS, ETC.
4. ALL EXPOSED DUCTWORK SHALL BE 26 GAUGE GALVANIZED STEEL WITH DOUBLE DUCT CONSTRUCTION PER SMACNA GUIDELINES.
5. FOR ALL NEW THERMOSTATS, PROVIDE ALL WIRING, CONDUITS, SUPPORT, FITTINGS, CONTROLS AND REQUIRED ACCESSORIES FOR CONNECTIONS BETWEEN TSTAT AND RESPECTIVE ROOFTOP PACKAGE UNIT.
6. FOR INDIVIDUAL EQUIPMENT DETAIL REFERENCE, SEE EQUIPMENT SCHEDULES ON SHEET M002 THRU M007.
7. MAINTAIN A MINIMUM OF 10'-0" CLEARANCE BETWEEN ANY EXHAUST OUTLET AND OUTSIDE AIR INTAKE INTO THE BUILDING.

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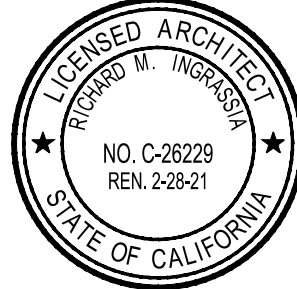
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Lincoln Middle School
1501 California Avenue
Santa Monica, California 90403

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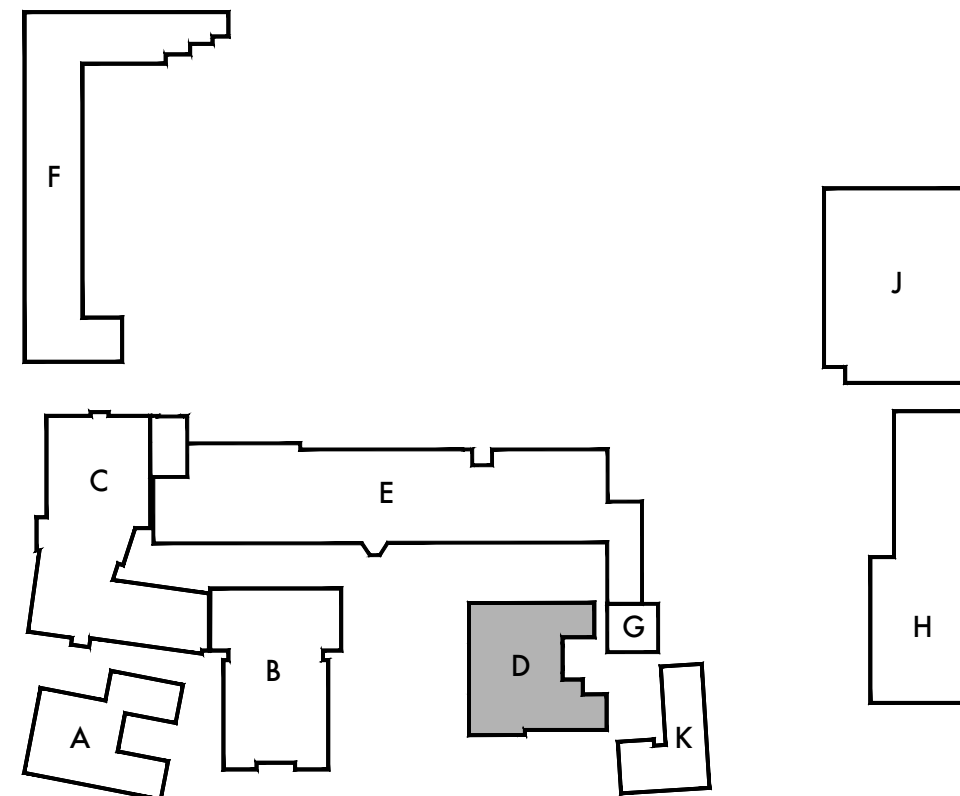


Sheet Title

Building 'D'
Mechanical
Roof Plan


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MD202




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KEYNOTES

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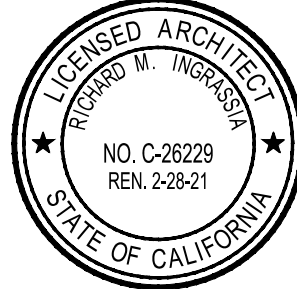
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Lincoln Middle School
1501 California Avenue
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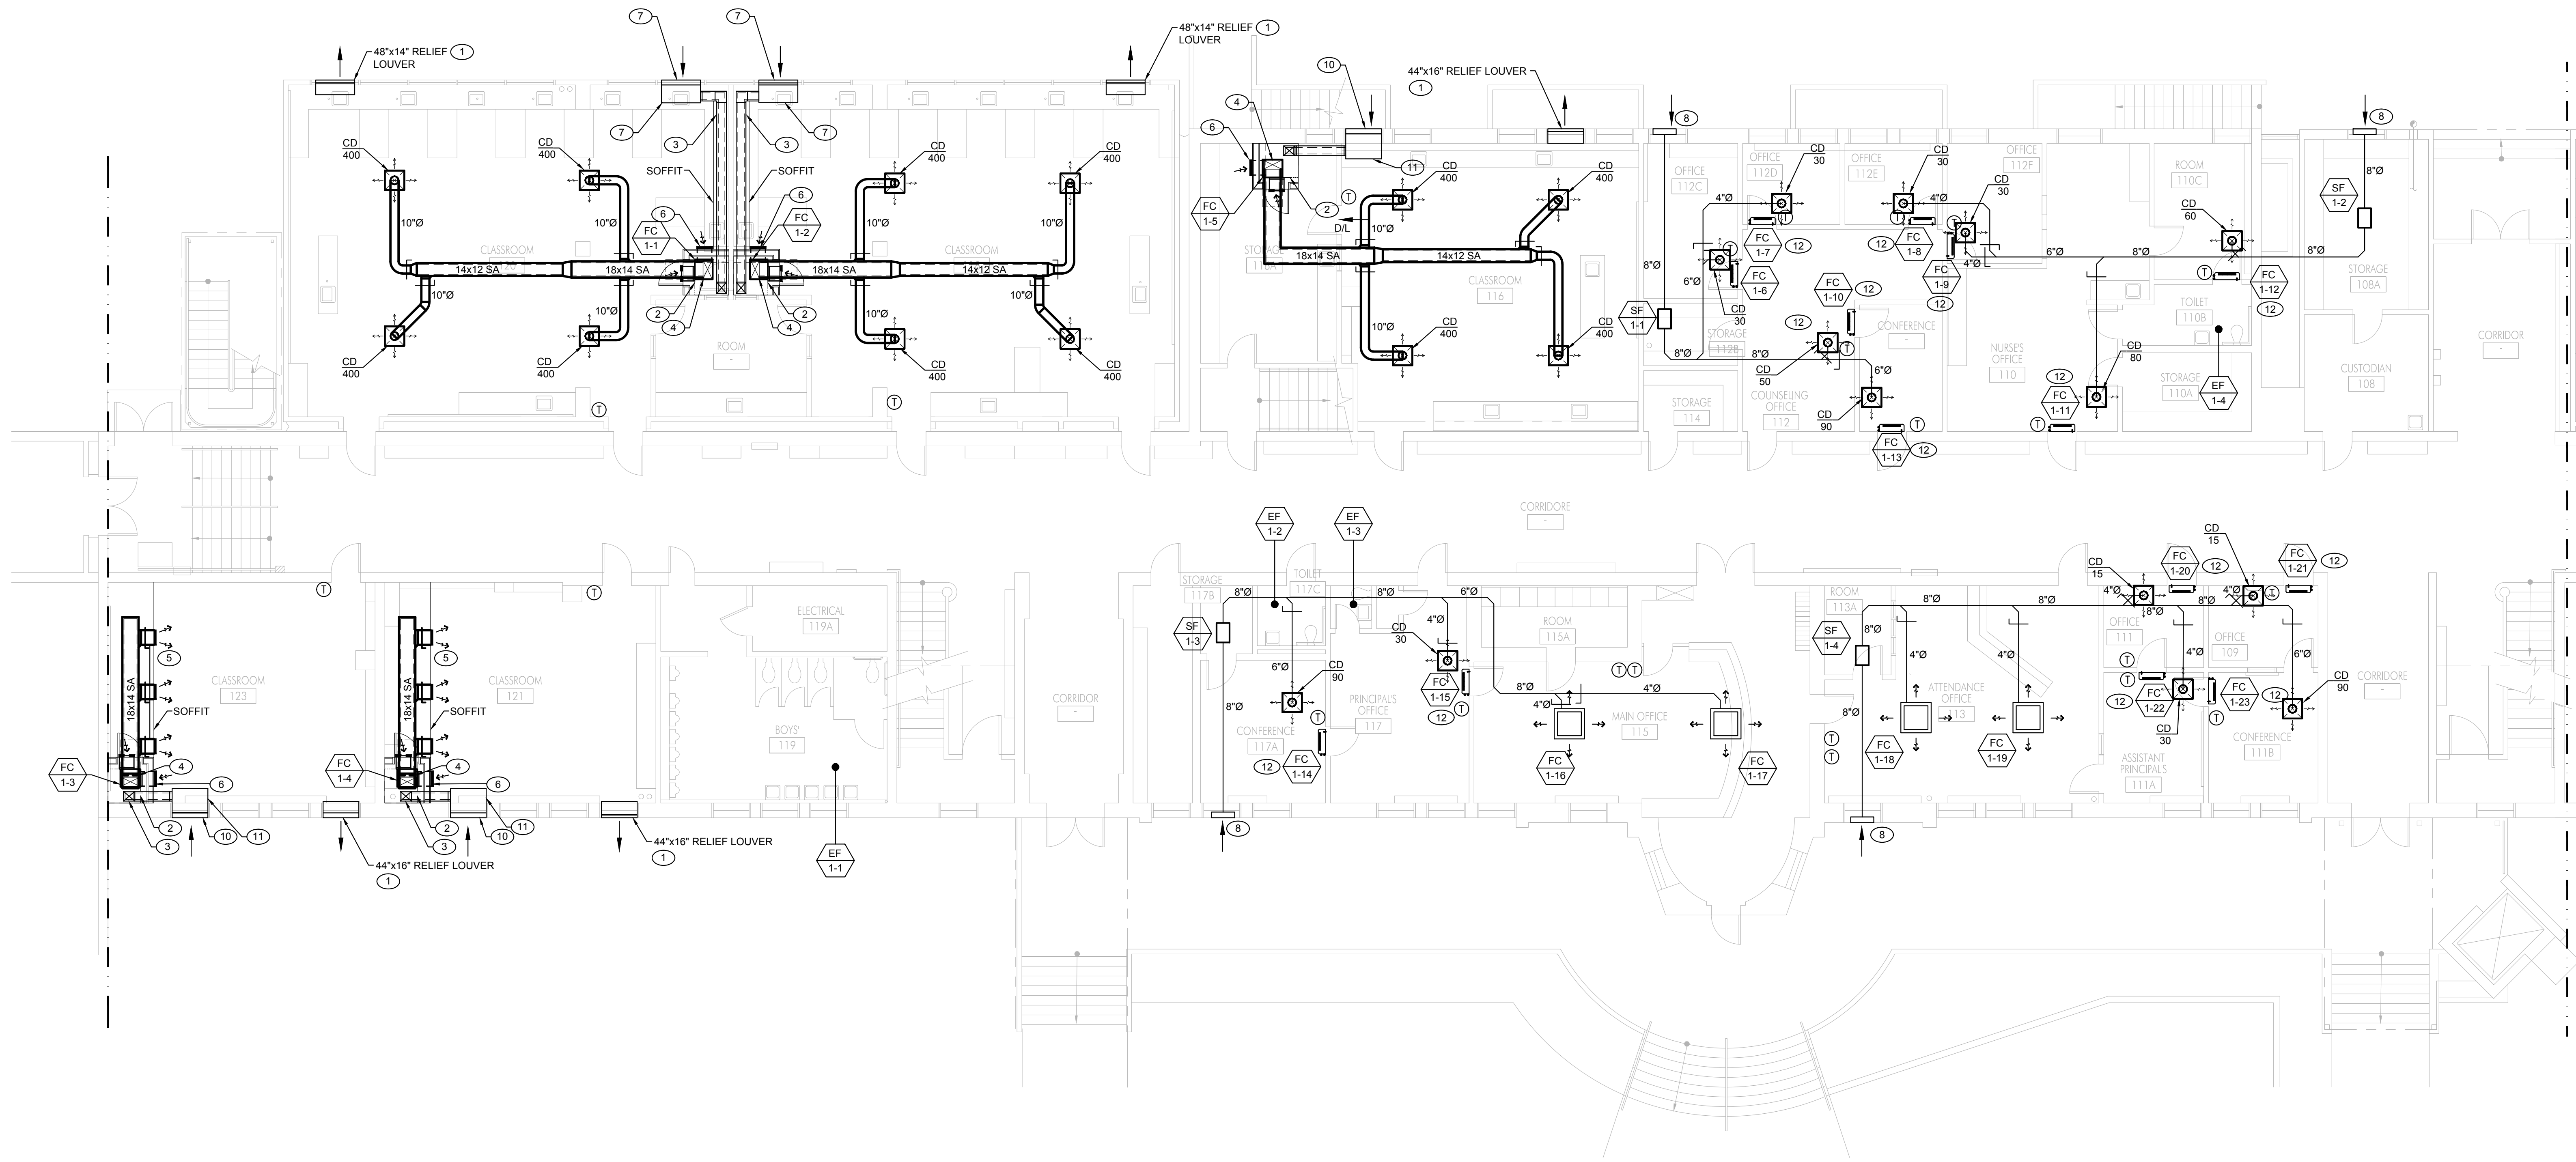


Sheet Title
Building 'D'
Mechanical Roof
Demolition Plan

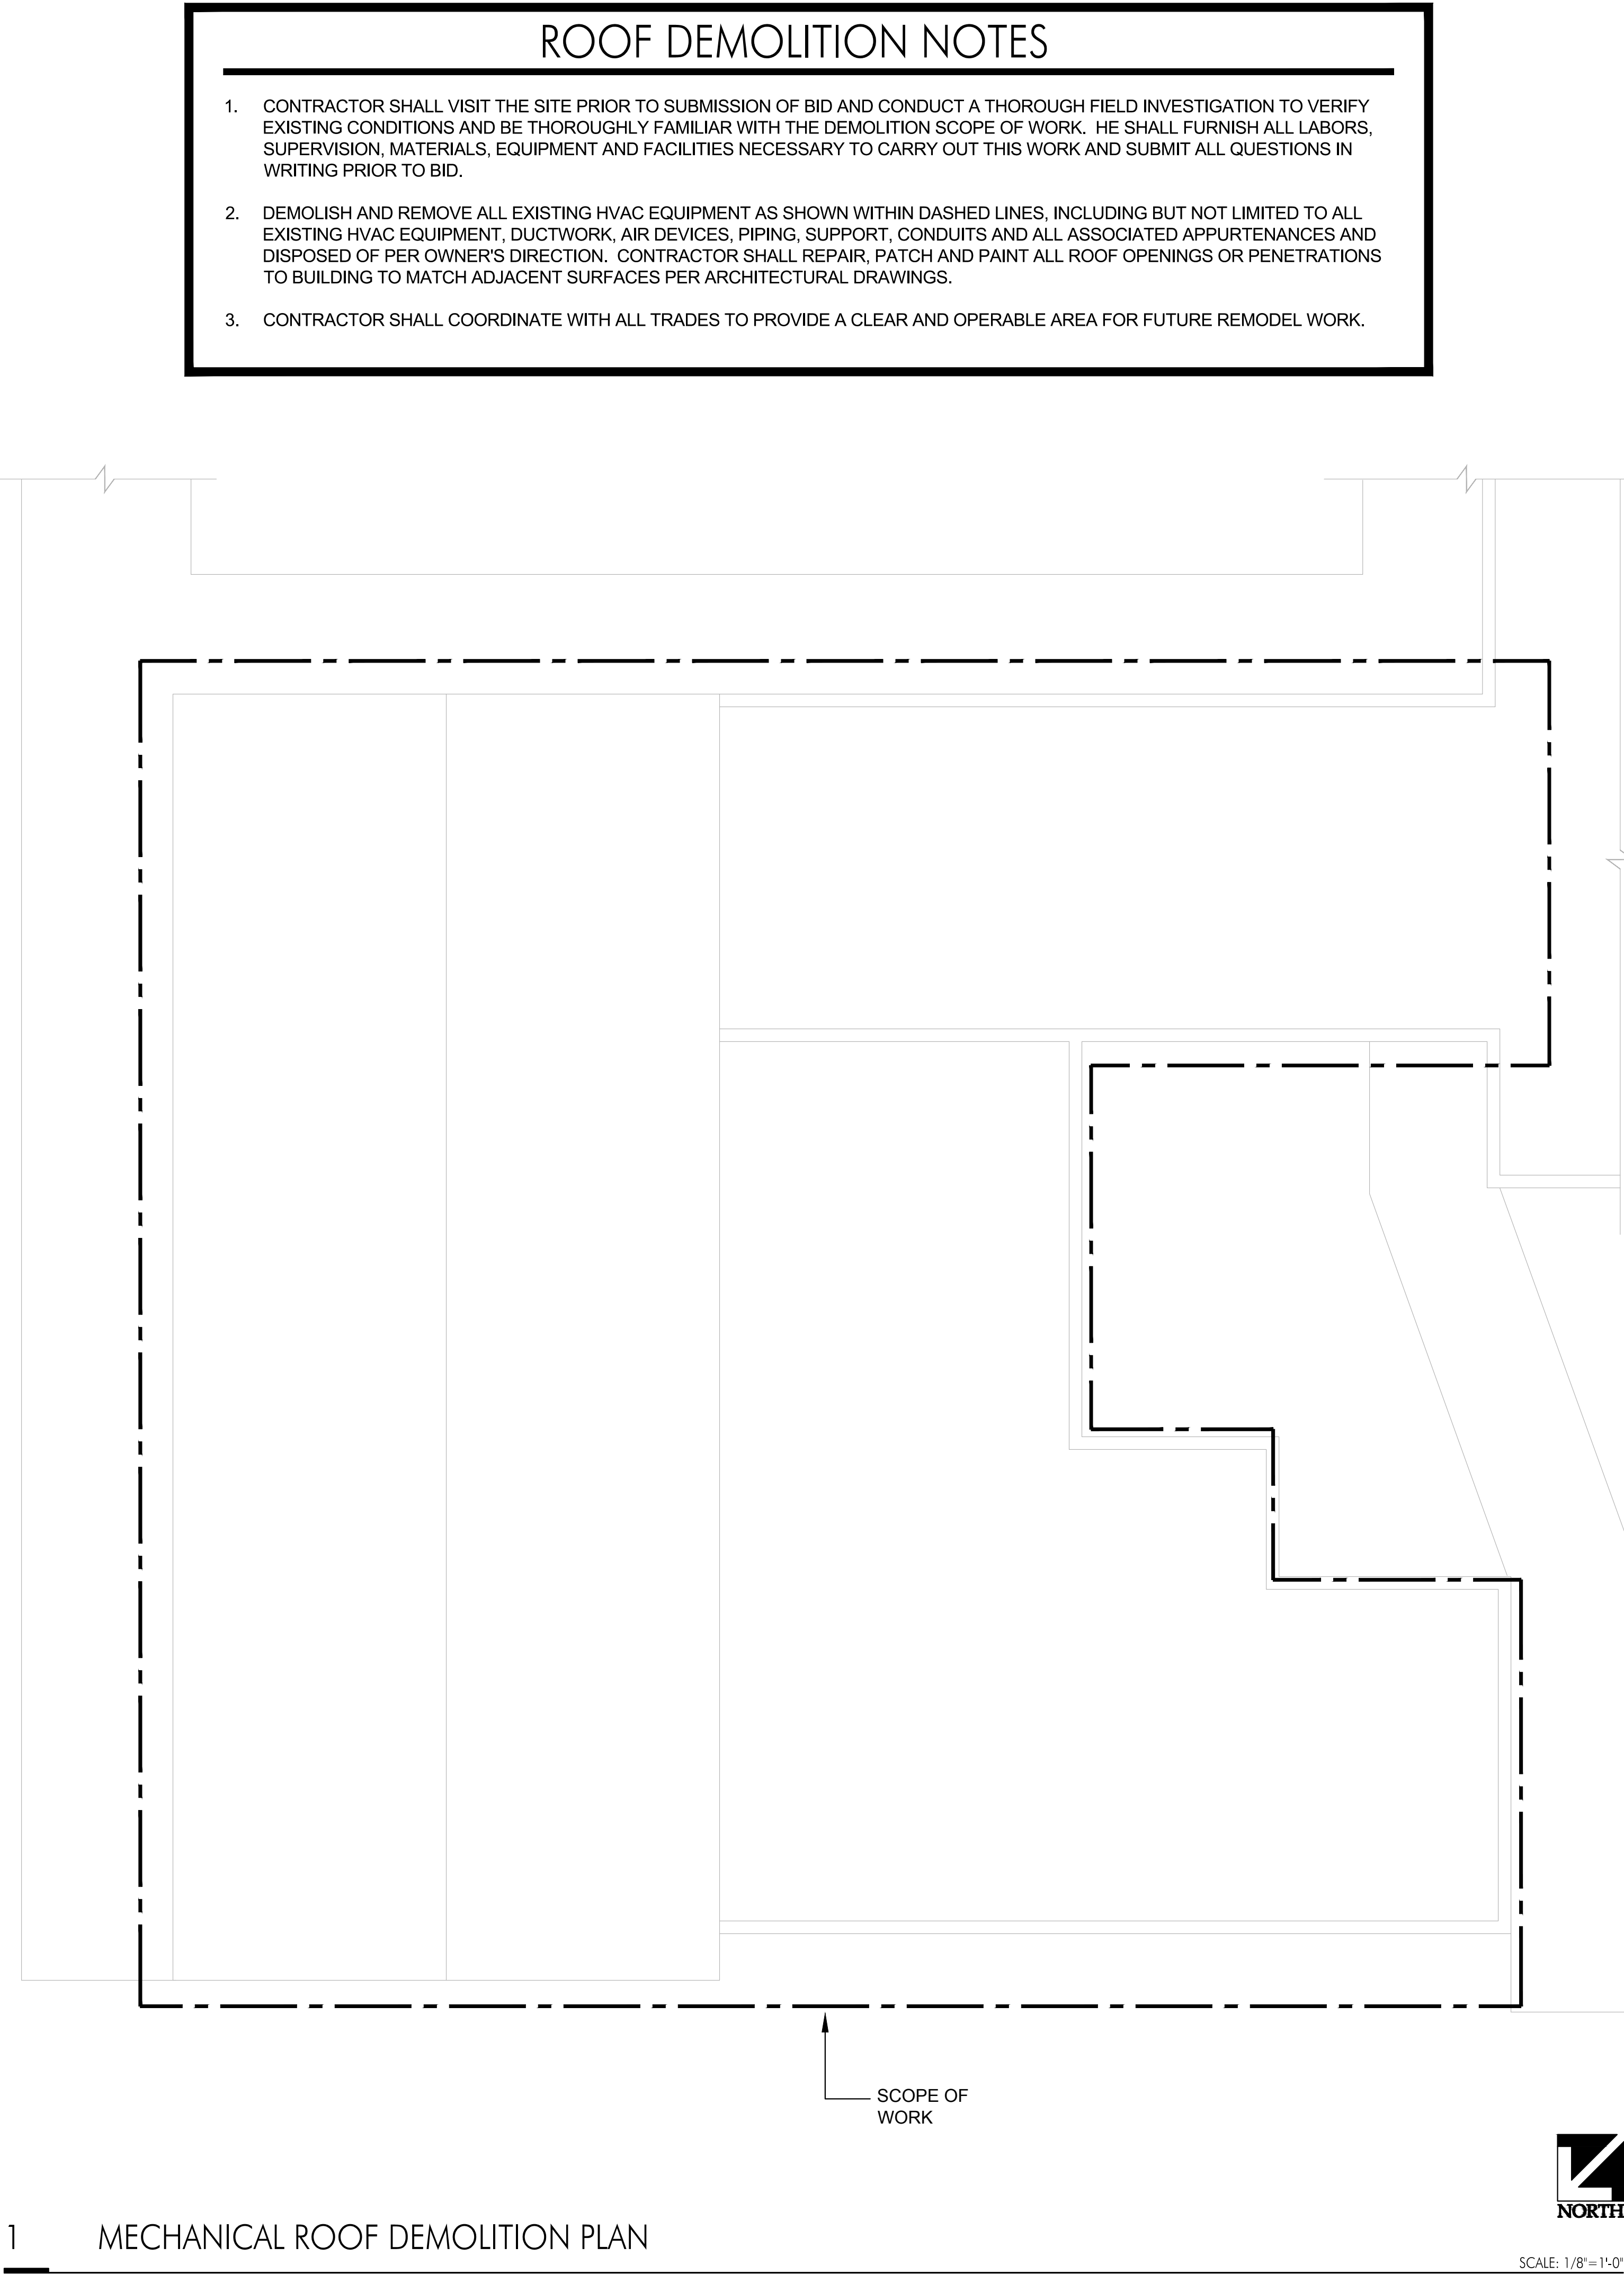Sheet Number

MDD202

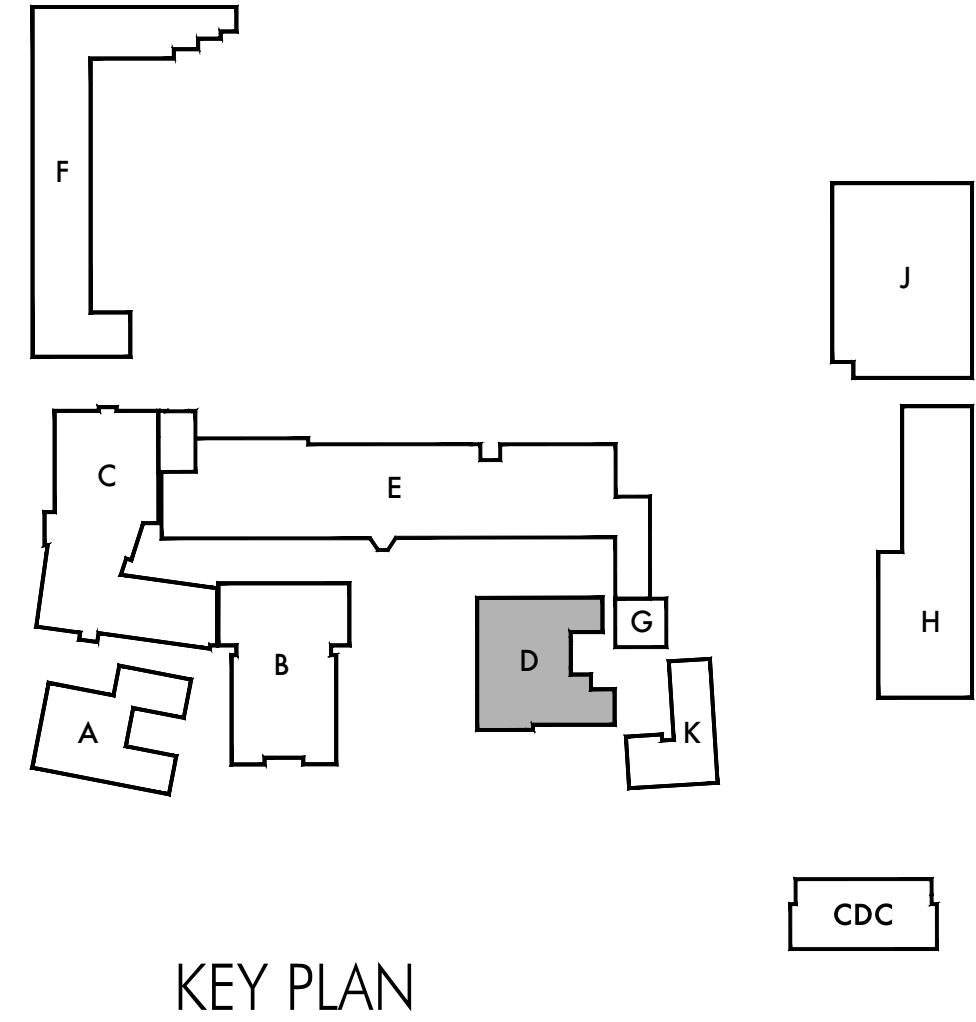
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1 FIRST FLOOR MECHANICAL PLAN - SEGMENT A

KEYNOTES

- 1 PROVIDE BAROMETRIC RELIEF AIR DAMPER. SET DAMPER TO OPEN AT 0.05" PRESSURE.
- 2 3'-4"x3'-6" RETURN AIR PLENUM BELOW FAN COIL UNIT.
- 3 12"x10" OSA INTAKE DUCT W/ 1" LINING DN & CONNECT TO RETURN AIR PLENUM.
- 4 18"x14" SA DUCT W/ 1" LINING DN AND CONNECT TO UNIT'S SUPPLY AIR OPENING. PROVIDE ALL NECESSARY FITTINGS.
- 5 18"x10" SWS PRICE 500, DOUBLE DEFLECTION, 535 CFM (TYP 3.)
- 6 18"x14" SWR, PRICE 500, 575 CFM, (TYP 2.)
- 7 48"x14" OSA INTAKE LOUVER.
- 8 12"x12" OSA INTAKE LOUVER W/ PLENUM.
- 9 48" (L) x 22" (W) x 14" (H) OSA PLENUM.
- 10 44"x16" OSA INTAKE LOUVER.
- 11 44" (L) x 30" (W) x 16" (H) OSA PLENUM.
- 12 WALL MOUNTED FAN COIL UNIT. INSTALL PER MANUFACTURER'S RECOMMENDATIONS. COORDINATE LOCATION W/ ALL OTHER TRADES. ENSURE PROPER ACCESS SPACE FOR MAINTENANCE. FOR MOUNTING DETAIL SEE -JM-. RUN REFRIGERANT LINES TO CORRESPONDING CONDENSER UNIT PER MANUFACTURER RECOMMENDATION.



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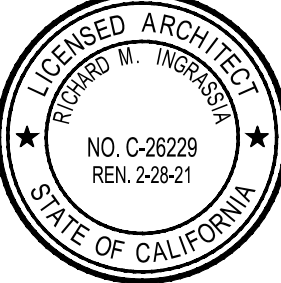
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Lincoln Middle School
1501 California Avenue
Santa Monica, California 90403
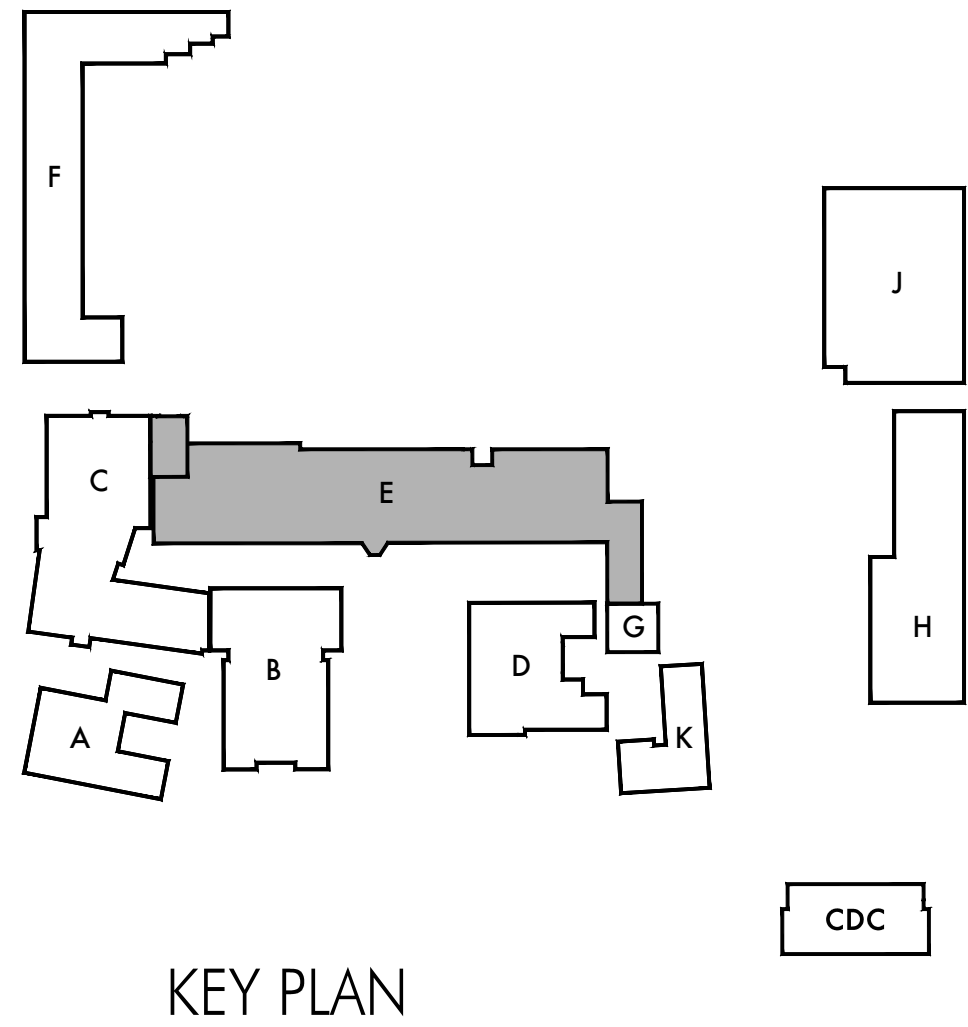
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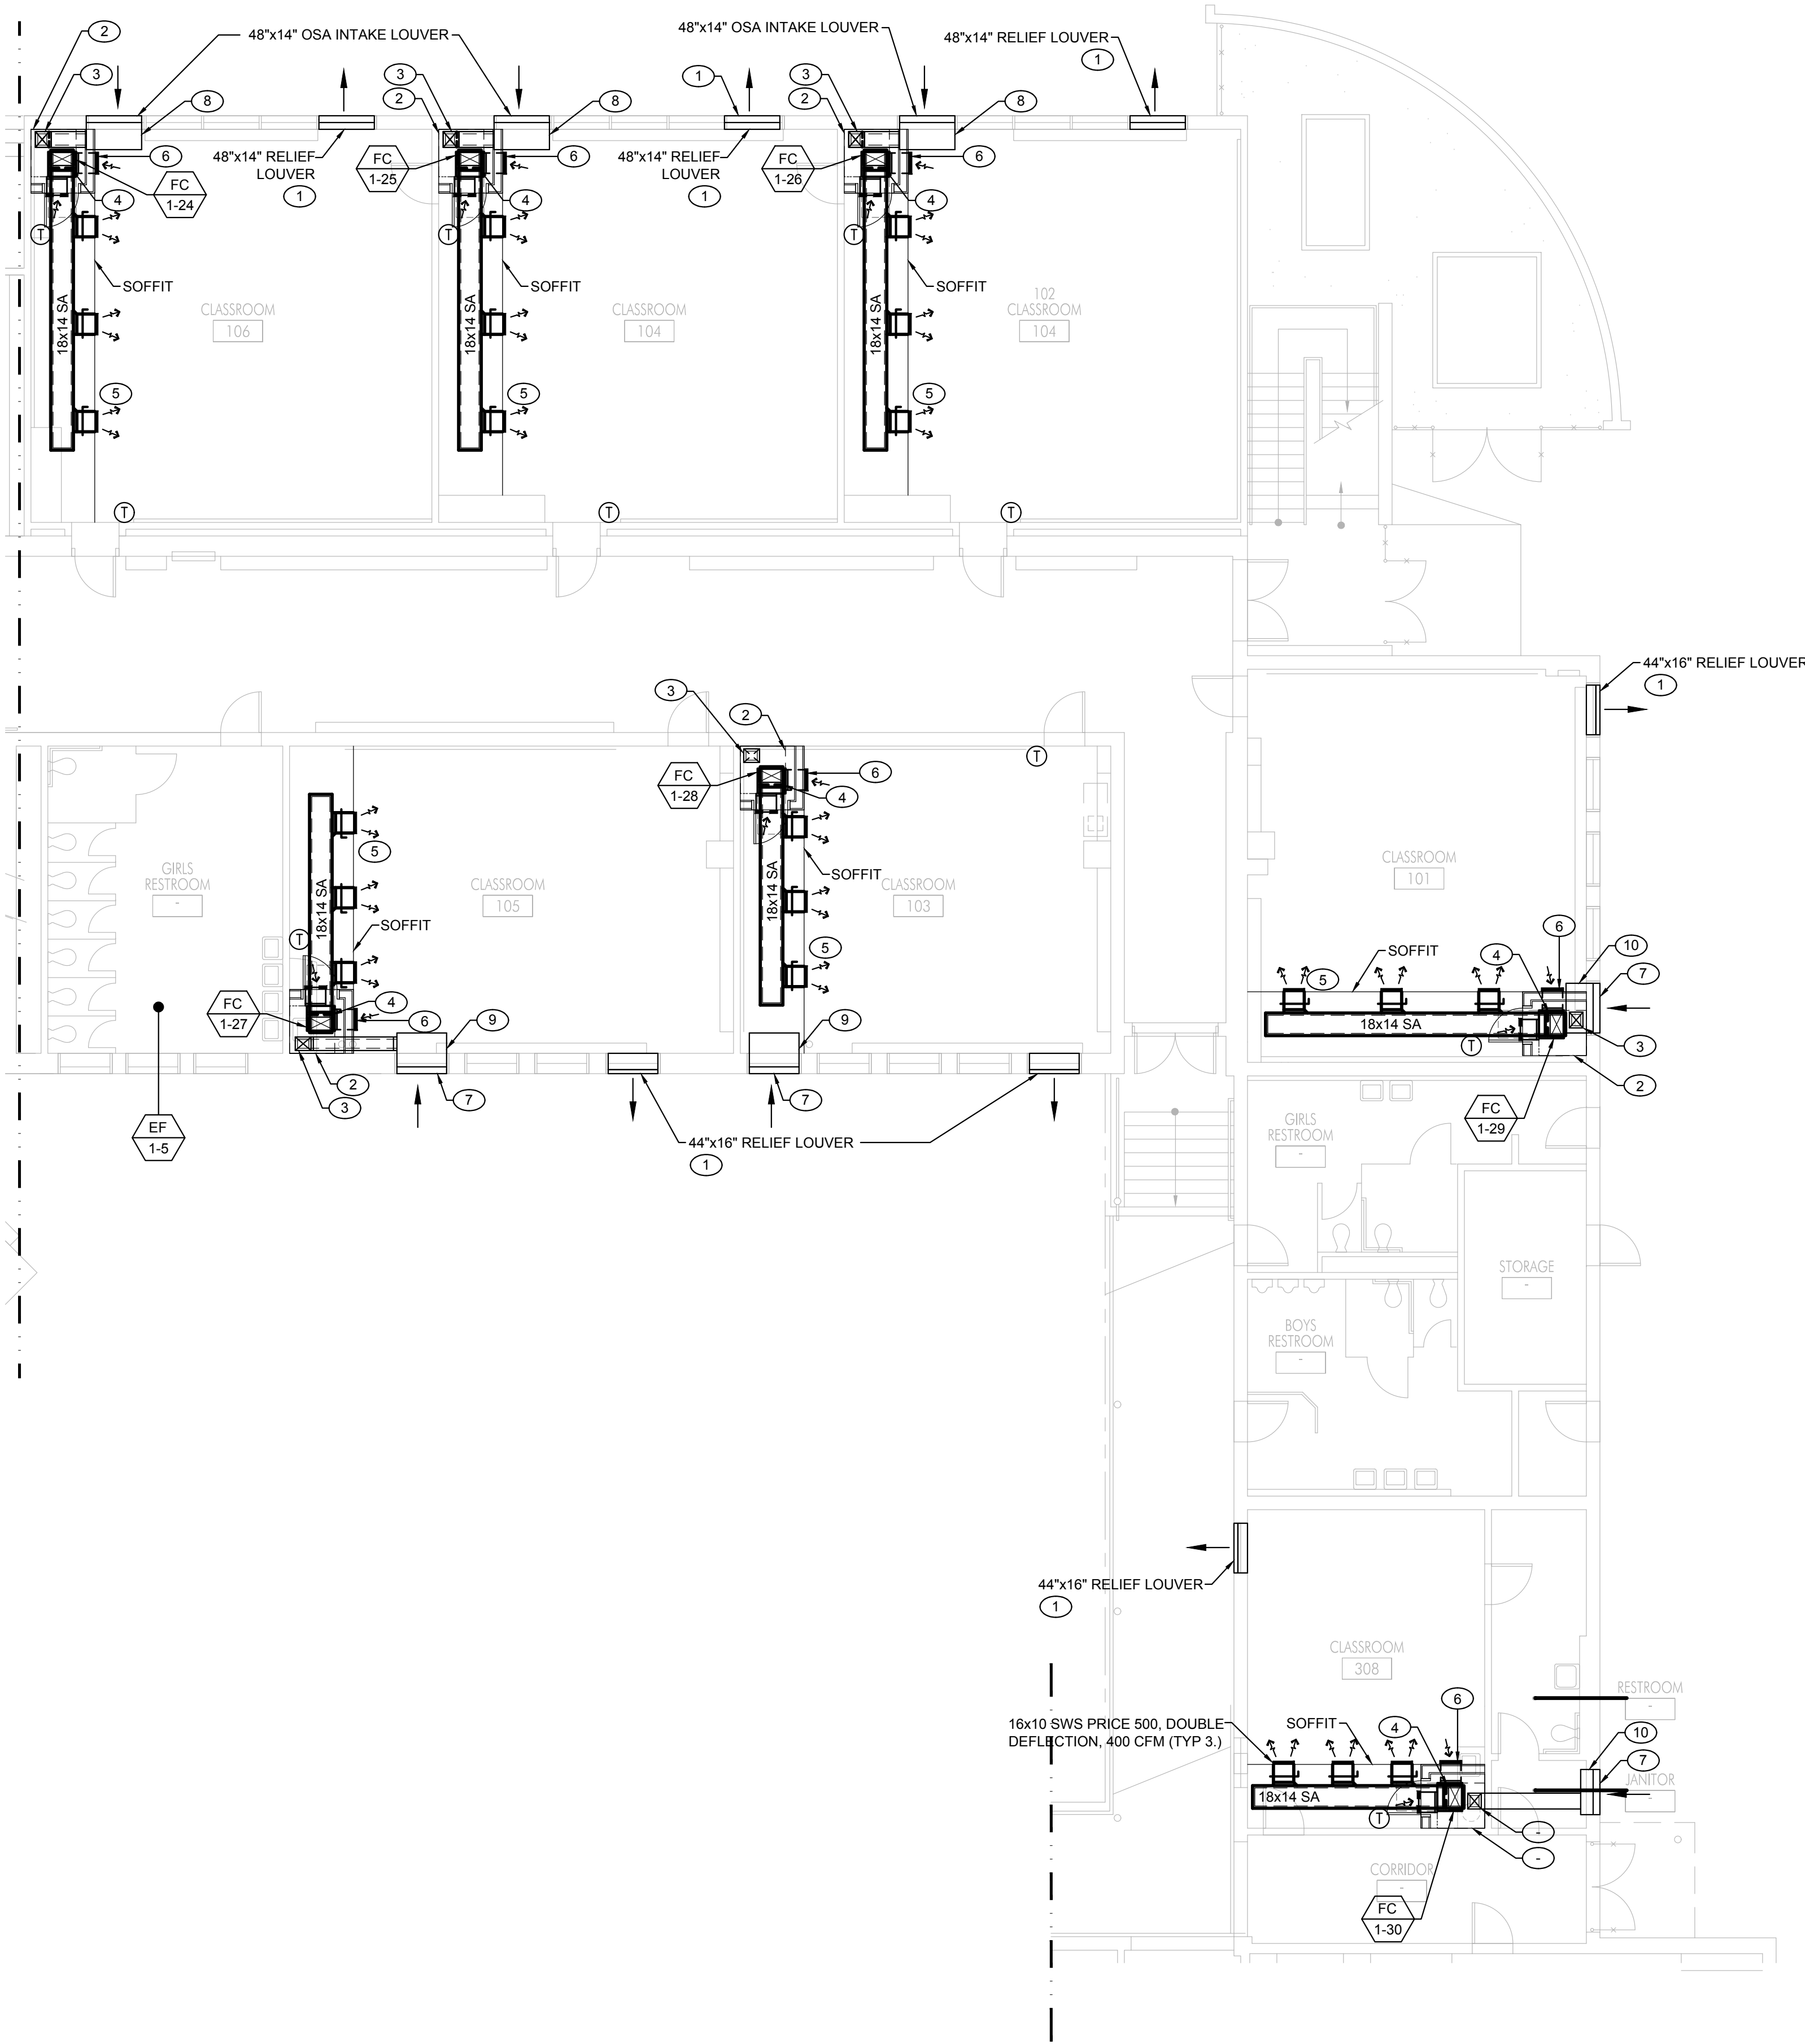
Building 'E'
First Floor
Mechanical Plan
Segment A

Sheet Number


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1 FIRST FLOOR MECHANICAL PLAN - SEGMENT B



SCALE: 1/8"=1'-0"



- KEYNOTES
- 1 PROVIDE BAROMETRIC RELIEF AIR DAMPER. SET DAMPER TO OPEN AT 0.05" PRESSURE.
 - 2 3'-4"x3'-6" RETURN AIR PLENUM BELOW FAN COIL UNIT.
 - 3 12"x10" OSA INTAKE DUCT W/ 1" LINING DN & CONNECT TO RETURN AIR PLENUM.
 - 4 18x14 SA DUCT W/ 1" LINING DN AND CONNECT TO UNIT'S SUPPLY AIR OPENING. PROVIDE ALL NECESSARY FITTINGS.
 - 5 18x10 SWS PRICE 500, DOUBLE DEFLECTION, 535 CFM (TYP 3.)
 - 6 18x14 SWR, PRICE 500, 575 CFM, (TYP 2.)
 - 7 44"x16" OSA INTAKE LOUVER.
 - 8 48" (L) x 24" (W) x 14" (H) OSA PLENUM.
 - 9 44" (L) x 30" (W) x 16" (H) OSA PLENUM.
 - 10 44" (L) x 24" (W) x 16" (H) OSA PLENUM.
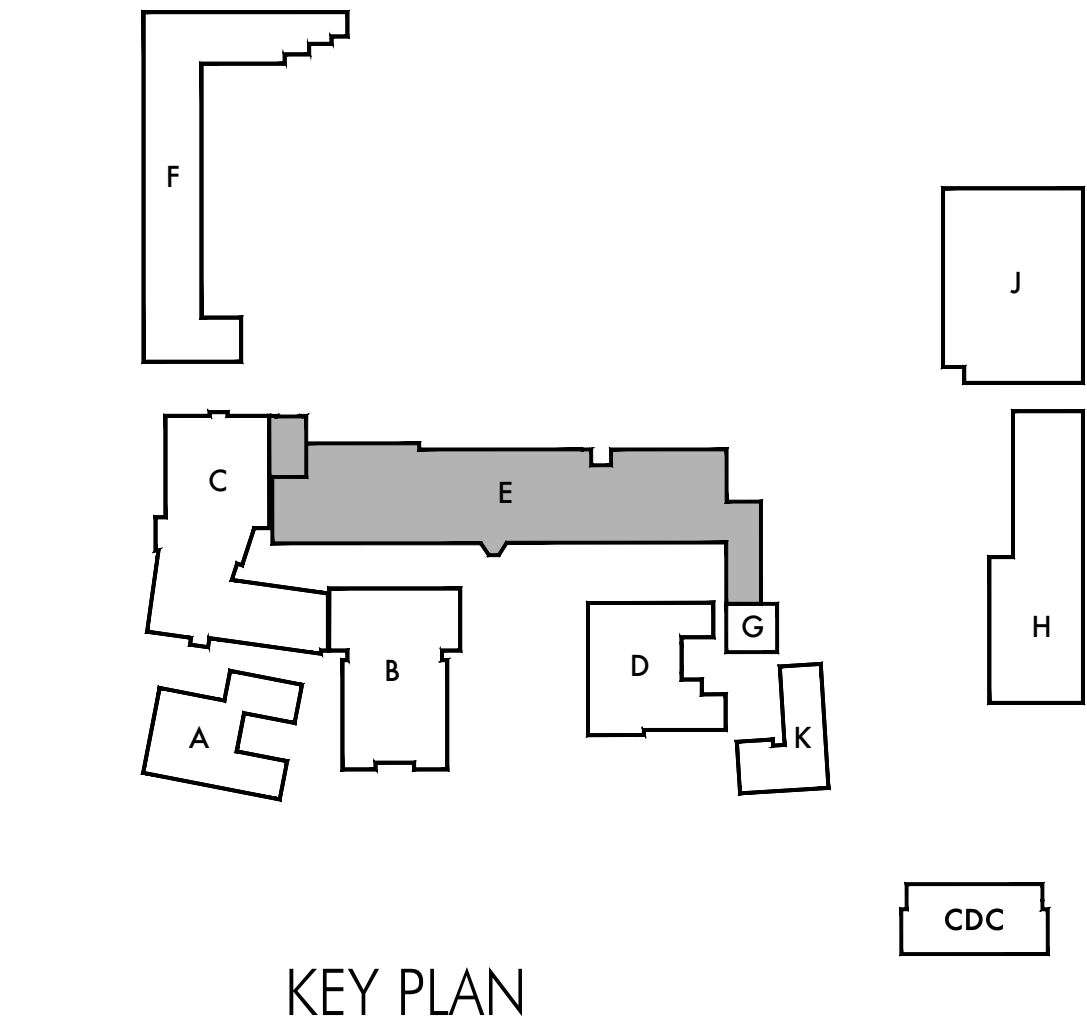
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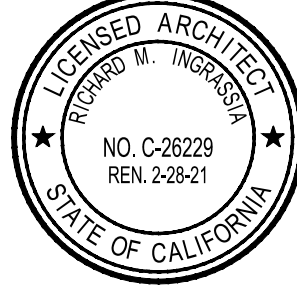
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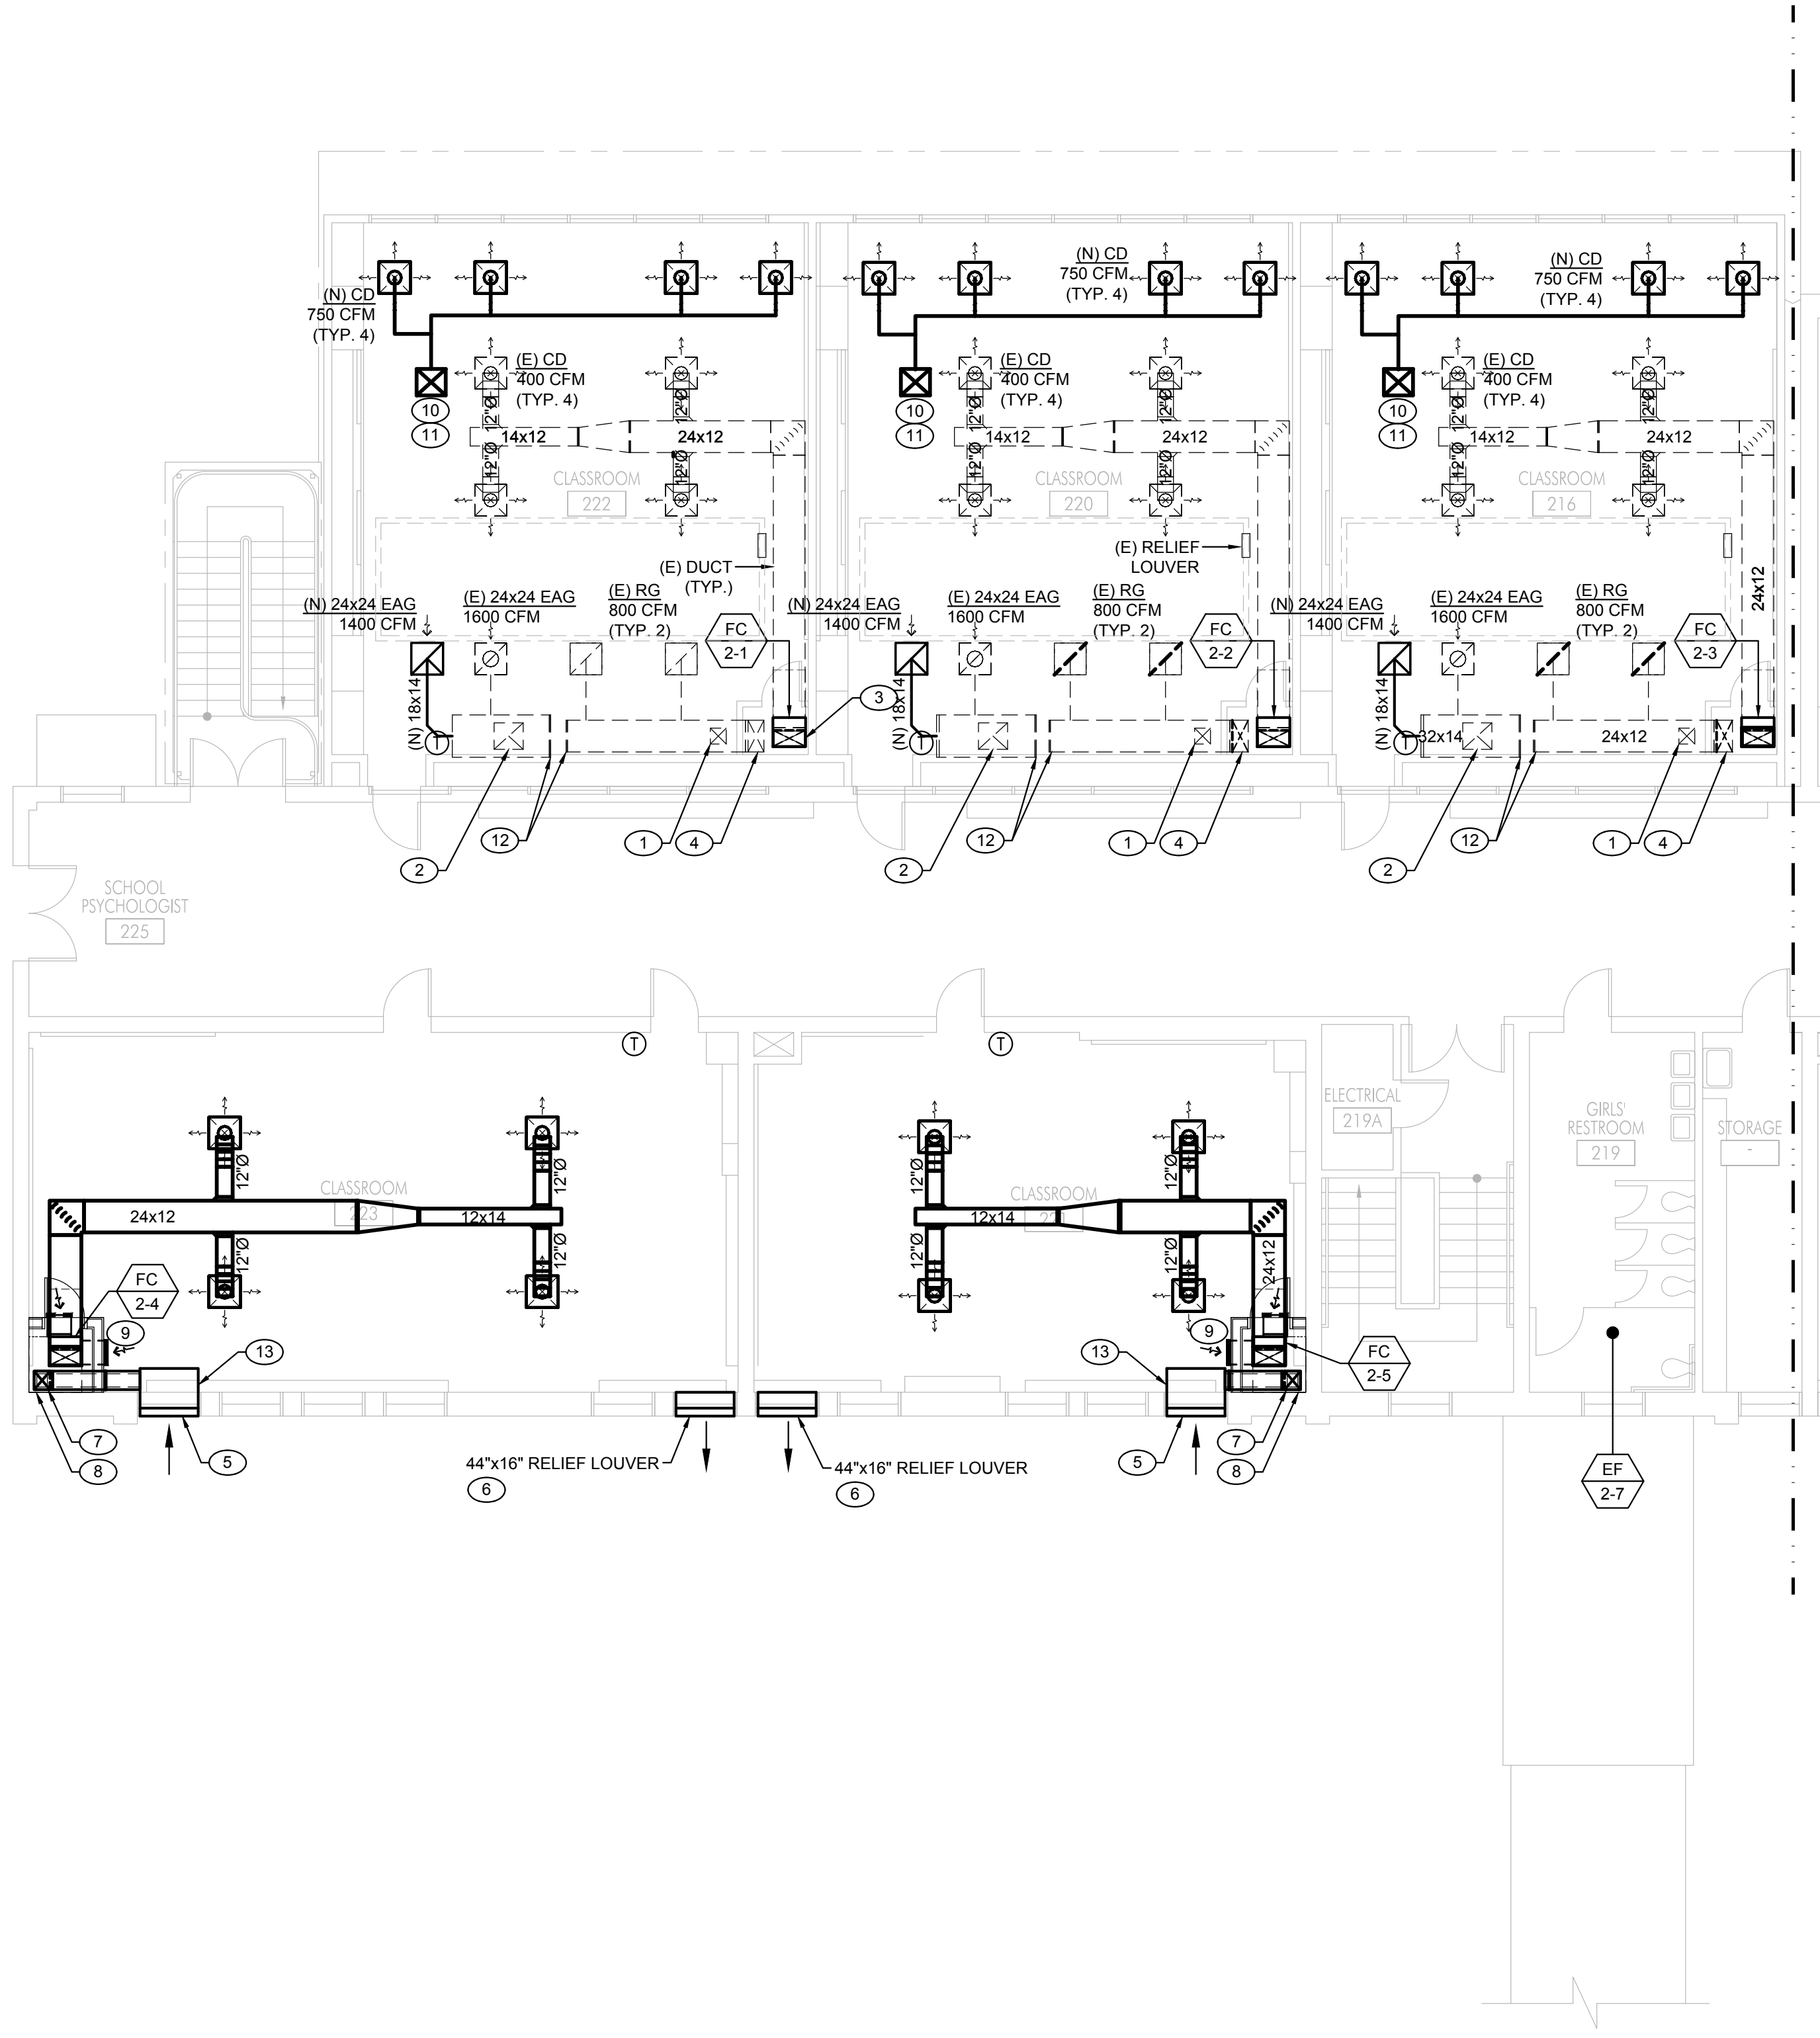
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Building 'E'
First Floor
Mechanical Plan
Segment B


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ME201B

1 SECOND FLOOR MECHANICAL PLAN - SEGMENT A



SCALE: 1/8"=1'-0"

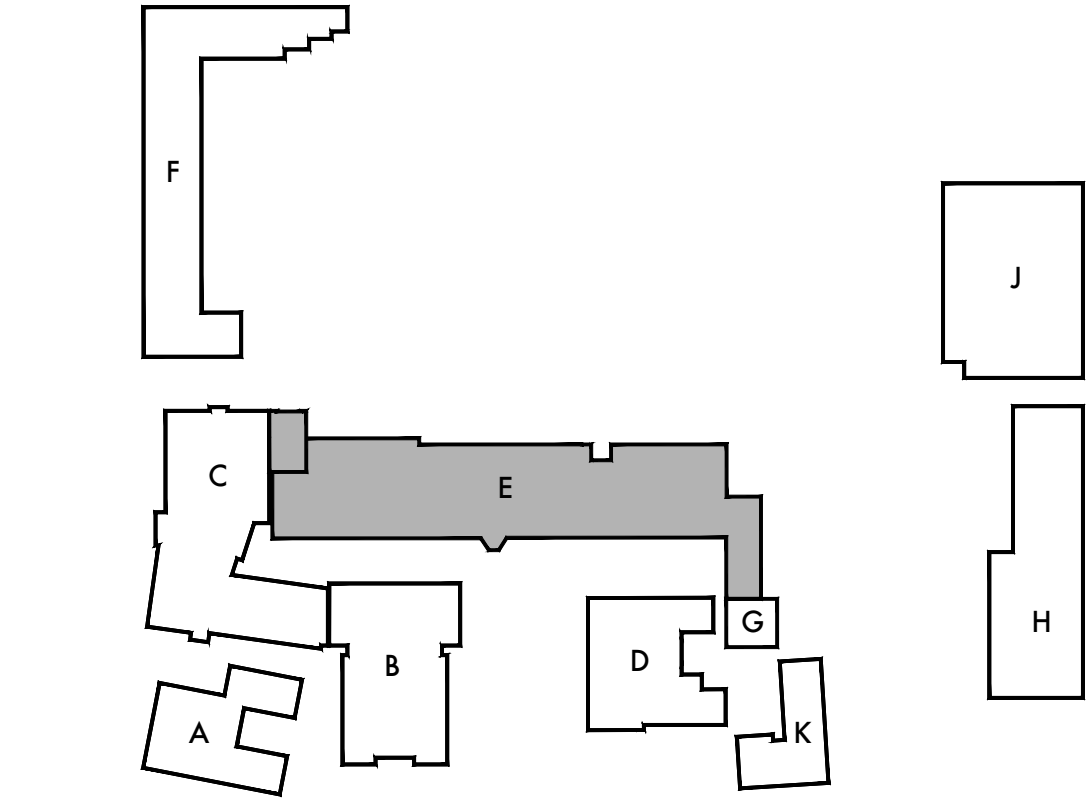

KEY PLAN

- KEYNOTES**
- 1 (E) 12x12 OSA DUCT W/ 1" LINING UP THRU ROOF AND CONNECT TO (N) GRAVITY INTAKE VENTILATOR. PROVIDE DUCT FITTING AS NEEDED.
 - 2 (E) 22x20 EA DUCT UP THRU ROOF & CONNECT TO (N) EXHAUST FAN. PROVIDE DUCT FITTING AS NEEDED.
 - 3 24x12 SA DUCT W/ 1" LINING DN AND CONNECT TO UNIT'S SUPPLY AIR OPENING. PROVIDE ALL NECESSARY FITTINGS.
 - 4 24x12 RA DUCT W/ 1" LINING DN & CONNECT TO RETURN AIR PLENUM.
 - 5 44"x16" OSA INTAKE LOUVER.
 - 6 PROVIDE BAROMETRIC RELIEF AIR DAMPER. SET DAMPER TO OPEN AT 0.05" PRESSURE.
 - 7 12"x10" OSA INTAKE DUCT W/ 1" LINING DN & CONNECT TO RETURN AIR PLENUM.
 - 8 3'-4"x3'-6" RETURN AIR PLENUM BELOW FAN COIL UNIT.
 - 9 18x14 SWR, PRICE 500, 575 CFM, (TYP. 2.)
 - 10 22"x20" MAKE-UP AIR DUCT UP THRU ROOF.
 - 11 PROVIDE 1" DUCT LINER THROUGHOUT.
 - 12 PROVIDE CAP.
 - 13 44" (L) x 30" (W) x 16" (H) OSA PLENUM.

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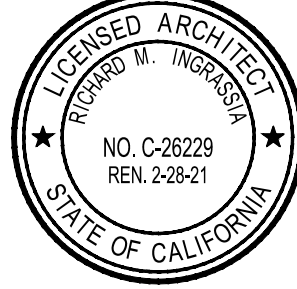
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Building 'E'
Second Floor
Mechanical Plan
Segment A

Sheet Number

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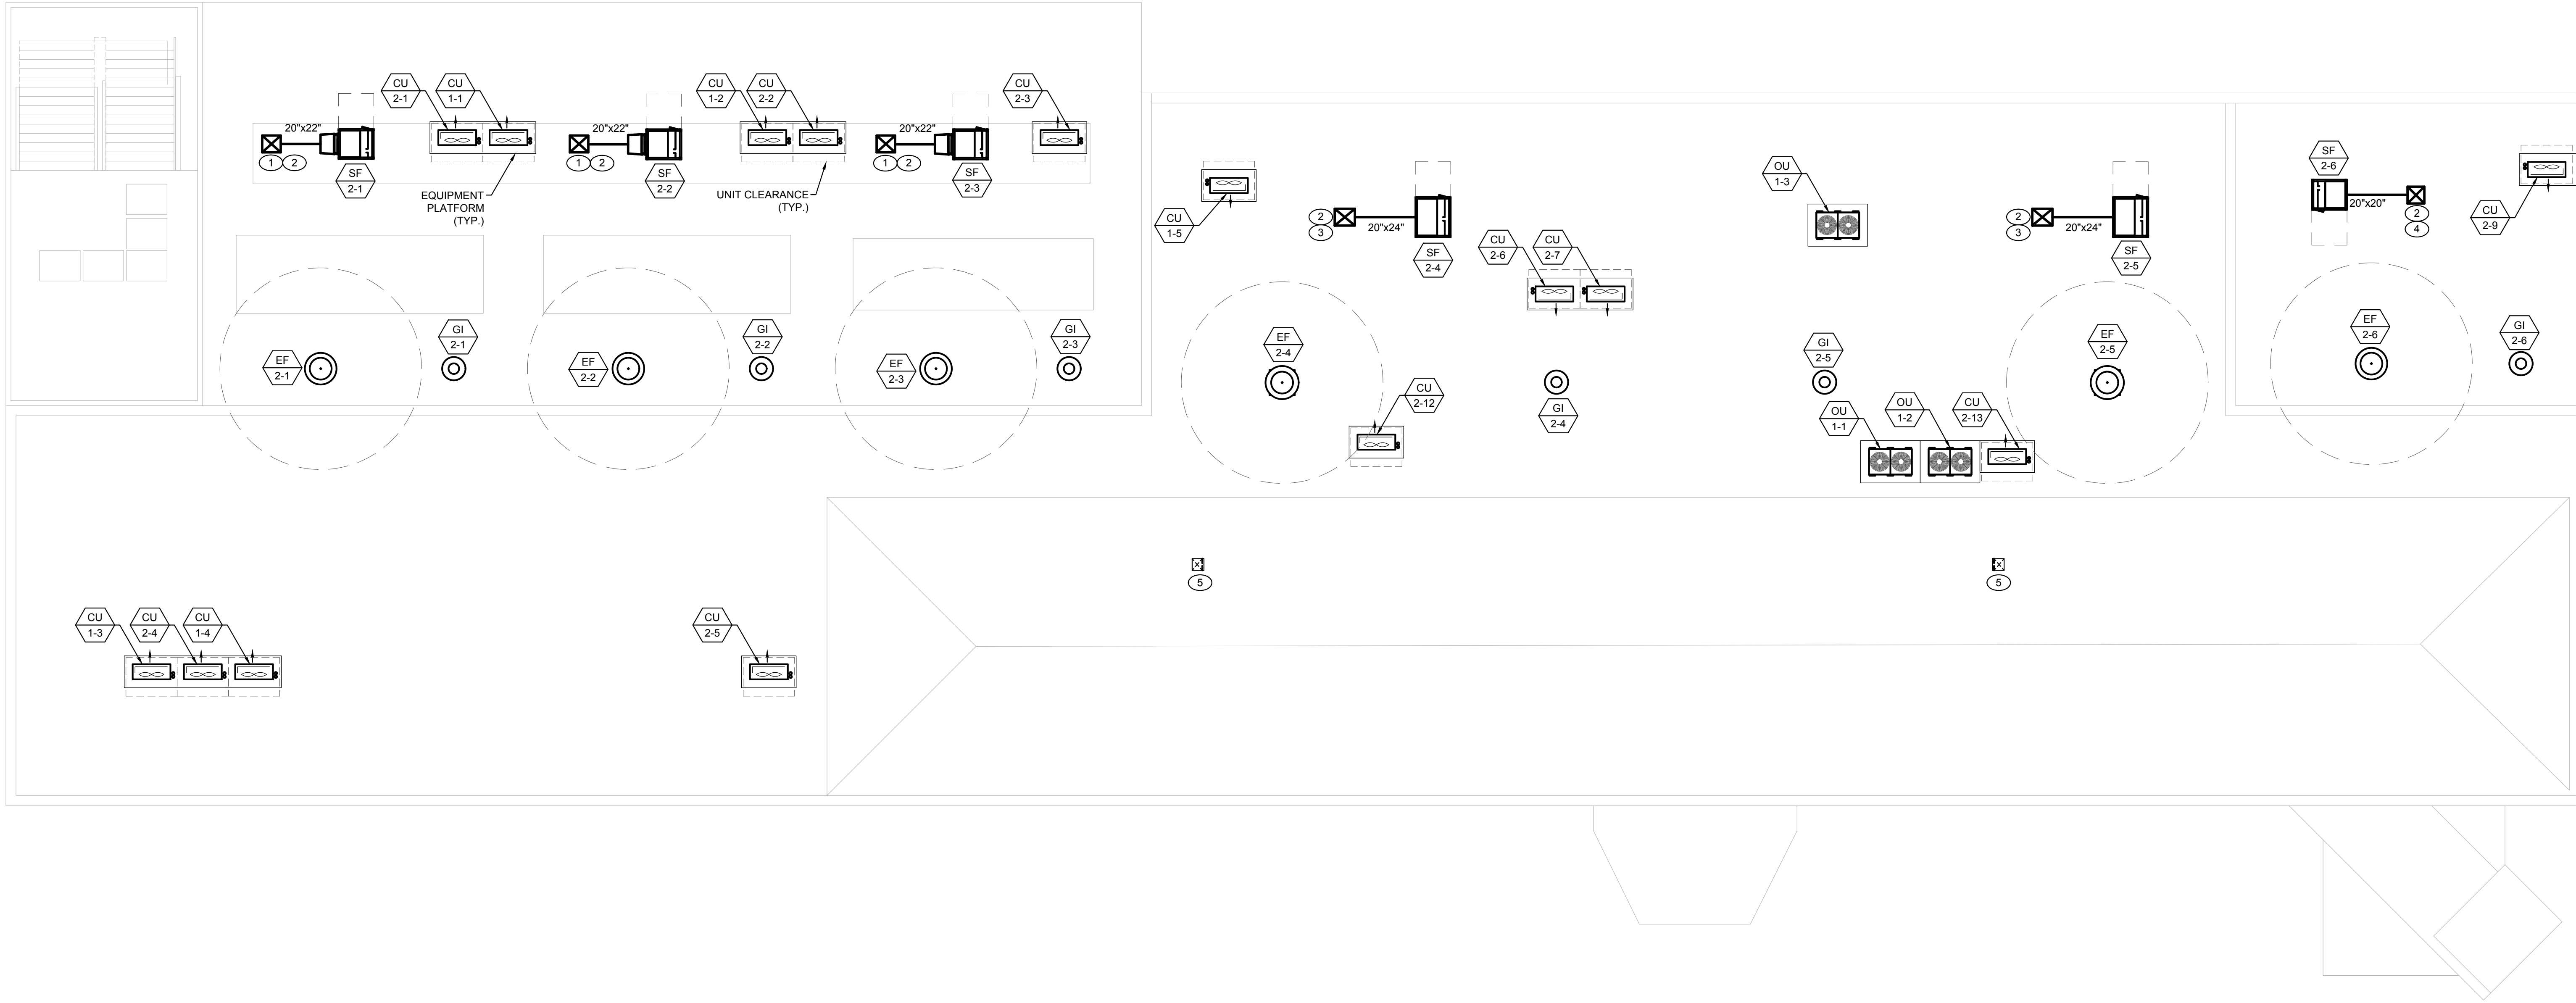
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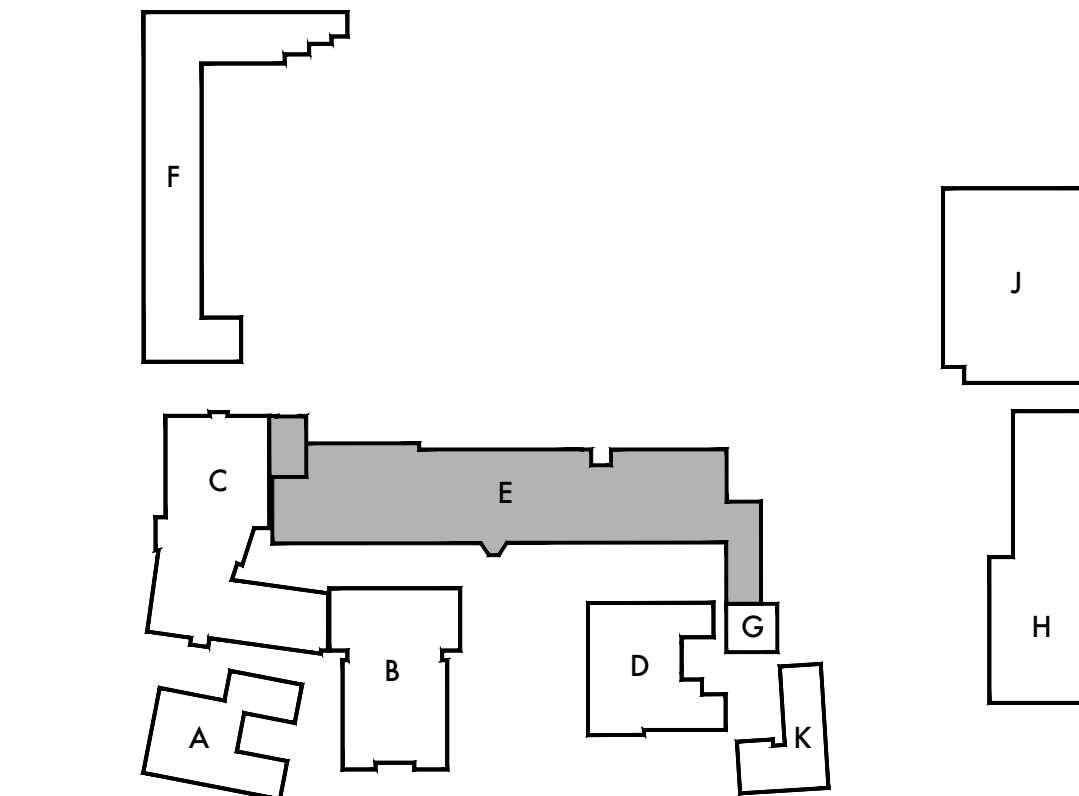
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1 MECHANICAL ROOF PLAN - SEGMENT A



SCALE: 1/8"=1'-0"



KEY PLAN

KEYNOTES

- 1 22"x20" MAKE-UP AIR DUCT DN THRU ROOF.
- 2 PROVIDE 1" DUCT LINER THROUGHOUT.
- 3 24"x20" MAKE-UP AIR DUCT DN THRU ROOF.
- 4 20"x20" MAKE-UP AIR DUCT DN THRU ROOF.
- 5 12"x10" OSA DUCT W/ 1" LINING DN THRU ROOF & CONNECT TO RETURN AIR PLENUM. PROVIDE ROOF JACK WITH WIRE MESH SCREEN.

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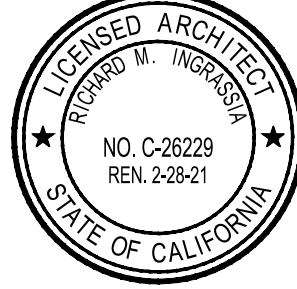
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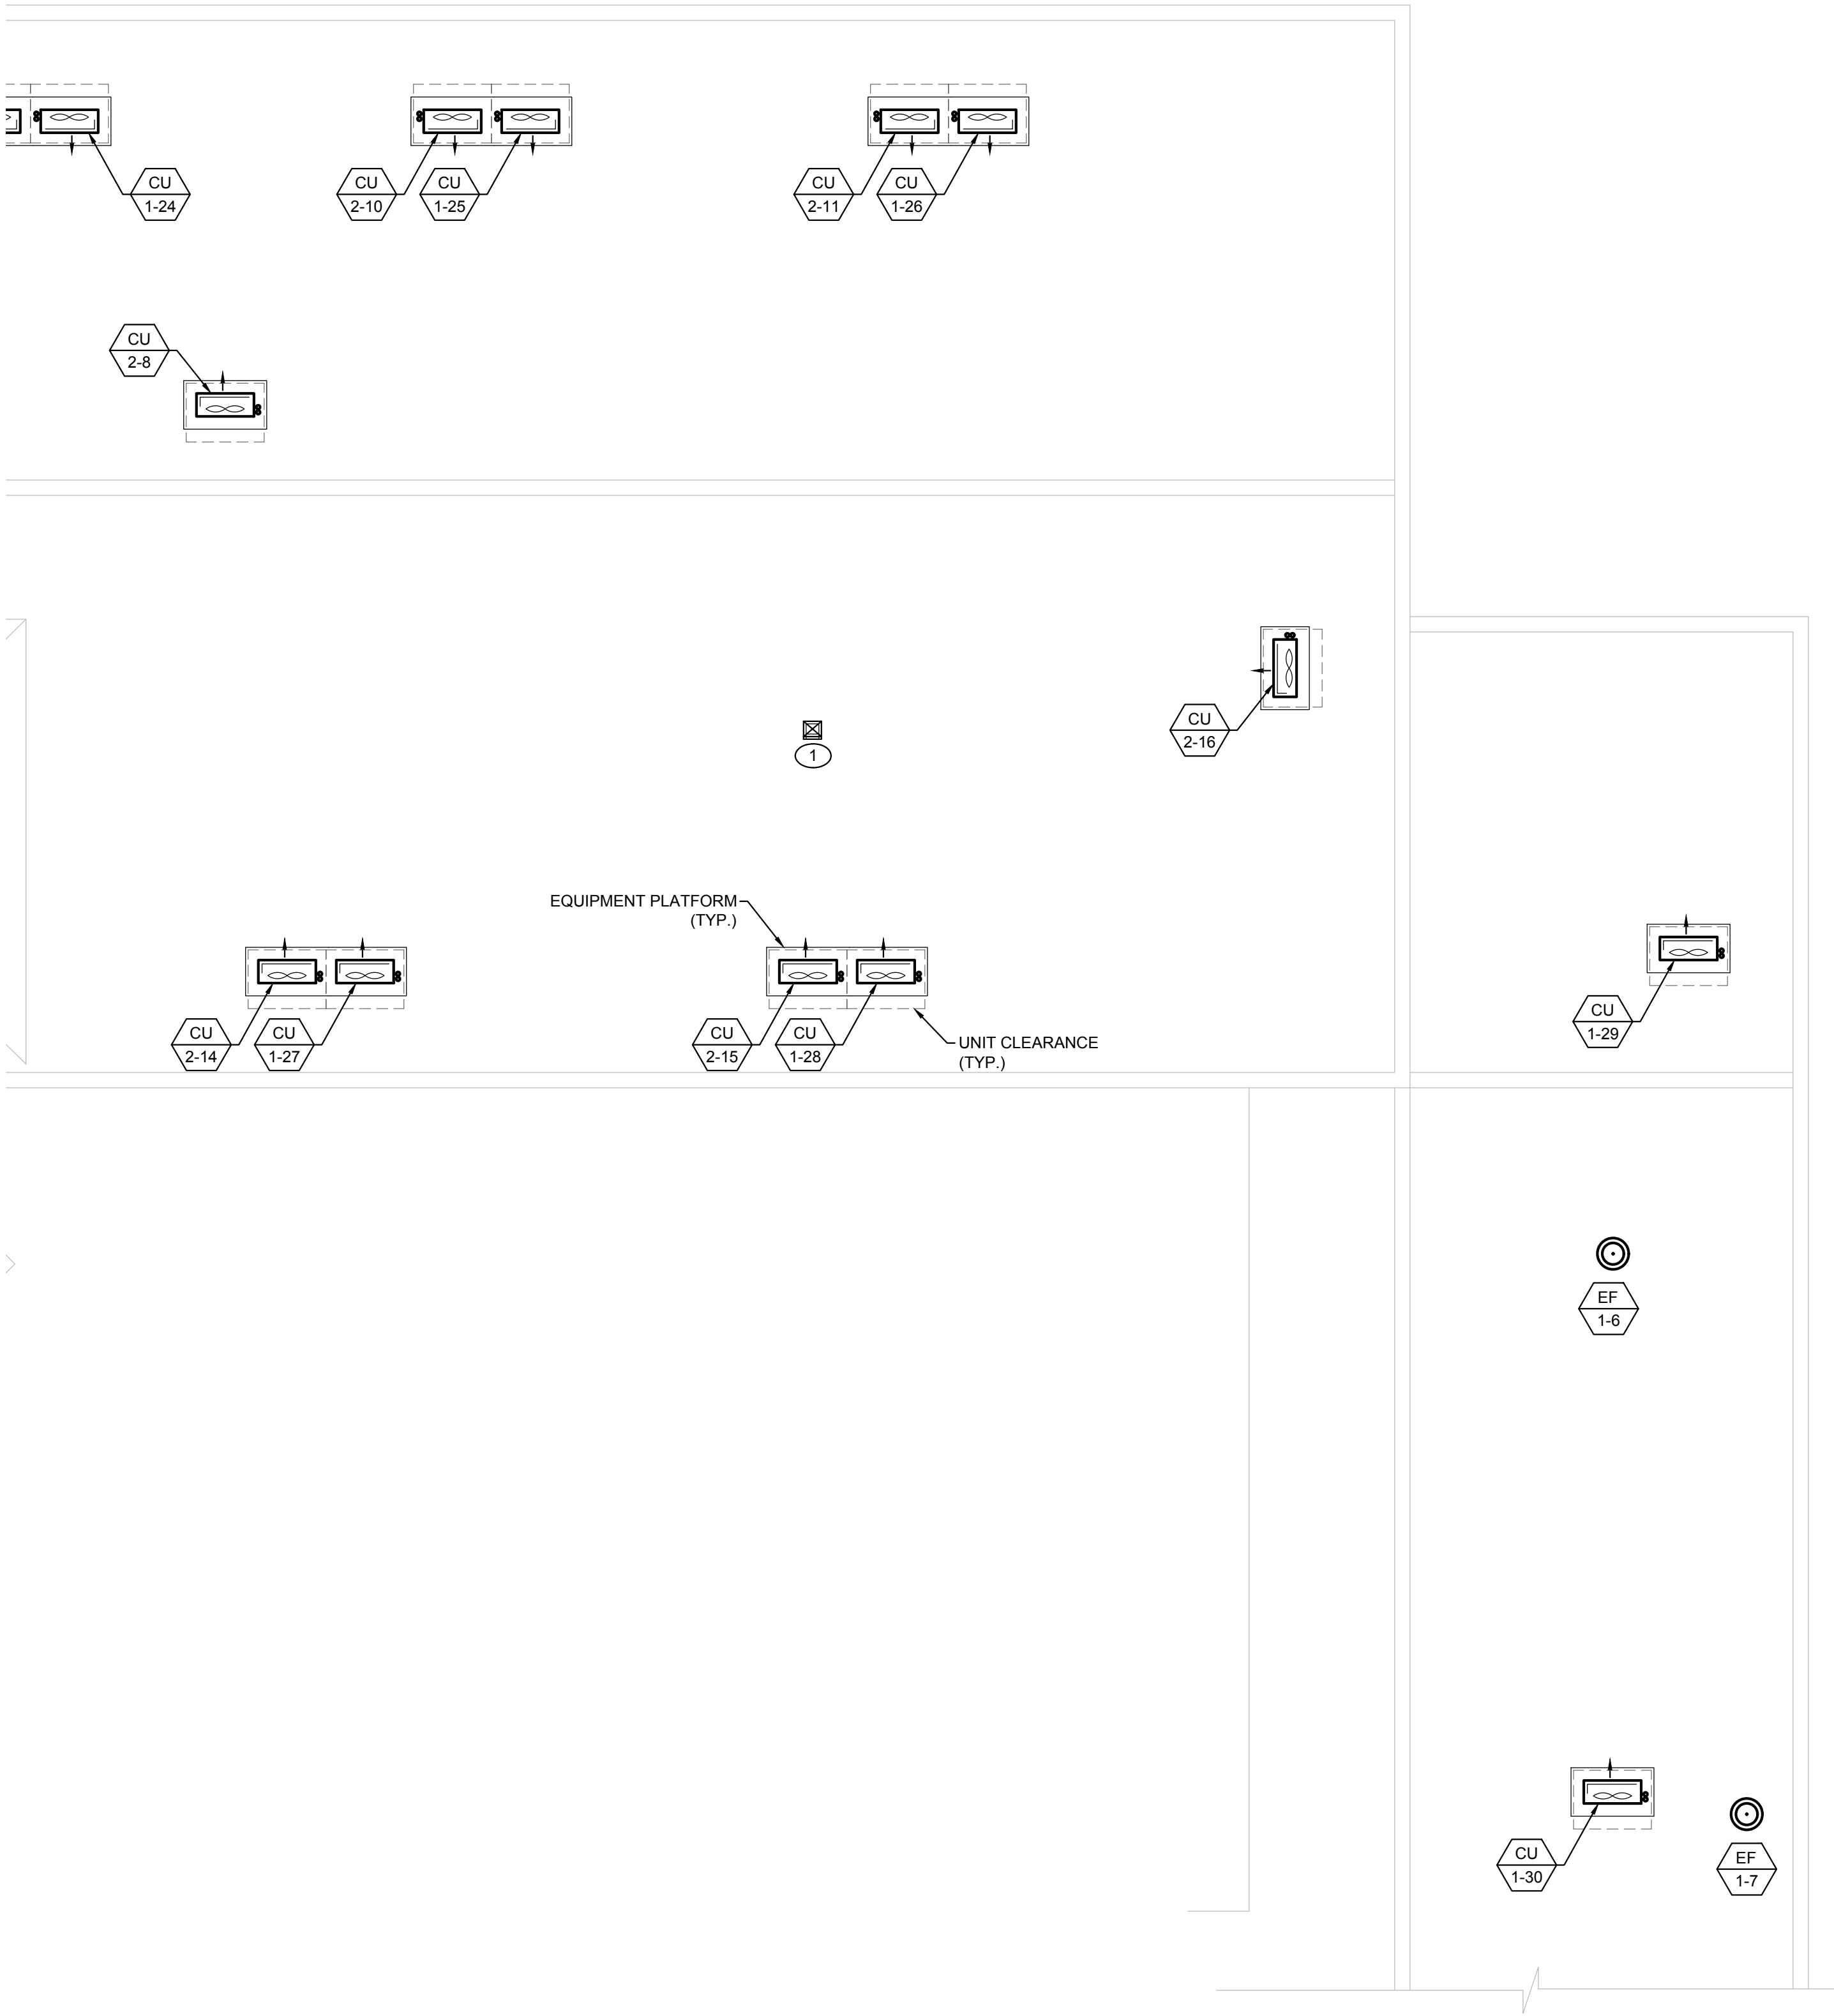
Sheet Title
Building 'E'
Mechanical
Roof Plan
Segment A

Sheet Number

ME203A

Plot Date: 11/15/2019 2:13:17 PM Login: Min_Zow Last Save By: mazow S:\MUSD - Lincoln MS Modernization\Sheet\Mechanical\19009_ME203B.dwg

1 MECHANICAL ROOF PLAN - SEGMENT B



SCALE: 1/8"=1'-0"

KEYNOTES

- 1 12"x10" OSA DUCT W/ 1" LINING DN THRU ROOF & CONNECT TO RETURN AIR PLENUM. PROVIDE ROOF JACK WITH WIRE MESH SCREEN.

DSA Stamp

Architect




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Lincoln Middle School HVAC Replacement Project
Lincoln Middle School
1501 California Avenue
Santa Monica, California 90403

Rev	Date	Issue
1	07.22.19	-

Date:
Scale: As Shown
Drawn By: DH, RM
Checked By: RI

Architect / Engineer Stamp

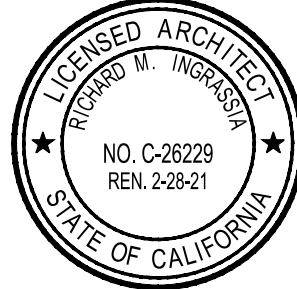


Consultants



Sheet Title
Building 'E'
Mechanical
Roof Plan
Segment B

Sheet Number

ME203B

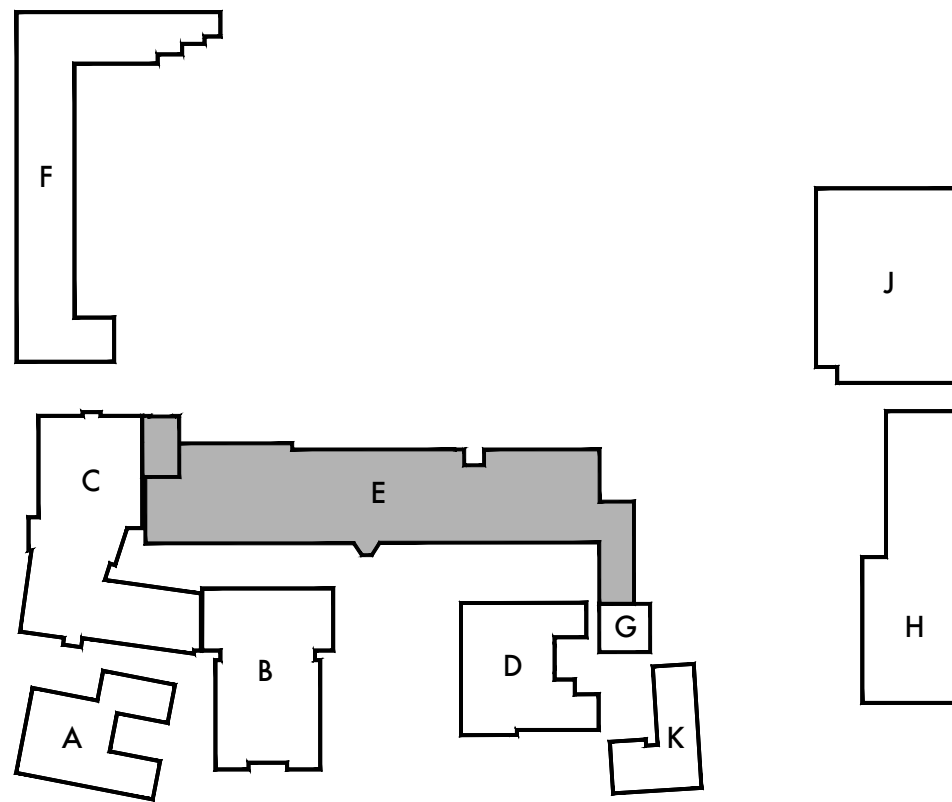

KEY PLAN


1 BASEMENT MECHANICAL DEMOLITION PLAN

DEMOLITION GENERAL NOTES


1. CONTRACTOR SHALL VISIT THE SITE PRIOR TO SUBMISSION OF BID AND CONDUCT A THOROUGH FIELD INVESTIGATION TO VERIFY EXISTING CONDITIONS AND BE THOROUGHLY FAMILIAR WITH THE DEMOLITION SCOPE OF WORK. HE SHALL FURNISH ALL LABORS, SUPERVISION, MATERIALS, EQUIPMENT AND FACILITIES NECESSARY TO CARRY OUT THIS WORK AND SUBMIT ALL QUESTIONS IN WRITING PRIOR TO BID.
2. CONTRACTOR SHALL REPAIR, PATCH AND SEAL ALL UNUSED OR DAMAGED WALL AND ROOF OPENINGS/ PENETRATIONS TO BUILDING CAUSED BY DEMOLITION OF EQUIPMENT, PIPING, DUCTWORK, SUPPORTS, ETC.
3. ALL DAMAGED, BROKEN OR INOPERABLE AIR DEVICES OR DAMPERS SHALL BE REPLACED BY CONTRACTOR WITH NEW LIKE SIZED COMPONENTS OR AIR DEVICES. CONTRACTOR SHALL CONDUCT A THOROUGH FIELD INVESTIGATION TO VERIFY EXISTING CONDITIONS PRIOR TO BIDDING. SUBMIT ALL QUESTIONS IN WRITING PRIOR TO BID.
4. FIRE PROTECTION DURING DEMOLITION / CONSTRUCTION SHALL BE IN ACCORDANCE WITH 2016 CBC, CHAPTER 33.

DEMOLITION KEYNOTES

- 1
- REMOVE (E) HEATING SYSTEM IN THE BASEMENT AND ALL RELATED EQUIPMENT, PIPING, PUMPS, PIPE DISTRIBUTION, PIPING SUPPORTS, ELECTRICAL AND CONTROLS. PATCH AND REPAIR EXISTING WALLS, FLOORS, CEILING, ETC AS NEEDED TO MATCH EXISTING. VERIFY WITH THE DISTRICT AND OBTAIN AUTHORIZATION PRIOR TO REMOVAL AND DEMOLITION WORK. DISTRICT TO SALVAGE PARTS OF THE FURNACES SUCH AS BURNERS, ETC. PRIOR TO ANY DEMOLITION WORK.

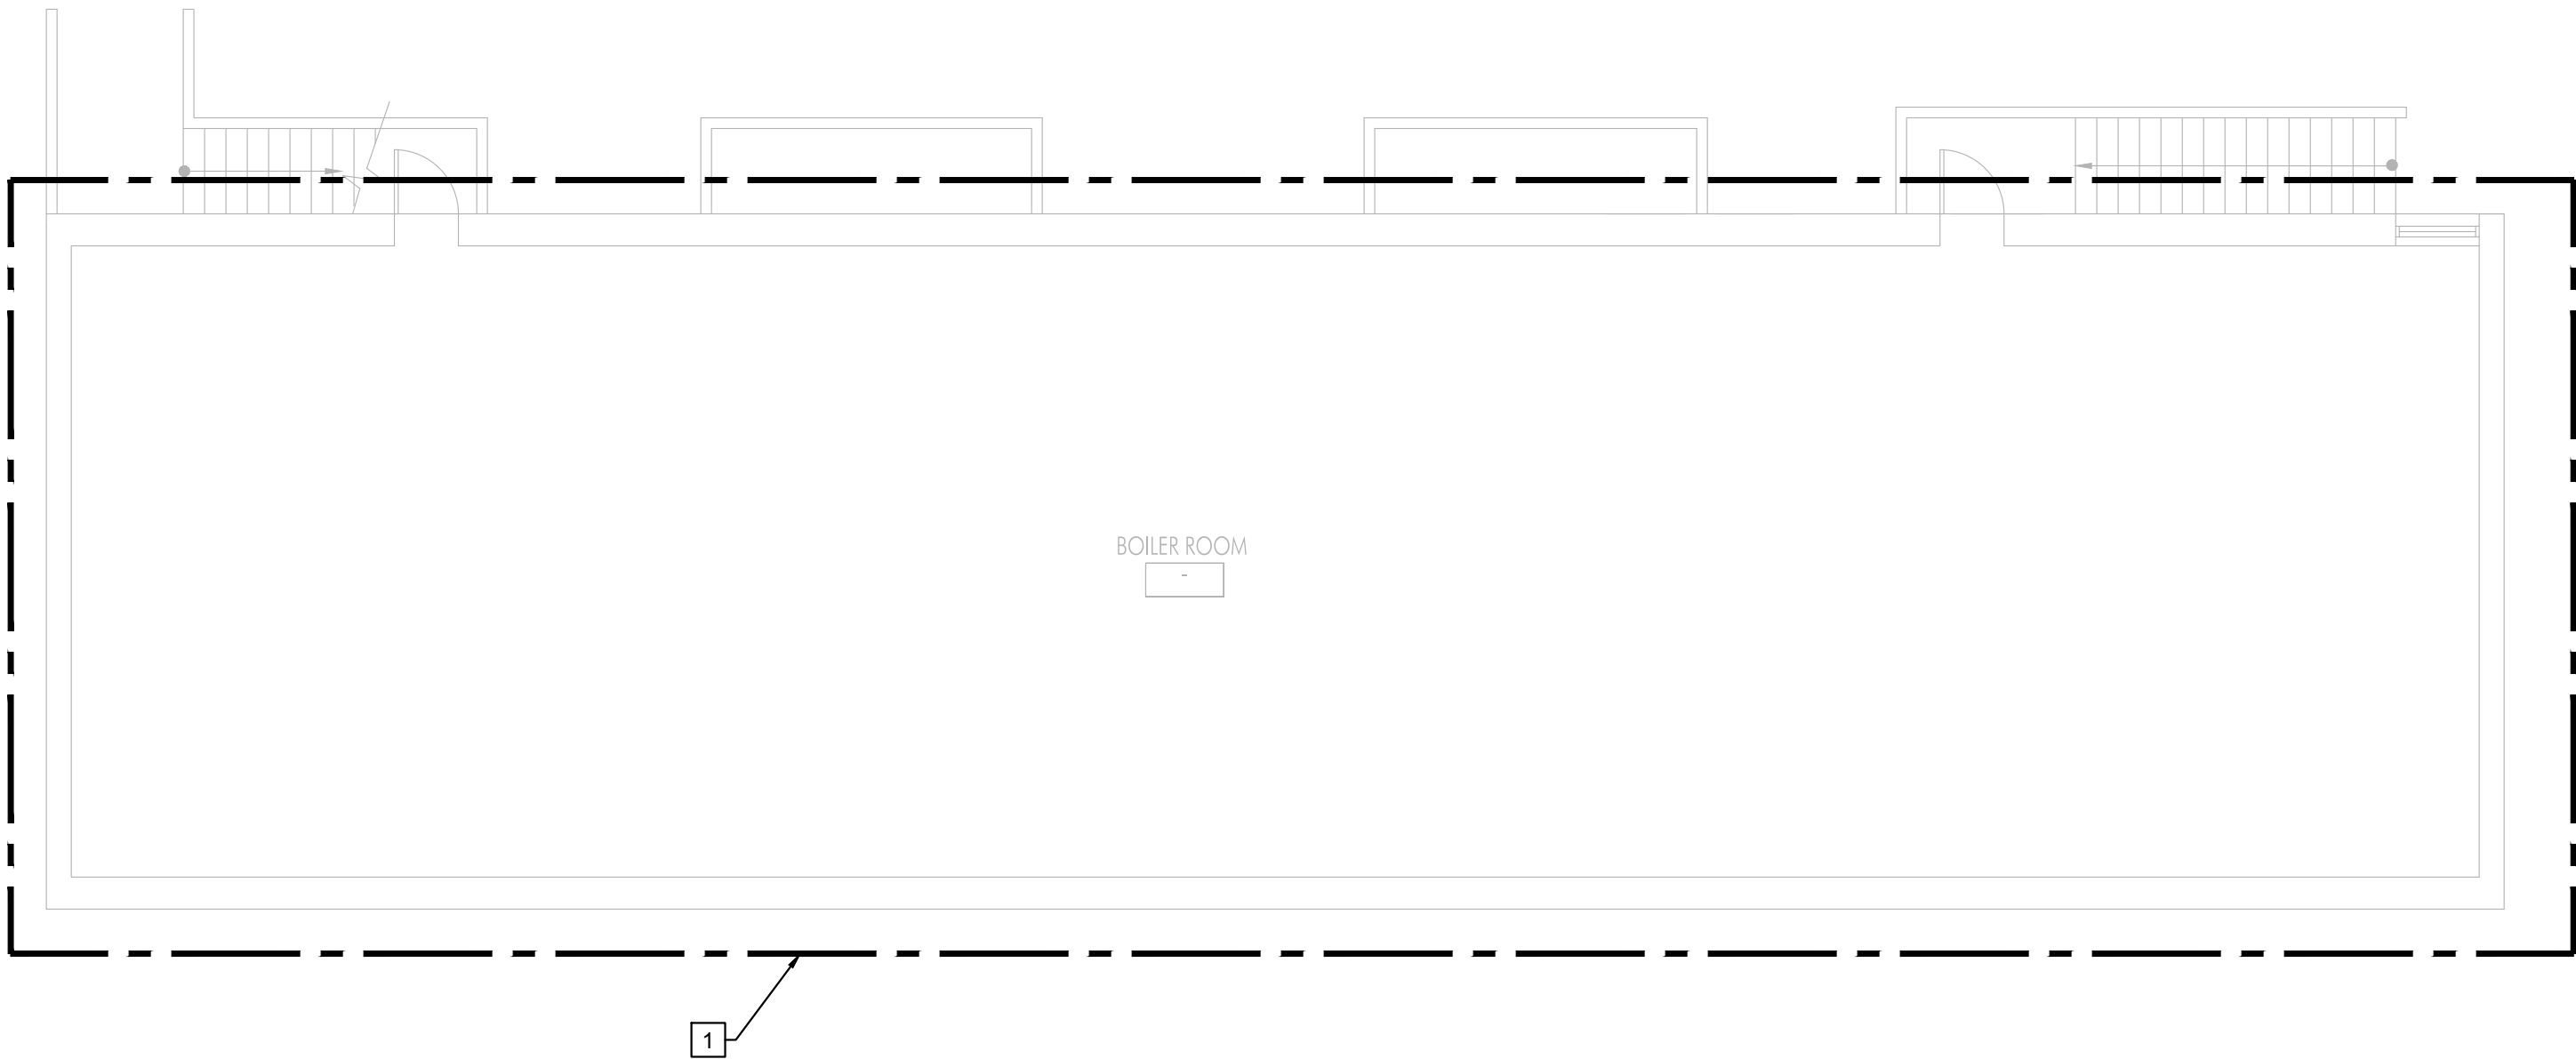

SCALE: 1/8"=1'-0"

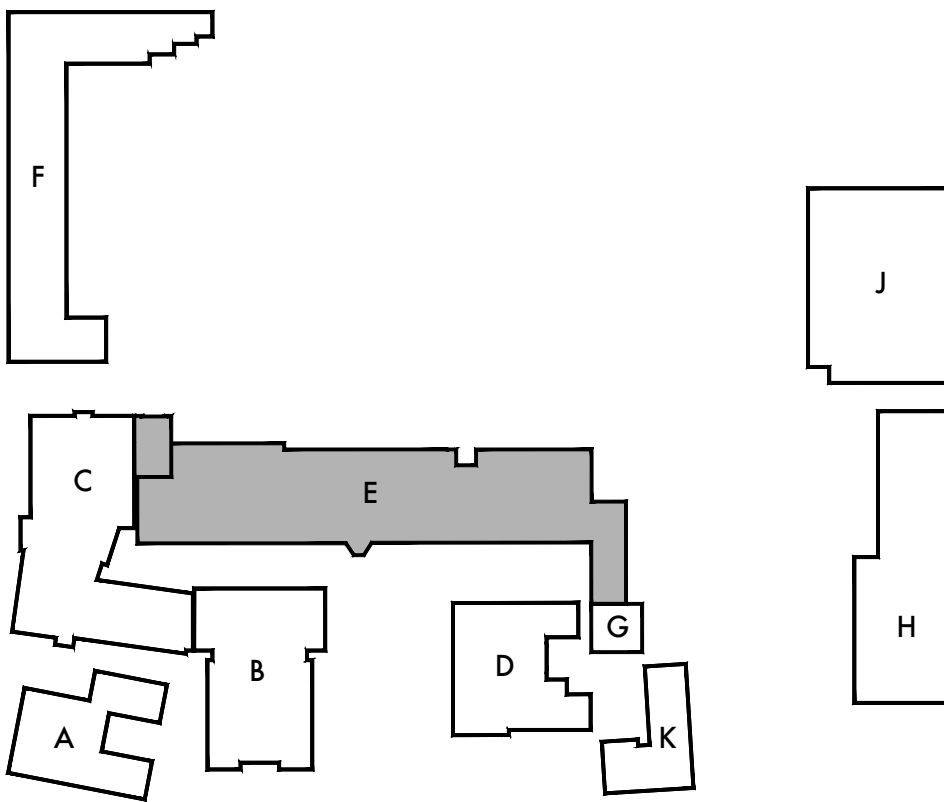

KEY PLAN

DSA Stamp

Architect




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Lincoln Middle School
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Santa Monica, California 90403

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421 East Huntington Drive
Monrovia, California 91016
P: 626.930.1383 F: 626.930.1385
Project No. 19009

Sheet Title

Building 'E'
Basement
Mechanical
Demolition Plan

Sheet Number

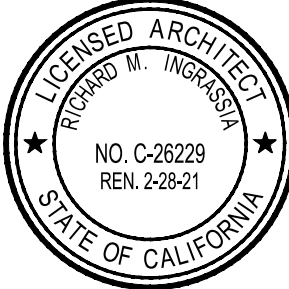MED200


KEYNOTES

- 1
- REMOVE (E) HEATING AND VENTILATION SYSTEM, DUCTWORK, PIPING SUPPORTS, THERMOSTAT, CONTROL AND ACCESSORIES WITHIN THE SCOPE OF WORK AREA UNLESS OTHERWISE NOTED. PATCH AND REPAIR EXISTING WALLS, CEILING, FLOOR AS NEEDED.

Architect




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1 FIRST FLOOR MECHANICAL DEMOLITION PLAN - SEGMENT A

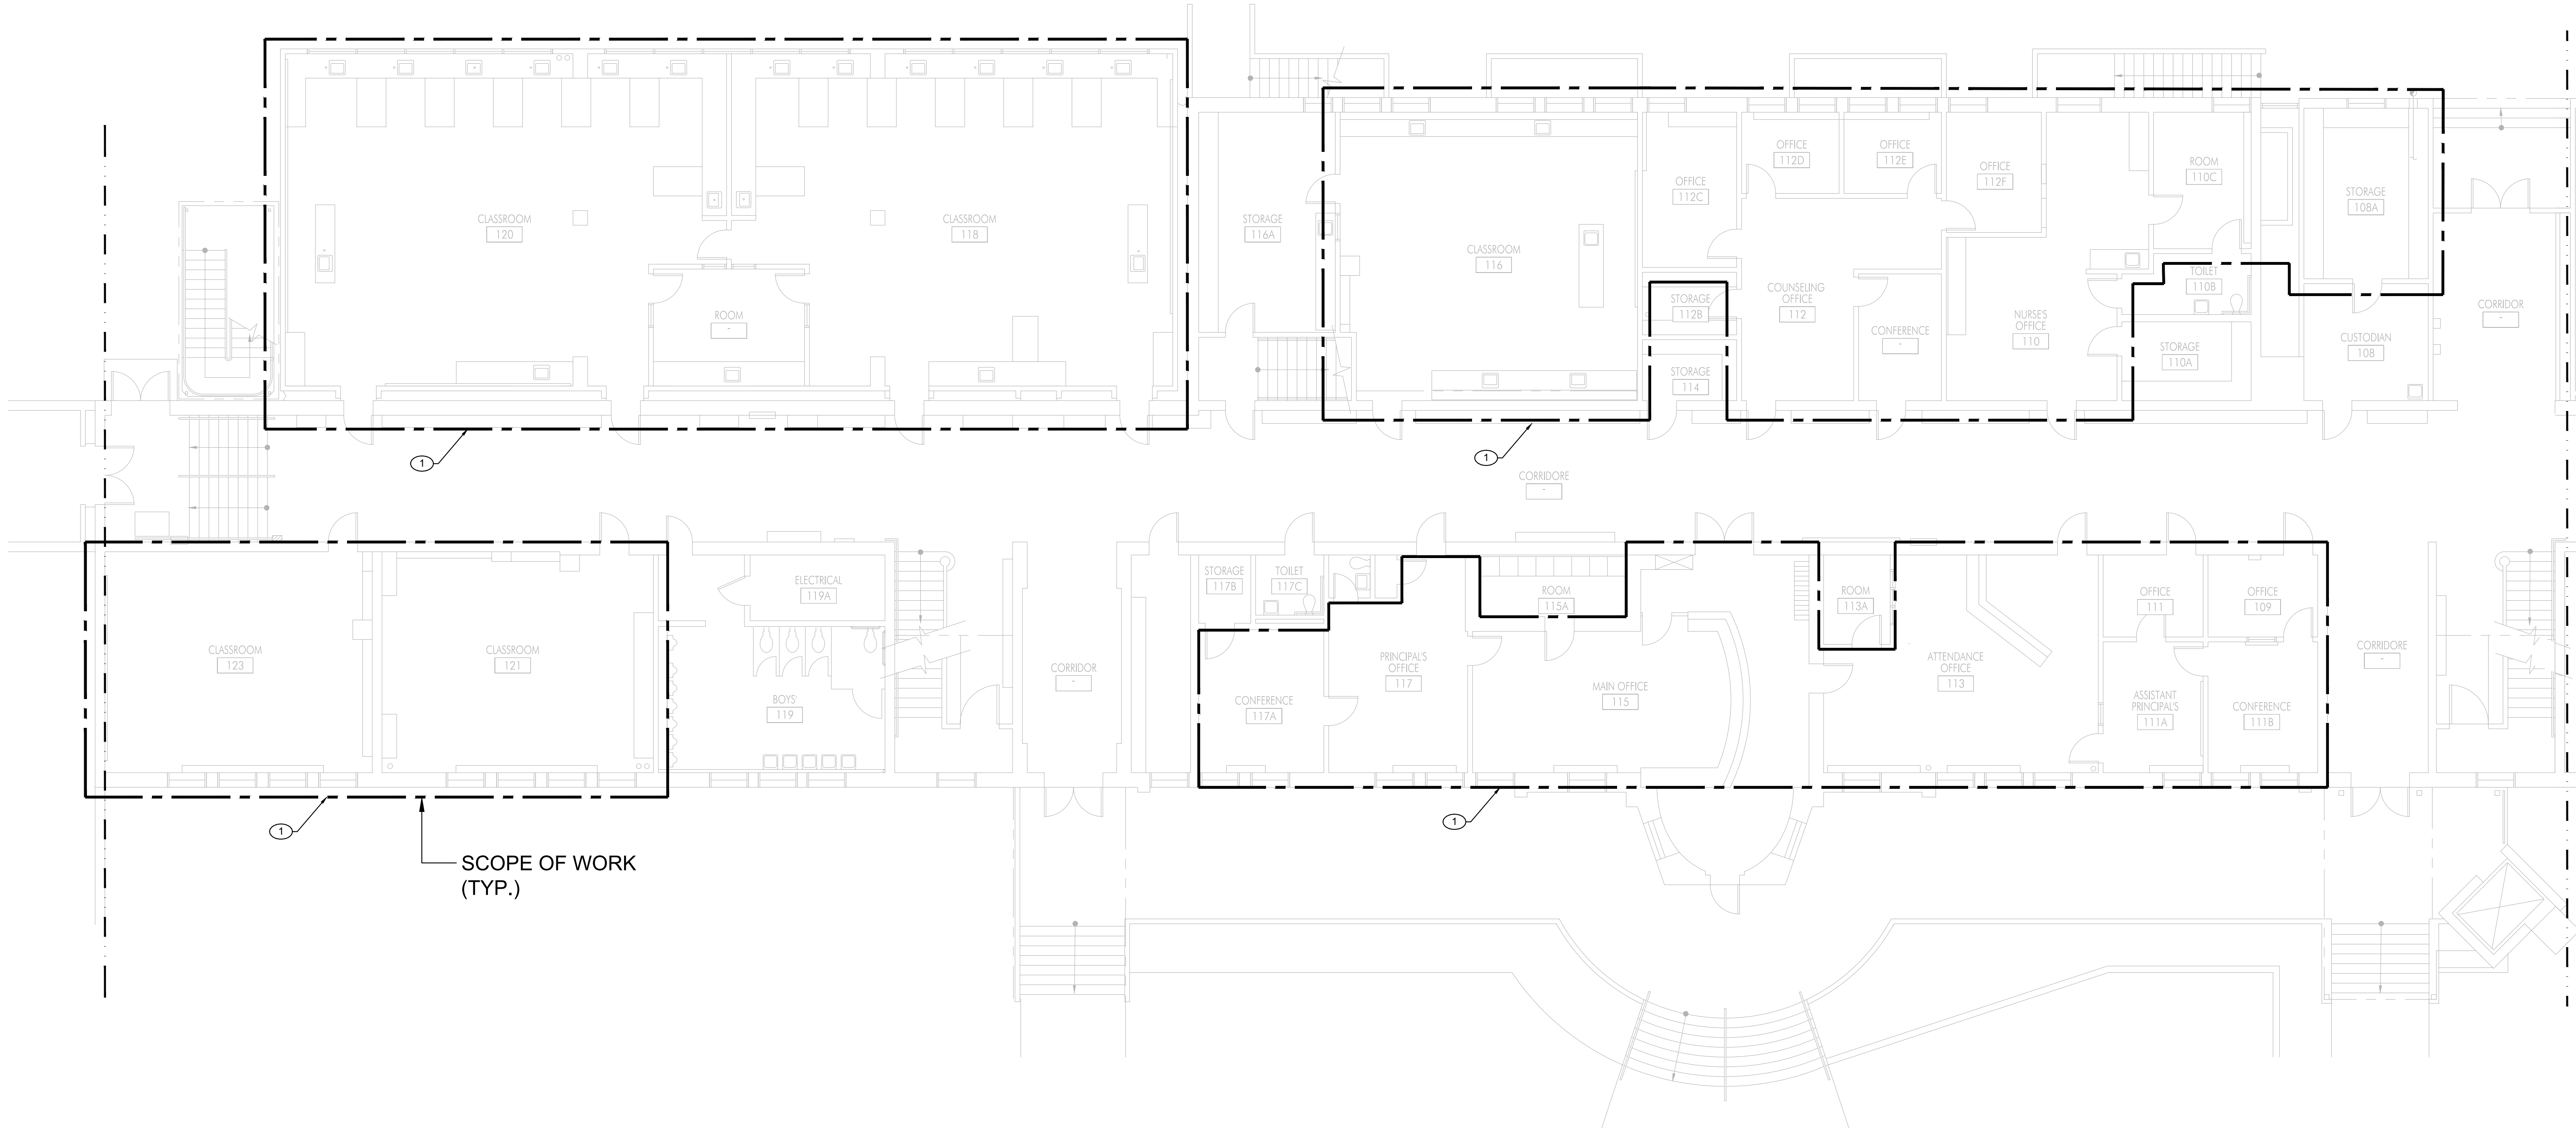

SCALE: 1/8"=1'-0"




KEY PLAN

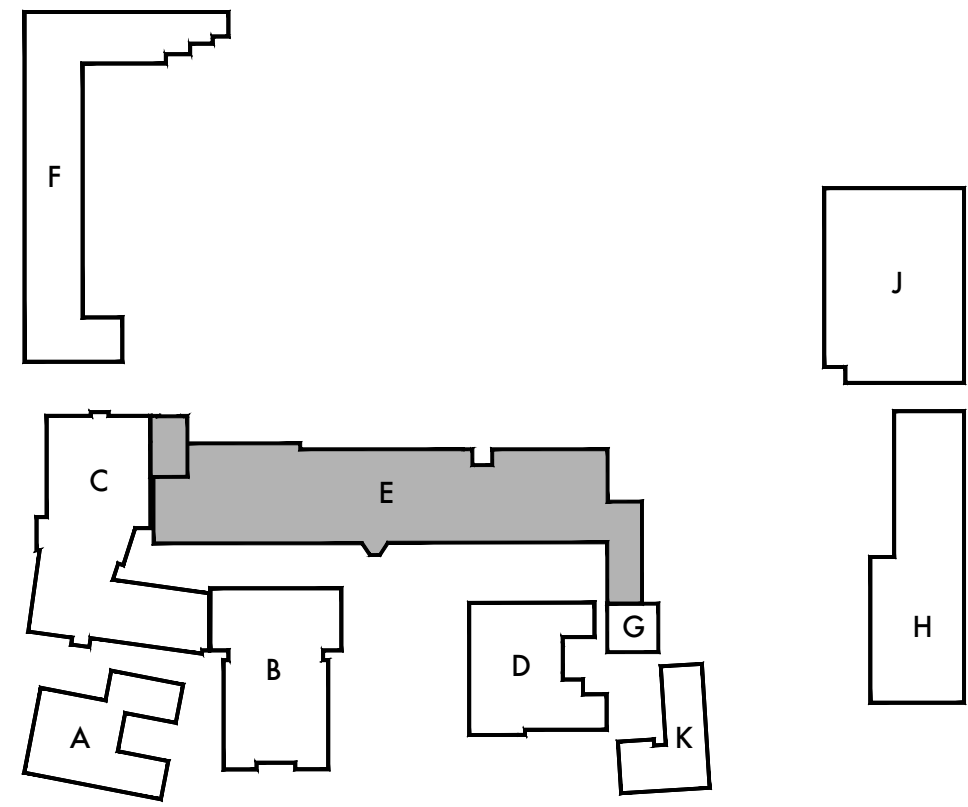Lincoln Middle School HVAC Replacement Project
Lincoln Middle School
1501 California Avenue
Santa Monica, California 90403

Rev	Date	Issue
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421 East Huntington Drive
Monrovia, California 91016
P: 626.930.1383 F: 626.930.1385
Project No. 19009

Sheet Title

Building 'E'
First Floor
Mechanical Demo.
Plan Segment A

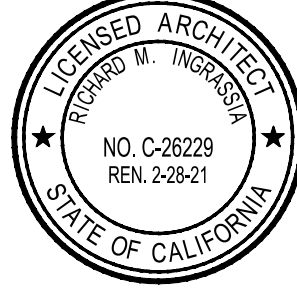Sheet Number

MED201A

KEYNOTES

- 1
- REMOVE (E) HEATING AND VENTILATION SYSTEM, DUCTWORK, PIPING SUPPORTS, THERMOSTAT, CONTROL AND ACCESSORIES WITHIN THE SCOPE OF WORK AREA UNLESS OTHERWISE NOTED. PATCH AND REPAIR EXISTING WALLS, CEILING, FLOOR AS NEEDED.

Architect




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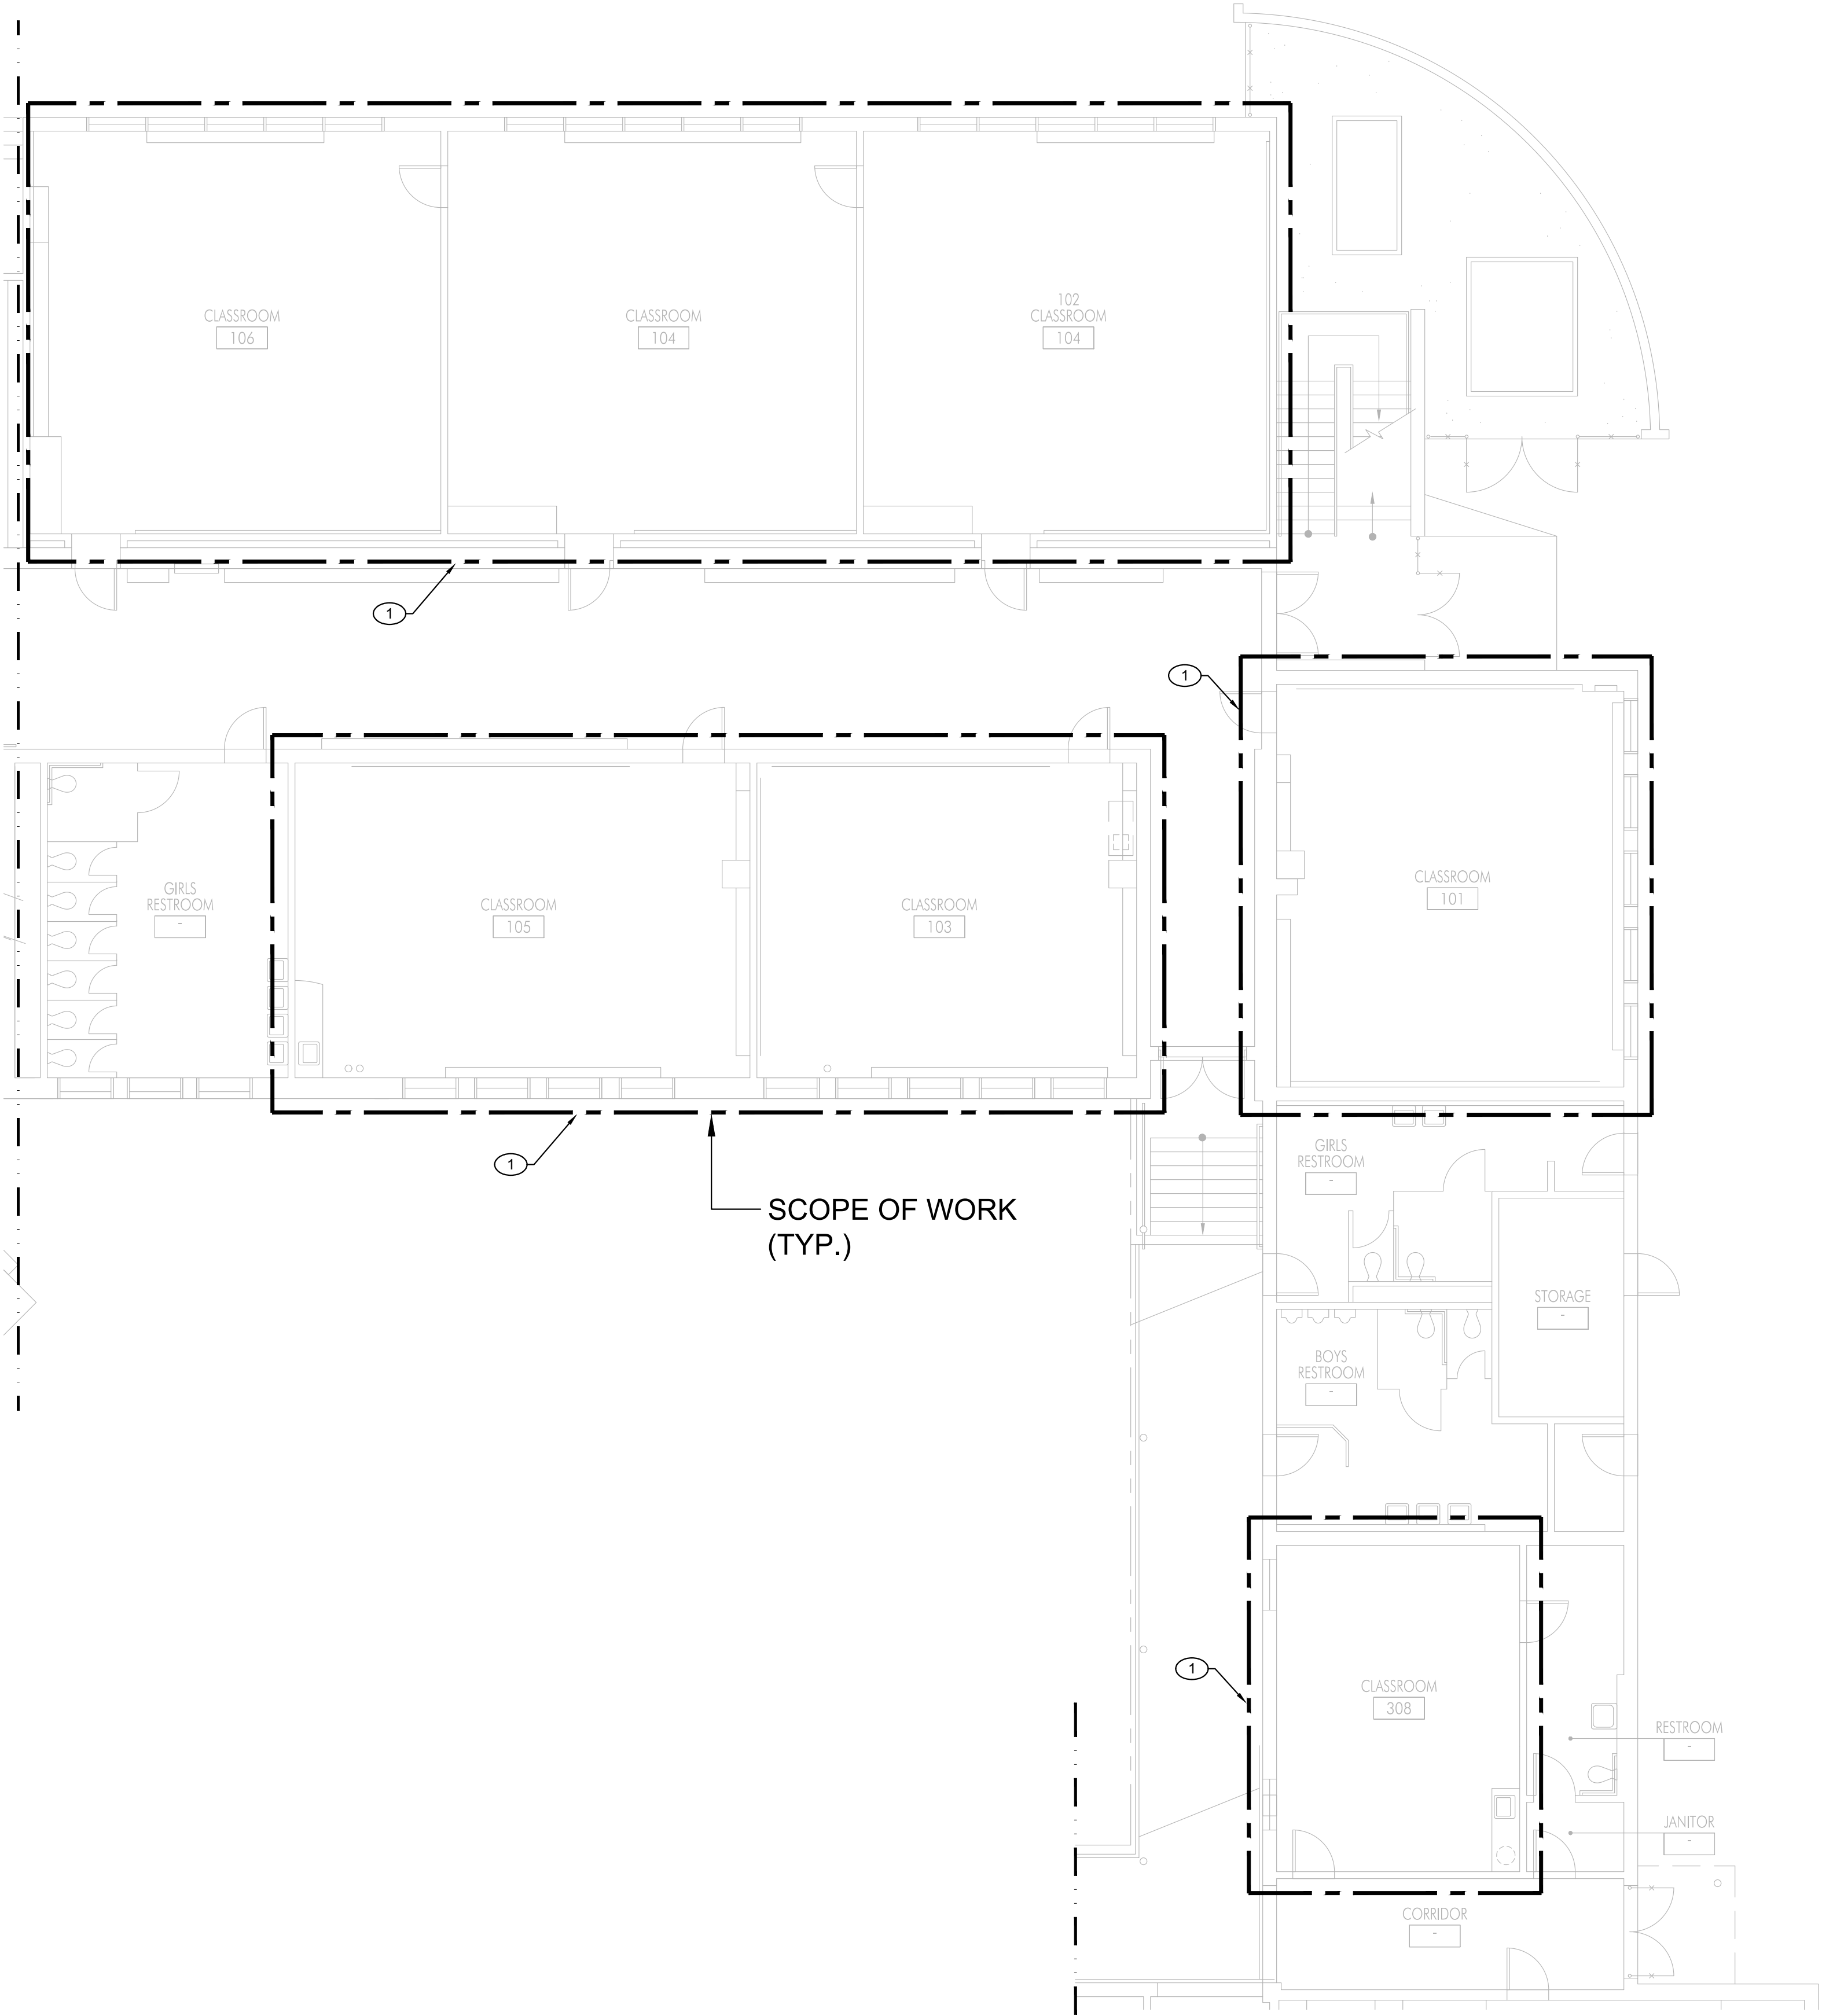


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Project No. 19009


Sheet Title
Building 'E'
First Floor
Mechanical Demo.
Plan Segment B

Sheet Number

MED201B

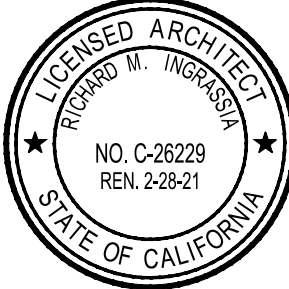

1 FIRST FLOOR MECHANICAL DEMOLITION PLAN - SEGMENT B

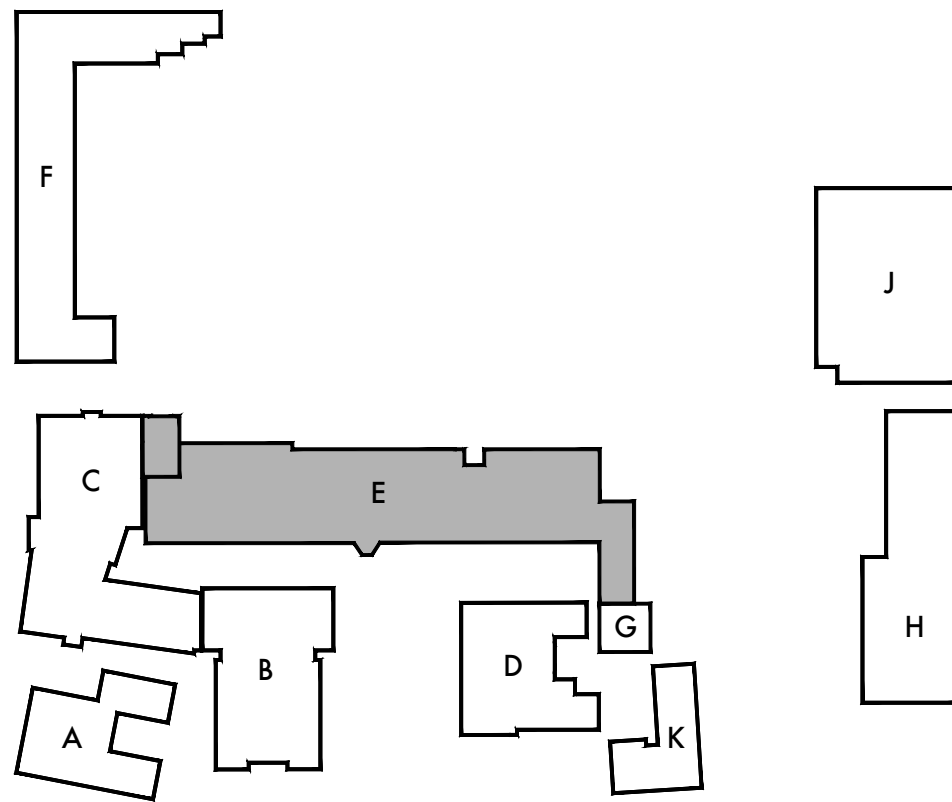

KEY PLAN

KEYNOTES

- 1
- REMOVE (E) GAS FURNACE UNITS, GAS PIPES, SUPPORTS, ENTIRE ASSOCIATED COMBUSTION AIR AND FLUE PIPES UP THRU ROOF WITHIN THE SCOPE OF WORK AREA. PATCH AND REPAIR EXISTING WALLS, CEILING, ROOF AS NEEDED.
- 2
- REMOVE (E) DUCT TRANSITION & CAPPED FOR NEW SYSTEM.
- 3
- REMOVE (E) MOTORIZED DAMPER, RECONNECT (E) DUCTWORK TO BE REUSED.

Architect




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1501 California Avenue
Santa Monica, California 90403

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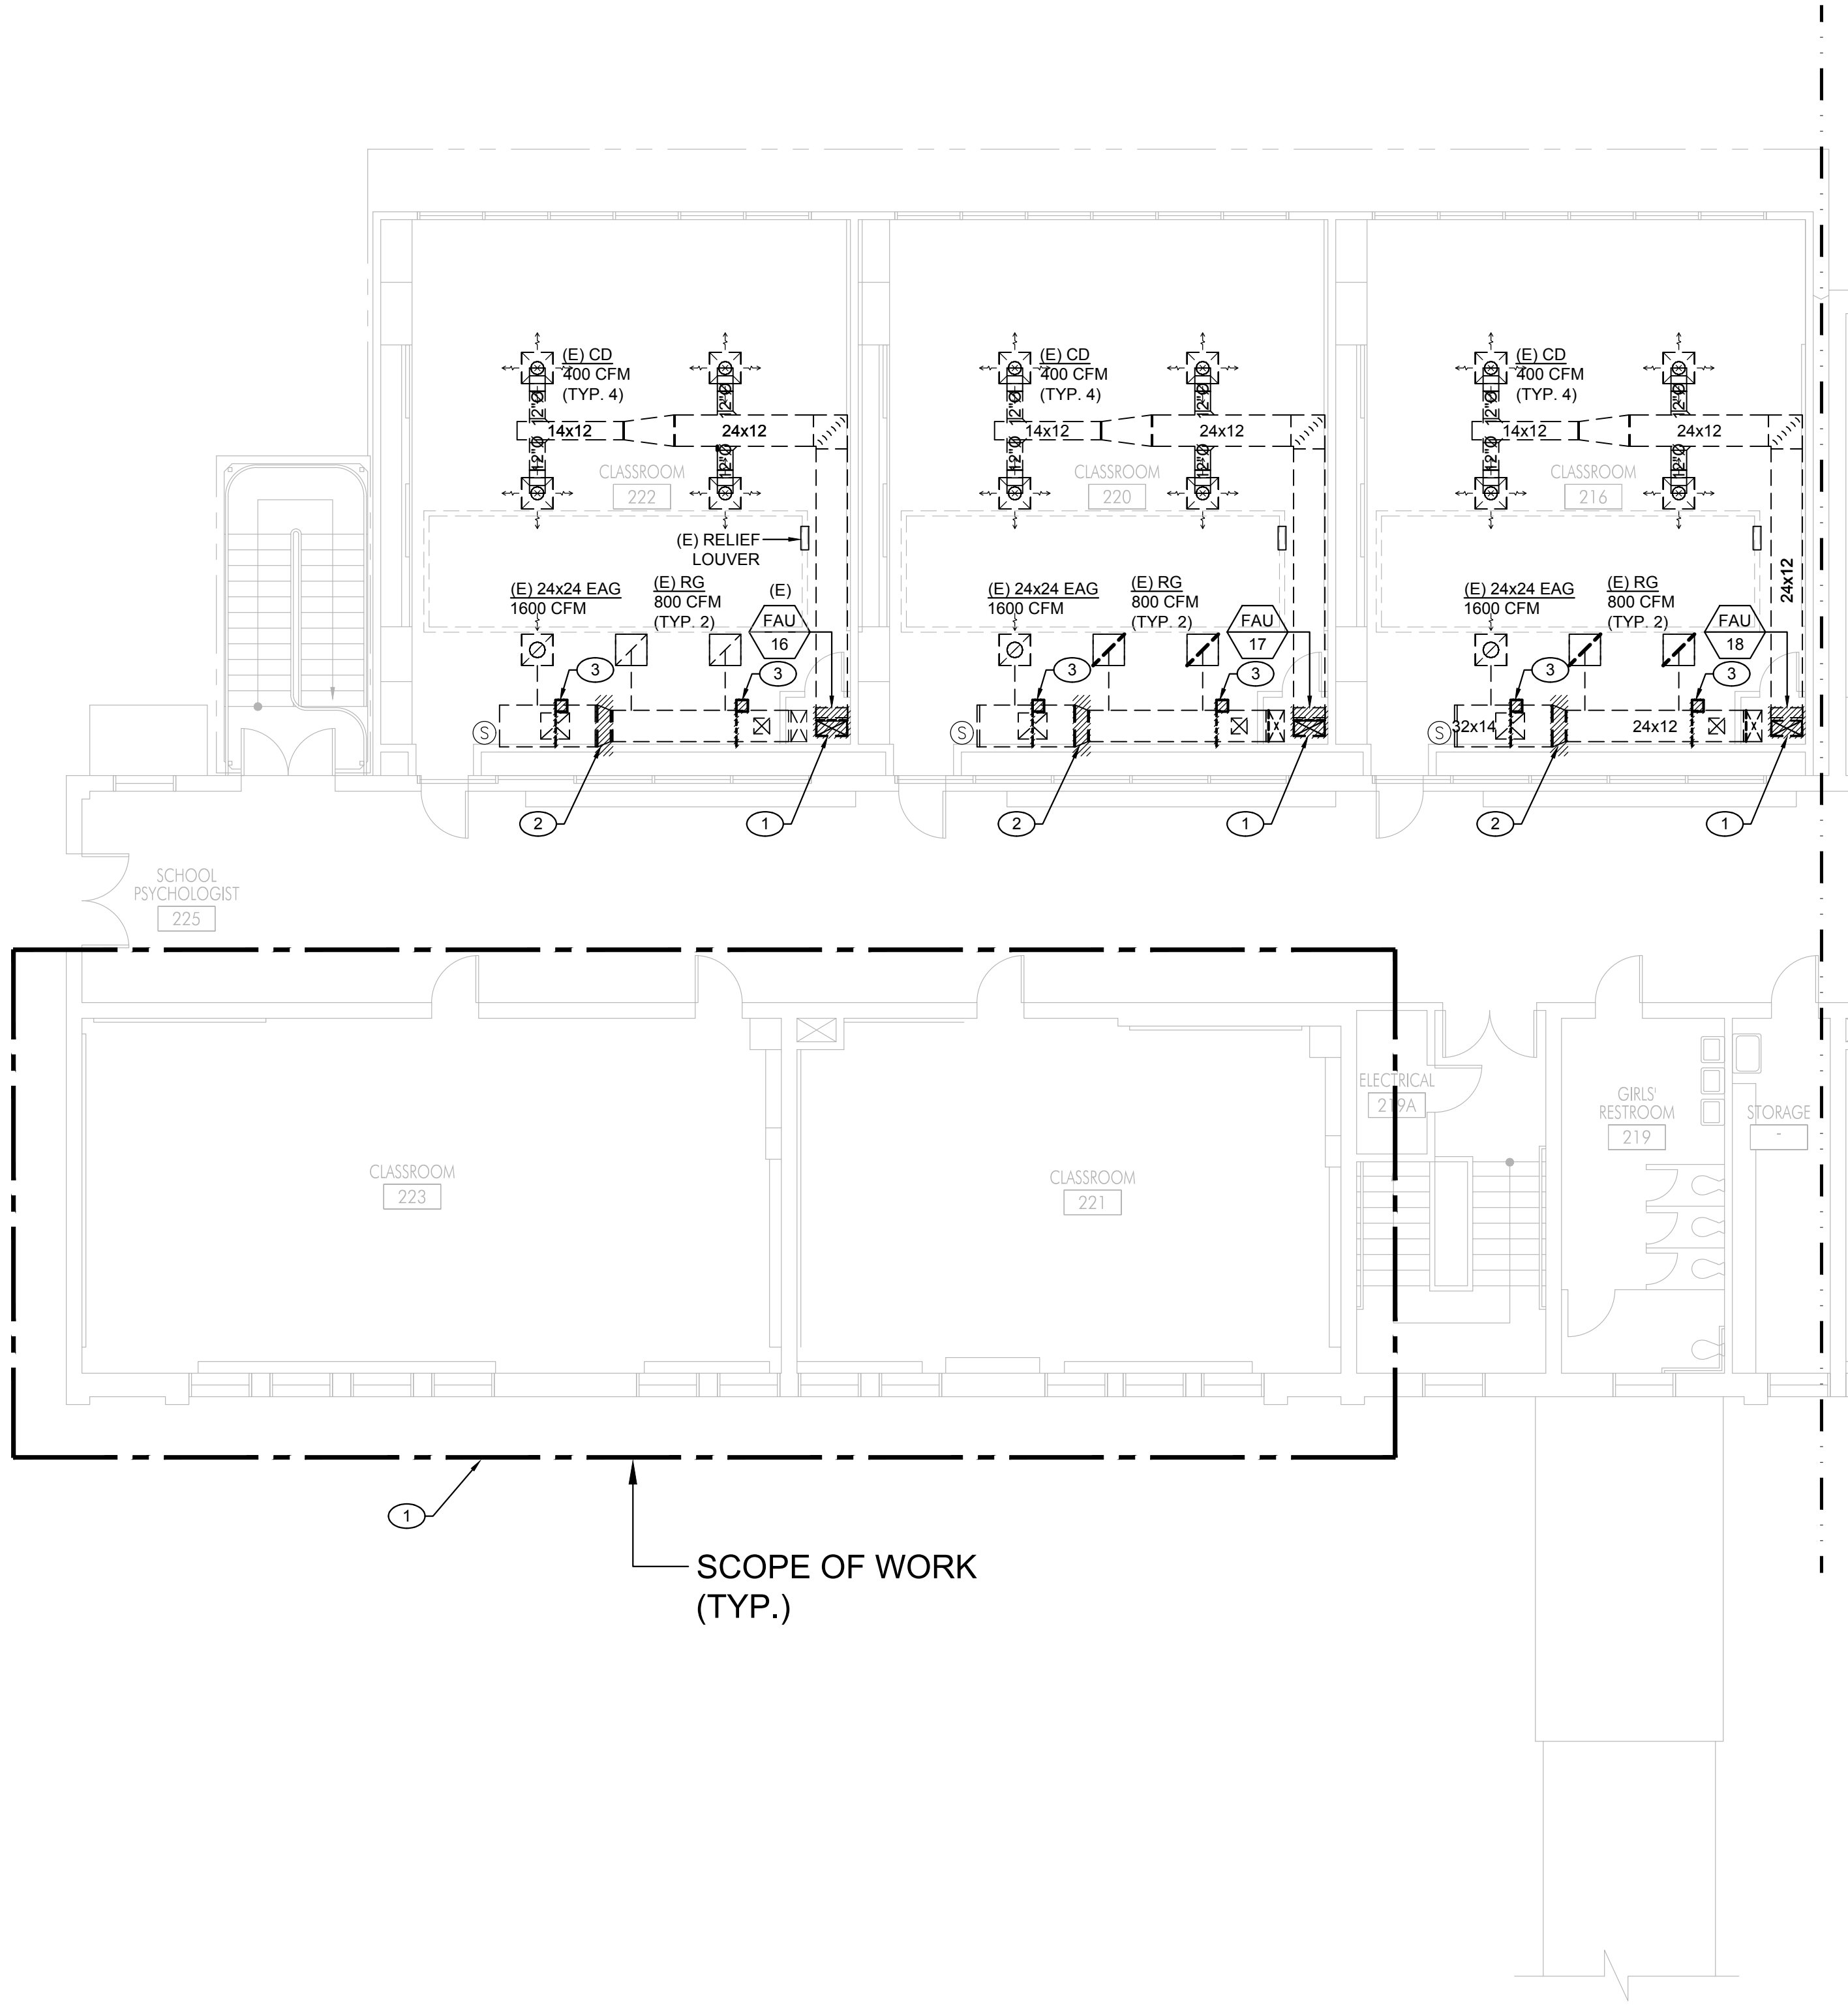
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Sheet Title
Building 'E'
Second Floor
Mechanical Demo.
Plan Segment A

Sheet Number


MED202A

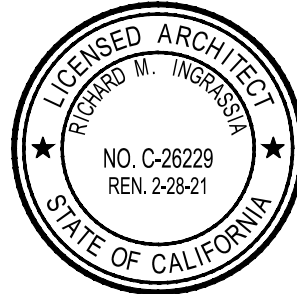

1 SECOND FLOOR MECHANICAL DEMOLITION PLAN - SEGMENT A



SCALE: 1/8"=1'-0"

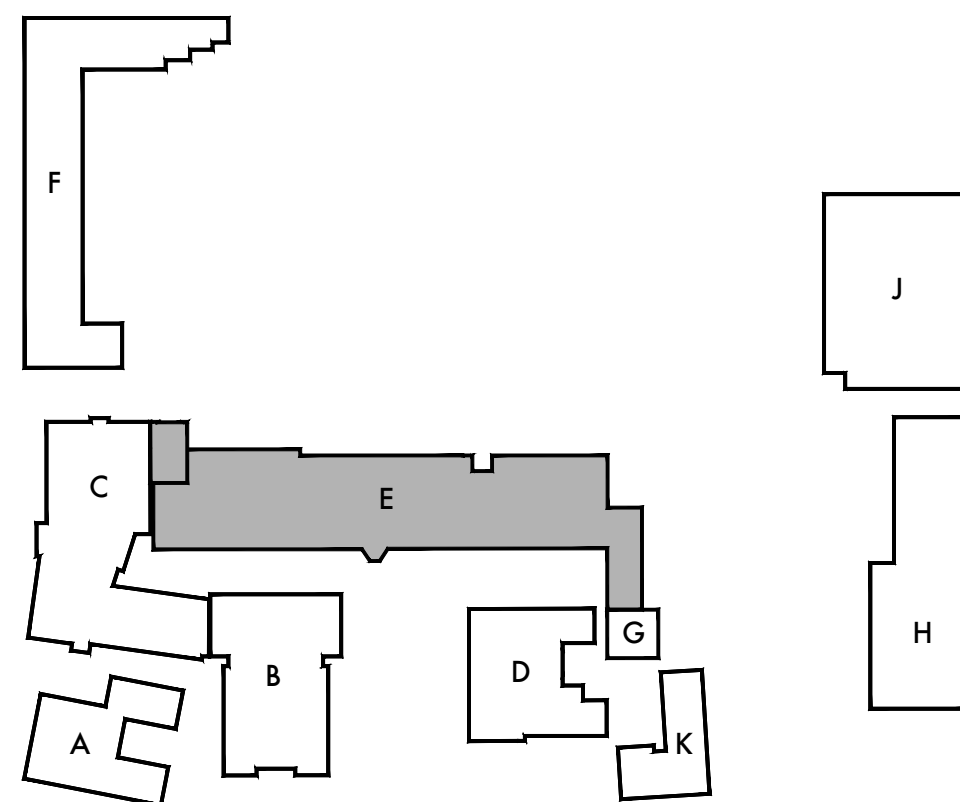

KEY PLAN


KEYNOTES

- 1
- REMOVE (E) GAS FURNACE UNITS, GAS PIPES, SUPPORTS, ENTIRE ASSOCIATED COMBUSTION AIR AND FLUE PIPES UP THRU ROOF WITHIN THE SCOPE OF WORK AREA. PATCH AND REPAIR EXISTING WALLS, CEILING, ROOF AS NEEDED.
- 2
- REMOVE (E) DUCT TRANSITION & CAPPED FOR NEW SYSTEM.
- 3
- REMOVE (E) MOTORIZED DAMPER, RECONNECT (E) DUCTWORK TO BE REUSED.

Architect




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1 SECOND FLOOR MECHANICAL DEMOLITION PLAN - SEGMENT B

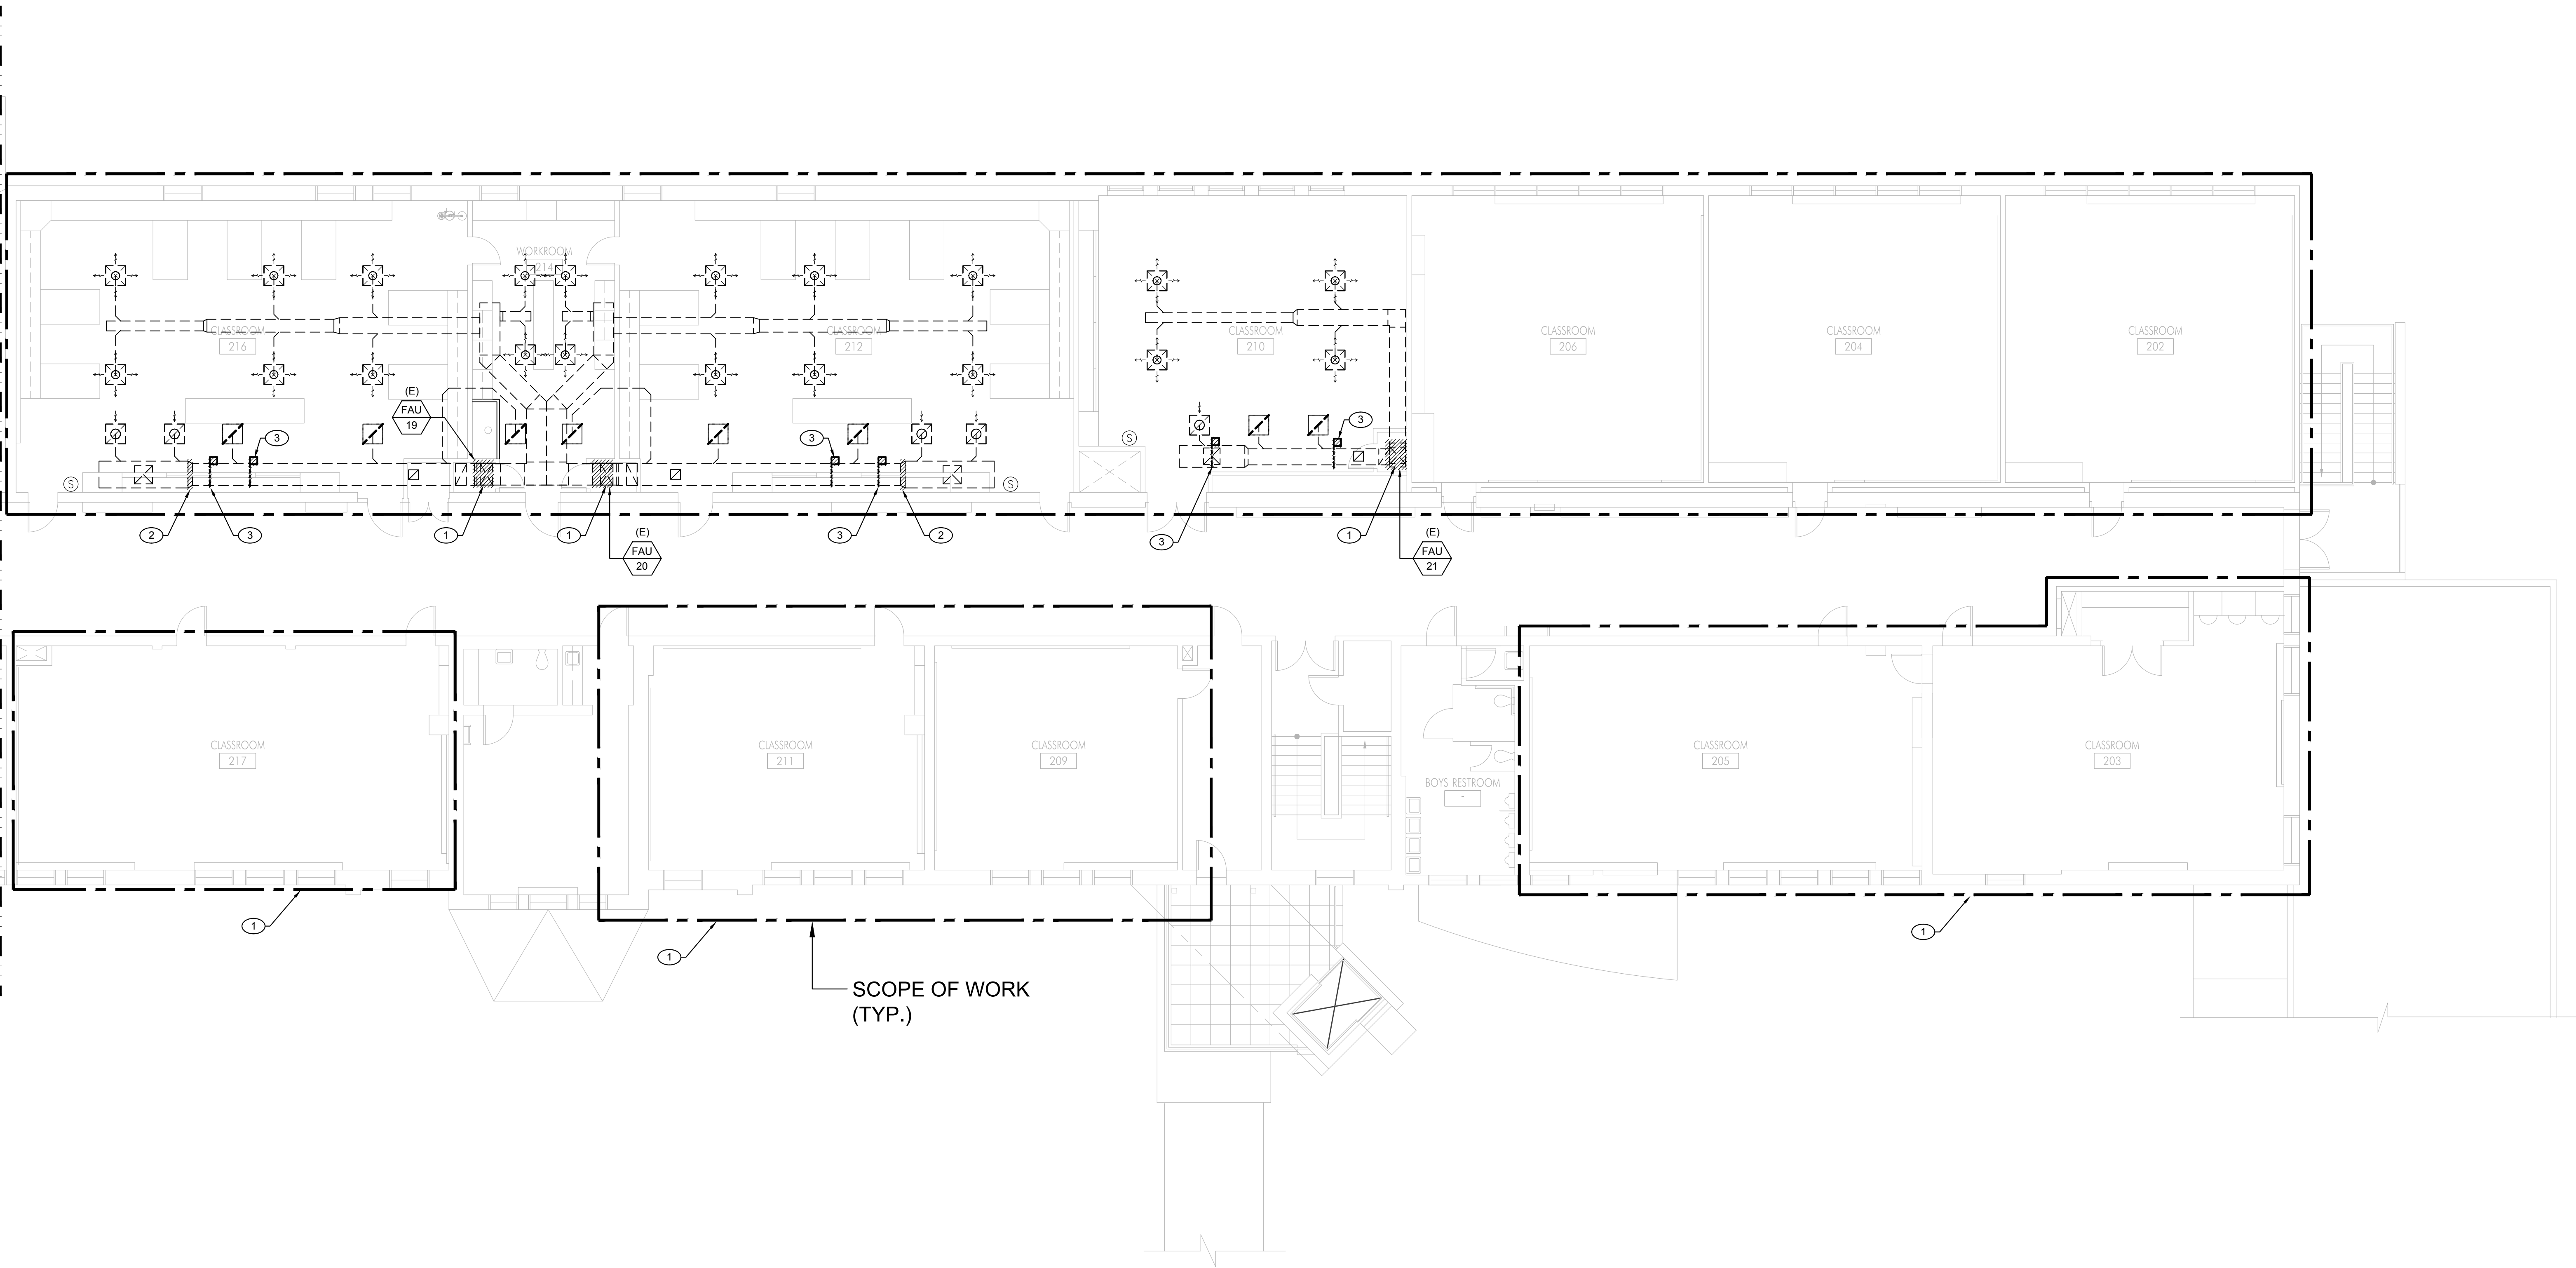

SCALE: 1/8"=1'-0"




KEY PLAN
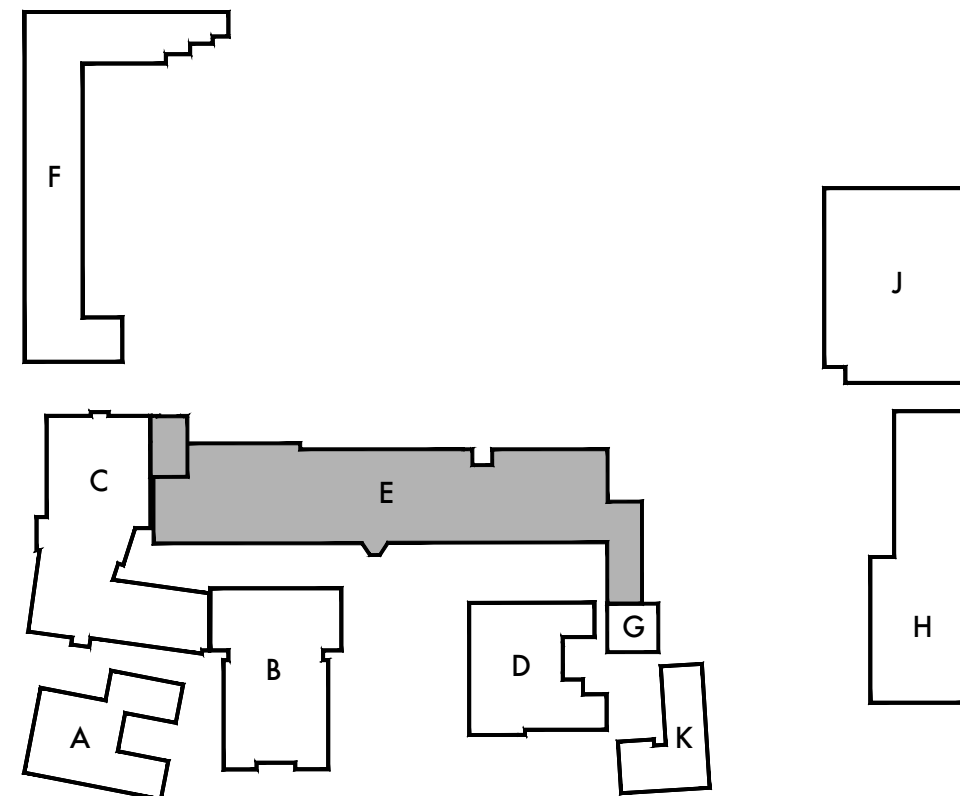
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Building 'E'
Second Floor
Mechanical Demo.
Plan Segment B

Sheet Number

MED202B

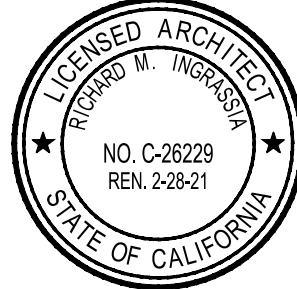KEYNOTES


- 1
- REMOVE (E) EQUIPMENT & PAD. (E) ROOF OPENING WILL BE USED FOR (N) EQUIPMENT. PATCH AND REPAIR EXISTING ROOF AS NEEDED.



1 MECHANICAL ROOF PLAN - SEGMENT A



SCALE: 1/8"=1'-0"

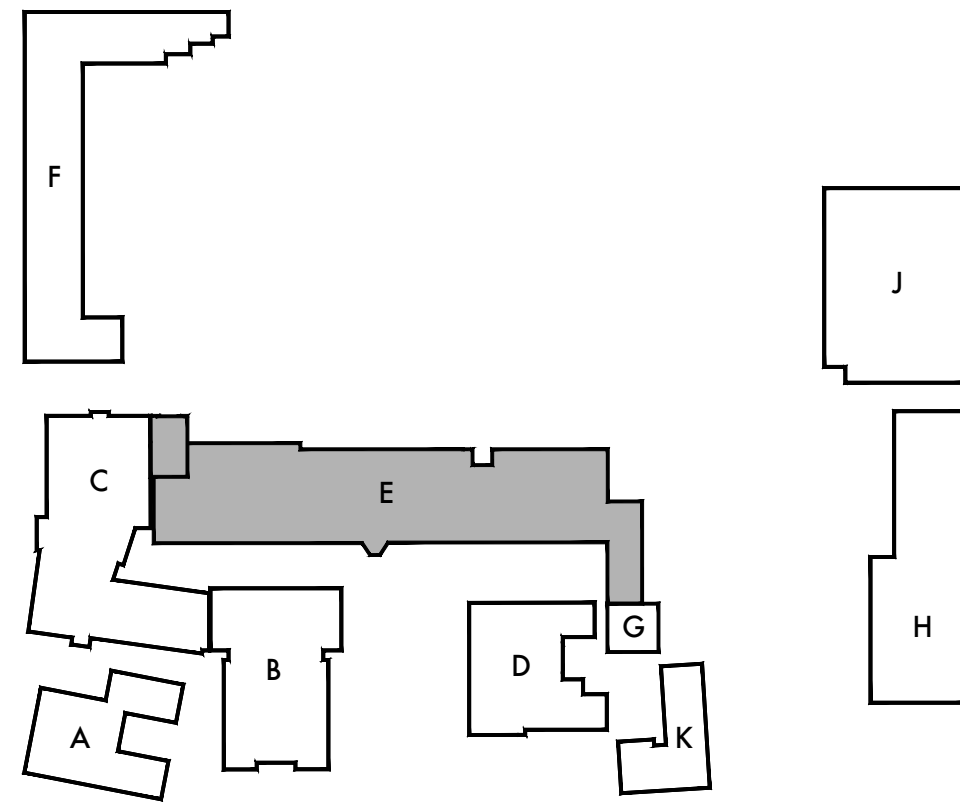

KEY PLAN

Architect




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Lincoln Middle School HVAC Replacement Project
Lincoln Middle School
1501 California Avenue
Santa Monica, California 90403

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Sheet Title
Building 'E'
Roof Mechanical
Demolition Plan
Segment A

Sheet Number


MED203A

FLOOR REMODEL GENERAL NOTES

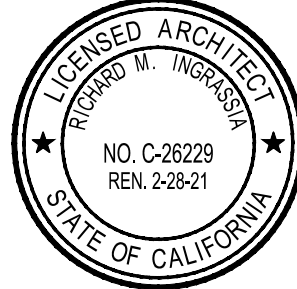1. ALL MECHANICAL WORK NEED TO BE COORDINATED WITH ARCHITECTURAL PLANS AND ENSURE THAT ALL EQUIPMENT, DUCTWORK, AIR DEVICES, PIPING, ETC SHALL AVOID CONFLICT WITH ANY ARCHITECTURAL ITEMS INCLUDING BUT NOT LIMITED TO LIGHTS, SPEAKERS, SPRINKLERS, ETC AND ADJUST MECHANICAL WORK AND ITEMS AS NEEDED. SEE ARCH PLANS FOR ADDITIONAL SCOPE OF WORK THAT MAY NOT BE ADDRESSED OR SHOWN ON MECHANICAL PLANS.
2. SEE ARCHITECTURAL DRAWINGS INCLUDING REFLECTED CEILING PLANS AND INTERIOR ELEVATIONS FOR FURTHER DIMENSIONS AND LOCATIONS OF ALL THERMOSTATS, DIFFUSERS, GRILLES, REGISTERS, ETC.
3. FOR CLASSROOMS, AND OTHER SPACES WITH NEW HVAC REPLACEMENT, CONTRACTOR TO COORDINATE WITH SCHOOL DISTRICT REPRESENTATIVE FOR THERMOSTAT TYPE AND CONNECTIVITY TO ALLOW FOR SCHEDULING AND UNIT CONTROL.
4. FOR INDIVIDUAL EQUIPMENT DETAIL REFERENCE, SEE EQUIPMENT SCHEDULES ON SHEET M002 THRU M007.

FLOOR REMODEL KEYNOTES

1. INTERLOCK CO2 SENSOR WITH RTU ECONOMIZER. SEE DETAIL 4/M7.1 FOR CONTROLS.
2. 25x11(L) RA & 18x14(L) SA DUCTS UP TO RTU. COORDINATE DUCT AND AIR DEVICE DISTRIBUTION WITH ARCHITECTURAL CEILING PLANS AND PROVIDE ADJUSTMENT TO AVOID CONFLICT WITH STRUCTURAL MEMBERS, LIGHTS, SPEAKERS, SPRINKLERS AND ANY OTHER ARCHITECTURAL FEATURES, ETC.
3. TSTAT AND RTU CONTROLS BY PELICAN CONTROLS. SEE „M7.1 FOR CONTROL DETAIL.

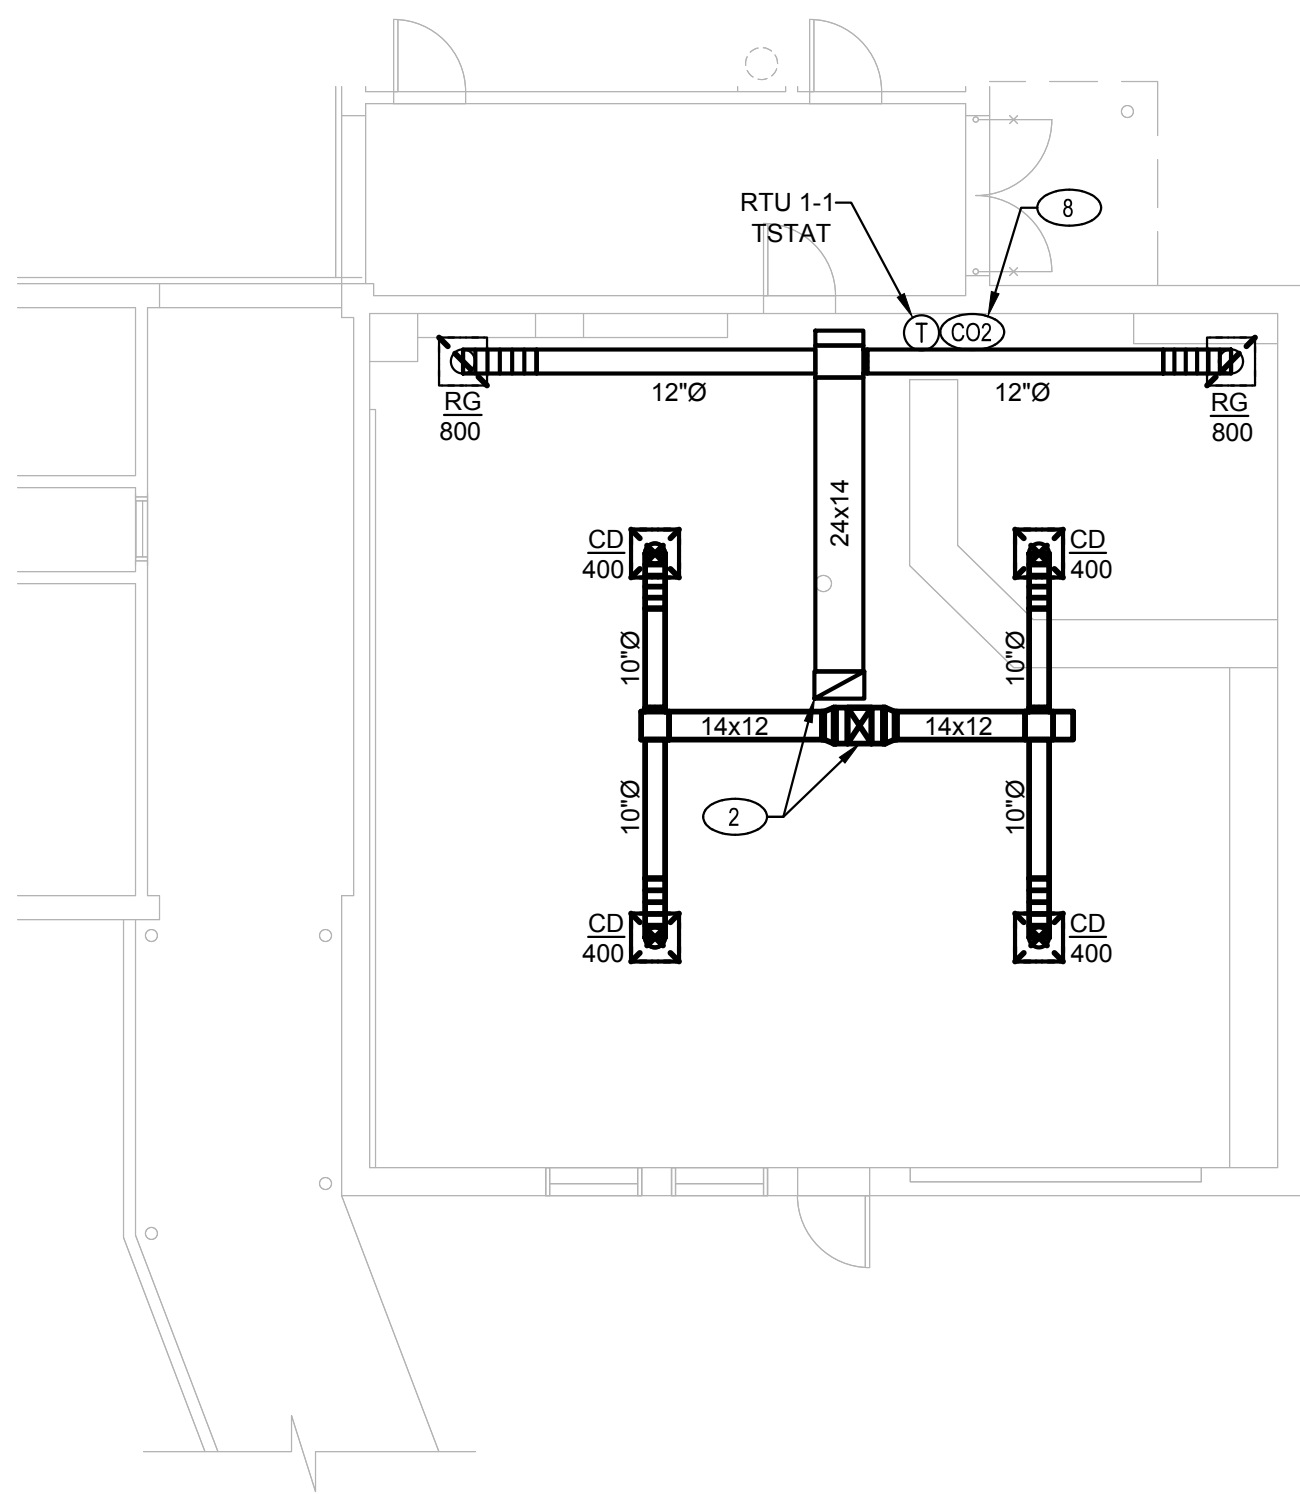


1 MECHANICAL REMODEL PLAN

SCALE: 1/8"=1'-0"

FLOOR DEMOLITION GENERAL NOTES

1. CONTRACTOR SHALL VISIT THE SITE PRIOR TO SUBMISSION OF BID AND CONDUCT A THOROUGH FIELD INVESTIGATION TO VERIFY EXISTING CONDITIONS AND BE THOROUGHLY FAMILIAR WITH THE DEMOLITION SCOPE OF WORK. HE SHALL FURNISH ALL LABORS, SUPERVISION, MATERIALS, EQUIPMENT AND FACILITIES NECESSARY TO CARRY OUT THIS WORK AND SUBMIT ALL QUESTIONS IN WRITING PRIOR TO BID.
2. ANY EXISTING TO REMAIN EQUIPMENT AND DUCTWORK OUTSIDE OF DASHED LINES SCOPE OF WORK, SHALL BE REPAIRED, CLEANED AND PAINTED BY CONTRACTOR PER DISTRICT'S STANDARDS.
3. CONTRACTOR SHALL REPAIR, PATCH AND SEAL ALL UNUSED OR DAMAGED WALL AND ROOF OPENINGS/ PENETRATIONS TO BUILDING CAUSED BY DEMOLITION OF EQUIPMENT, PIPING, DUCTWORK, SUPPORTS, ETC.
4. CONTRACTOR SHALL REMOVE AND DISPOSE OF ALL EXISTING REGISTERS, DUCTWORK AND RELATED APPURTENANCES SHOWN WITHIN DASHED LINES SCOPE OF WORK. THEY MUST NOT BE ABANDONED IN PLACE UNLESS NOTED OTHERWISE
5. ALL DAMAGED, BROKEN OR INOPERABLE AIR DEVICES OR DAMPERS SHALL BE REPLACED BY CONTRACTOR WITH NEW LIKE SIZED COMPONENTS OR AIR DEVICES. CONTRACTOR SHALL CONDUCT A THOROUGH FIELD INVESTIGATION TO VERIFY EXISTING CONDITIONS PRIOR TO BIDDING. SUBMIT ALL QUESTIONS IN WRITING PRIOR TO BID.
6. CONTRACTOR SHALL INSTALL ALL EQUIPMENT AND DEVICES SUCH THAT COMPONENTS WILL BE ACCESSIBLE FOR MAINTENANCE.
7. FIRE PROTECTION DURING DEMOLITION / CONSTRUCTION SHALL BE IN ACCORDANCE WITH 2016 CBC, CHAPTER 33.

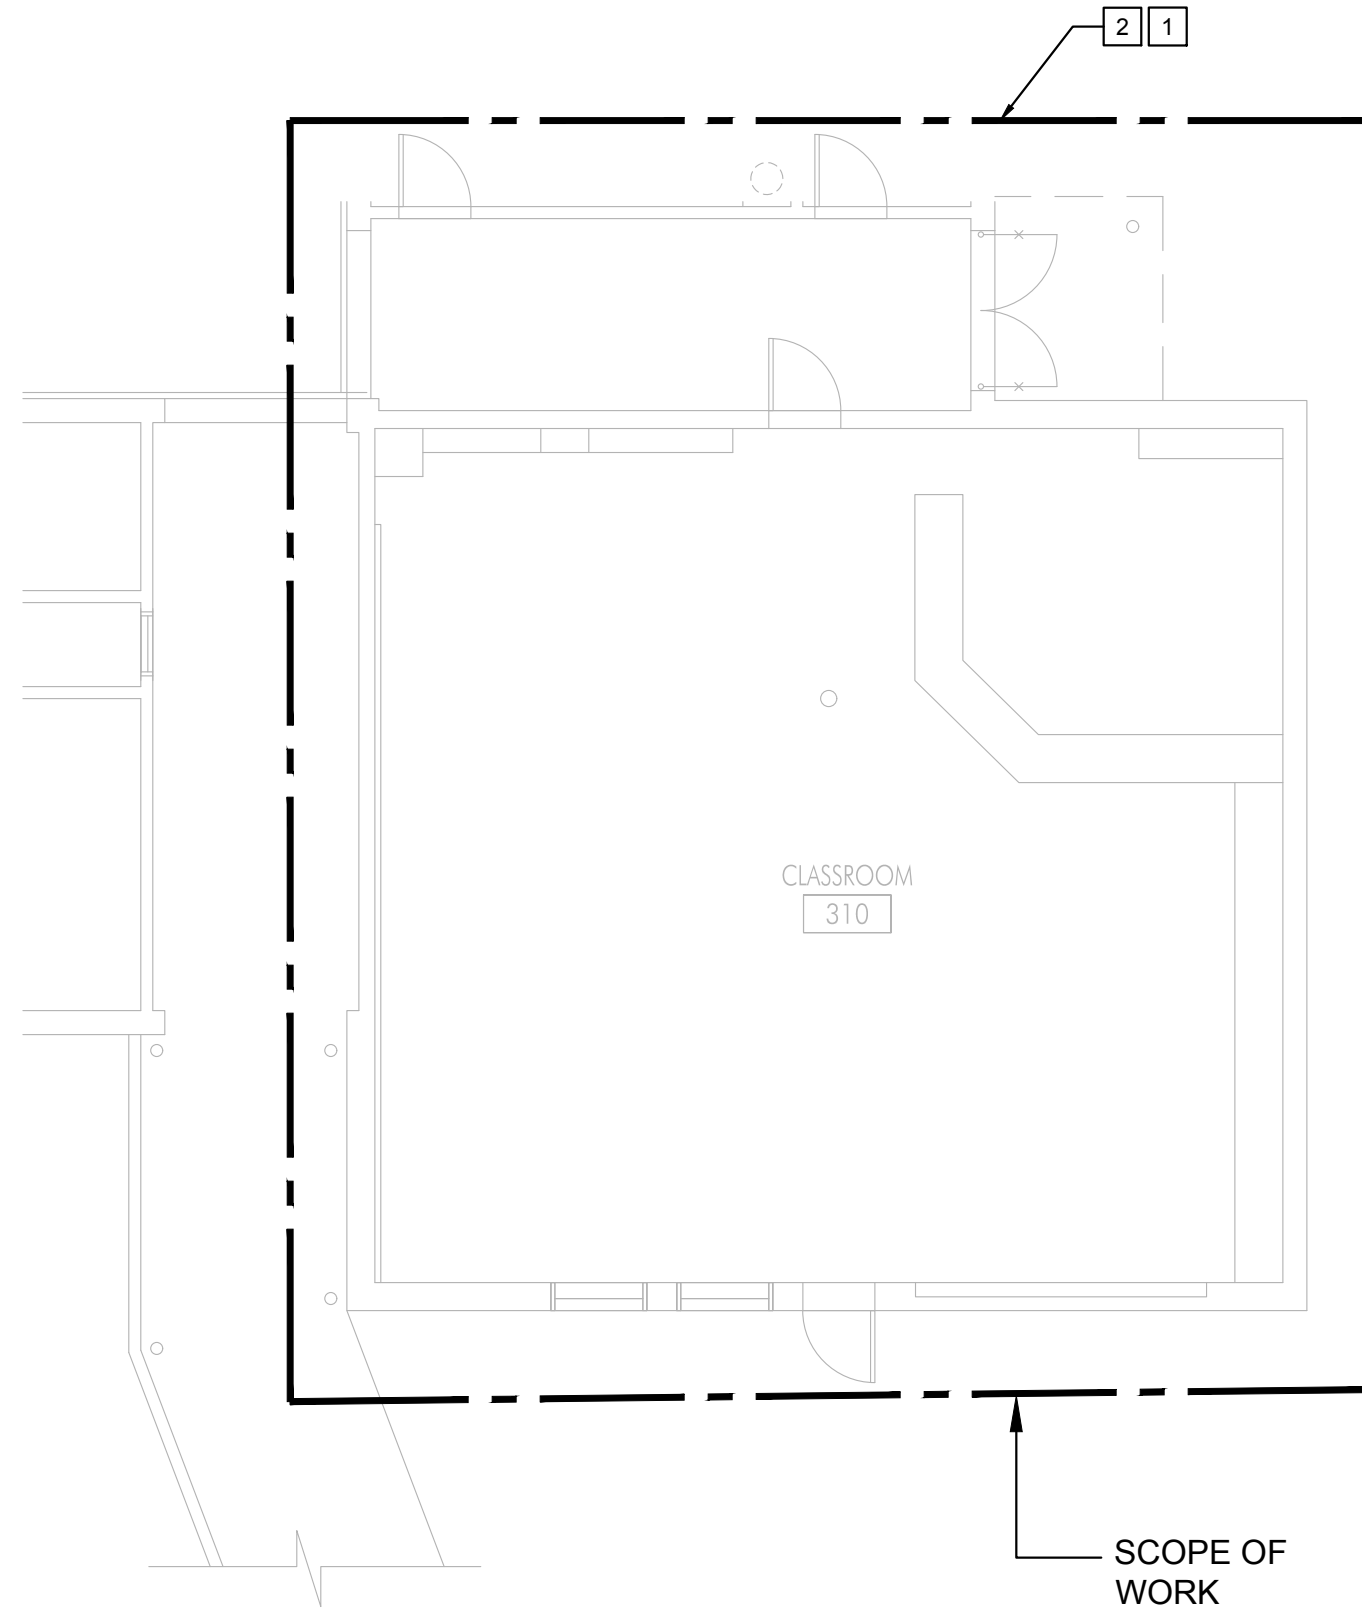

2 MECHANICAL DEMOLITION PLAN

SCALE: 1/8"=1'-0"

FLOOR DEMOLITION KEYNOTES


1. DEMOLISH AND REMOVE ALL EXISTING HVAC EQUIPMENT AS SHOWN WITHIN DASHED LINES SCOPE OF WORK, INCLUDING BUT NOT LIMITED TO ALL EXISTING HVAC EQUIPMENT, DUCTWORK, AIR DEVICES, PIPING, SUPPORT, CONDUITS AND ALL ASSOCIATED APPURTENANCES AND DISPOSED OF PER OWNERS DIRECTION. CONTRACTOR SHALL REPAIR, PATCH AND PAINT ALL ROOF WALL, CEILING, FLOOR INCLUDING ANY ASSOCIATED OPENINGS OR PENETRATIONS TO MATCH ADJACENT SURFACES PER ARCHITECTURAL DRAWINGS.
2. CONTRACTOR SHALL COORDINATE WITH ALL TRADES TO PROVIDE A CLEAR AND OPERABLE AREA FOR FUTURE REMODEL WORK.

ROOF REMODEL GENERAL NOTES

1. CONTRACTOR SHALL VISIT THE SITE PRIOR TO SUBMISSION OF BID AND THOROUGHLY FAMILIARIZE HIMSELF WITH THE REMODEL SCOPE OF WORK. HE SHALL FURNISH ALL LABOR, SUPERVISION, MATERIALS, EQUIPMENT AND FACILITIES NECESSARY TO CARRY THIS WORK.
2. ALL ROOFTOP EQUIPMENTS MUST BE INSTALLED AT LEAST 10 FEET AWAY FROM ANY PARAPET WALL.
3. SEE ARCHITECTURAL DRAWINGS INCLUDING REFLECTED CEILING PLANS AND INTERIOR ELEVATIONS FOR FURTHER DIMENSIONS AND LOCATIONS OF ALL THERMOSTATS, DIFFUSERS, GRILLES, REGISTERS, ETC.
4. ALL EXPOSED DUCTWORK SHALL BE 26 GAUGE GALVANIZED STEEL WITH DOUBLE DUCT CONSTRUCTION PER SMACNA GUIDELINES.
5. FOR ALL NEW THERMOSTATS, PROVIDE ALL WIRING, CONDUITS, SUPPORT, FITTINGS, CONTROLS AND REQUIRED ACCESSORIES FOR CONNECTIONS BETWEEN TSTAT AND RESPECTIVE ROOFTOP PACKAGE UNIT.
6. FOR INDIVIDUAL EQUIPMENT DETAIL REFERENCE, SEE EQUIPMENT SCHEDULES ON SHEET M002 THRU M007.
7. MAINTAIN A MINIMUM OF 10'-0" CLEARANCE BETWEEN ANY EXHAUST OUTLET AND OUTSIDE AIR INTAKE INTO THE BUILDING.


ROOF REMODEL KEYNOTES

1. 25x11(L) RA & 18x14(L) SA DUCTS CONNECTING TO/FROM RTU ON ROOF. COORDINATE DUCT ROUTING BETWEEN EXISTING ROOF FRAMING OR OPENINGS. SEE STRUCTURAL DRAWINGS FOR FRAMING OF OPENINGS.
2. RTU OSA INTAKE HOOD. MAINTAIN MINIMUM 10'-0" CLEARANCE BETWEEN OSA HOOD AND ANY EXHAUST FROM THE BUILDING. RELOCATE EQUIPMENT AS REQUIRED TO MEET THIS CODE REQUIRED CLEARANCE(S).
3. 3'-0" HVAC MANUFACTURER CLEARANCE ALL AROUND EACH RTU FOR EQUIPMENT MAINTENANCE AND ACCESS.
4. RTU MUST BE INSTALLED AT LEAST 10'-0" AWAY FROM PARAPET WALL.

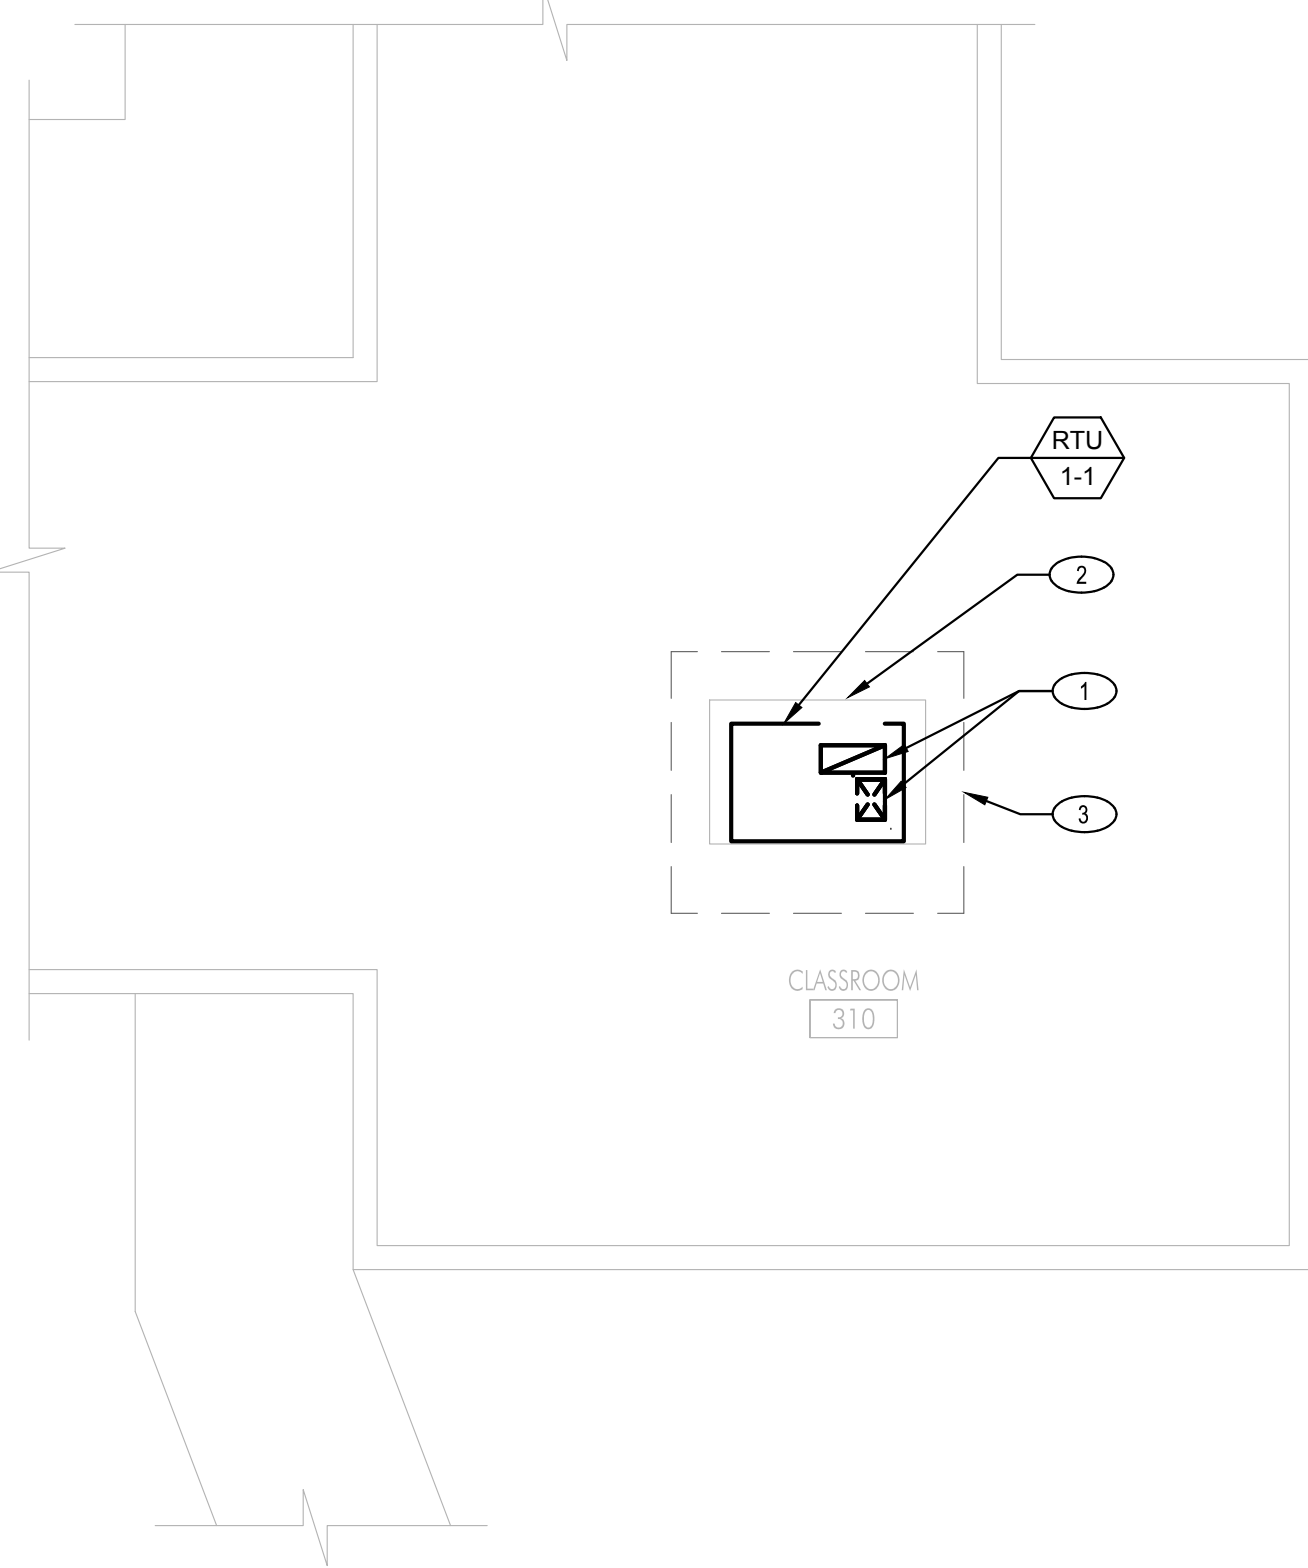

E MECHANICAL ROOF PLAN

SCALE: 1/8"=1'-0"

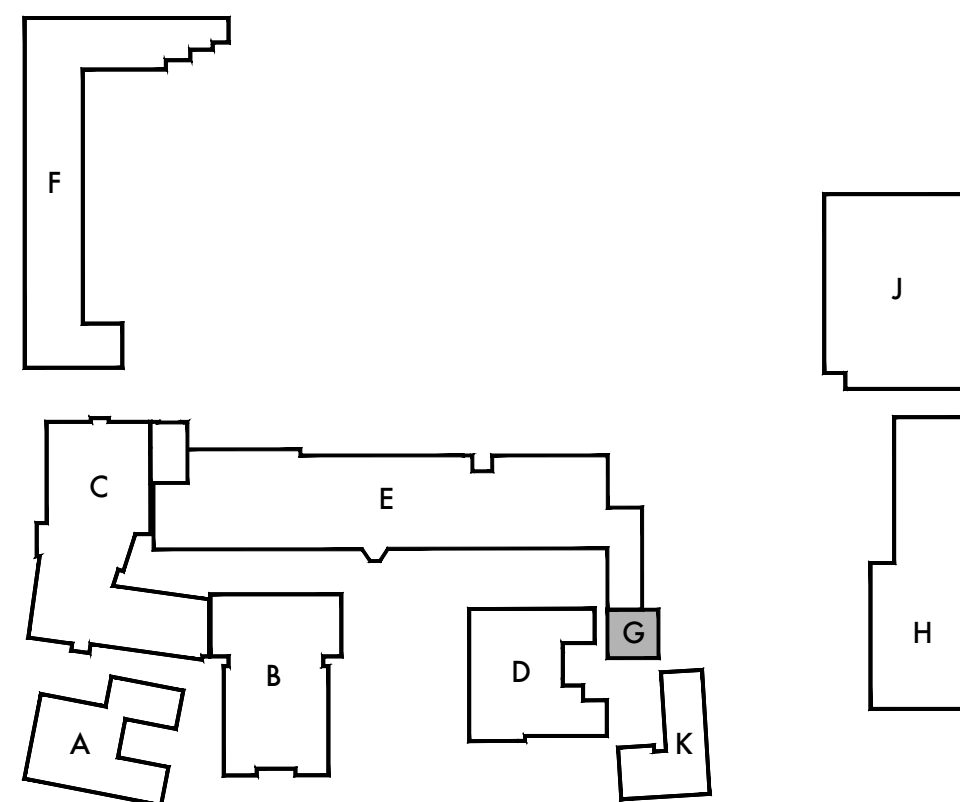

KEY PLAN

DSA Stamp

Architect




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1501 California Avenue
Santa Monica, California 90403

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Consultants



Sheet Title
Building 'G'
Mechanical Plans

Sheet Number

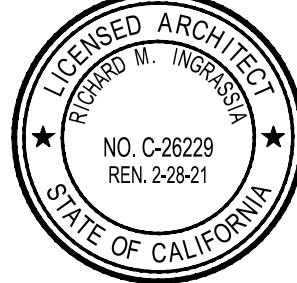MG201

DUCT CLEANING GENERAL NOTES

CLEANING ALL DUCT INTERIORS AS FOLLOW :

- (1) CLEAN DUCT SYSTEM AND FORCE AIR AT HIGH VELOCITY THROUGH DUCT TO REMOVE ACCUMULATED DUST. TO OBTAIN SUFFICIENT AIR FLOW, CLEAN ONE HALF OF SYSTEM COMPLETELY BEFORE PROCEEDING TO OTHER HALF. PROTECT EQUIPMENT WITH POTENTIAL TO BE HARMED BY EXCESSIVE DIRT WITH TEMPORARY FILTERS, OR BYPASS DURING CLEANING.
- (2) CLEAN DUCT SYSTEM WITH HIGH POWER VACUUM MACHINES. PROTECT EQUIPMENT WITH POTENTIAL TO BE HARMED BY EXCESSIVE DIRT WITH FILTERS, OR BYPASS DURING CLEANING. INSTALL ACCESS OPENING INTO DUCTWORK FOR CLEANING PURPOSES.


KEYNOTES

- 1 WALL MOUNTED FAN COIL UNIT. INSTALL PER MANUFACTURER'S RECOMMENDATIONS. COORDINATE LOCATION W/ ALL OTHER TRADES. ENSURE PROPER ACCESS SPACE FOR MAINTENANCE. FOR MOUNTING DETAIL SEE -M-. RUN REFRIGERANT LINES TO CORRESPONDING CONDENSER UNIT PER MANUFACTURER RECOMMENDATION.
- 2 3'-4"x3'-6" RETURN AIR PLENUM BELOW FAN COIL UNIT.
- 3 48"x14" OSA INTAKE LOUVER.
- 4 6"Ø OSA DUCT W/ 1" LINING UP THRU ROOF. PROVIDE ROOF JACK WITH WIRE MESH SCREEN.
- 5 REUSE PREVIOUS WALL OPENING FOR NEW LOUVER.
- 6 PROVIDE BAROMETRIC RELIEF AIR DAMPER. SET DAMPER TO OPEN AT 0.05" PRESSURE.
- 7 48" (L) x 22" (W) x 14" (H) OSA PLENUM.
- 8 18"x6" SAG 400 CFM (TYP 4.)
- 9 PRICE SDG MODEL WITH AIR SCOOP (AS), DOUBLE DEFLECTION. (TYP.)
- 10 12"x10" OSA INTAKE DUCT W/ 1" LINING DN & CONNECT TO RETURN AIR PLENUM.

Architect




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1 MECHANICAL PLAN

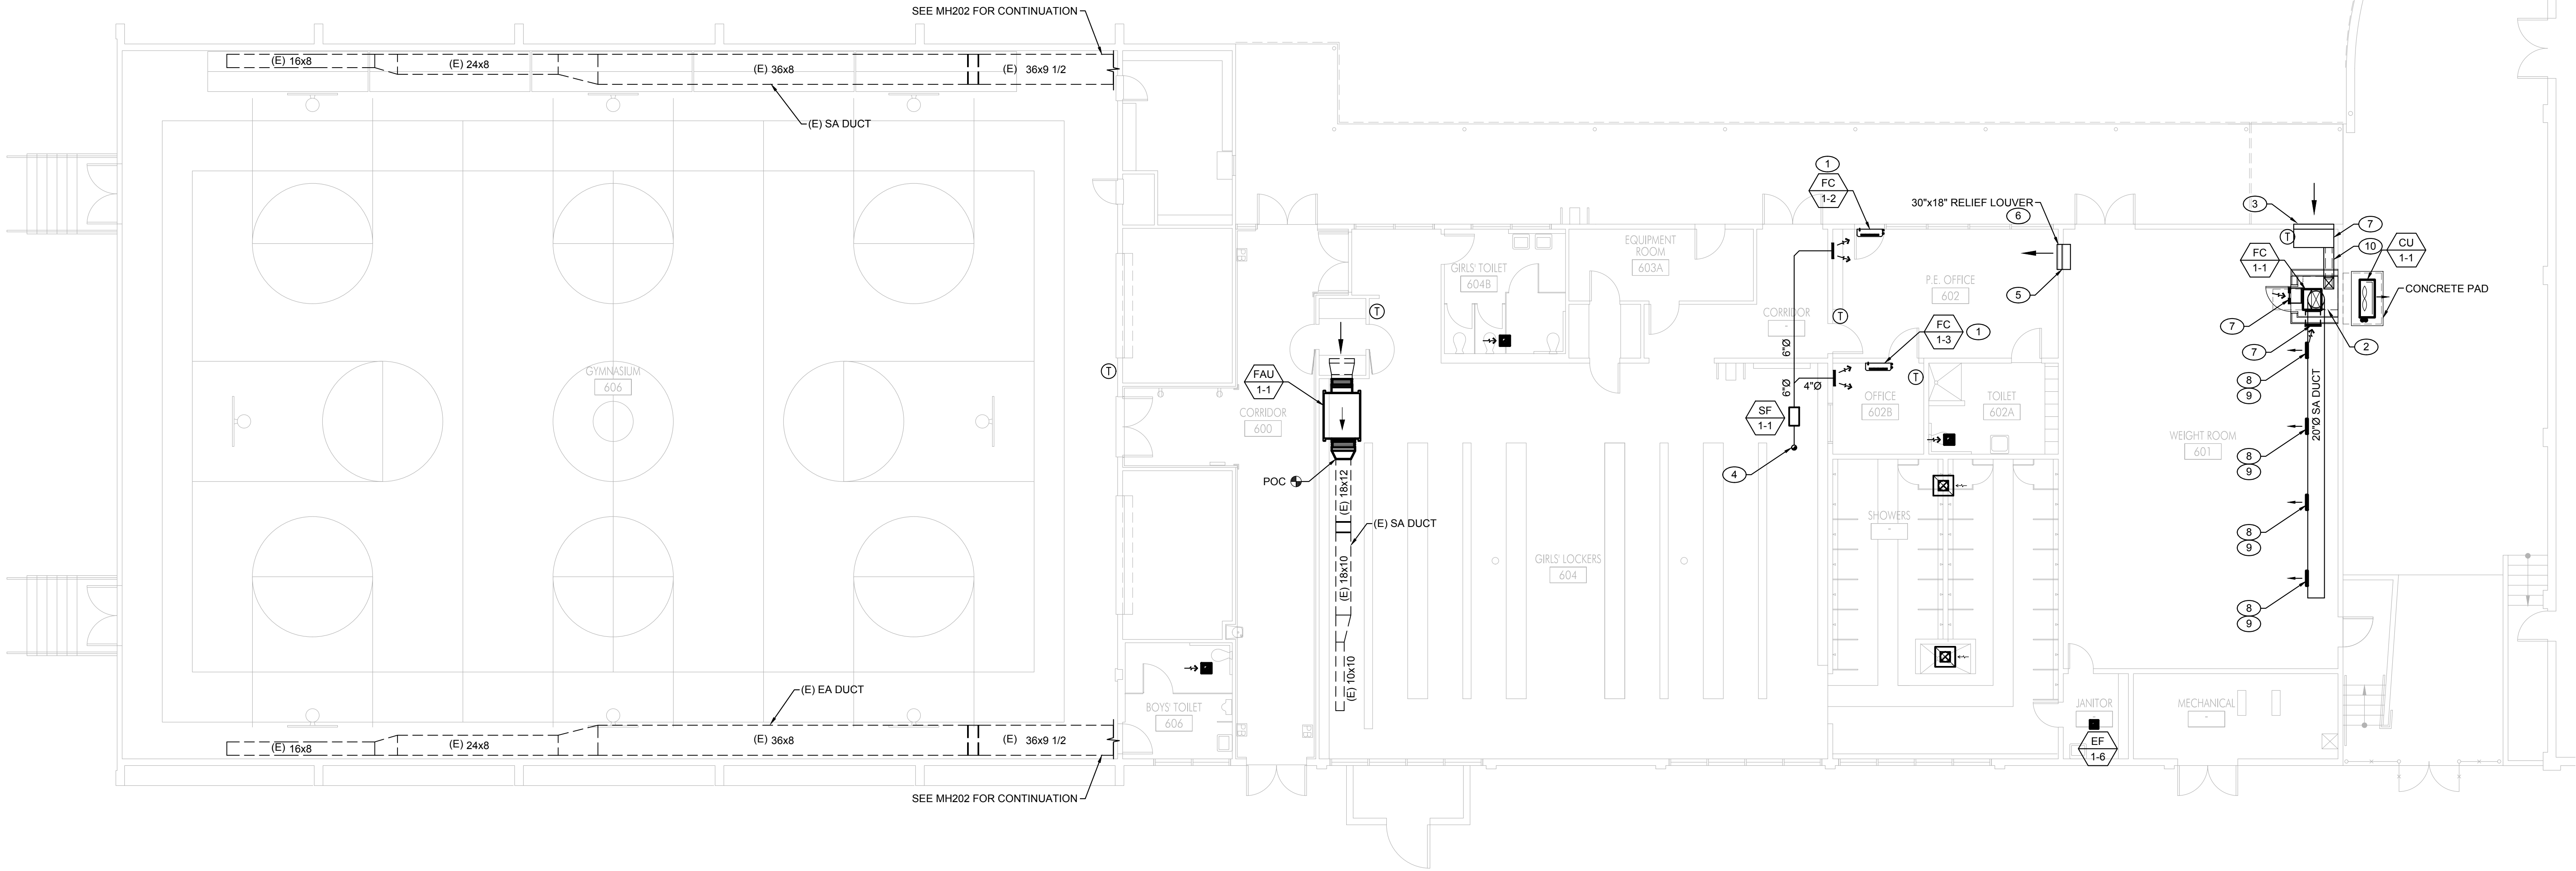

SCALE: 1/8"=1'-0"




KEY PLAN

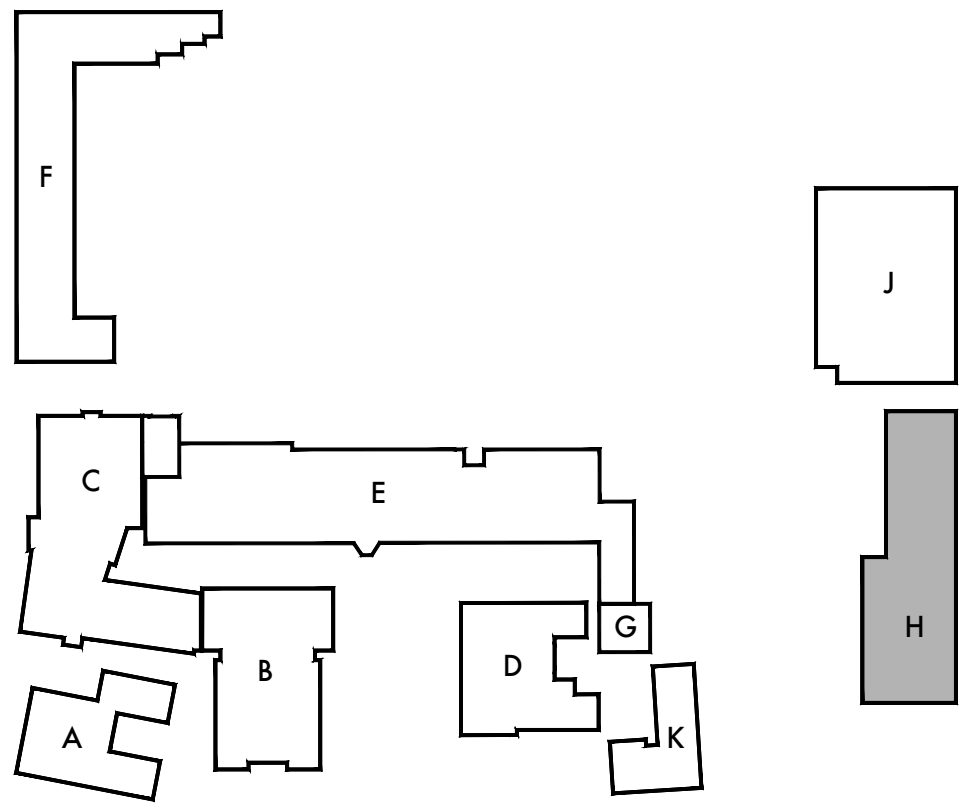Rev	Date	Issue
1	07.22.19	-

Date:
Scale: As Shown
Drawn By: DH, RM
Checked By: RI

Architect / Engineer Stamp

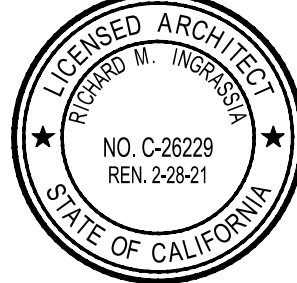

Consultants



Sheet Title
Building 'H'
Mechanical Plan

Sheet Number

MH201

KEYNOTES

1 10"Ø OSA DUCT W/ 1" LINING DN THRU ROOF. PROVIDE ROOF JACK WITH WIRE MESH SCREEN.

Architect




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Lincoln Middle School
1501 California Avenue
Santa Monica, California 90403

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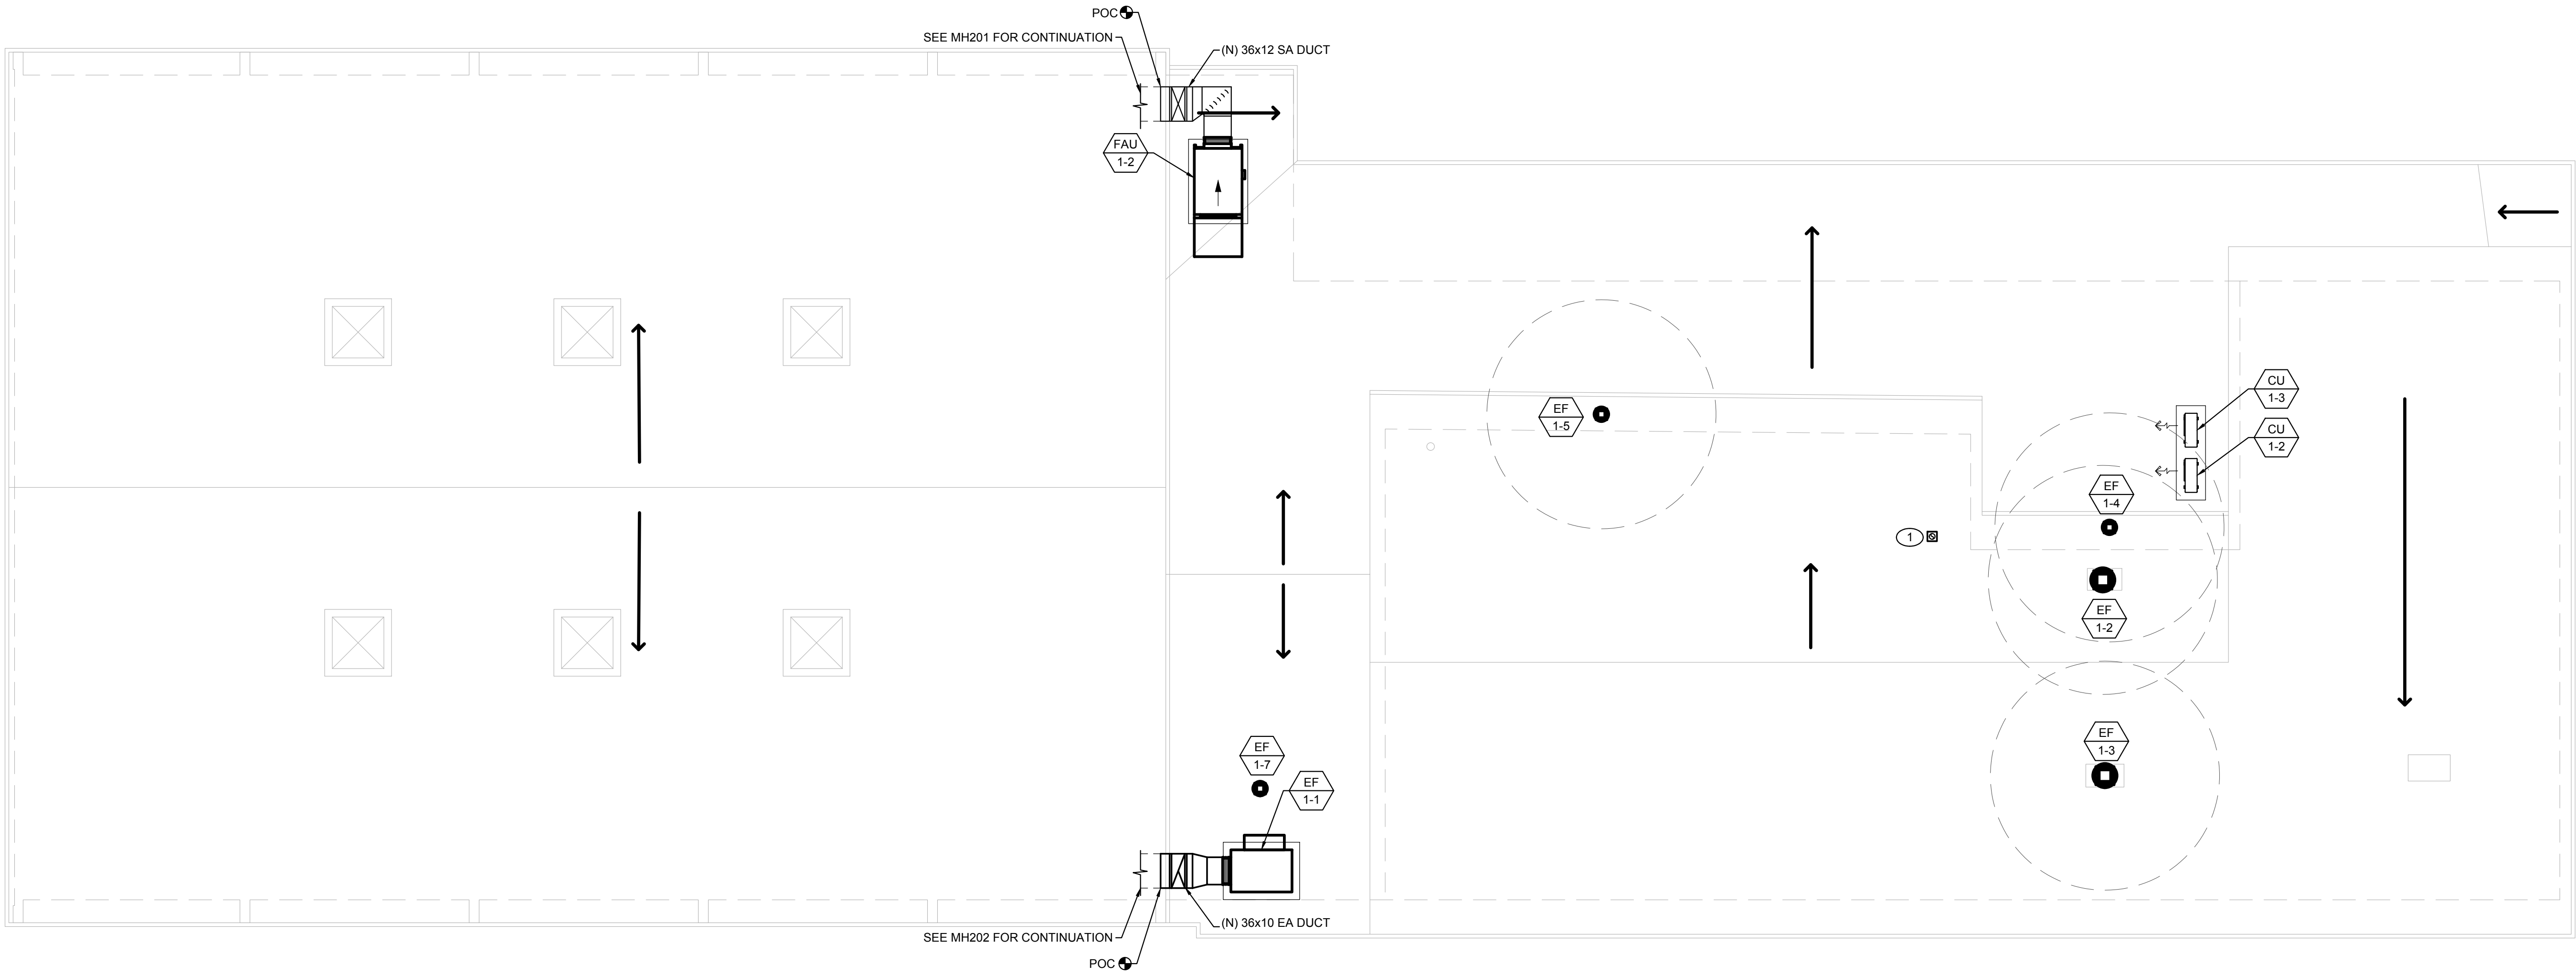
421 East Huntington Drive
Monrovia, California 91016
P: 626.930.1383 F: 626.930.1385
Project No. 19009

Sheet Title


Building 'H'
Mechanical Roof
Plan

Sheet Number

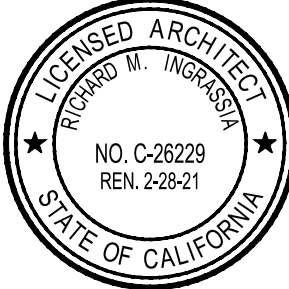MH202



SCALE: 1/8"=1'-0"

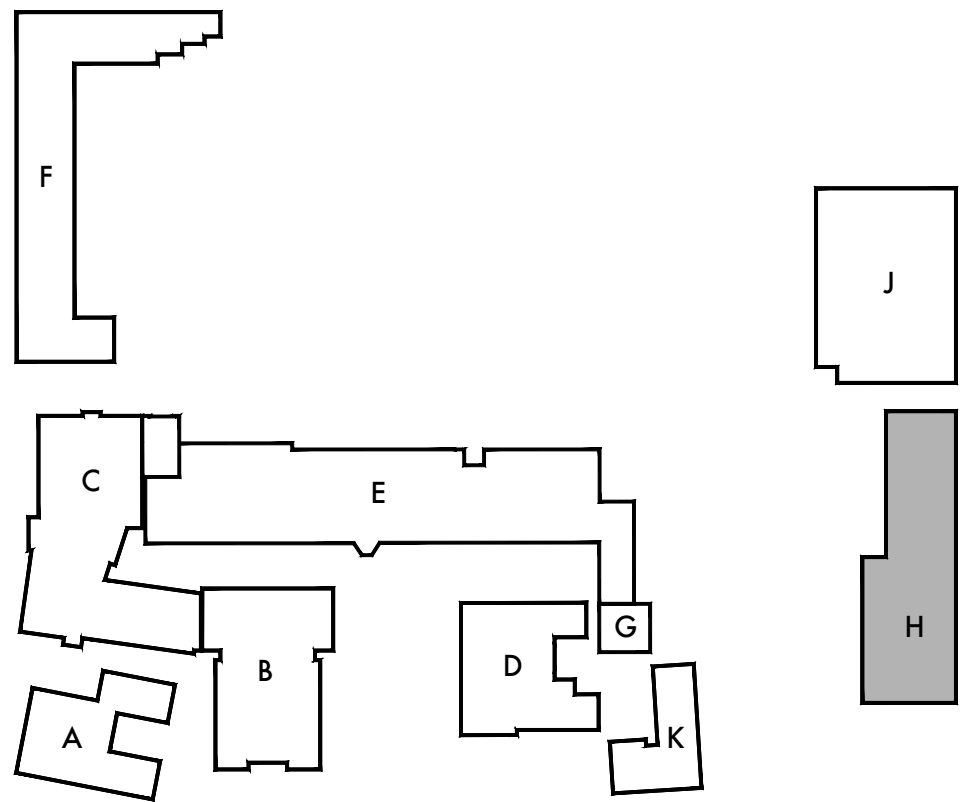

KEY PLAN

KEYNOTES

- 1
- REMOVE (E) GAS FURNACE UNITS, DUCTWORK, GAS PIPES, SUPPORTS, ENTIRE ASSOCIATED COMBUSTION AIR, OSA INTAKE LOUVER AND FLUE PIPES UP THRU ROOF. PATCH AND REPAIR EXISTING WALLS, CEILING, ROOF AS NEEDED.

Architect




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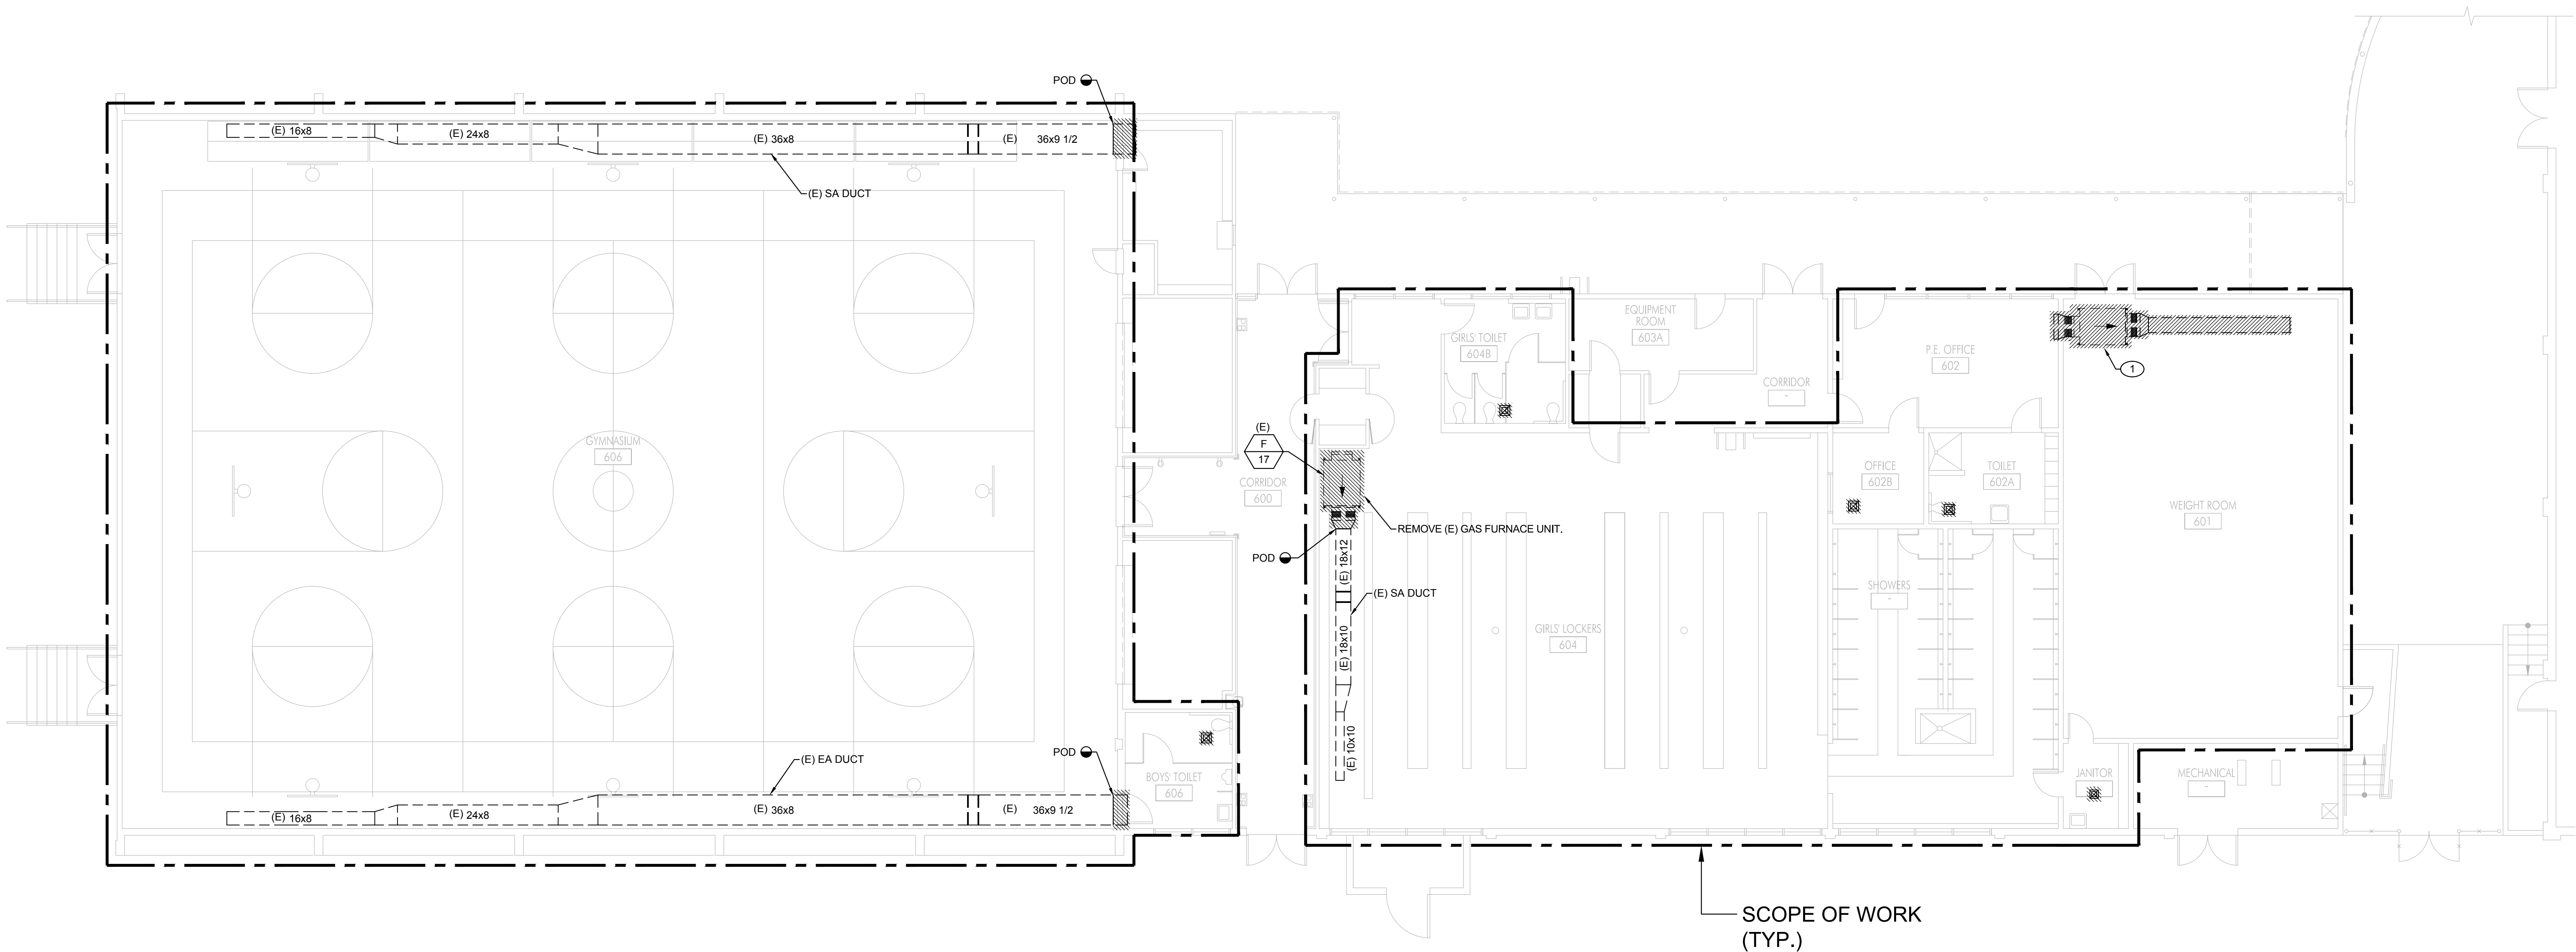
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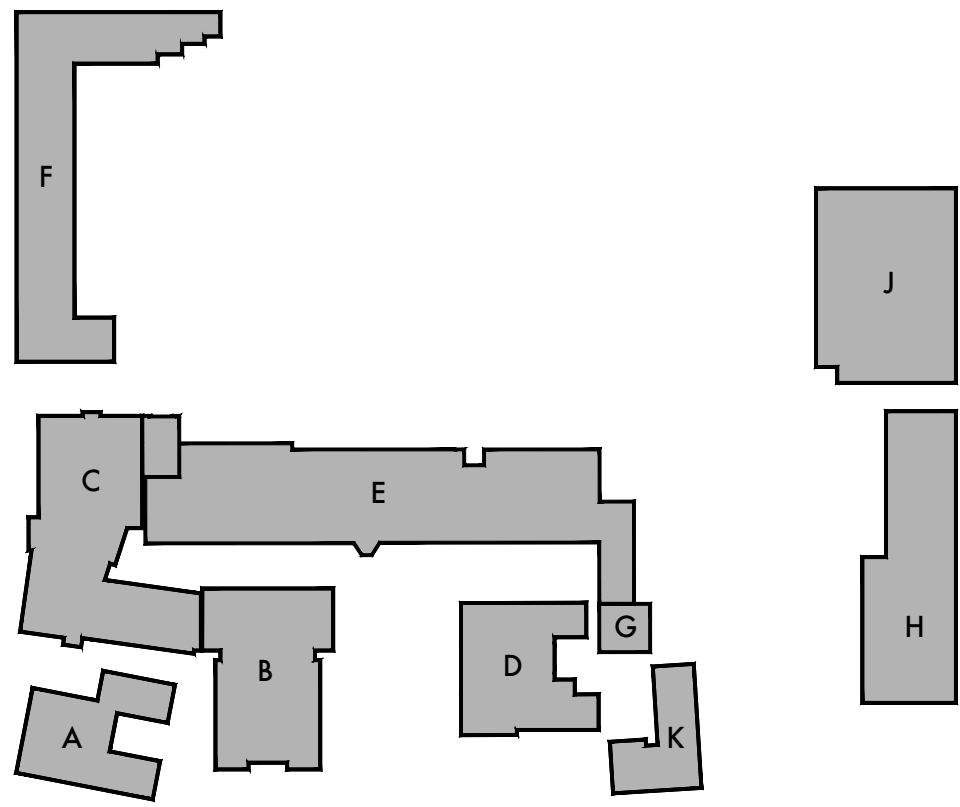
Sheet Title
Building 'H'
Mechanical
Demolition Plan

Sheet Number

MHD201



SCALE: 1/8"=1'-0"

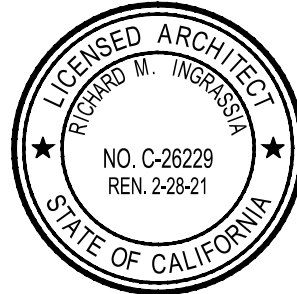

KEY PLAN

Architect




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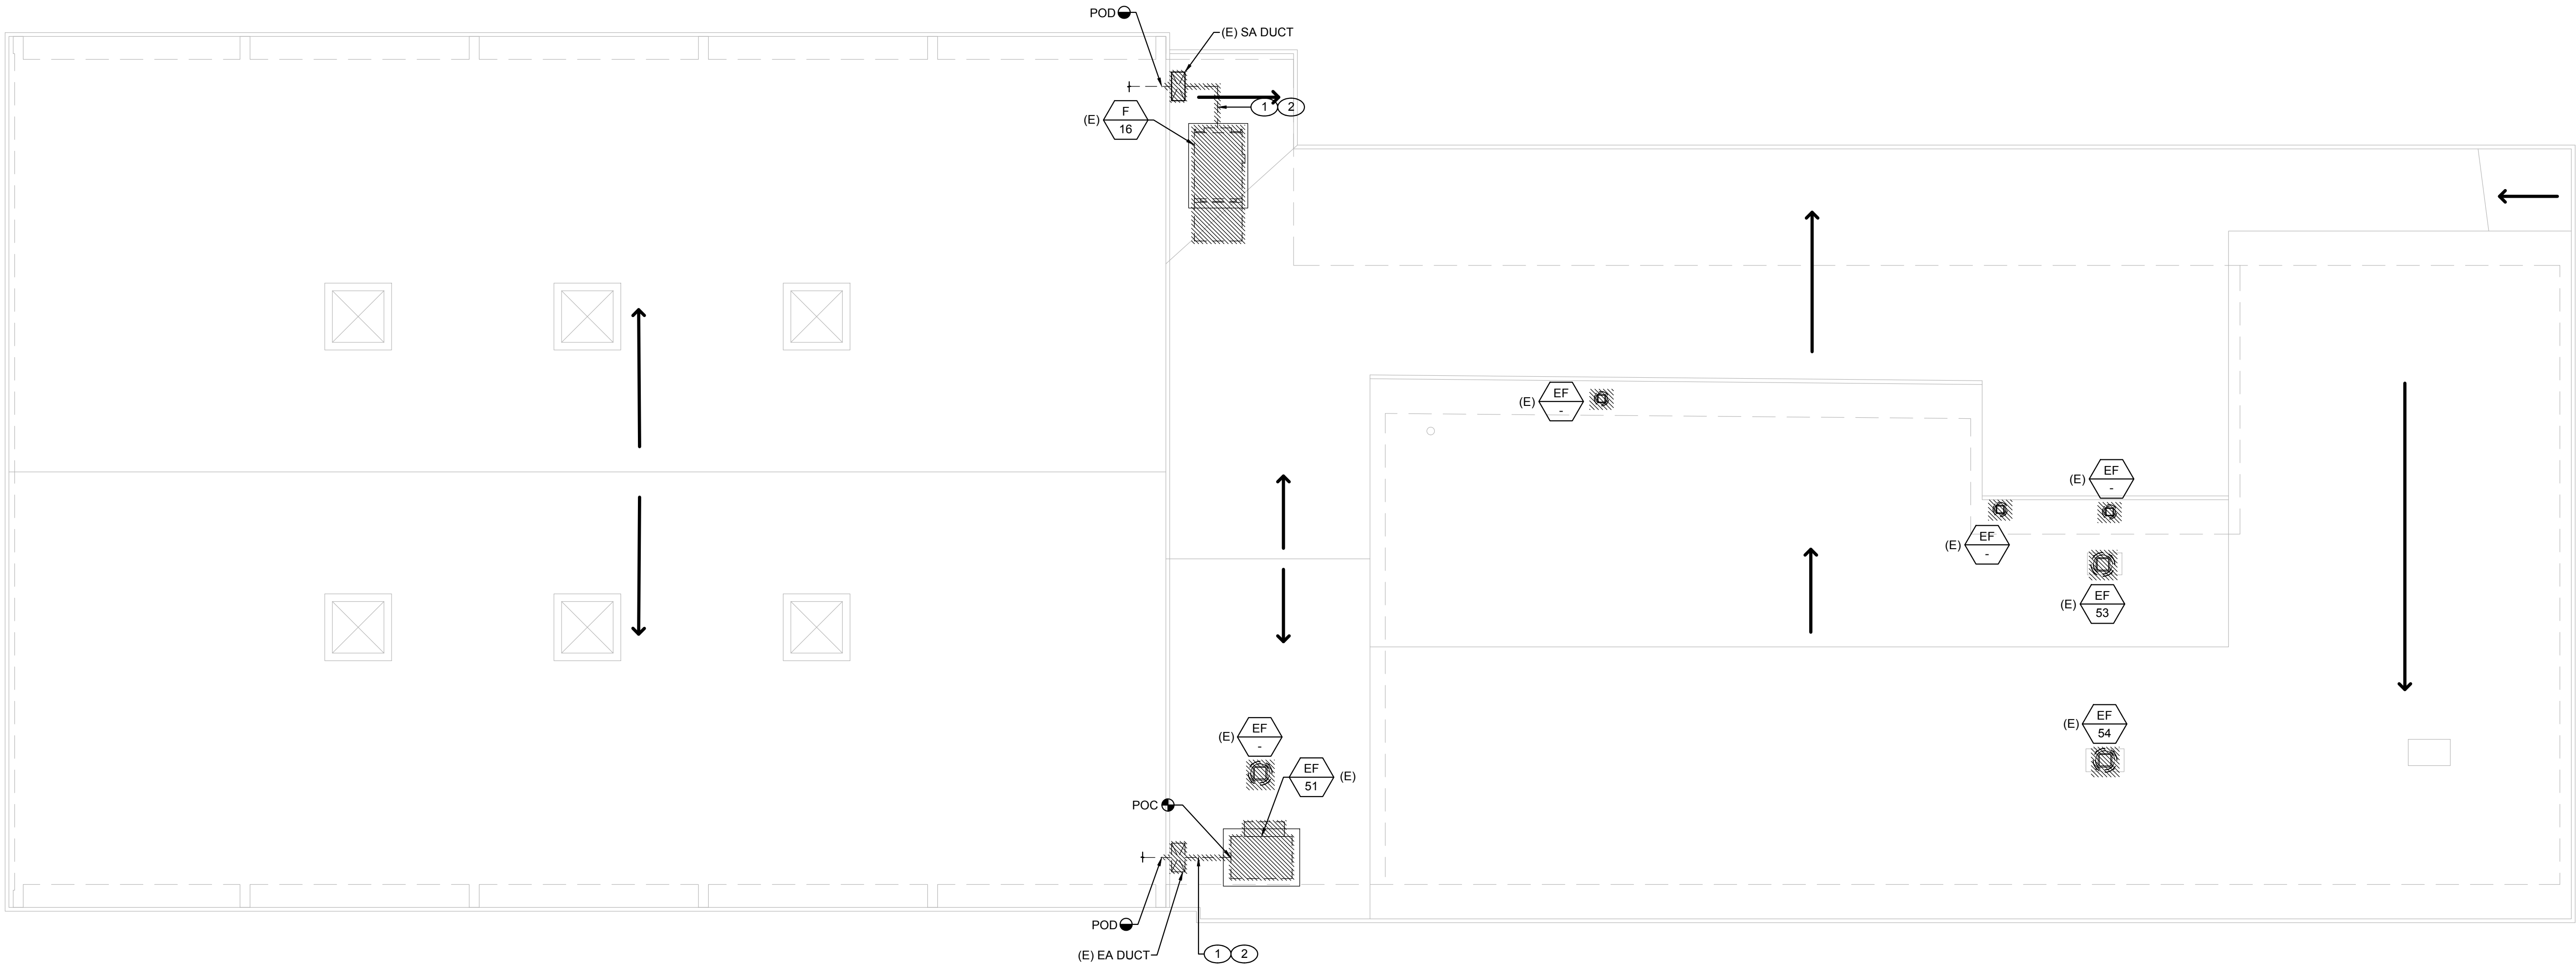
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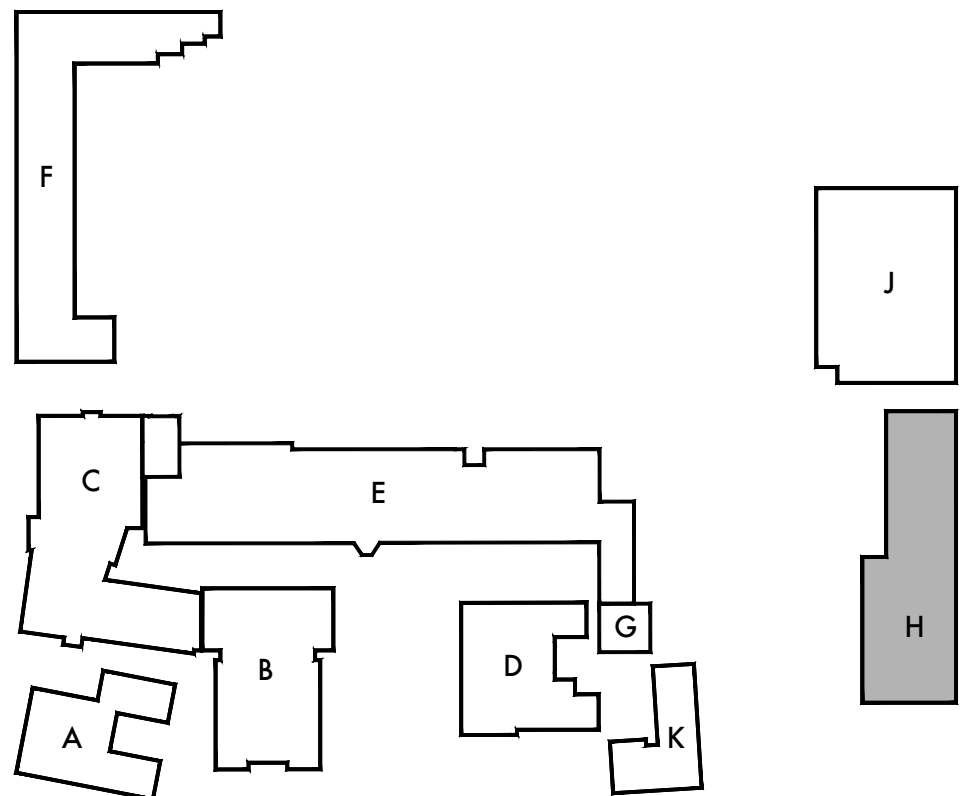
Building 'H'
Mechanical Roof
Demolition Plan

Sheet Number

MHD202



SCALE: 1/8"=1'-0"

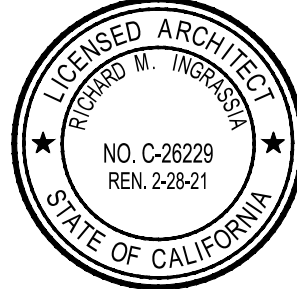


KEY PLAN

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KEYNOTES

- 1 NEW FAN COIL UNIT CLOSET. REFER TO ARCHITECTURAL DRAWING. MIN. 4'-0"x4'-0" CLEAR INSIDE DIMENSION.
- 2 18"x24" OSA INTAKE LOUVER.
- 3 24"x18" OSA INTAKE LOUVER.
- 4 PROVIDE BAROMETRIC RELIEF AIR DAMPER. SET DAMPER TO OPEN AT 0.05" PRESSURE.
- 5 14"x10" OSA INTAKE DUCT W/ 1" LINING DN & CONNECT TO RETURN AIR PLENUM.
- 6 14" (L) x 18" (W) x 24" (H) OSA PLENUM.
- 7 18"x8" MAKE-UP AIR DUCT UP THRU ROOF.
- 8 18"x8" OSA INTAKE DUCT W/ 1" LINING DN & CONNECT TO RETURN AIR PLENUM.
- 9 3'-4"x3'-6" RETURN AIR PLENUM BELOW FAN COIL UNIT.

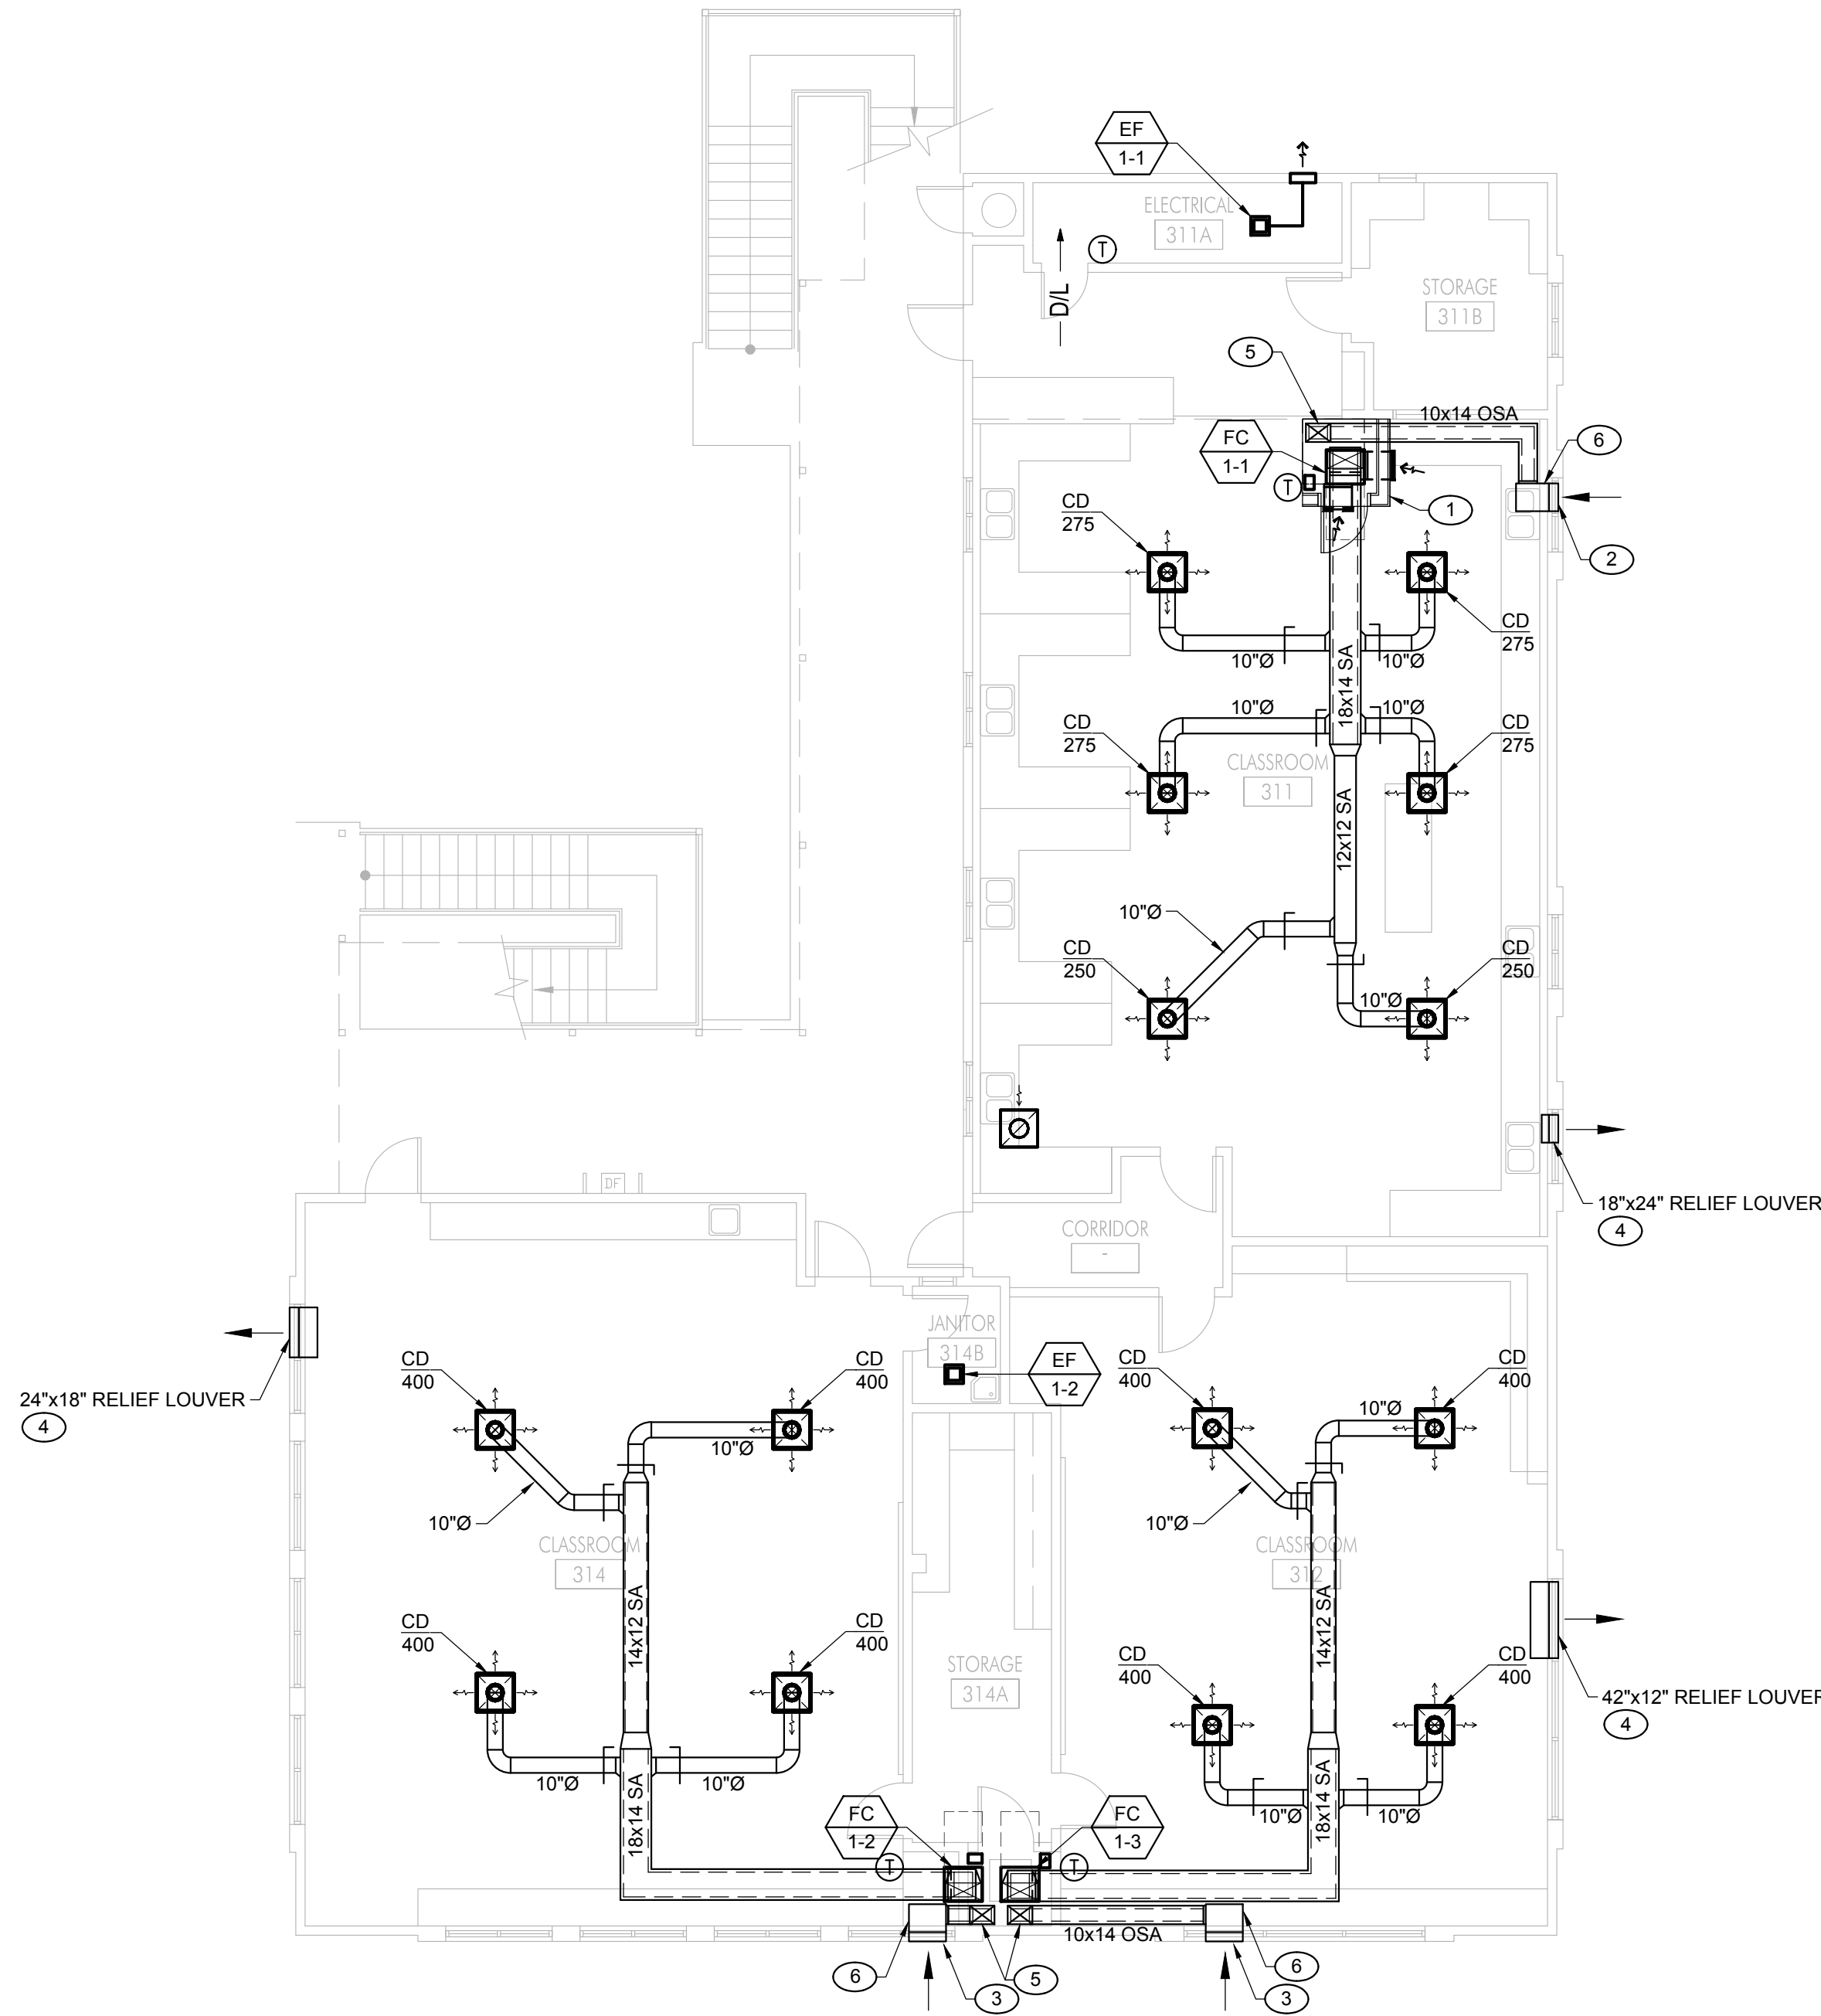


SCALE: 1/8"=1'-0"

1 FIRST FLOOR MECHANICAL PLAN


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- 6 14" (L) x 18" (W) x 24" (H) OSA PLENUM.
- 7 18"x8" MAKE-UP AIR DUCT UP THRU ROOF.
- 8 18"x8" OSA INTAKE DUCT W/ 1" LINING DN & CONNECT TO RETURN AIR PLENUM.
- 9 3'-4"x3'-6" RETURN AIR PLENUM BELOW FAN COIL UNIT.

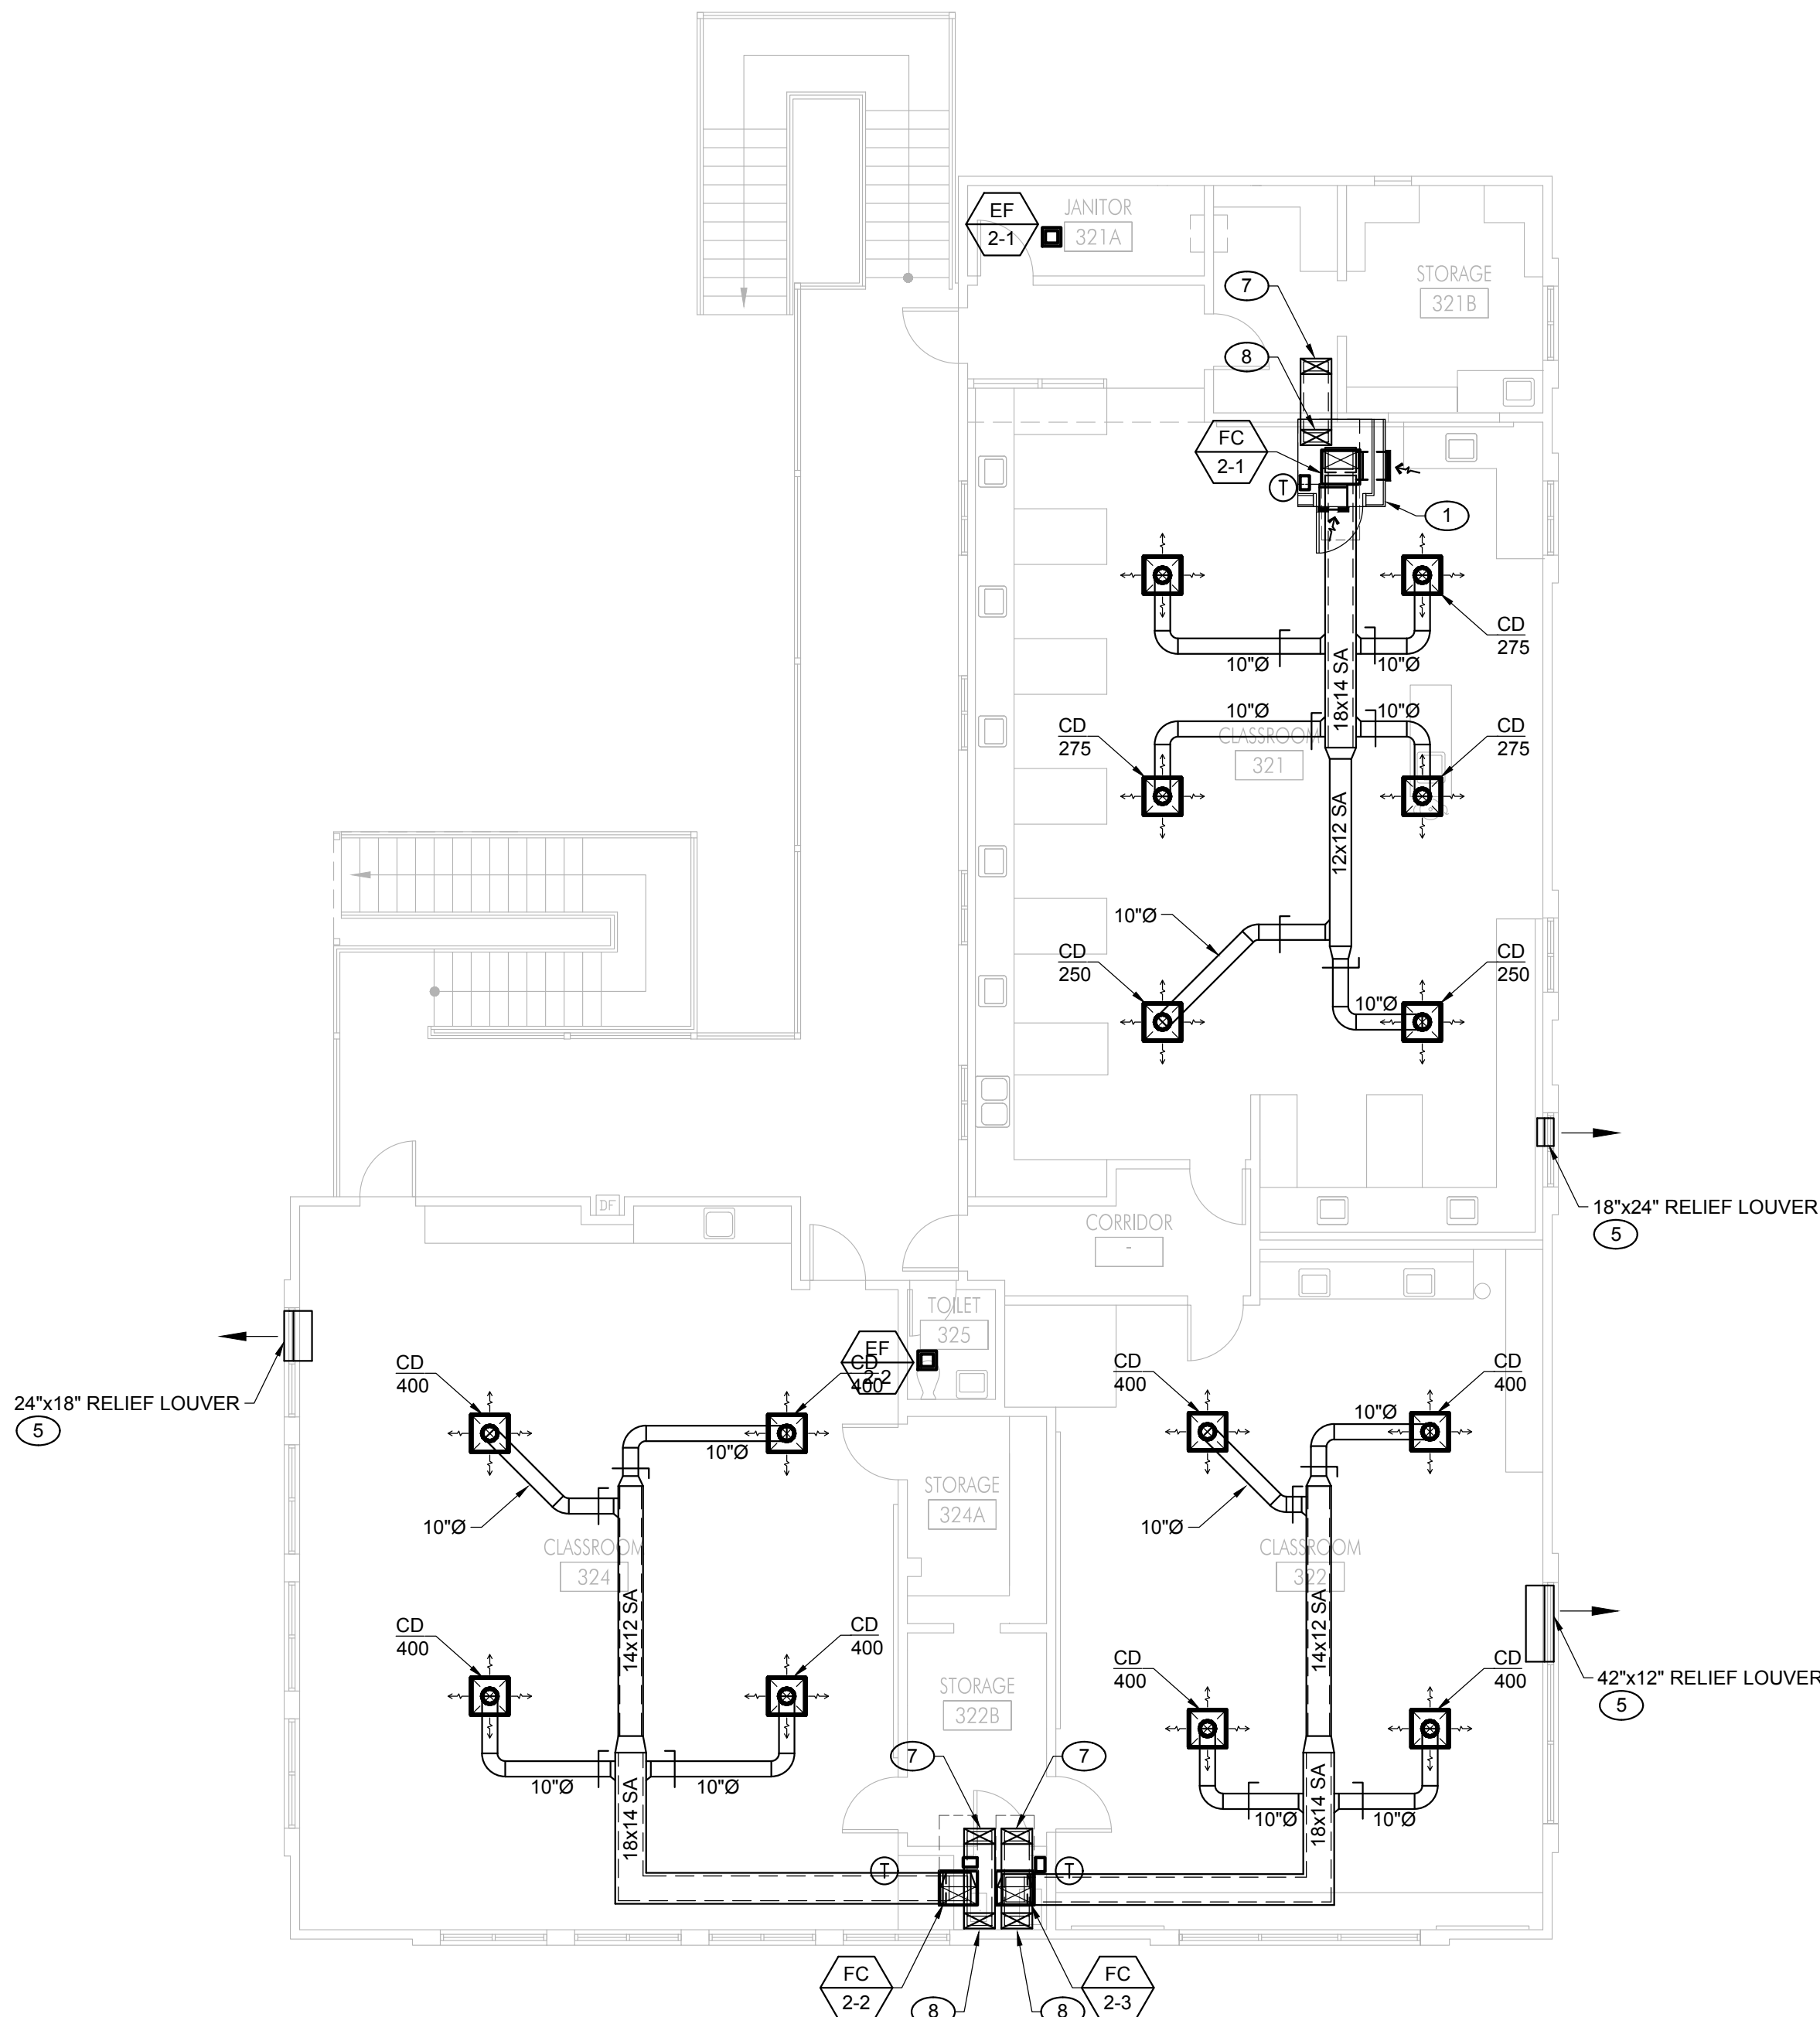

SCALE: 1/8"=1'-0"

2 SECOND FLOOR MECHANICAL PLAN

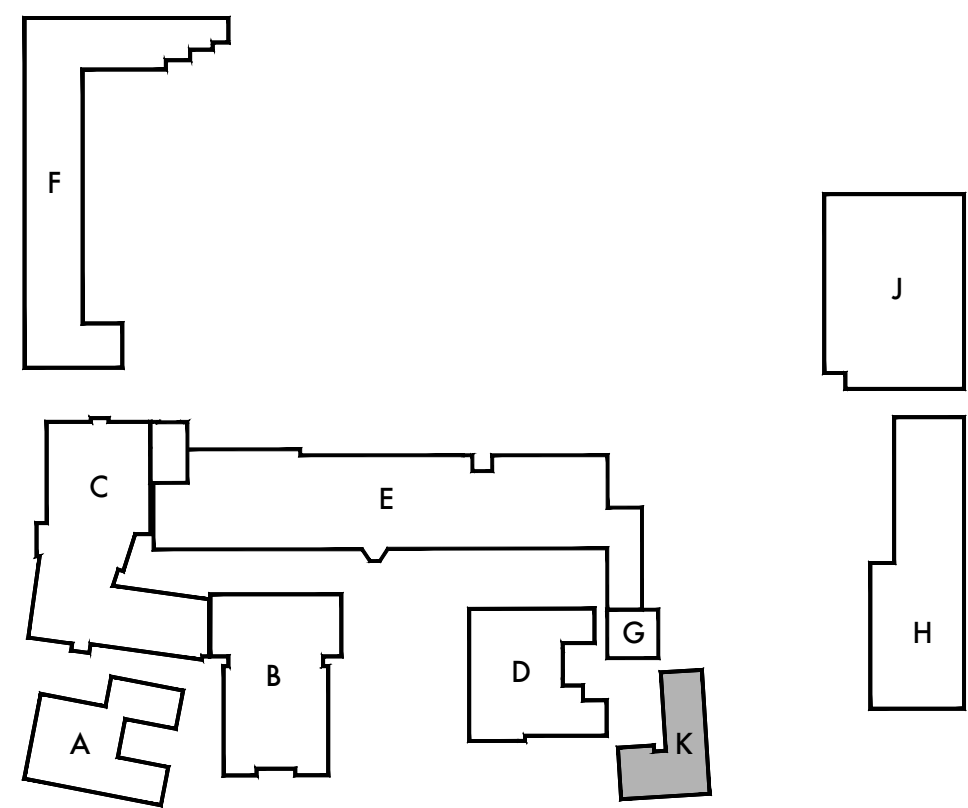

KEY PLAN

DSA Stamp

Architect




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Checked By: RI

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Consultants



Sheet Title
Building 'K'
Mechanical Plans

Sheet Number

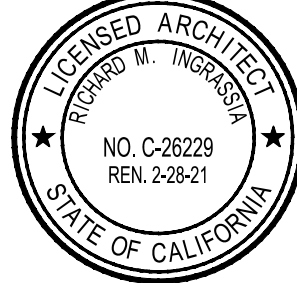MK201

KEYNOTES

- 1
- 12"x10" OSA DUCT W/ 1" LINING DN THRU ROOF, OFFSET DUCT & CONNECT TO RETURN AIR FLENUM. PROVIDE ROOF JACK WITH WIRE MESH SCREEN.

Architect




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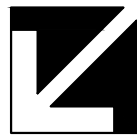
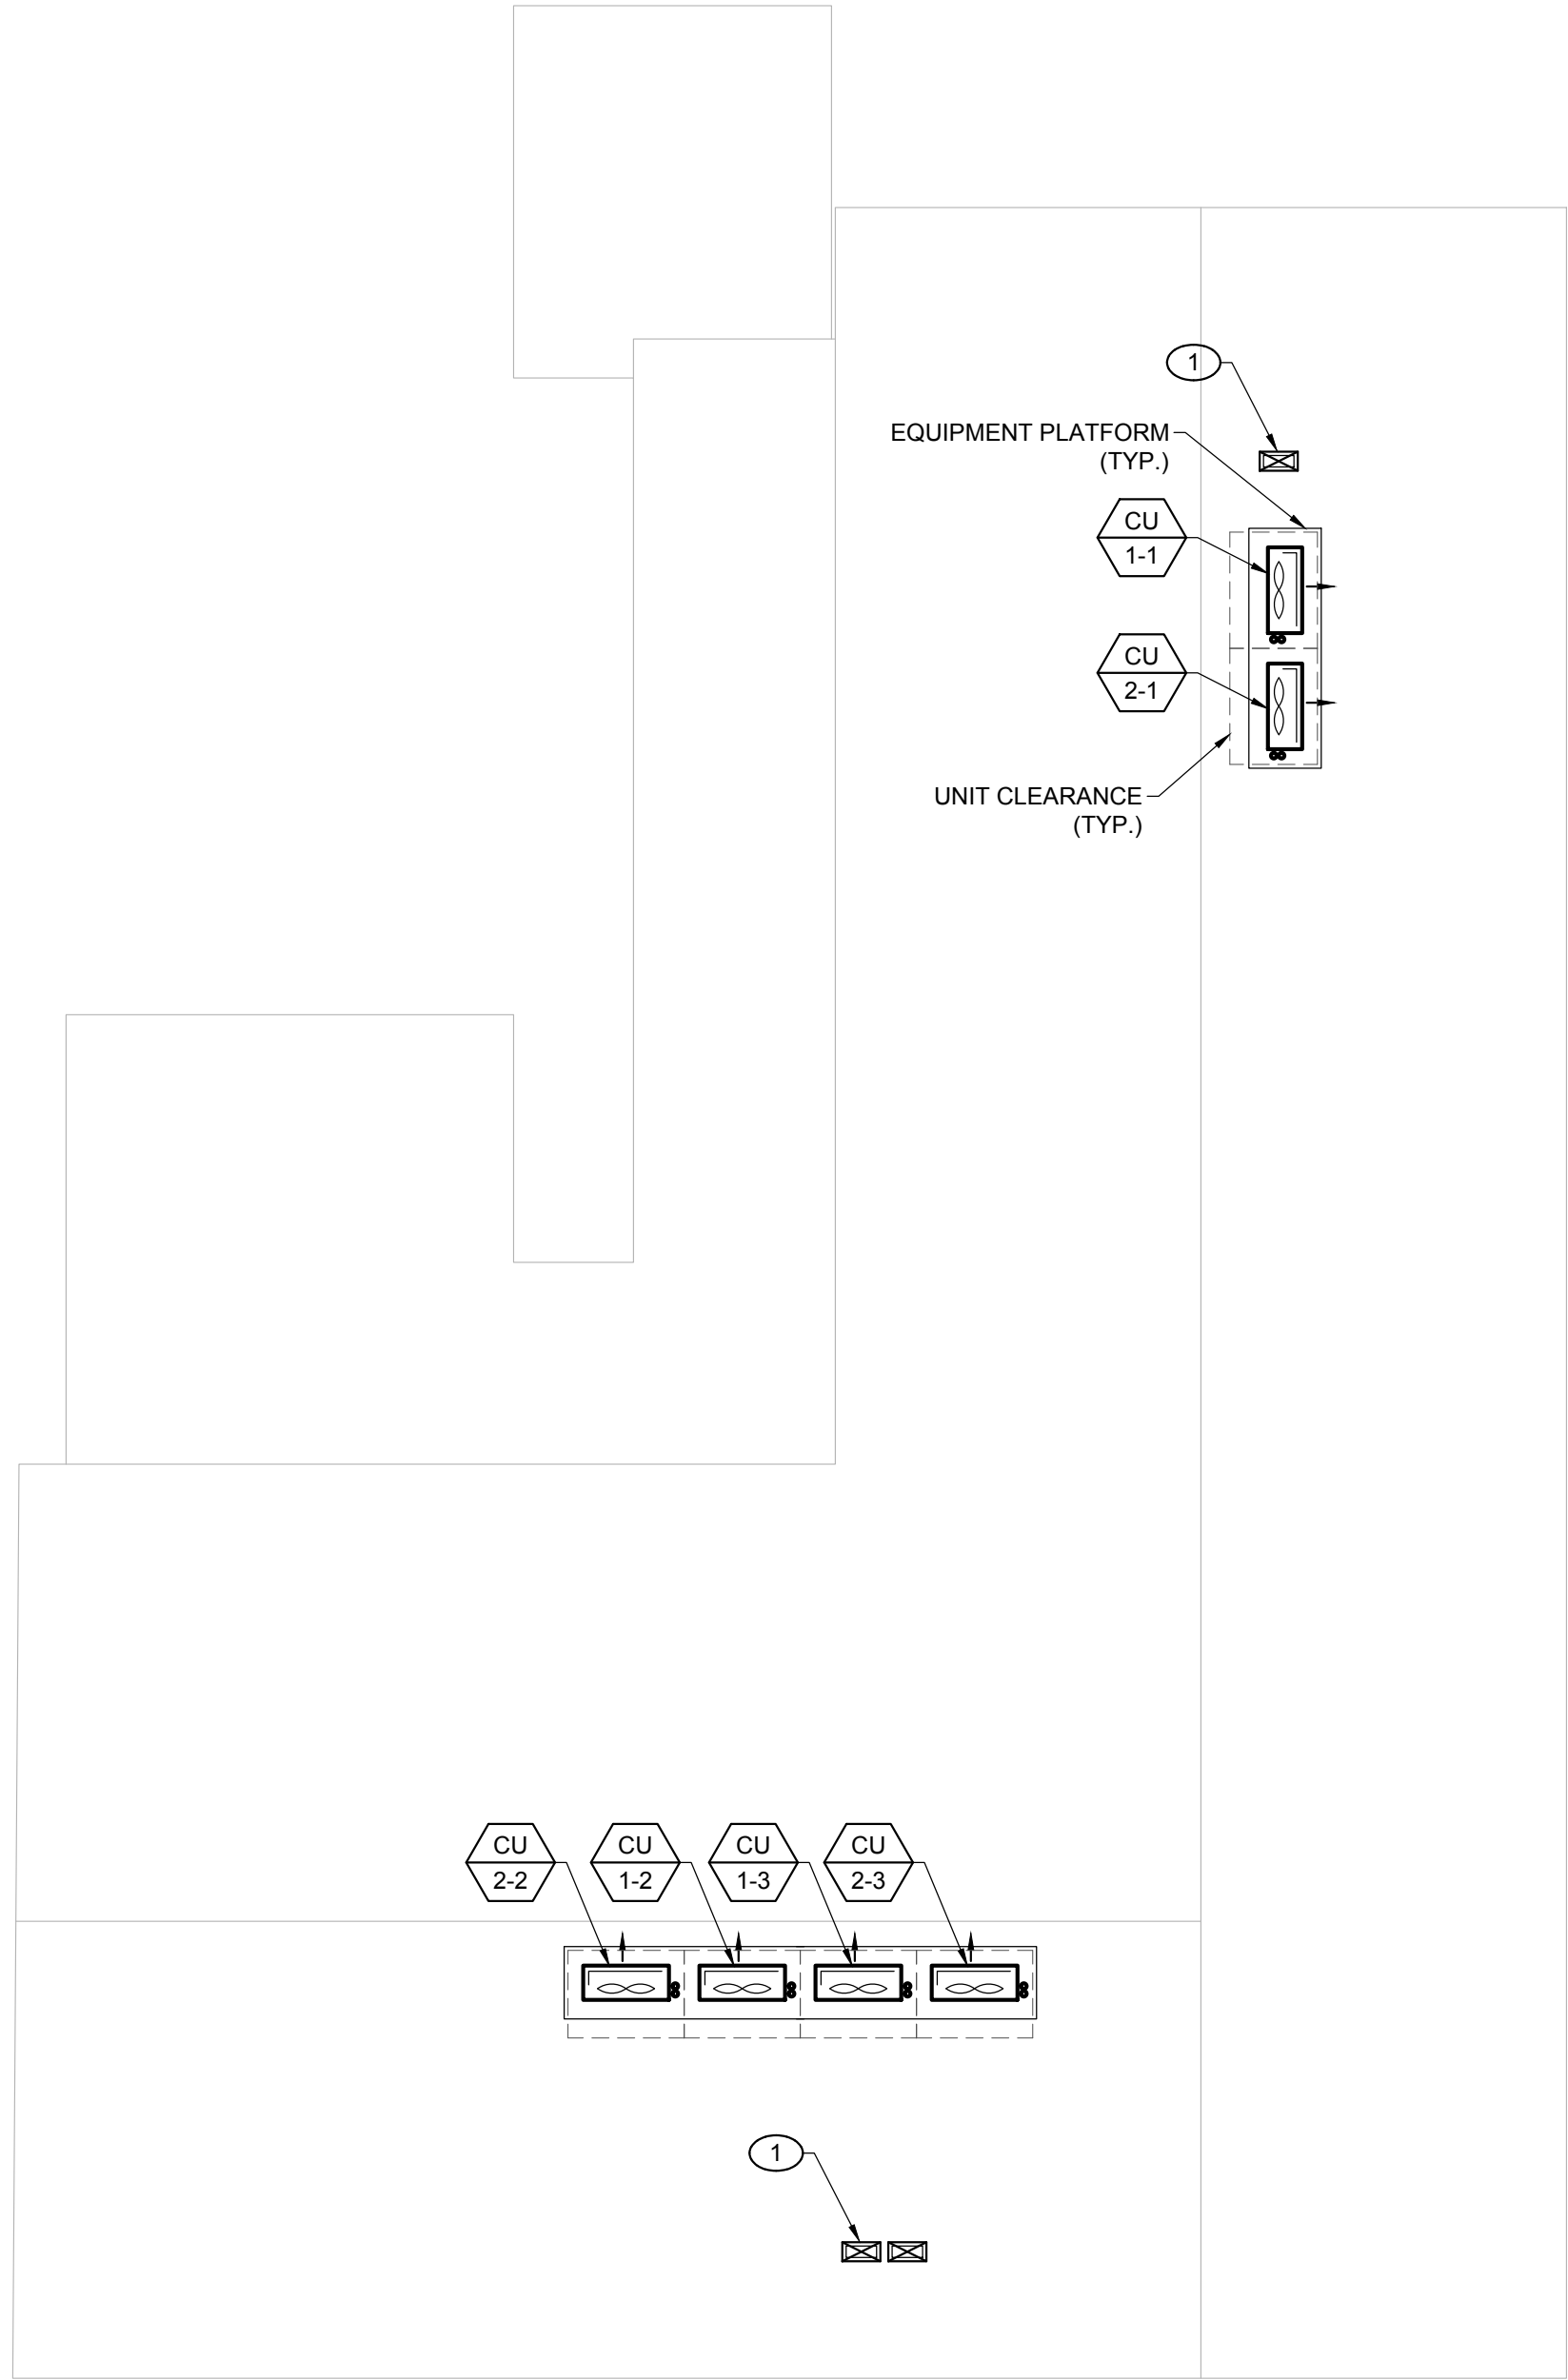
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Project No. 19009

Sheet Title

Building 'K'
Mechanical
Roof Plan


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MK202

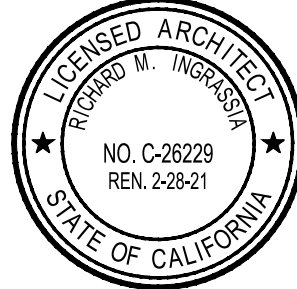

SCALE: 1/8"=1'-0"

1 MECHANICAL ROOF PLAN

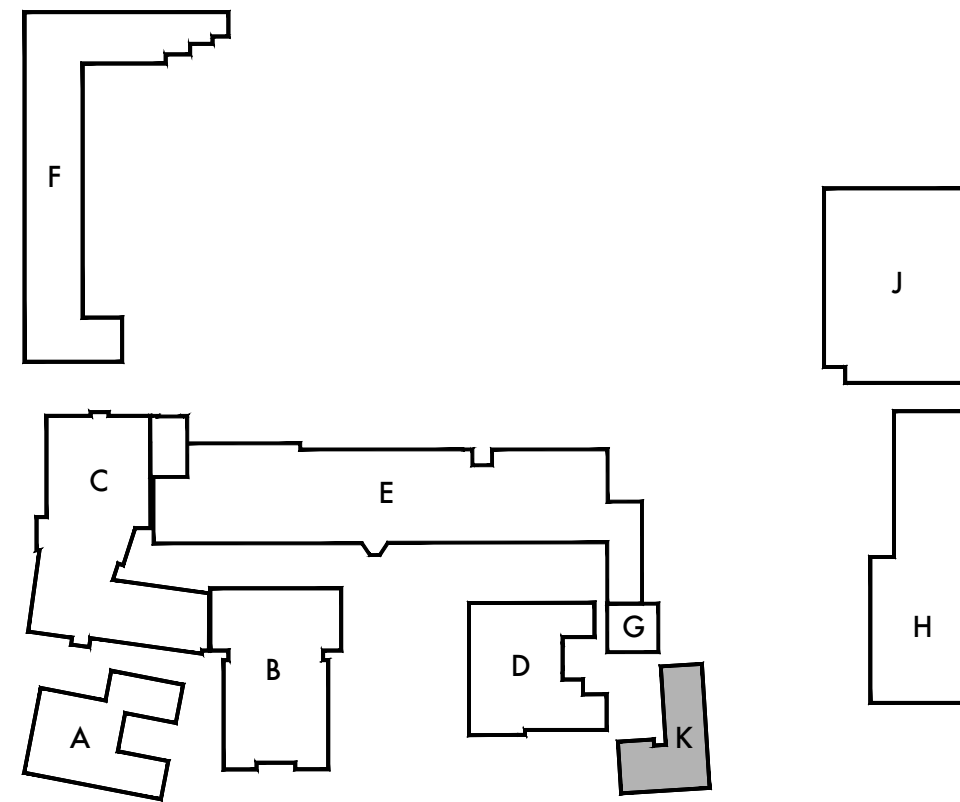


KEY PLAN

CDC

KEYNOTES

- 1 REMOVE (E) HEATING AND VENTILATION SYSTEM, DUCTWORK, PIPING SUPPORTS, THERMOSTAT, CONTROL AND ACCESSORIES WITHIN THE SCOPE OF WORK AREA UNLESS OTHERWISE NOTED. PATCH AND REPAIR EXISTING WALLS, CEILING, FLOOR AS NEEDED.

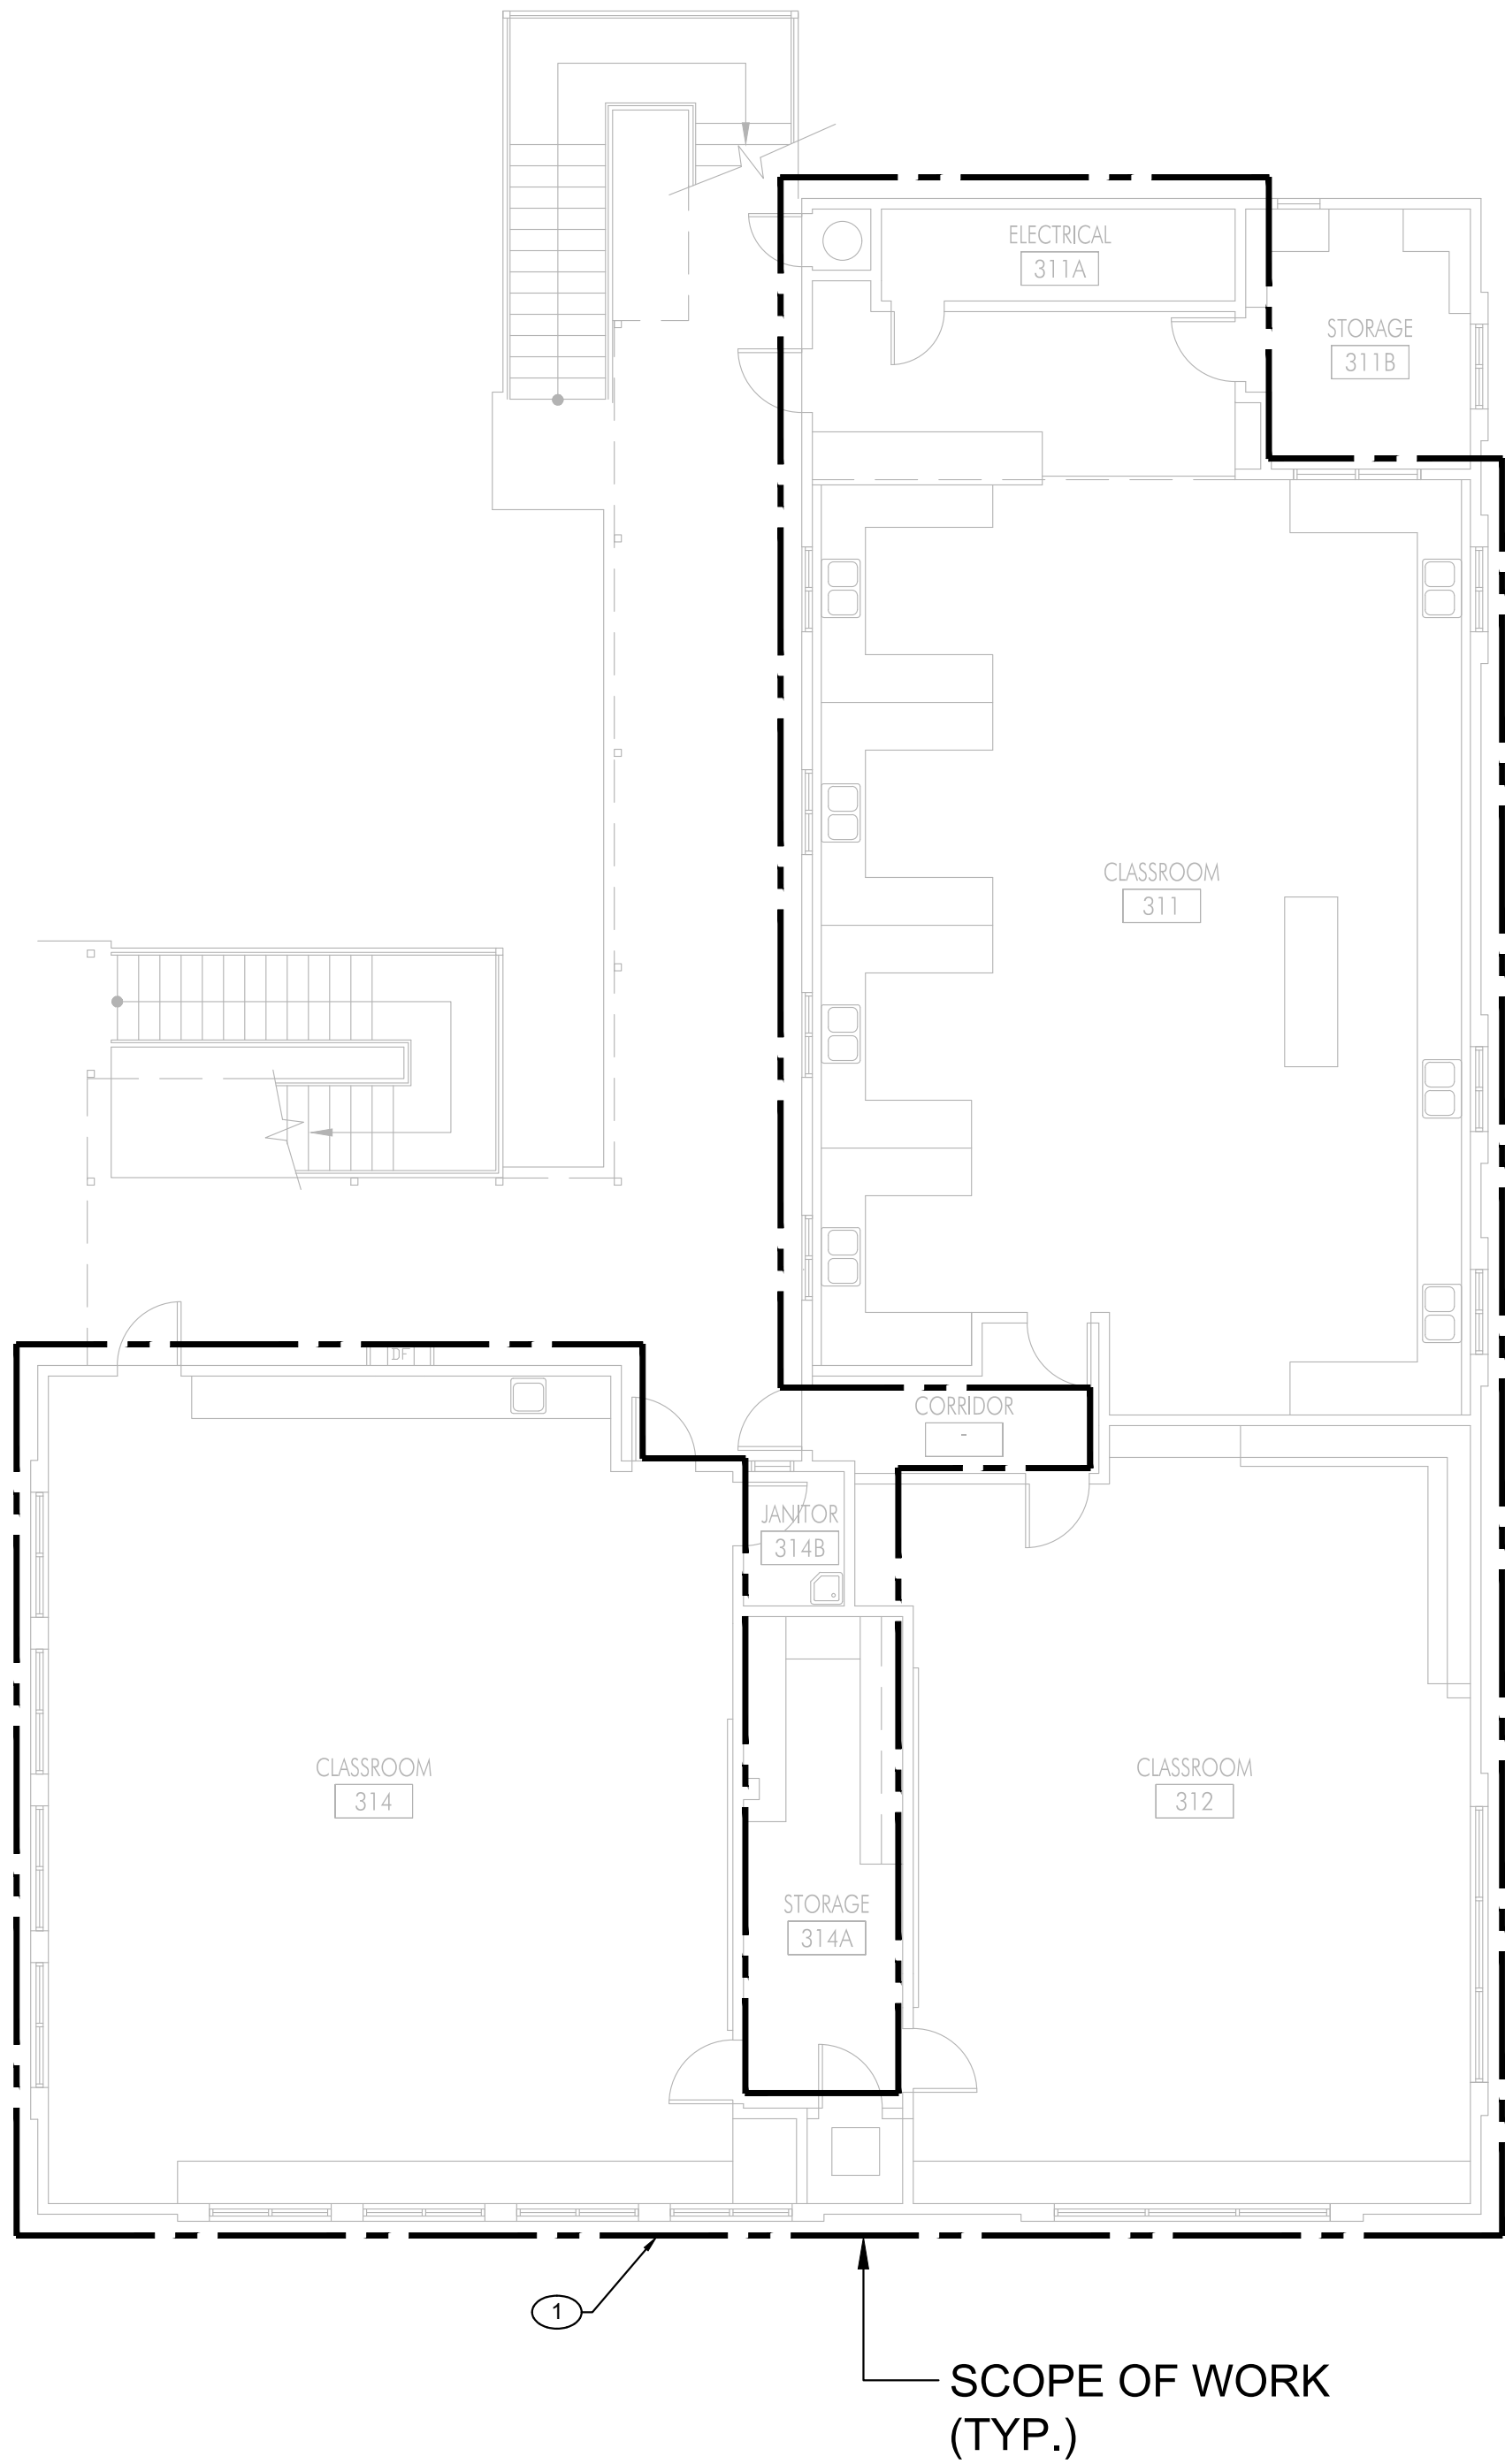


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1 FIRST FLOOR MECHANICAL DEMOLITION PLAN


KEYNOTES

- 1 REMOVE (E) HEATING AND VENTILATION SYSTEM, DUCTWORK, PIPING SUPPORTS, THERMOSTAT, CONTROL AND ACCESSORIES WITHIN THE SCOPE OF WORK AREA UNLESS OTHERWISE NOTED. PATCH AND REPAIR EXISTING WALLS, CEILING, FLOOR AS NEEDED.

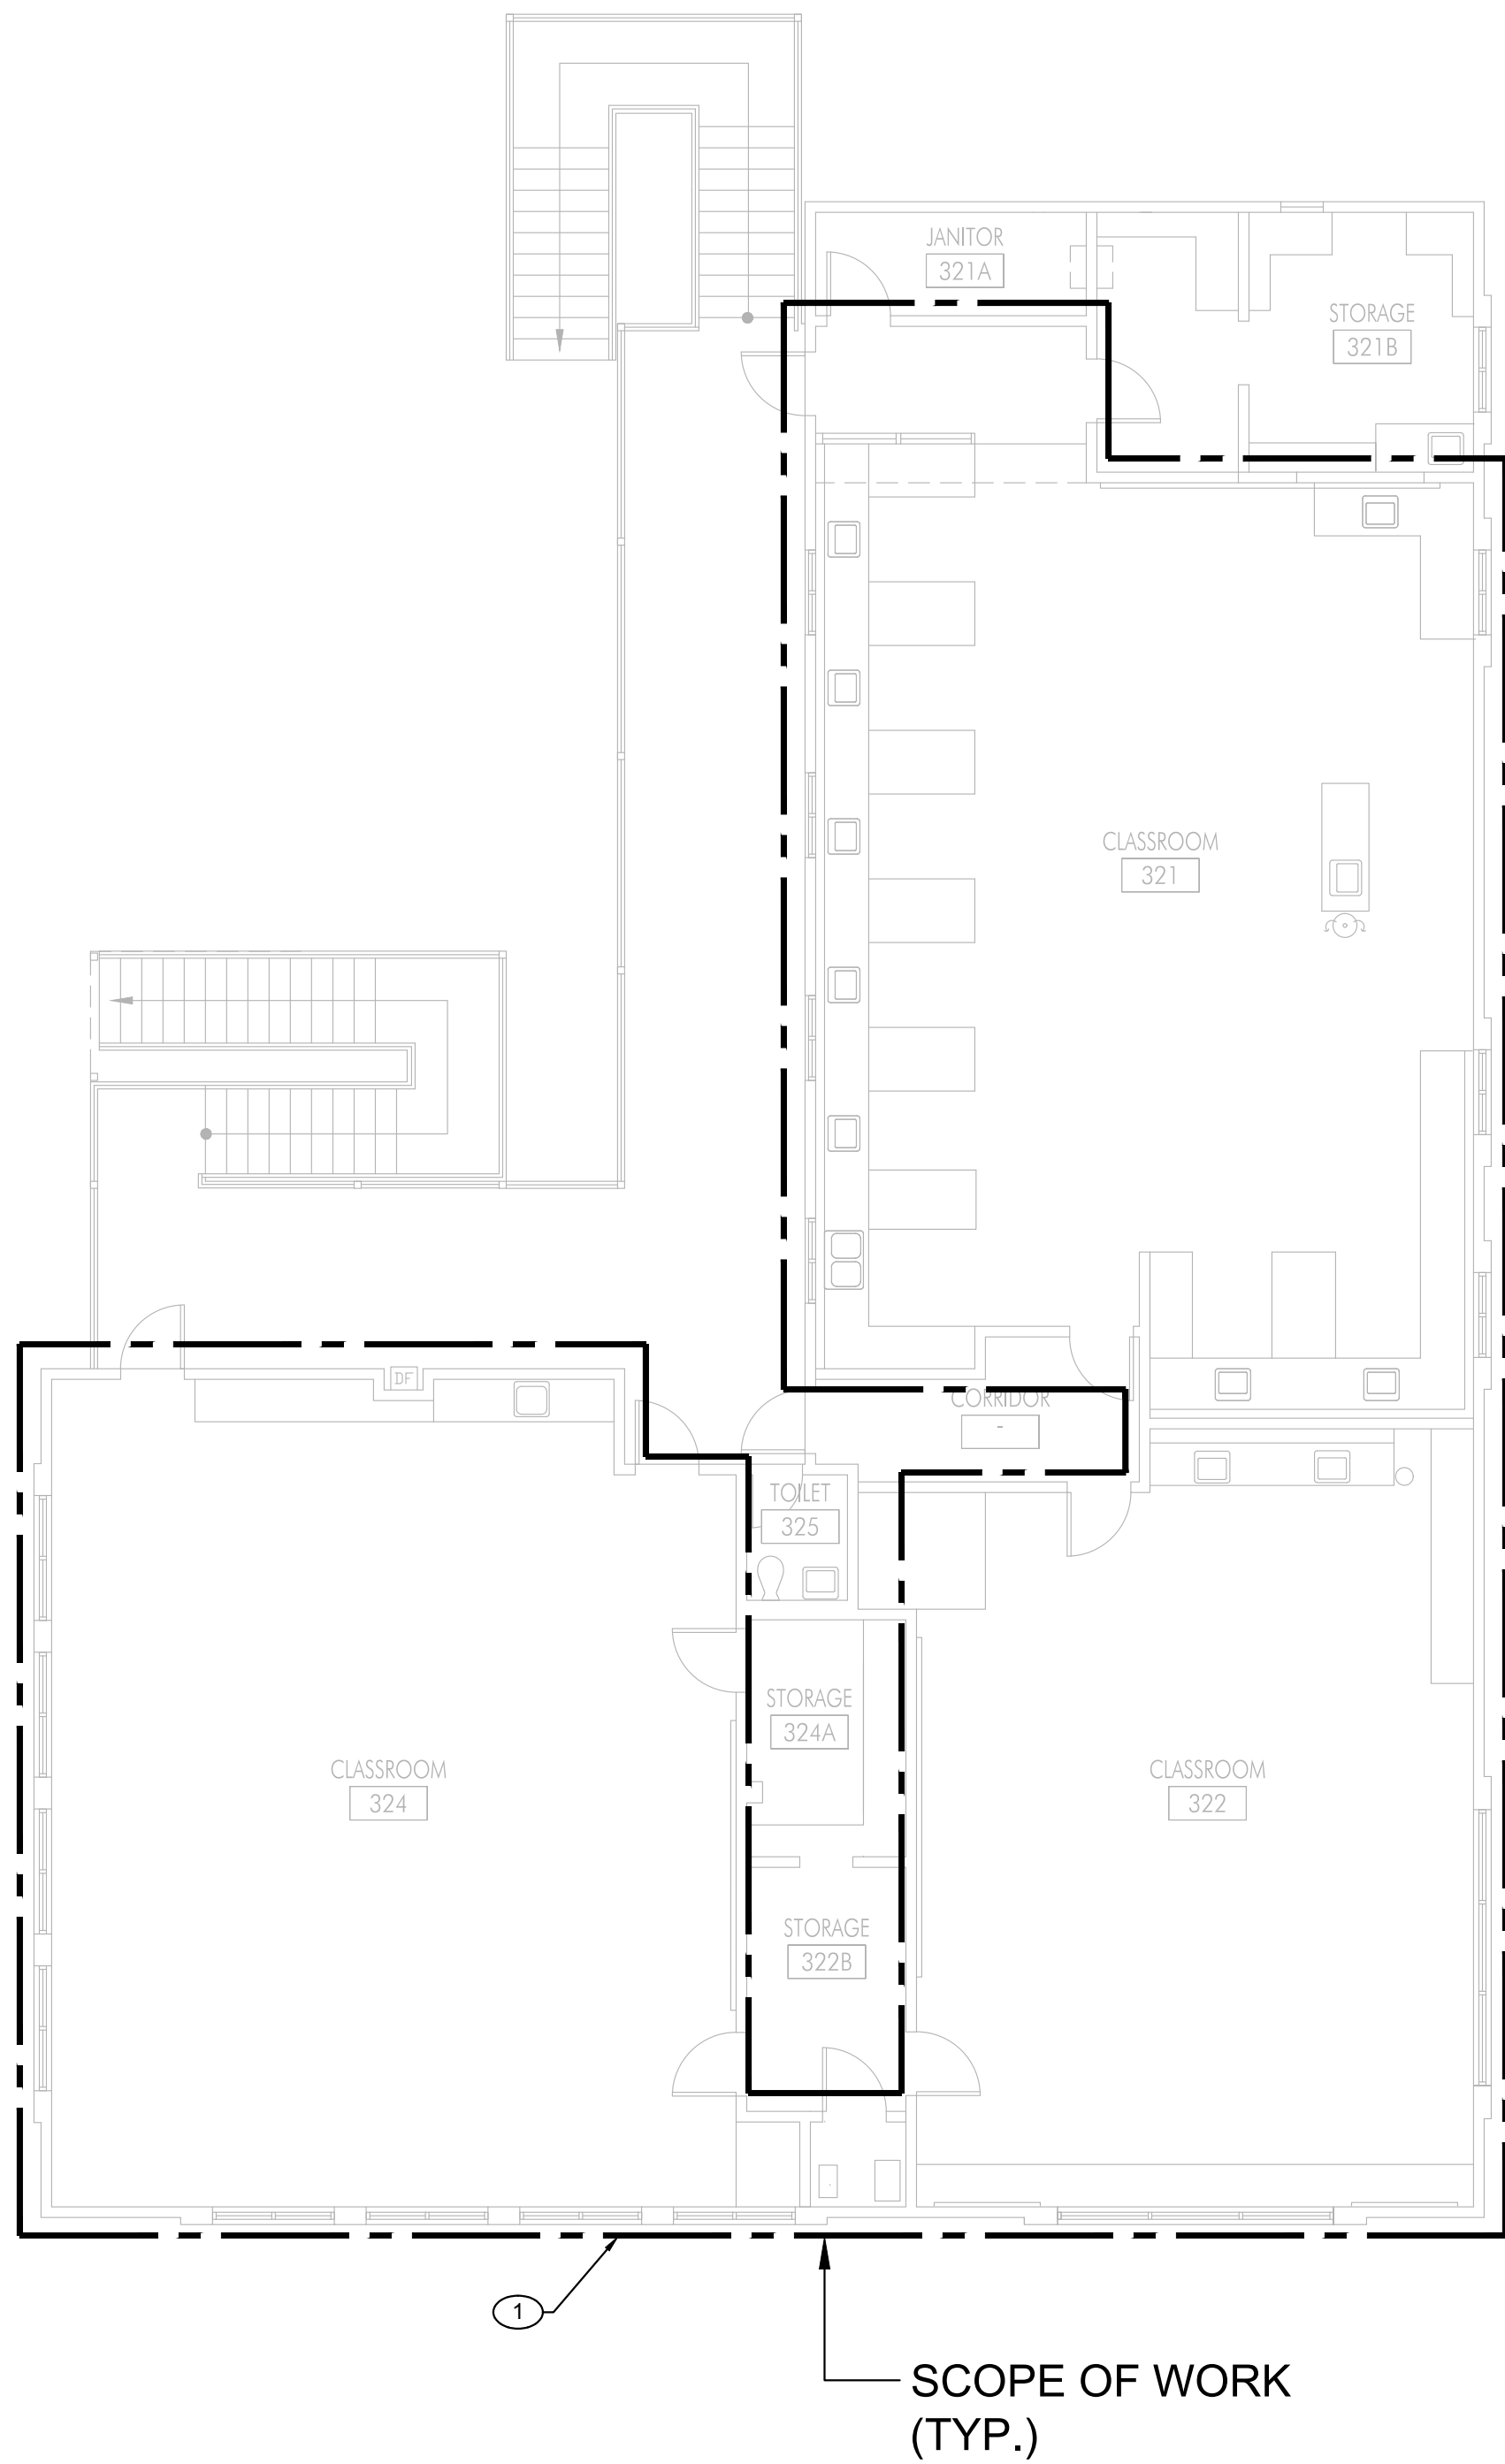

SCALE: 1/8"=1'-0"

2 SECOND FLOOR MECHANICAL DEMOLITION PLAN

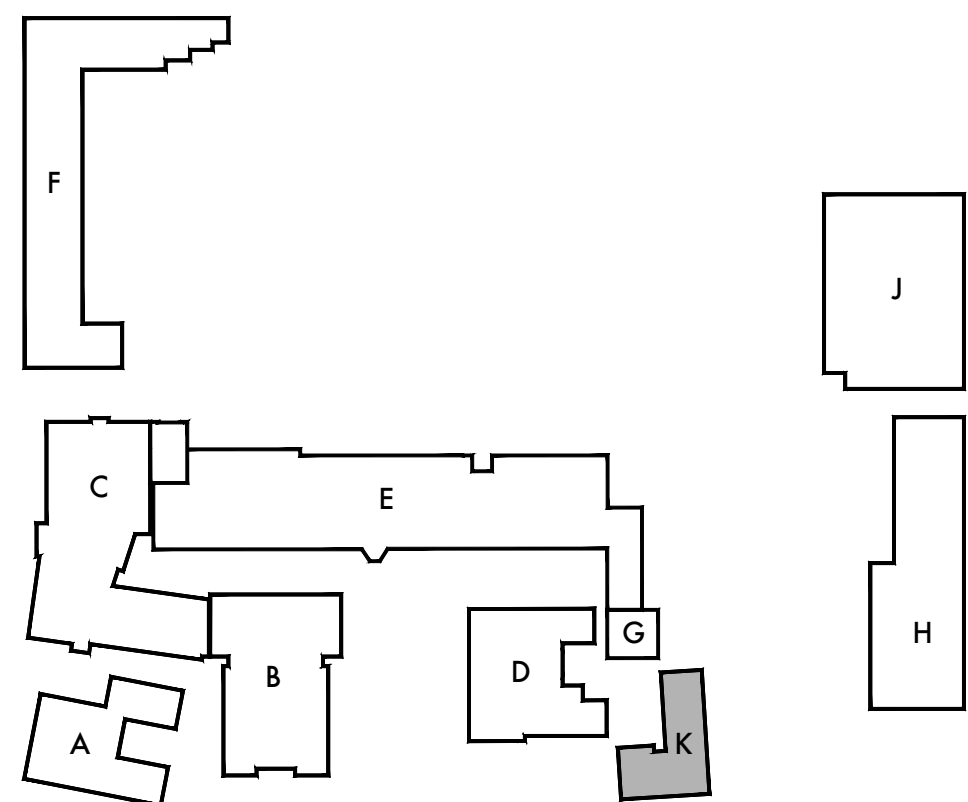

KEY PLAN

Architect




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P: 626.930.1383 F: 626.930.1385
Project No. 19009

Sheet Title

Building 'K'
Mechanical
Demolition Plans

Sheet Number

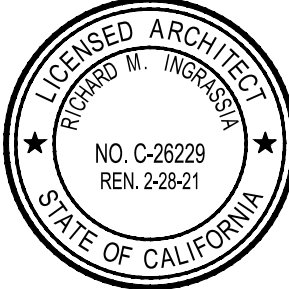




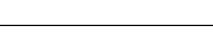
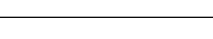
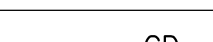
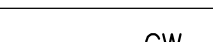





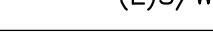
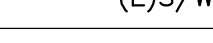
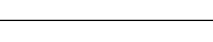

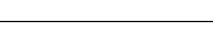
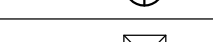
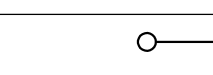
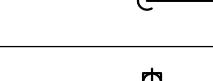
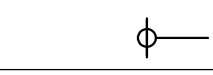

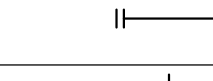
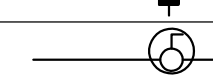
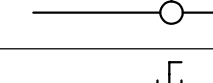
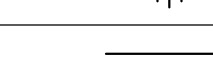
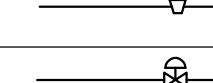
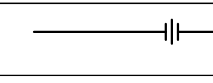
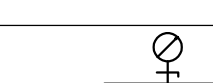
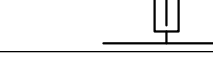
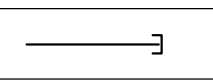
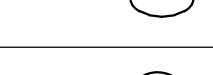





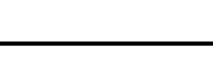

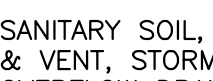


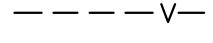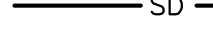



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PLUMBING GENERAL NOTES	
1.	PRIOR TO THE BID THE CONTRACTOR SHALL VERIFY THE EXACT LOCATIONS, ELEVATIONS, POINTS OF CONNECTIONS AND CHARACTERISTICS OF ALL UTILITY PIPING AND SHALL IMMEDIATELY NOTIFY THE ARCHITECT OF ANY DISCREPANCIES.
2.	EXACT LOCATION AND MOUNTING HEIGHTS OF PLUMBING FIXTURES SHALL BE OBTAINED FROM THE ARCHITECTURAL DRAWINGS.
3.	SEE ARCHITECTURAL DRAWINGS FOR ALL DISABLED ACCESS FIXTURE LOCATIONS AND MOUNTING HEIGHTS. INSULATE ALL EXPOSED EDGES, INCLUDING WATER SUPPLY PIPING, LOOSE KEY STOPS, AND DRAIN PIPING BELOW DISABLED ACCESS FIXTURES. ALL DESIGNATED FIXTURES SHALL BE ACCESSIBLE TO INDIVIDUALS WITH DISABILITIES IN ACCORDANCE WITH THE "AMERICANS WITH DISABILITIES ACT OF 2016 – FIXTURES AND THEIR INSTALLATION ANSI A117.1".
4.	ALL PLUMBING WORK SHALL BE INSTALLED SO AS TO AVOID INTERFERENCE WITH OTHER TRADES.
5.	CLEANOUTS SHALL BE PROVIDED AS REQUIRED BY CODE AND SHALL BE READILY ACCESSIBLE. THE CONTRACTOR SHALL COORDINATE ALL LOCATIONS WITH EQUIPMENT, CABINETS, ETC., WITH THE ARCHITECT PRIOR TO ANY INSTALLATION. ALL CLEANOUTS SHALL BE SIZED PER CODE.
6.	EQUIPMENT ANCHORAGE DETAILS FOR EQUIPMENT ARE SUBJECT TO APPROVAL OF THE DSA STRUCTURAL ENGINEER PRIOR TO INSTALLATION AND INSPECTION. UNLESS SPECIFICALLY SHOWN ON THESE PLANS, NO STRUCTURAL MEMBER SHALL BE CUT, DRILLED NOR NOTCHED WITHOUT PRIOR WRITTEN AUTHORIZATION FROM THE STRUCTURAL ENGINEER.
7.	ALL PLUMBING FIXTURES, EQUIPMENT, TRIM AND FITTING SHALL COMPLY WITH LOCAL, STATE, AND FEDERAL REGULATIONS AND CODES, INCLUDING, BUT NOT LIMITED TO WATER AND ENERGY CONSERVATION CODES. THE SCHEDULED AND/ OR SPECIFIED PLUMBING FIXTURES AND EQUIPMENT REPRESENT THE MINIMUM CRITERIA AND SHALL BE THE BASIS FOR THE CONTRACTOR'S BASE BID.
8.	ALL WASTE PIPING SHALL SLOPE AT 2% MINIMUM UNLESS OTHERWISE INDICATED OR REQUIRED DUE TO STRUCTURAL CONDITIONS.
9.	PROVIDE DIELECTRIC ISOLATION FITTINGS AT POINT OF CONNECTION OF ALL COPPER TUBING AND ANY DISSIMILAR METALS.
10.	ALL NEW PIPING, INCLUDING WATER, WASTE, AND GAS, SHALL BE TESTED IN ACCORDANCE WITH THE CALIFORNIA PLUMBING CODE.
11.	ALL HOT WATER PIPING SHALL BE INSULATED WITH MINIMUM THERMAL RESISTANCE OF R=4.0 PER INCH. THE INSULATION SHALL HAVE A FLAME SPREAD RATING OF NOT MORE THAN 25 AND SMOKE DEVELOPED RATING OF NOT MORE THAN 50, TYPE AND THICKNESS PER SPECIFICATIONS.
12.	PROVIDE LOOSE CHROME PLATED KEY STOPS AT ALL FIXTURES.
13.	EACH PLUMBING VENT SHALL TERMINATE NOT LESS THAN TEN (10) FEET FROM OR THREE (3) FEET ABOVE ANY WINDOW, DOOR, AIR INTAKE, OR VENT SHAFT, AND SHALL HAVE A VANDAL RESISTANT VENT CAP.
14.	ALL HOSE BIBBS HAVE A NON-REMOVABLE VACUUM BREAKER.
15.	CONTRACTOR SHALL PAY ALL FEES REQUIRED TO COMPLETELY INSTALL ALL EQUIPMENT, MATERIALS AND PIPING INDICATED IN CONTRACT DRAWINGS.
16.	CONTRACTOR SHALL COORDINATE LOCATIONS OF ALL EXPOSED PIPING ON ROOF WITH ALL EQUIPMENT, CRICKETS AND RIDGE LINES AS SHOWN ON MECHANICAL, ELECTRICAL, AND ARCHITECTURAL DRAWINGS.
17.	CONTRACTOR SHALL PROVIDE WATER HAMMERS, THREADED OR SOLDERED, UPSTREAM OF LAST FIXTURE ON HW & CW SUPPLY PIPING, PER PDI & TD WH-201 STANDARD.
18.	ALL BURRED ENDS OF WATER PIPING AND TUBING SHALL BE REAMED TO THE FULL BORE OF THE PIPE OR TUBE AND ALL CHIPS SHALL BE REMOVED (SEE CALIFORNIA PLUMBING CODE, 2016 EDITION, SECTION 510.3, ADDITIONALLY TOOLS USED IN CUTTING OR REAMING SHALL BE KEPT FREE FROM OIL OR GREASE AND WHERE SUCH CONTAMINATION HAS OCCURRED, THE ITEMS AFFECTED SHALL BE REWORKED AND RINSED.
19.	FOR PIPE PENETRATIONS THROUGH FIRE RATED FLOOR, WALL, AND PARTITIONS, PROVIDE FIRE STOP DEVICES AND PACKING IN COMPLIANCE WITH U.L. FIRE RESISTANCE DIRECTORY FORTHROUGH – PENETRATION FIRE STOP DEVICES (XHCR), SYSTEMS WL1001, WL1002, WL5001, WL5002 OR CAJ1001, CAJ5001, CAJ5002, CAJ5003 AS APPLICABLE.
20.	SEAL ALL PENETRATIONS THROUGH FIRE RESISTIVE CONSTRUCTION WITH APPROVED MATERIALS PER SECTION 714, CBC.
21.	PER CODE ALL LAVATORIES, SINKS SHALL HAVE WALL CLEAN-OUTS, URINALS SHALL HAVE WALL CLEAN-OUTS ABOVE THE FLUSH VALVES.
23.	CONTRACTOR SHALL COMPLY WITH LOW-LEAD ORDINANCE AB-1953.
24.	COORDINATE ACCESS PANEL LOCATIONS WITH ARCHITECTURAL DWG'S.
25.	ALL PLUMBING FIXTURES & PLUMBING FITTINGS SHALL COMPLY WITH MAXIMUM FLOW RATE VALUES OF SECTION 5.303.2. AND SECTION 5.303.3. OF CALIFORNIA GREEN BUILDING CODE.
26.	NEW OR REPAIRED POTABLE WATER SYSTEMS SHALL BE DISINFECTED PRIOR TO USE ACCORDING TO THE METHOD SET IN SECTION 609.9 OF THE CALIFORNIA PLUMBING CODE.

SEISMIC BRACING OF PLUMBING SYSTEMS	
1.	GENERAL CONTRACTOR SHALL ENGINEER, PROVIDE AND INSTALL GRAVITY SUPPORTS (HANGERS, STANDS, ETC.) AND SEISMIC RESTRAINTS (CABLE BRACING, ANGLE BRACING, ETC.) INCLUDING THEIR CONNECTIONS TO THE STRUCTURE, FOR ALL EQUIPMENT AND DISTRIBUTION SYSTEMS (PIPING, DUCTWORK, CONDUIT, ETC.) WHERE SUCH SUPPORTS AND BRACING ARE NOT COVERED IN THE STRUCTURAL DRAWINGS FOR THE PROJECT. GRAVITY SUPPORTS AND SEISMIC RESTRAINTS SHALL MEET THE REQUIREMENTS SET FORTH IN THE 2016 CALIFORNIA BUILDING CODE, IT'S REFERENCE STANDARD ASCE 7-10 (CHAPTER 13), AND ALL OTHER APPLICABLE CODES.
2.	GENERAL CONTRACTOR SHALL SUBMIT THE ENGINEERED DESIGN OF THE SEISMIC RESTRAINTS, STAMPED AND SIGNED BY A CALIFORNIA LICENSED CIVIL OR STRUCTURAL ENGINEER, TO THE AHJ REPRESENTATIVE FOR REVIEW AND APPROVAL PRIOR TO INSTALLATION.
3.	SEISMIC BRACING SHALL CONSISTS OF ENGINEERED SYSTEMS (SUCH AS ISAT, TOLCO, OR ERICO) CARRYING AN OSHPD OPM CERTIFICATION UNDER THE 2013-CBC OR 2016-CBC.
4.	GRAVITY SUPPORTS AND SEISMIC RESTRAINTS SHALL BE LAID OUT AS TO AVOID INDUCING TORSION ON STRUCTURAL STEEL MEMBERS.
5.	SHOP DRAWINGS SHOWING ALL BRACING LOCATIONS AND DETAILS OF CONNECTIONS ARE REQUIRED FOR ALL SYSTEMS.

APPLICABLE CODES	
2016	CALIFORNIA BUILDING STANDARDS ADMINISTRATIVE CODE, PART 1, TITLE 24 C.C.R.
2016	CALIFORNIA BUILDING CODE, PART 2, TITLE 24 C.C.R. (2015 INTERNATIONAL BUILDING CODE WITH CALIFORNIA AMENDMENTS)
2016	CALIFORNIA ELECTRICAL CODE, PART 3, TITLE 24 C.C.R. (2015 NATIONAL ELECTRICAL CODE WITH CALIFORNIA AMENDMENTS)
2016	CALIFORNIA MECHANICAL CODE, PART 4, TITLE 24 C.C.R. (2015 UNIFORM MECHANICAL CODE WITH CALIFORNIA AMENDMENTS)
2016	CALIFORNIA PLUMBING CODE, PART 5, TITLE 24 C.C.R. (2014 UNIFORM PLUMBING CODE WITH CALIFORNIA AMENDMENTS)
2016	CALIFORNIA ENERGY CODE, PART 6, TITLE 24 C.C.R.
2016	CALIFORNIA FIRE CODE, PART 9, TITLE 24 C.C.R. (2014 INTERNATIONAL FIRE CODE)
2016	CALIFORNIA GREEN BUILDING STANDARD CODE, TITLE 24, PART II
2016	NFPA 13 – INSTALLATIONS OF FIRE SPRINKLER SYSTEMS
2016	CALIFORNIA REFERENCE STANDARDS CODE, PART 12, TITLE 24 C.C.R.

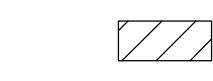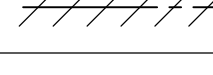PLUMBING LEGEND		
SYMBOL	ABBREV	DESCRIPTION
	S OR W	SEWER OR WASTE BEL. FLR. OR GRD.
	S OR W	SEWER OR WASTE ABV. FLR. OR GRD.
	V	VENT LINE
	SD	STORM DRAIN ABV. FLR. OR GRD.
	SD	STORM DRAIN BEL. FLR. OR GRD.
	OD	OVERFLOW DRAIN ABV. FLR. OR GROUND
	OD	OVERFLOW DRAIN BEL. FLR. OR GROUND
	PCD	PUMP CONDENSATE DRAIN
	CD	CONDENSATE DRAIN
	CW	COLD WATER
	HW	HOT WATER
	HWR	HOT WATER RETURN
	MPG	MEDIUM PRESSURE GAS (5 PSIG)
	G	GAS LINE (7" W.C.)
	TP	TRAP PRIMER LINE
	(E)S OR W	EXISTING SEWER OR WASTE BEL. FLR. OR GRD.
	(E)S OR W	EXISTING SEWER OR WASTE ABV. FLR. OR GRD.
	(E)V	EXISTING VENT LINE
	(E)CW	EXISTING COLD WATER
	(E)HW	EXISTING HOT WATER
	FD	FLOOR DRAIN
	FS	FLOOR SINK (HALF-GRATE)
	-	PIPE UP
	-	PIPE DOWN
	COYB	CLEANOUT IN YARD BOX
	FCO	FLOOR CLEANOUT
	WCO	WALL CLEANOUT BEHIND ACCESS PANEL
	IWR	INDIRECT WASTE RECEPTOR
	CO	CLEANOUT
	TP	TRAP PRIMER
	SOVYB	SHUT-OFF VALVE IN YARD BOX (BALL TYPE)
	SOV	SHUT-OFF VALVE (BALL TYPE)
	SOV	SHUT-OFF VALVE (BUTTERFLY TYPE)
	HB	HOSE BIBB
	GV	GAS VALVE
	GPR	GAS PRESSURE REGULATOR
	U	UNION
	CV	CHECK VALVE
	PG	PRESSURE/VACUUM GAUGE
	TH	THERMOMETER
	-	DIRECTION OF FLOW IN LINE
	-	CAP OR PLUG
	-	KEYNOTE
	-	REFERENCE DETAIL
	POC	POINT OF CONNECTION
	POD	POINT OF DISCONNECT
	-	EXISTING FIXTURE OR EQUIPMENT TO BE REMOVED
		EXISTING PIPING TO BE REMOVED

ABBREVIATIONS	
⊙	AT
ABV	ABOVE
ADA	AMERICANS WITH DISABILITIES ACT
AF	ABOVE FINISHED FLOOR
AP	ACCESS PANEL
ARCH	ARCHITECT/ARCHITECTURAL
BEH	BEHIND
BEL	BELOW
BLDG	BUILDING
CFH	CUBIC FEET PER HOUR
CFM	CUBIC FEET PER MINUTE
CLG	CEILING
CONC	CONCRETE
CONN	CONNECT/CONNECTION
CONT	CONTINUED/CONTINUATION
DIA (Ø)	DIAMETER
DN	DOWN
DWG(S)	DRAWING(S)
E/EX	EXISTING
EA	EACH
EQUIP	EQUIPMENT
FFE	FINISHED FLOOR ELEVATION
FCO	FLOOR CLEAN-OUT
FCU	FAN COIL UNIT
FIN	FINISH
FLR	FLOOR
FR	FROM
FTG(S)	FITTING(S)
GAL	GALLONS
CO	CLEAN-OUT
GPH	GALLONS PER HOUR
GPM	GALLONS PER MINUTE
GRD	GRADE OR GROUND
GPF	GALLONS PER FLUSH
HDR	HEADER
HP	HORSE POWER
HTR	HEATER
IE	INVERT ELEVATION
IW	INDIRECT WASTE
LPG	LOW PRESSURE GAS
MAX	MAXIMUM
MECH.	MECHANICAL
MIN	MINIMUM
PCD	PUMPED CONDENSATE DRAIN
PP	POLYPROPYLENE
PRESS	PRESSURE
P.S.I	POUNDS PER SQUARE INCH
PVC	POLYVINYL CHLORIDE
R.I. & C	ROUGH-IN & CONNECT
SHT	SHEET
TEMP	TEMPERATURE
THRU	THROUGH
TYP	TYPICAL
UL	UNDERWRITERS' LABORATORIES
VTR	VENT THRU ROOF
W/	WITH
WCO	WALL CLEAN-OUT
WHA	WATER HAMMER ARRESTOR

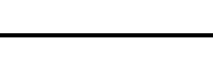PLUMBING SHEET INDEX	
P001	PLUMBING GENERAL NOTES, LEGEND & ABBREVIATIONS AND SHEET INDEX
PA201	BLDG. "A" – FIRST FLOOR PLUMBING PLANS
PB201	BLDG. "B" – FIRST FLOOR PLUMBING PLANS
PB202	BLDG. "B" – MEZZANINE LEVEL PLUMBING PLANS
PC202	BLDG. "C" – SECOND FLOOR PLUMBING PLAN
PC203	BLDG. "C" – PLUMBING ROOF PLAN
PCDC201	BLDG. "CDC" – FIRST FLOOR PLUMBING PLAN
PD201	BLDG. "D" – FIRST FLOOR PLUMBING PLANS
PD202	BLDG. "D" – PLUMBING ROOF PLAN
PE201A	BLDG. "E" – FIRST FLOOR PLUMBING PLAN – SEGMENT A
PE201B	BLDG. "E" – FIRST FLOOR PLUMBING PLAN – SEGMENT B
PE202A	BLDG. "E" – SECOND FLOOR PLUMBING PLAN – SEGMENT A
PE202B	BLDG. "E" – SECOND FLOOR PLUMBING PLAN – SEGMENT B
PG201	BLDG. "G" – PLUMBING FIRST FLOOR AND ROOF PLANS
PH201	BLDG. "H" – FIRST FLOOR PLUMBING PLANS
PH202	BLDG. "H" – PLUMBING ROOF PLAN
P601	PLUMBING DETAILS
P602	PLUMBING DETAILS

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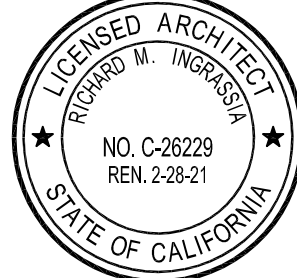
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Lincoln Middle School HVAC Replacement Project
Lincoln Middle School
1501 California Avenue
Santa Monica, California 90403

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
421 East Huntington Drive
Monrovia, California 91016
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Project No. 19009


Sheet Title

Plumbing
Cover Sheet

Sheet Number

P001

MISCELLANEOUS EQUIPMENT & DEVICE SCHEDULE					
TAG	DESCRIPTION	LOCATION	SERVICE	MANUFACTURER & MODEL NO.	REMARKS
 1	INDIRECT WASTE ROOF RECEPTOR	CHILLER PAD	WASTE	J. R. SMITH #3960Y-R-UDC-T	3" NO HUB OUTLET, CAST IRON RECEPTOR W/SOILD WATER DAM AND CAST IRON DOME BOTTOM STRAINER & STAINLESS STEEL VANDAL PROOF SCREWS.

BACKFLOW PREVENTER SCHEDULE							
TAG	LOCATION	SERVICE	MANUFACTURER & MODEL NO.	SIZE	CAPACITY		REMARKS
					GPM	PSI LOSS	
 1	VARIOUS	INDUSTRIAL COLD WATER	WATTS #C-009M3QT	3/4"	3	17	REDUCED PRESSURE PRINCIPLE ASSEMBLY WITH STRAINER, BALL VALVES & AIR GAP FITTING 909AG-A.

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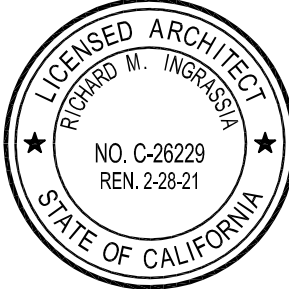
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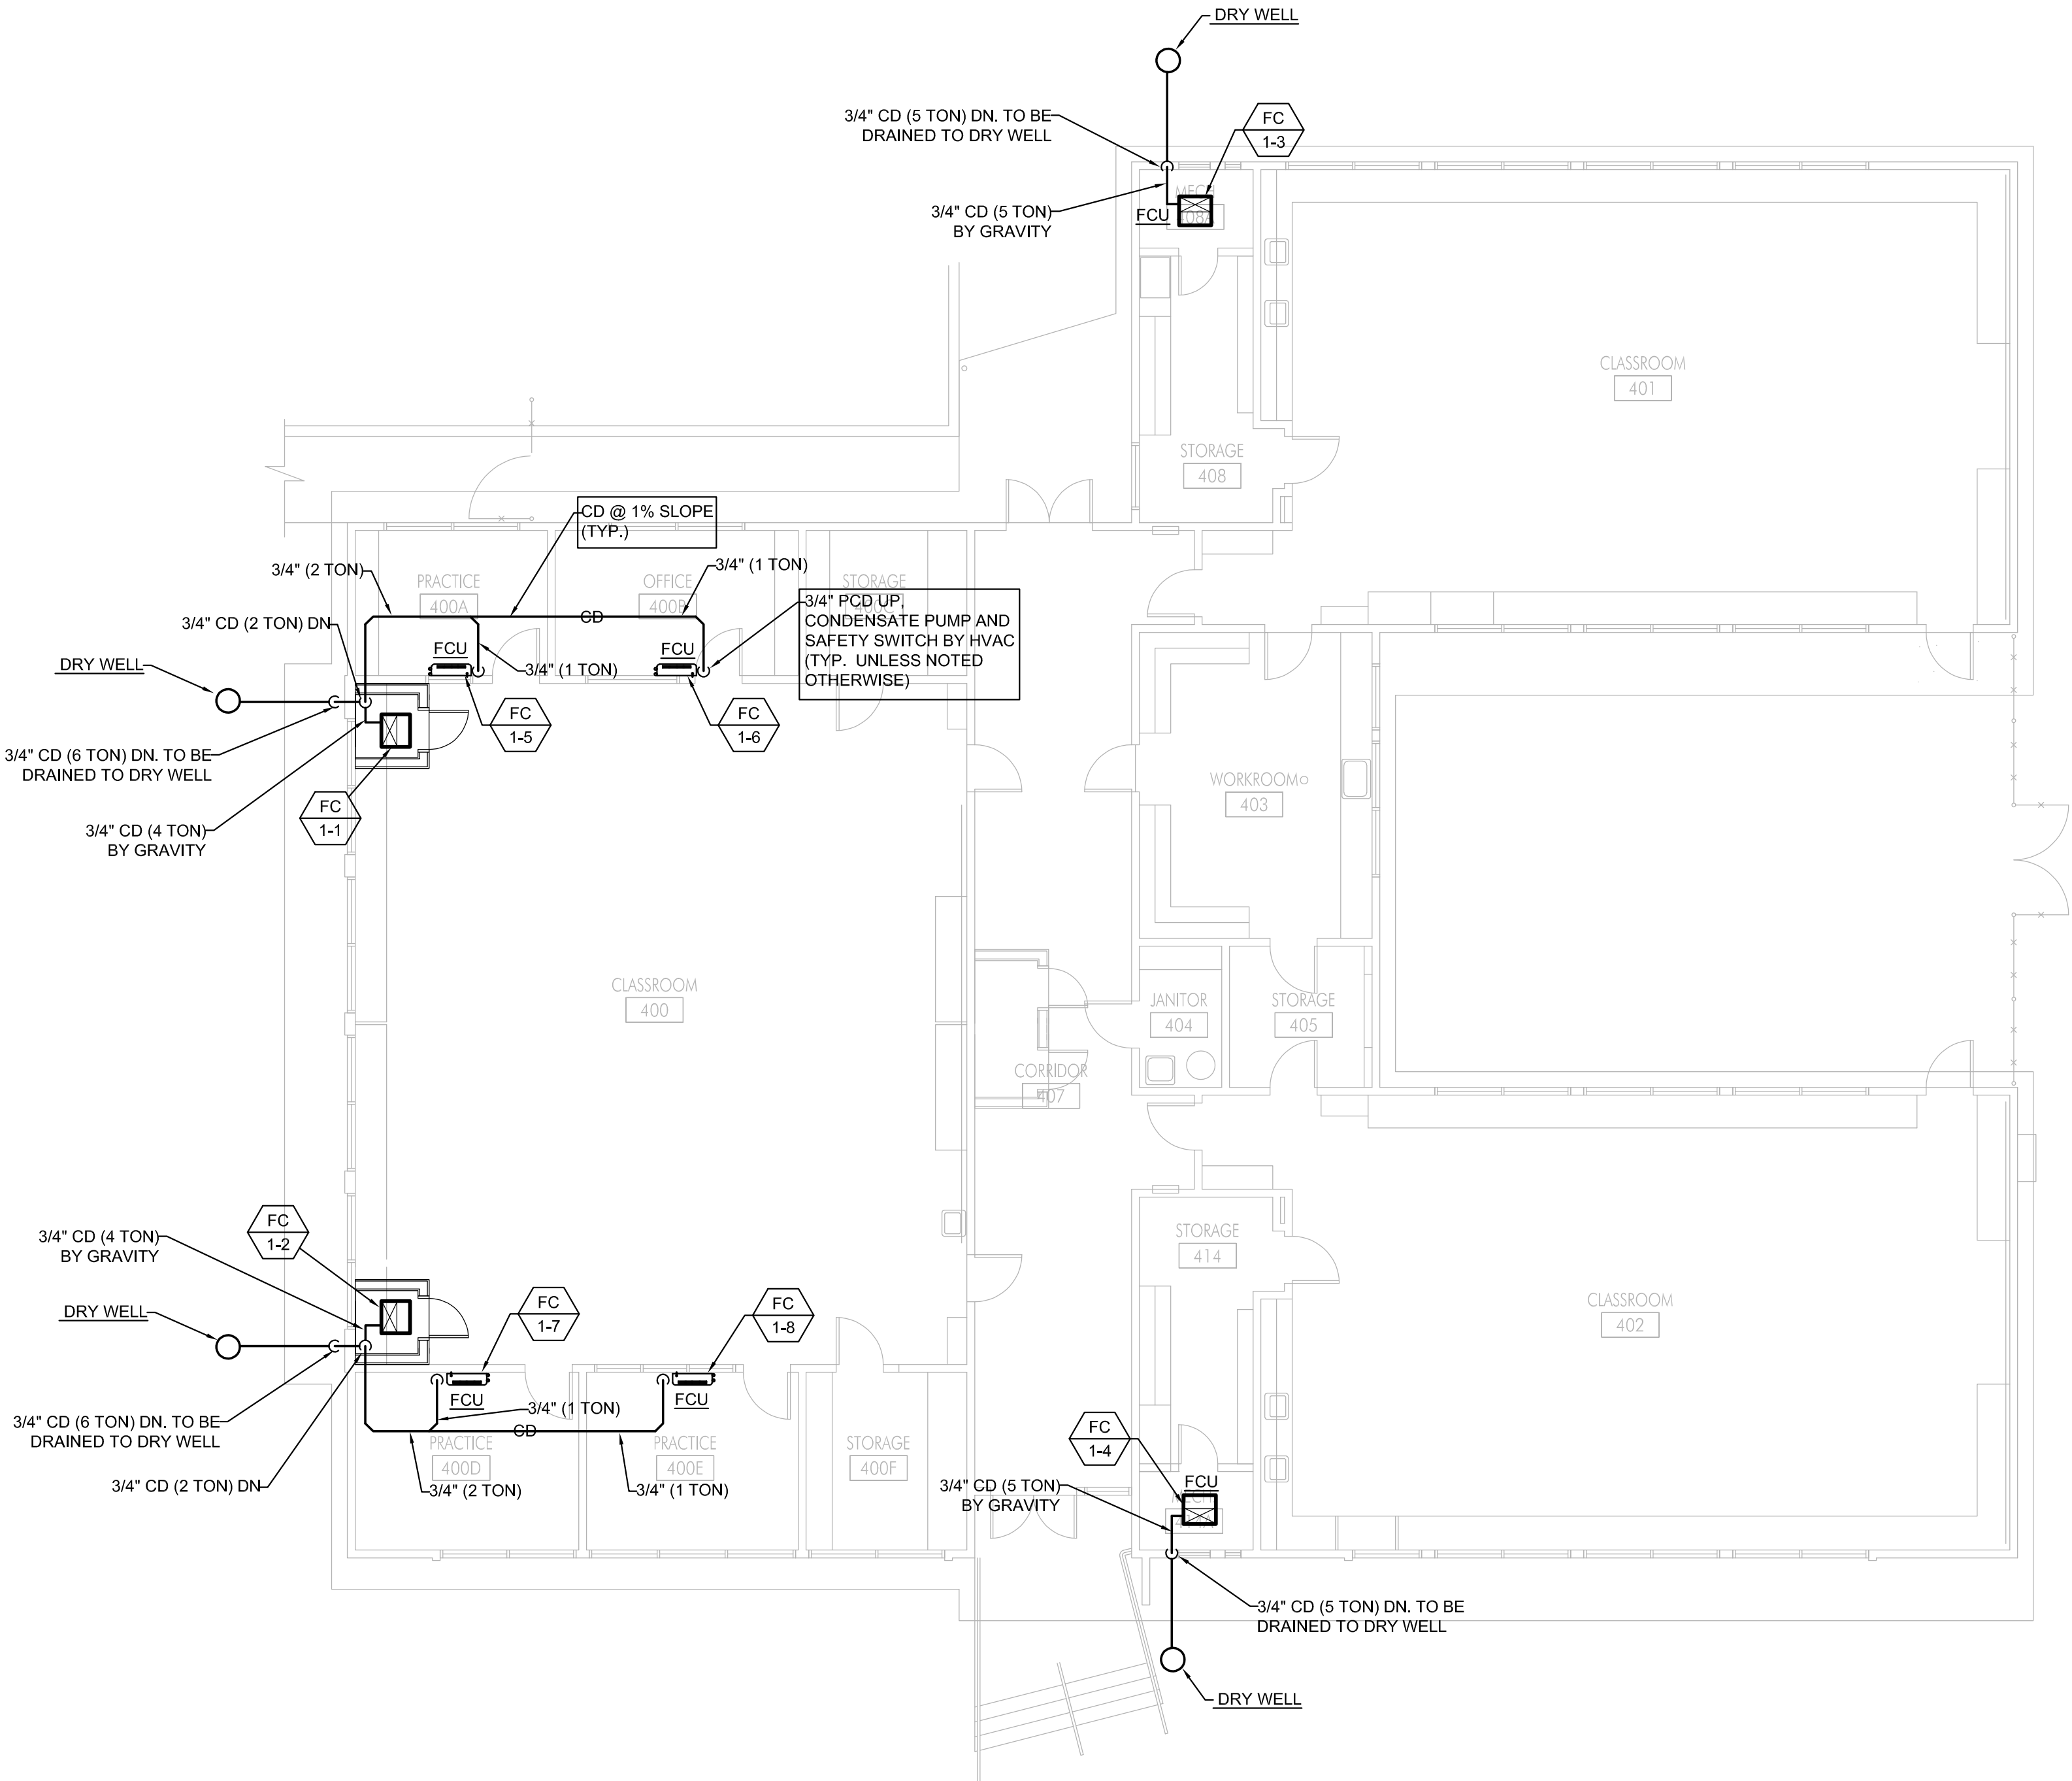
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Plumbing
Schedules


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KEY PLAN

LEGEND



DENOTES MECHANICAL FANCOIL UNIT DESIGNATION. SEE MECHANICAL SHEETS FOR SCHEDULES.

KEYNOTES

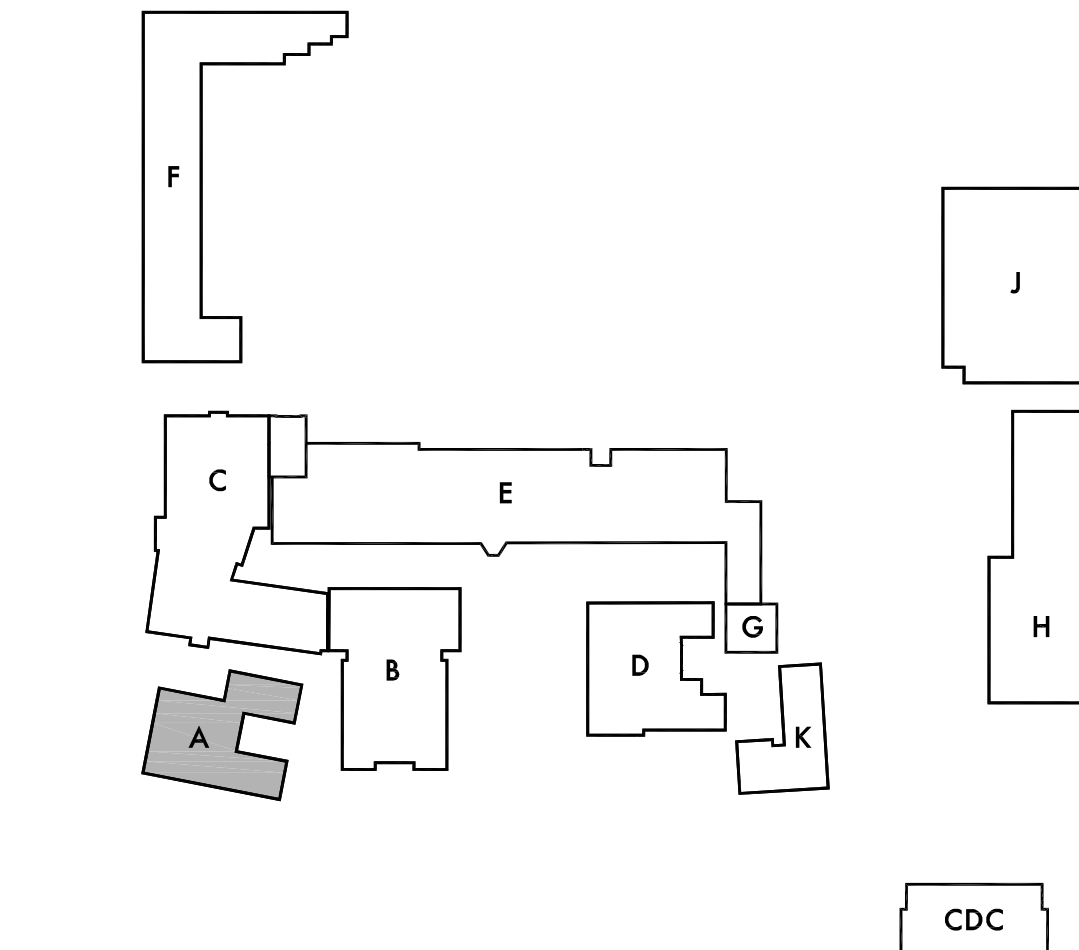1 XX-XX

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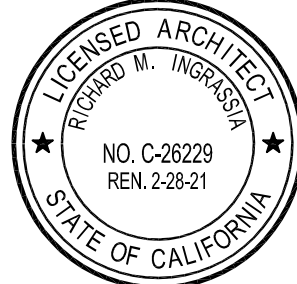
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Checked By: RI

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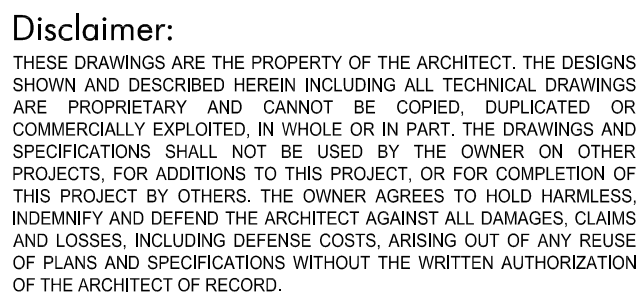
421 East Huntington Drive
Monrovia, California 91016
P: 626.930.1383 F: 626.930.1385
Project No. 19009

Sheet Title

Building 'A'
First Floor
Plumbing Plan

Sheet Number

PA201




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Lincoln Middle School HVAC R
Lincoln Middle School
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Santa Monica, California 90403

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Sheet Title

Building 'B'
First Floor
Plumbing Plan

Sheet Number



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KEYNOTES

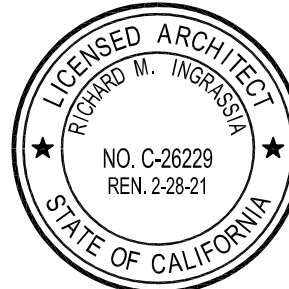① XX-XX

LEGEND

DENOTES MECHANICAL FANCOIL UNIT DESIGNATION. SEE MECHANICAL SHEETS FOR SCHEDULES.

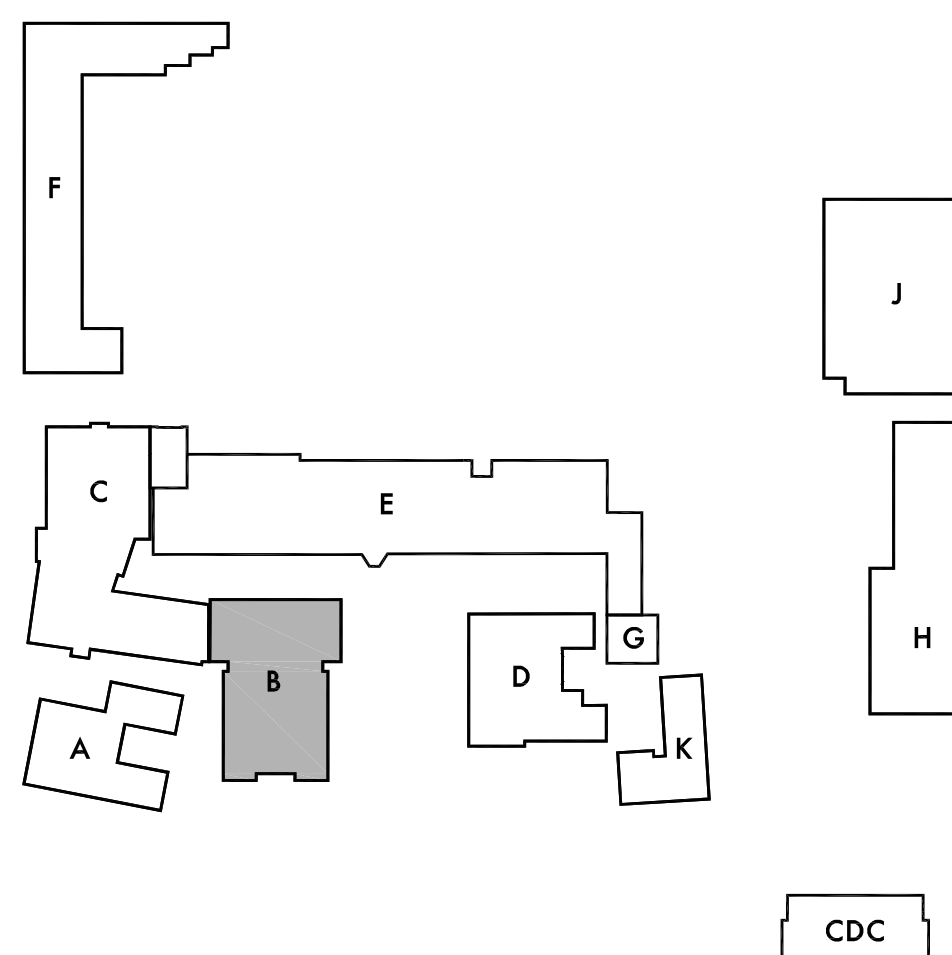
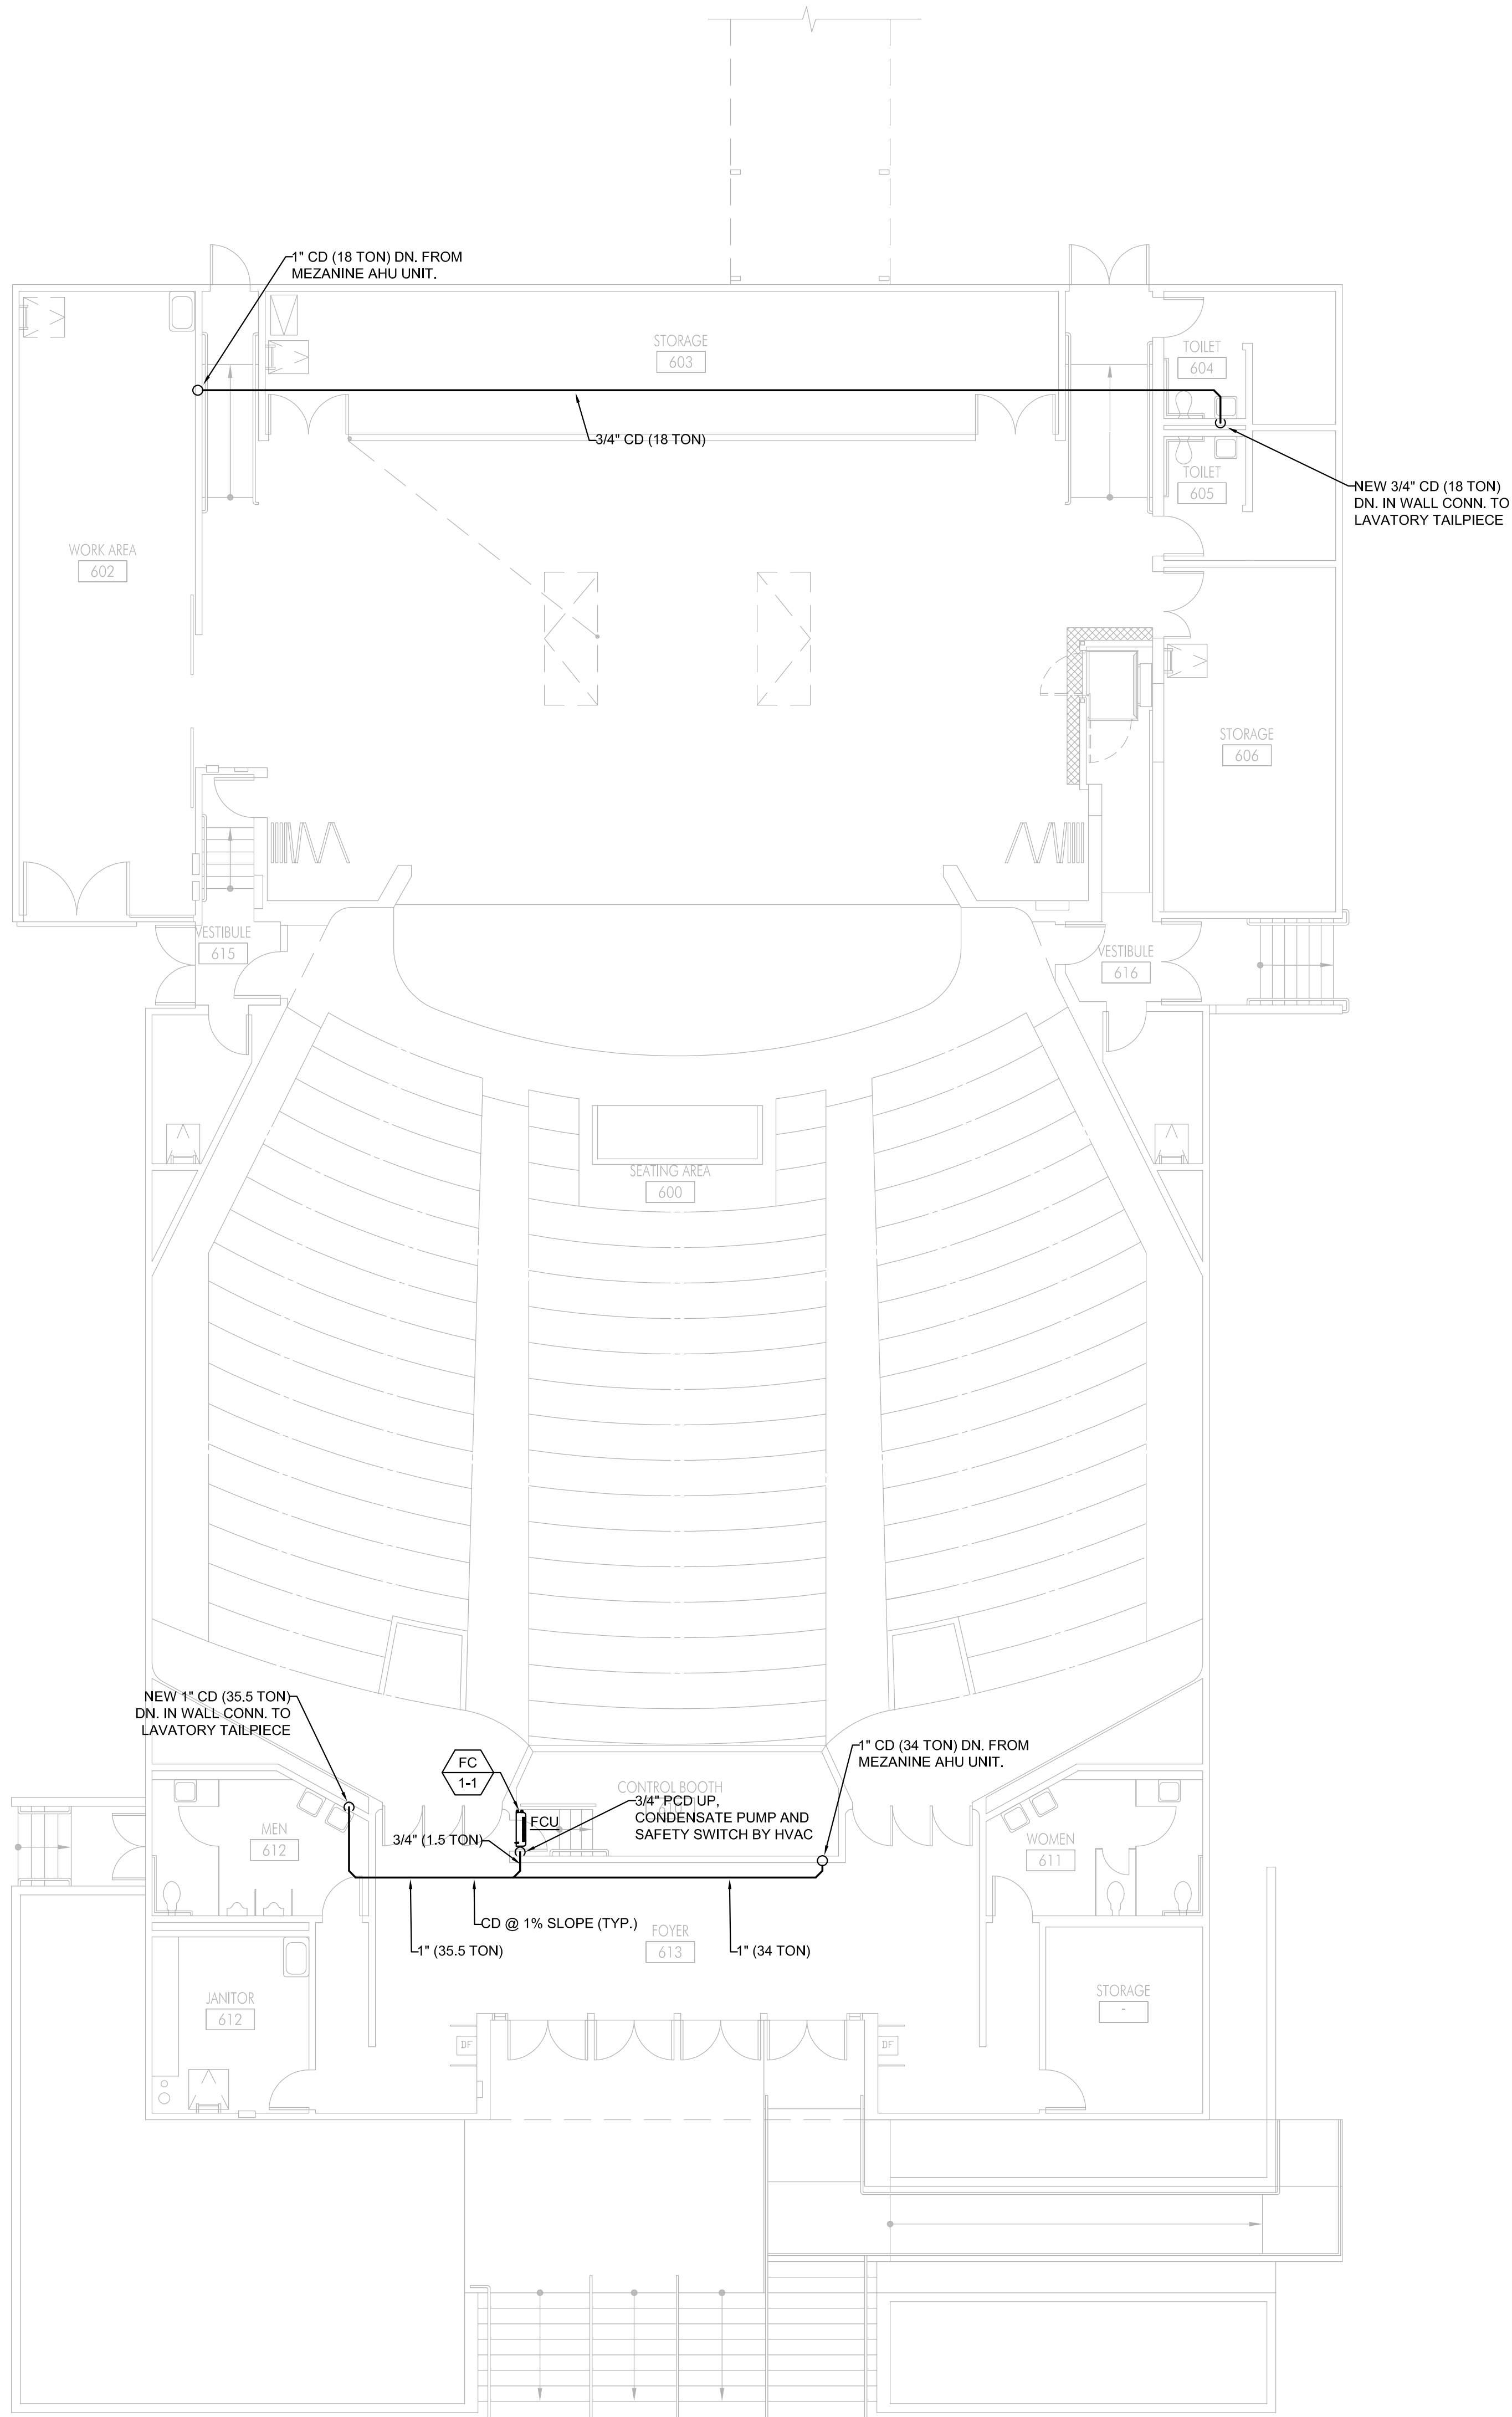


KEY PLAN




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SCALE: 1/8"=1'-0"

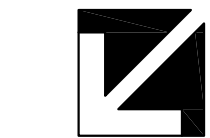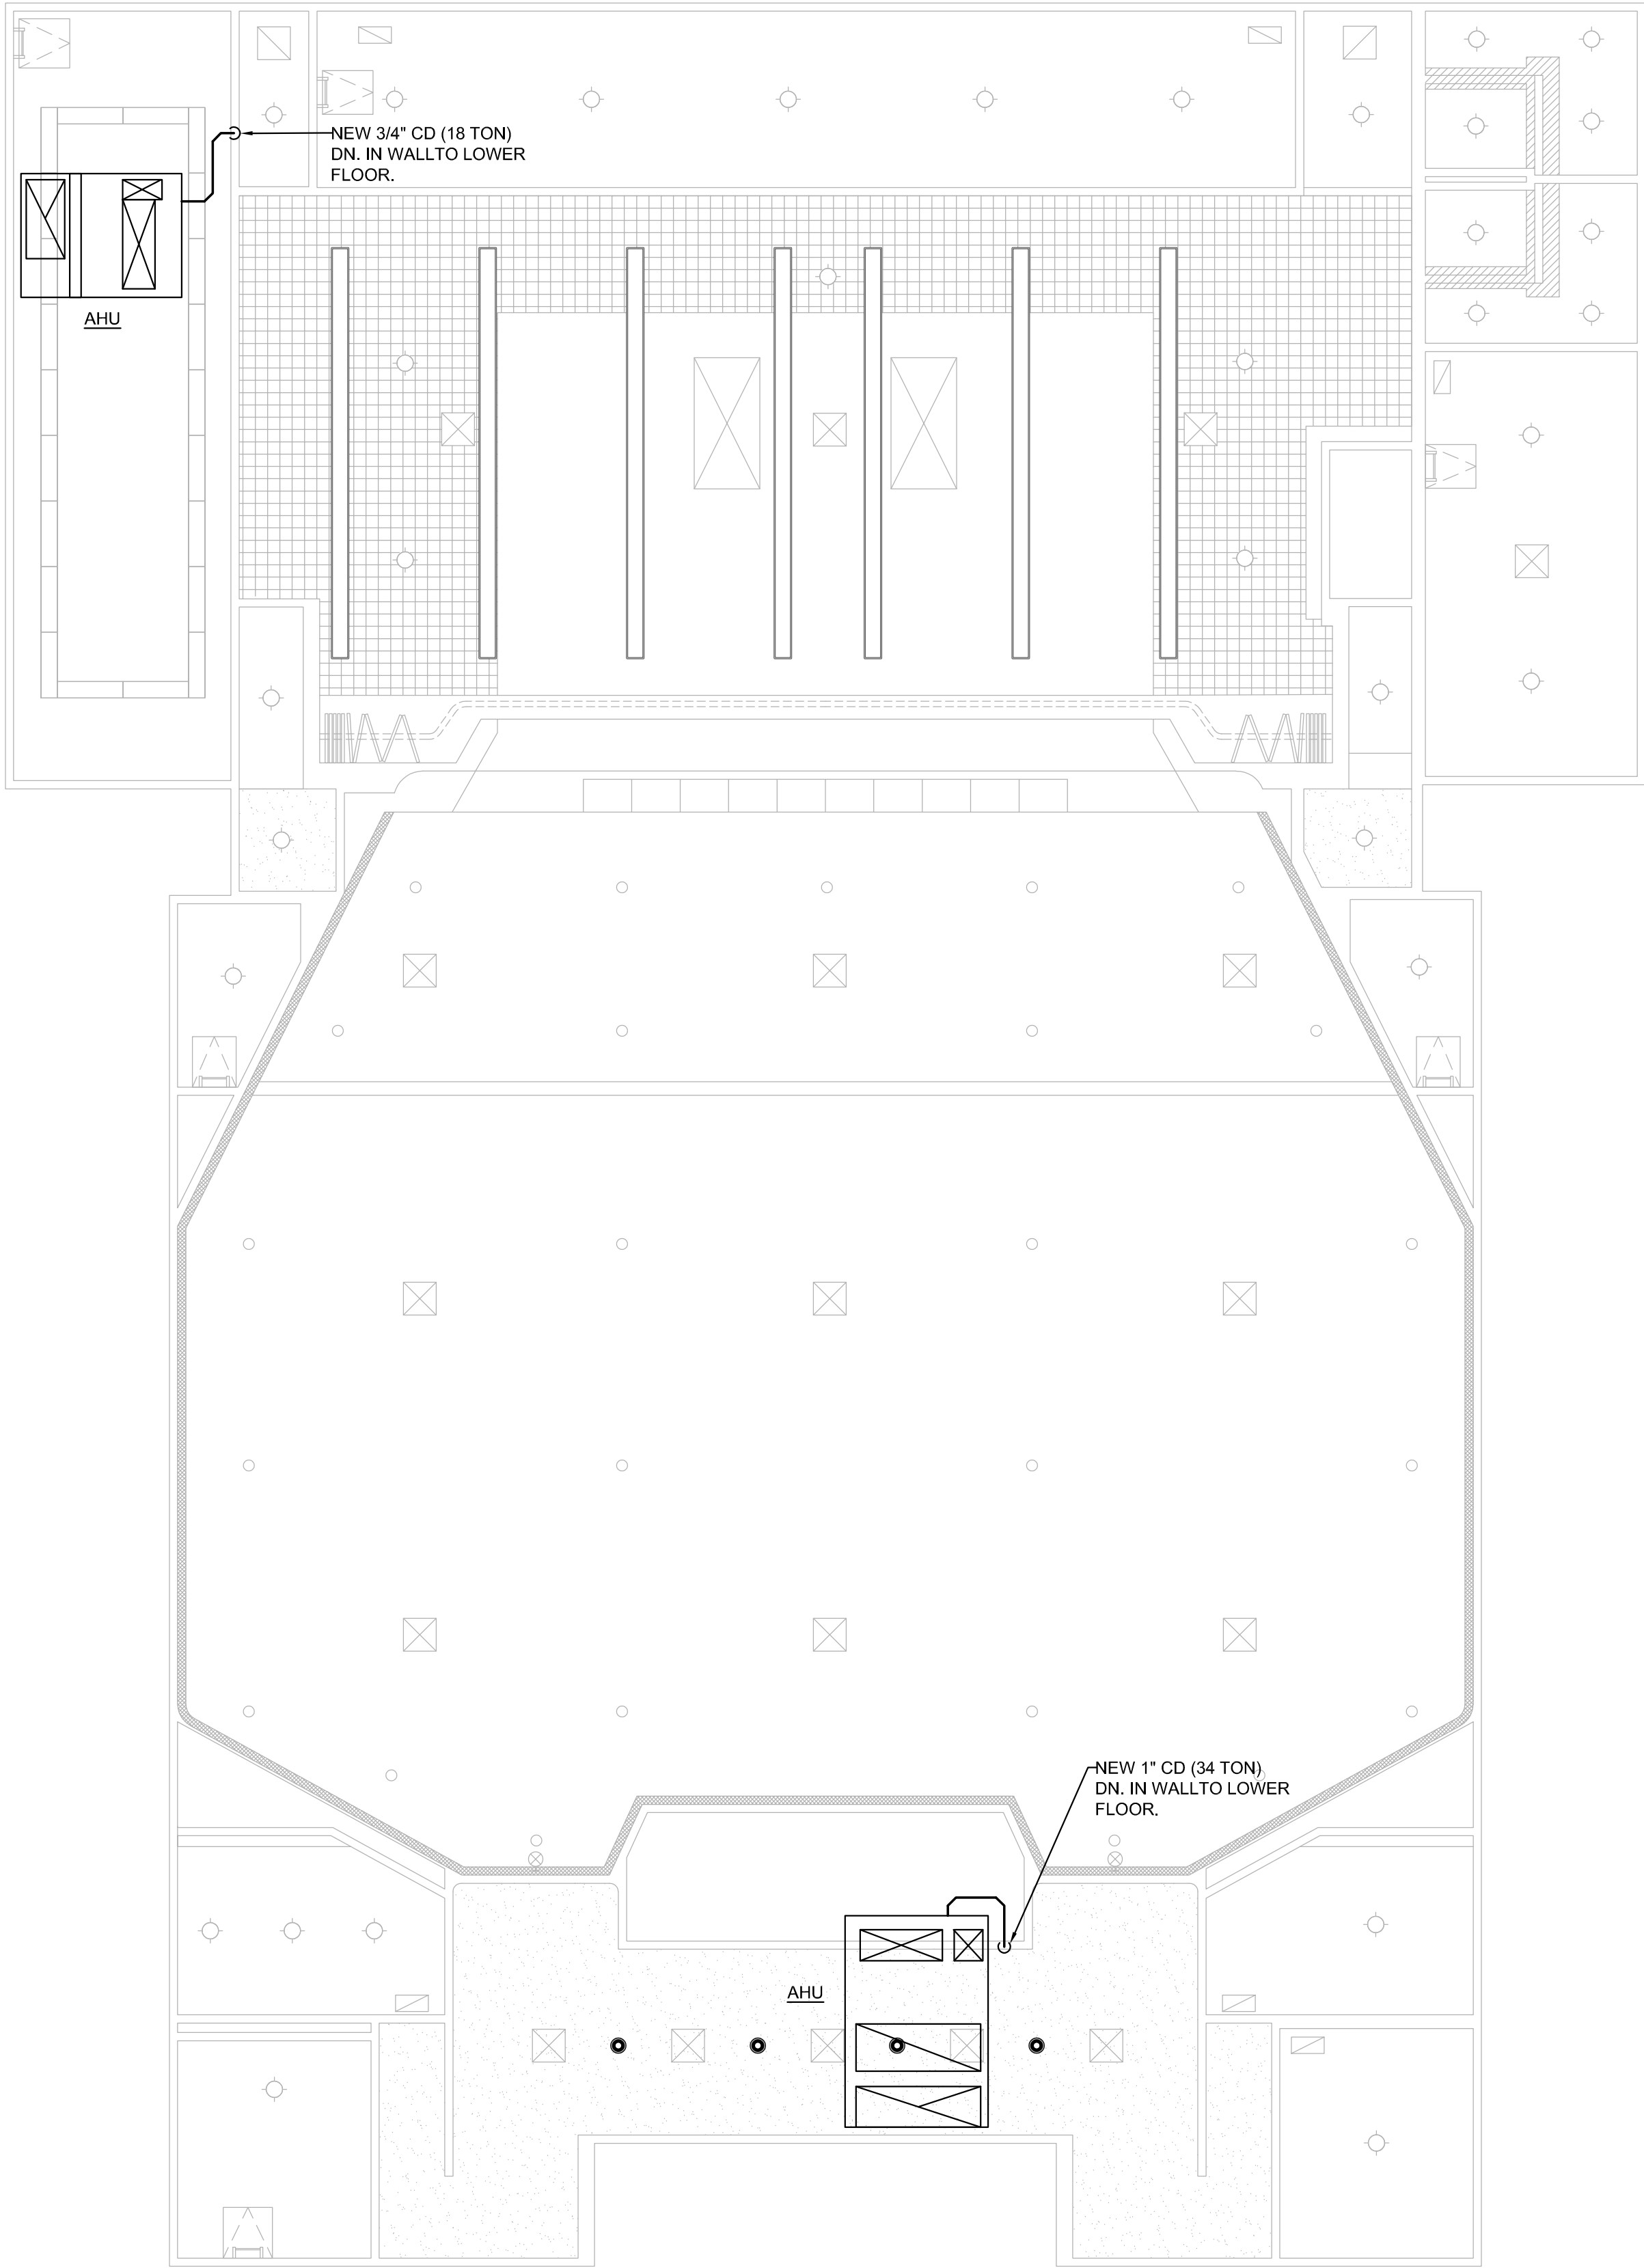

KEY PLAN

KEYNOTES

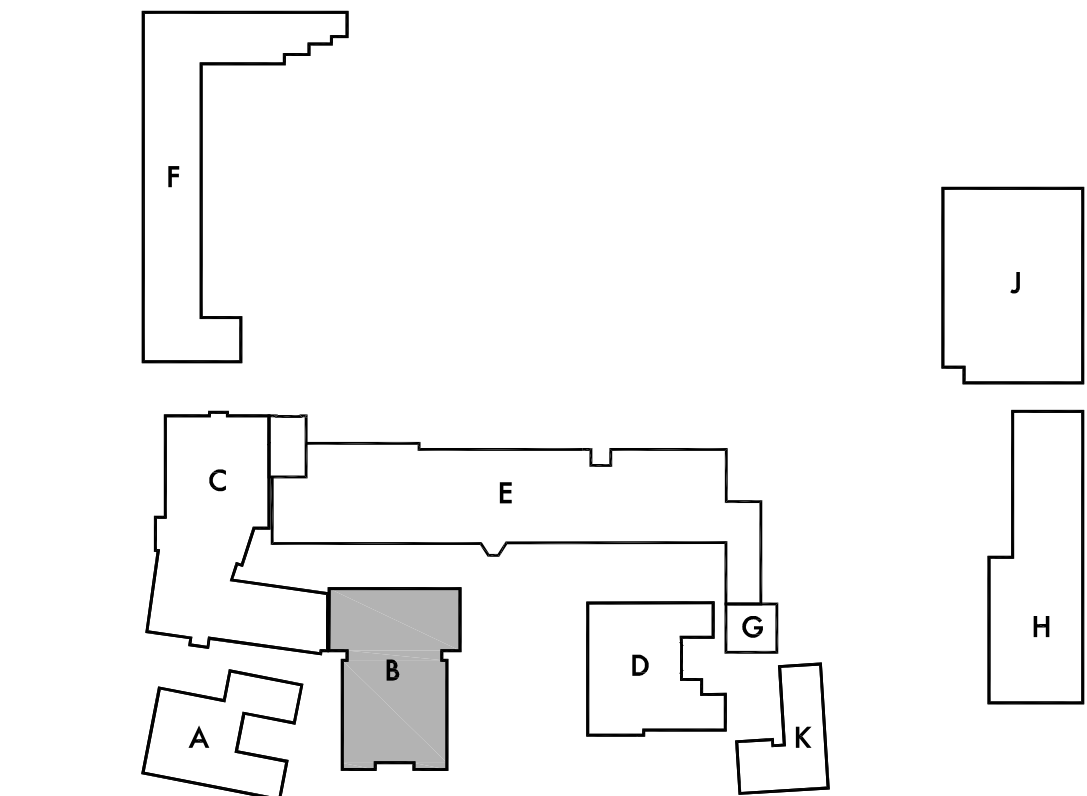1 -

	DENOTES MECHANICAL AIR HANDLING UNIT DESIGNATION. SEE MECHANICAL SHEETS FOR SCHEDULES.
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DSA Stamp

Architect




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Lincoln Middle School
1501 California Avenue
Santa Monica, California 90403

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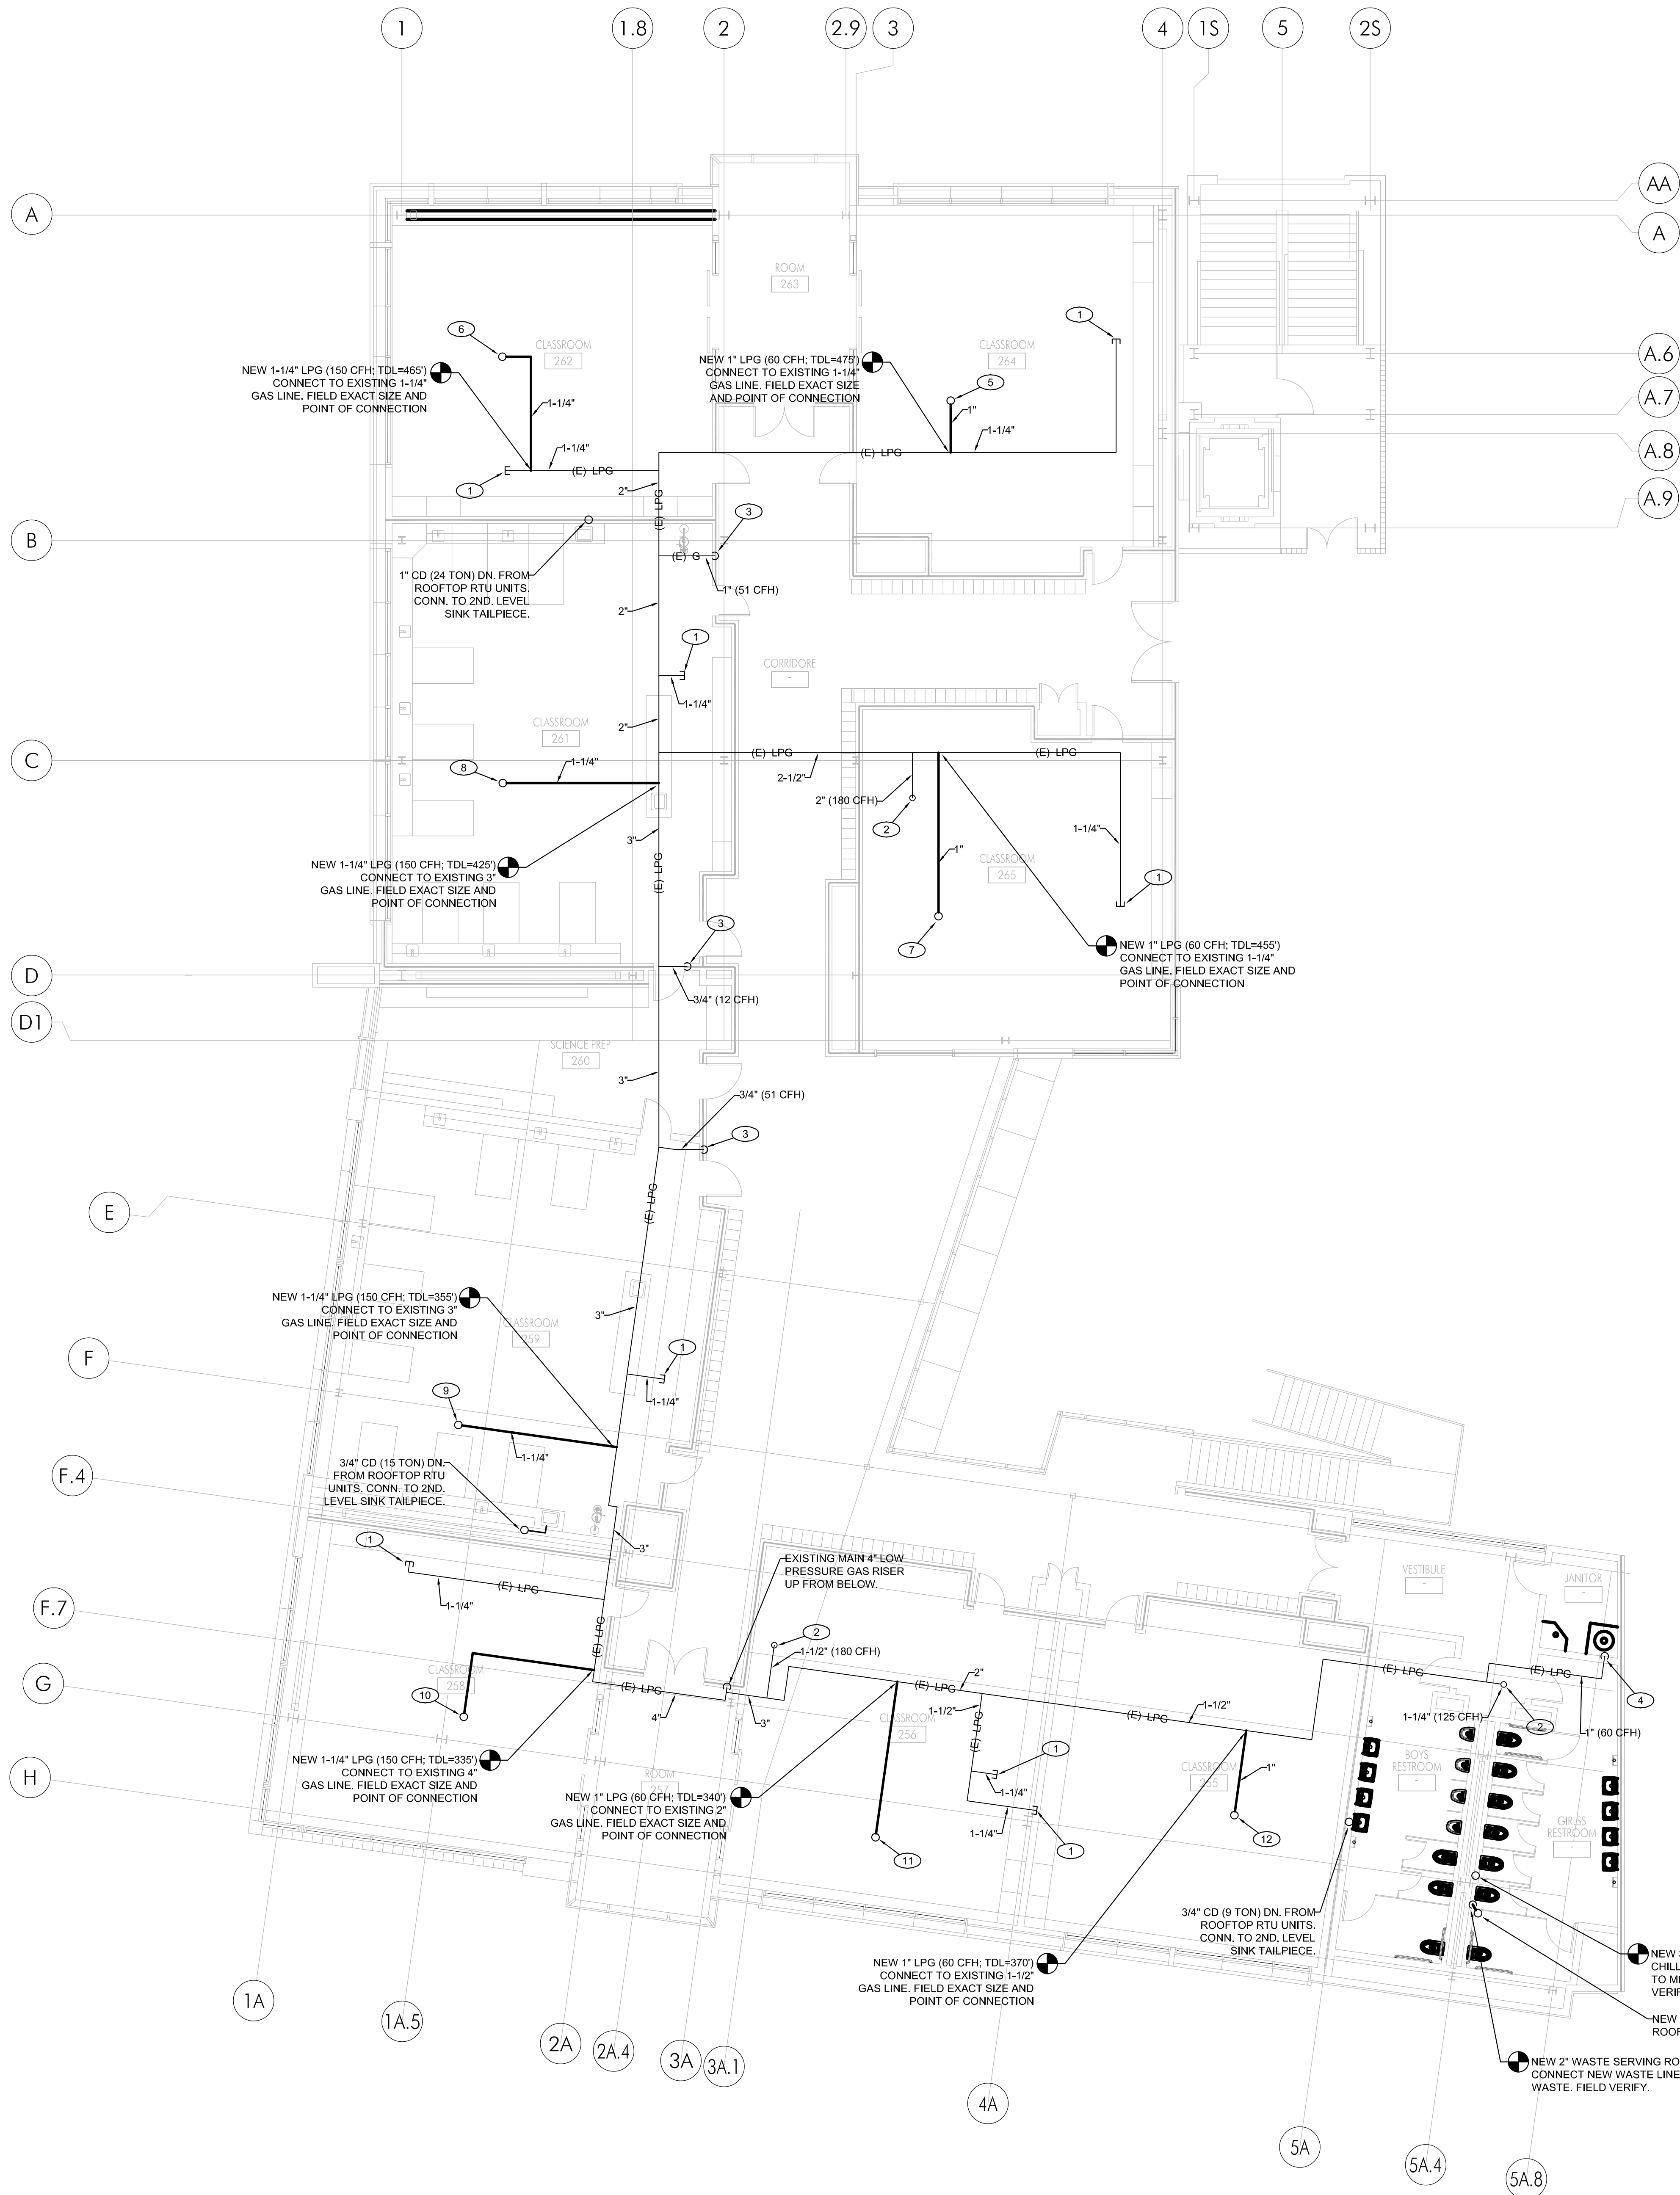


Sheet Title

Buildings 'B'
Mezzanine Level
Plumbing Plan

Sheet Number

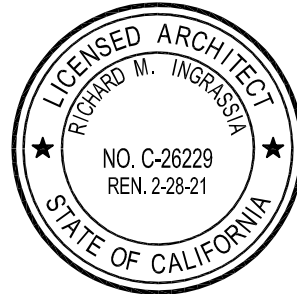PB202



KEYNOTES

- EXISTING GAS LINE TO BE CAPPED AS SHOWN. REMOVE ALL GAS LINE FROM THIS POINT SERVING REMOVED EXISTING FANCOIL UNIT. SEE MECHANICAL DEMOLITION PLANS.
- EXISTING GAS LINE UP SERVING ROOFTOP HVAC UNIT.
- EXISTING GAS LINE DOWN IN WALL SERVING SCIENCE LAB.
- EXISTING GAS LINE DOWN IN WALL SERVING EXISTING WATER HEATER.
- NEW 1" LPG (60CFH; TDL=475) UP TO SERVE NEW ROOFTOP HVAC UNIT
- NEW 1-1/4" LPG (150CFH; TDL=465) UP TO SERVE NEW ROOFTOP HVAC UNIT
- NEW 1" LPG (60CFH; TDL=455) UP TO SERVE NEW ROOFTOP HVAC UNIT
- NEW 1-1/4" LPG (150CFH; TDL=425) UP TO SERVE NEW ROOFTOP HVAC UNIT
- NEW 1-1/4" LPG (150CFH; TDL=355) UP TO SERVE NEW ROOFTOP HVAC UNIT
- NEW 1-1/4" LPG (150CFH; TDL=335) UP TO SERVE NEW ROOFTOP HVAC UNIT
- NEW 1" LPG (60CFH; TDL=340) UP TO SERVE NEW ROOFTOP HVAC UNIT
- NEW 1" LPG (60CFH; TDL=370) UP TO SERVE NEW ROOFTOP HVAC UNIT

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Lincoln Middle School HVAC Replacement Project


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Project No. 19009

Sheet Title

Building 'C'

Second Floor

Plumbing Plan

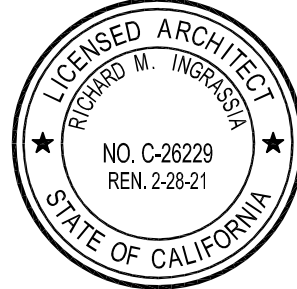
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PC202




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KEY PLAN



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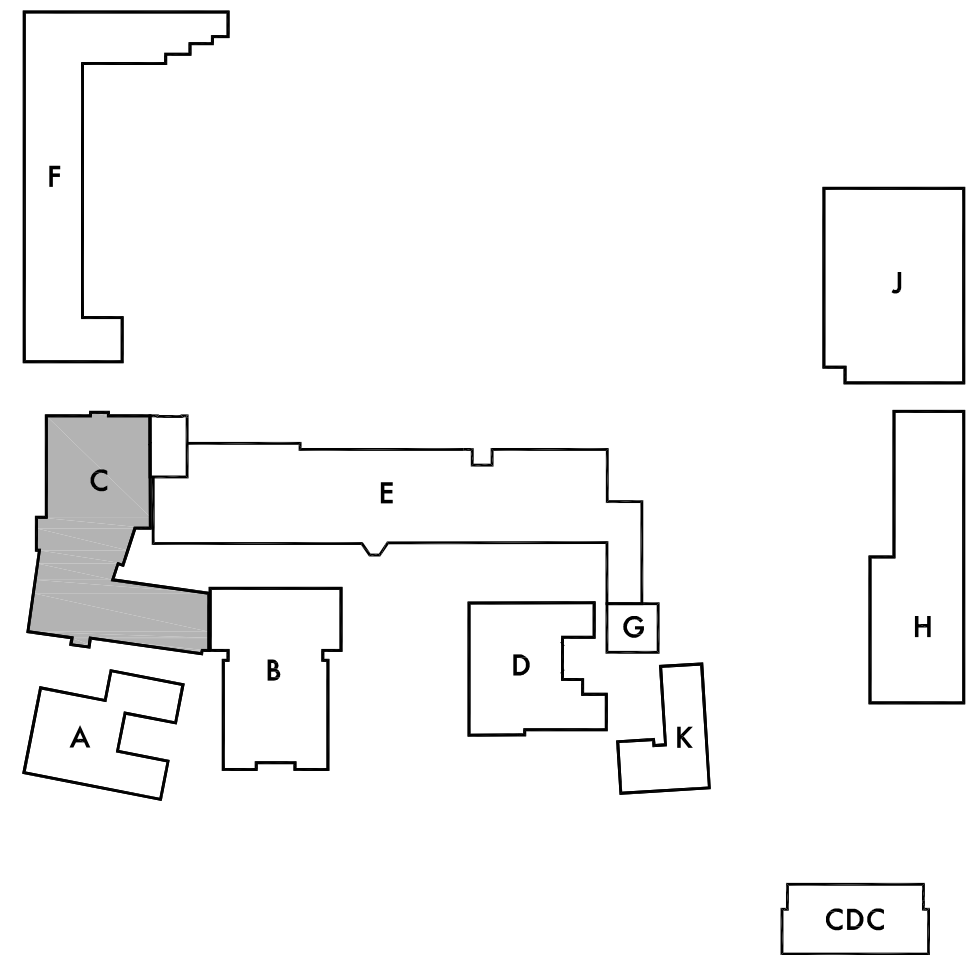

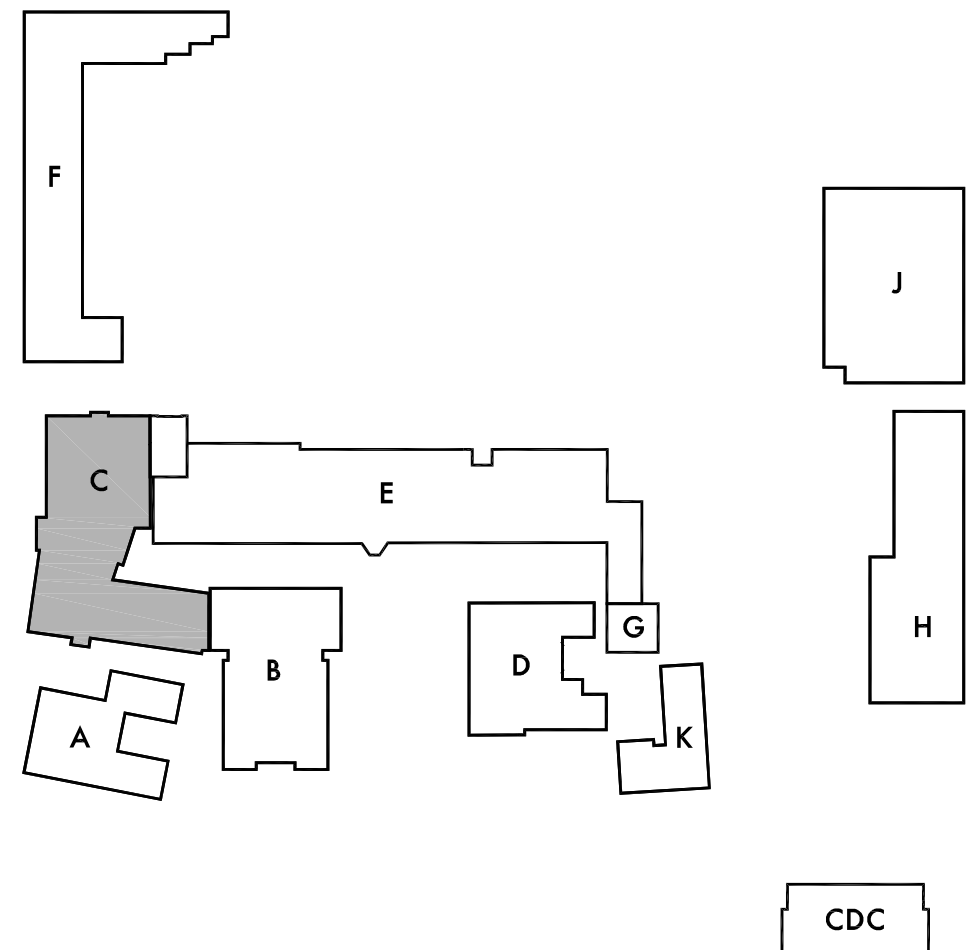
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KEYNOTES

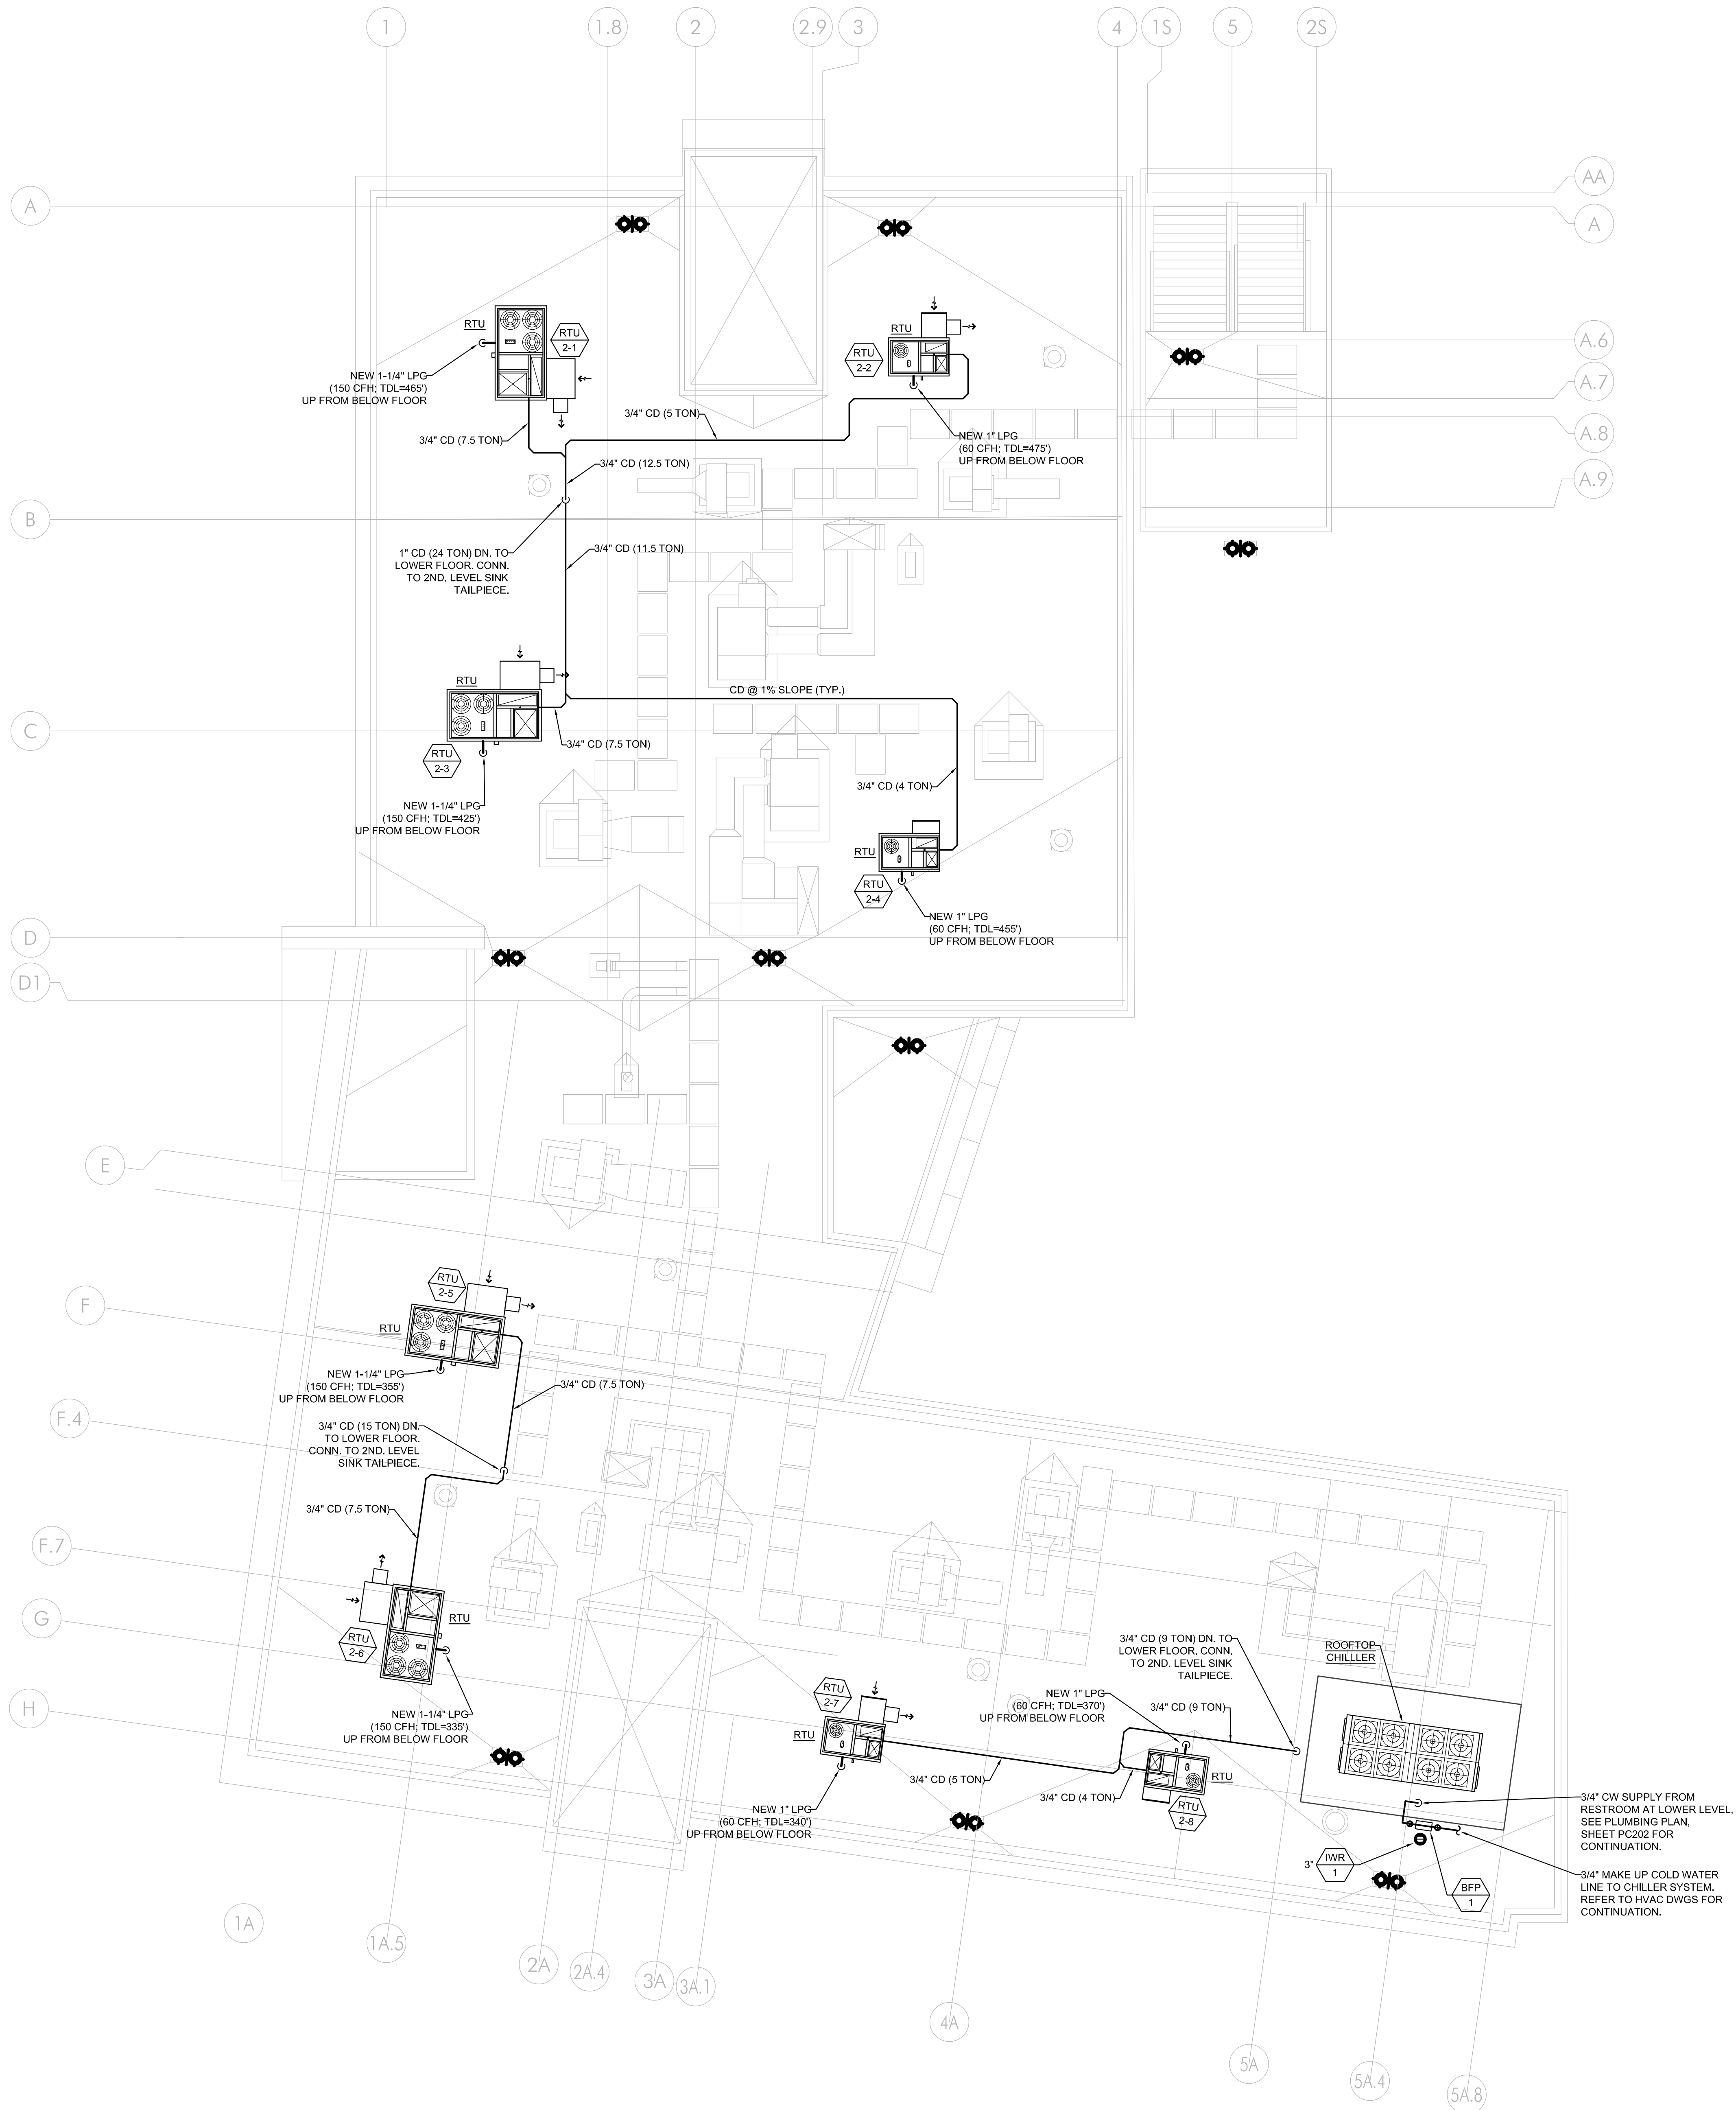1 XX-XX

LEGEND	
	DENOTES MECHANICAL ROOFTOP UNIT DESIGNATION. SEE MECHANICAL SHEETS FOR SCHEDULES.



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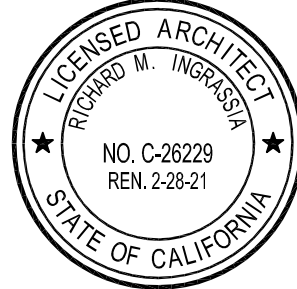
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Lincoln Middle School
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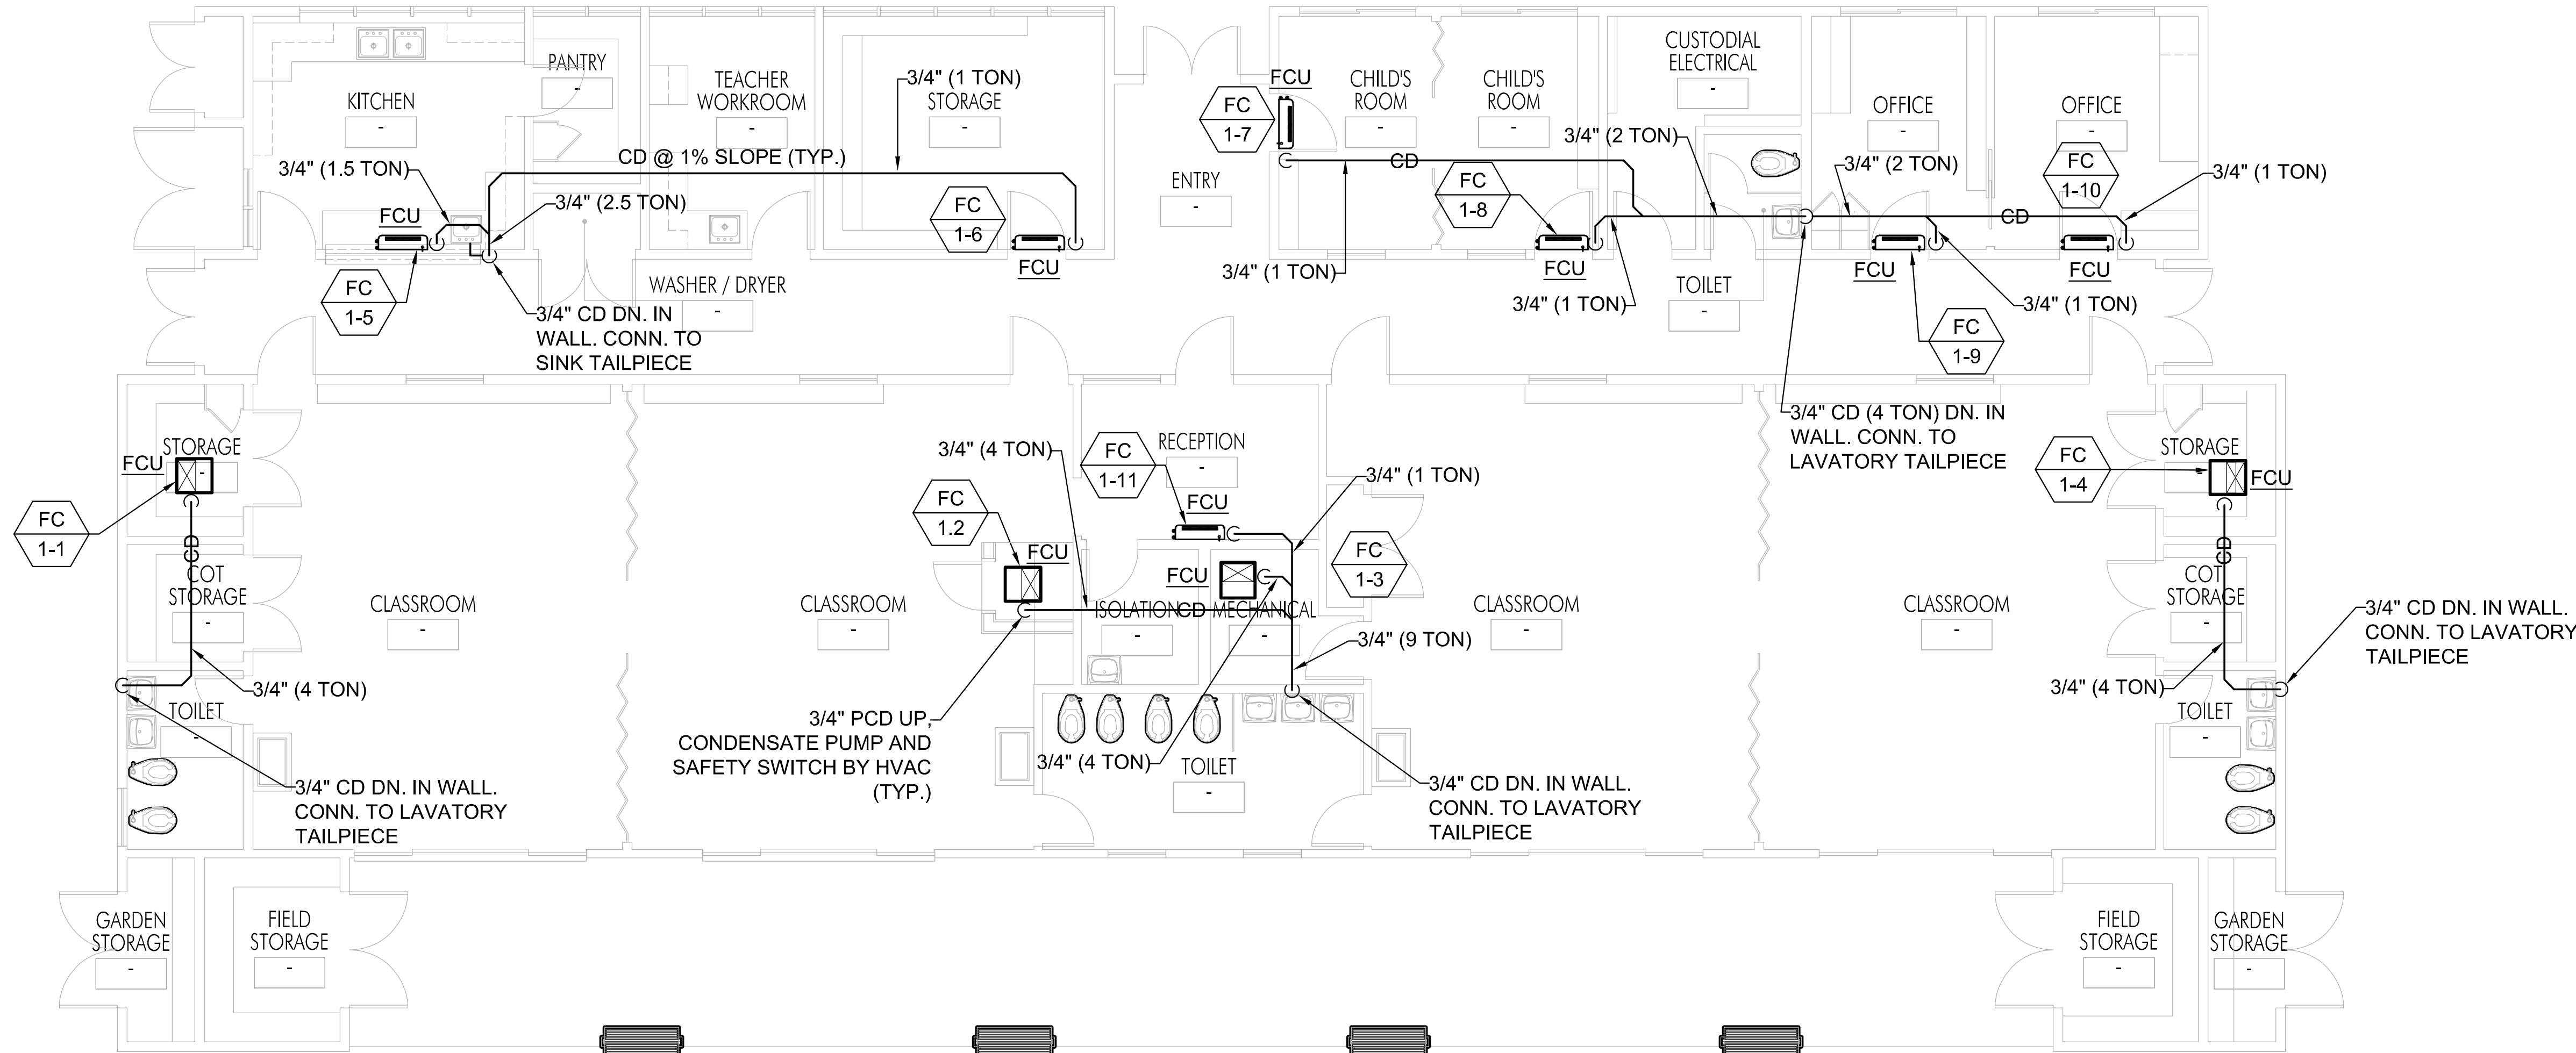
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Building 'C'
Plumbing Roof Plan

Sheet Number

PC203

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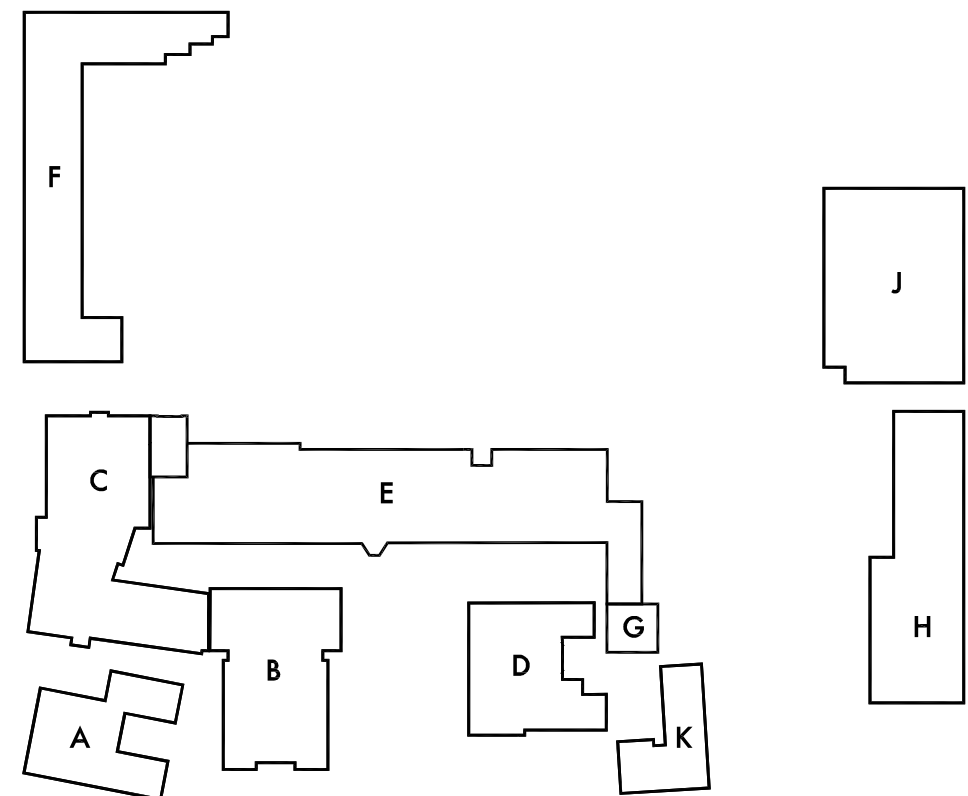
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KEYNOTES

1 -

LEGEND

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KEY PLAN

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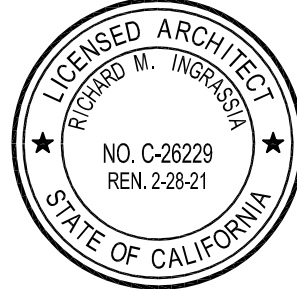
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Sheet Title
Building 'CDC'
First Floor
Plumbing Plans

Sheet Number


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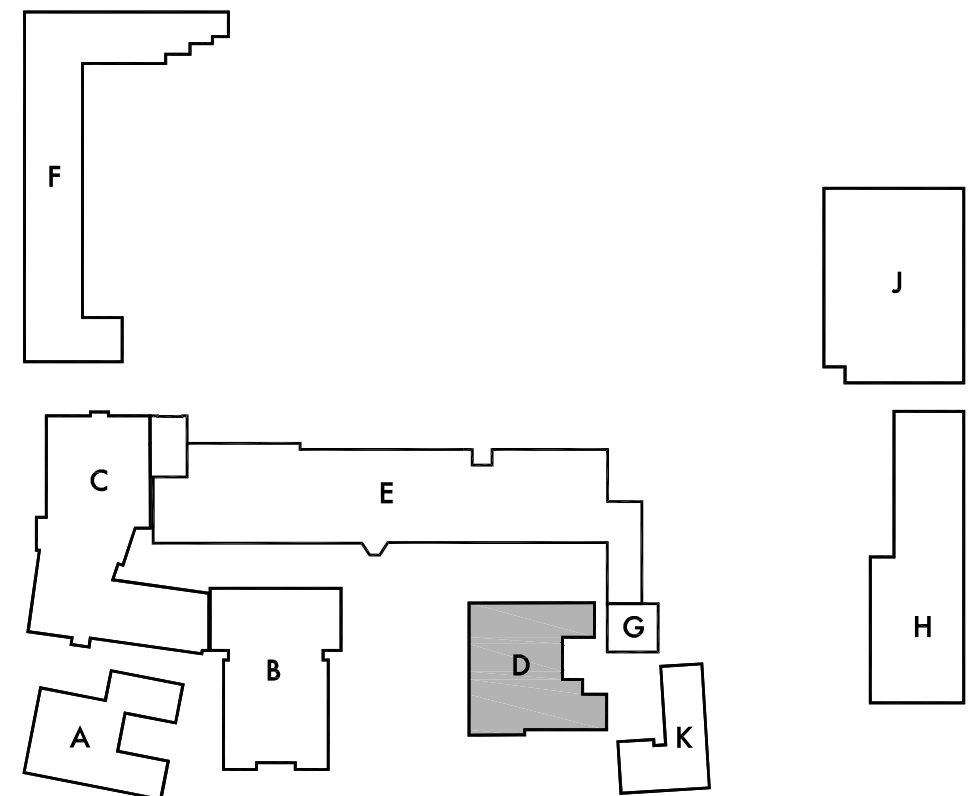
1 XX-XX

LEGEND

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1 PLUMBING PLAN



KEY PLAN

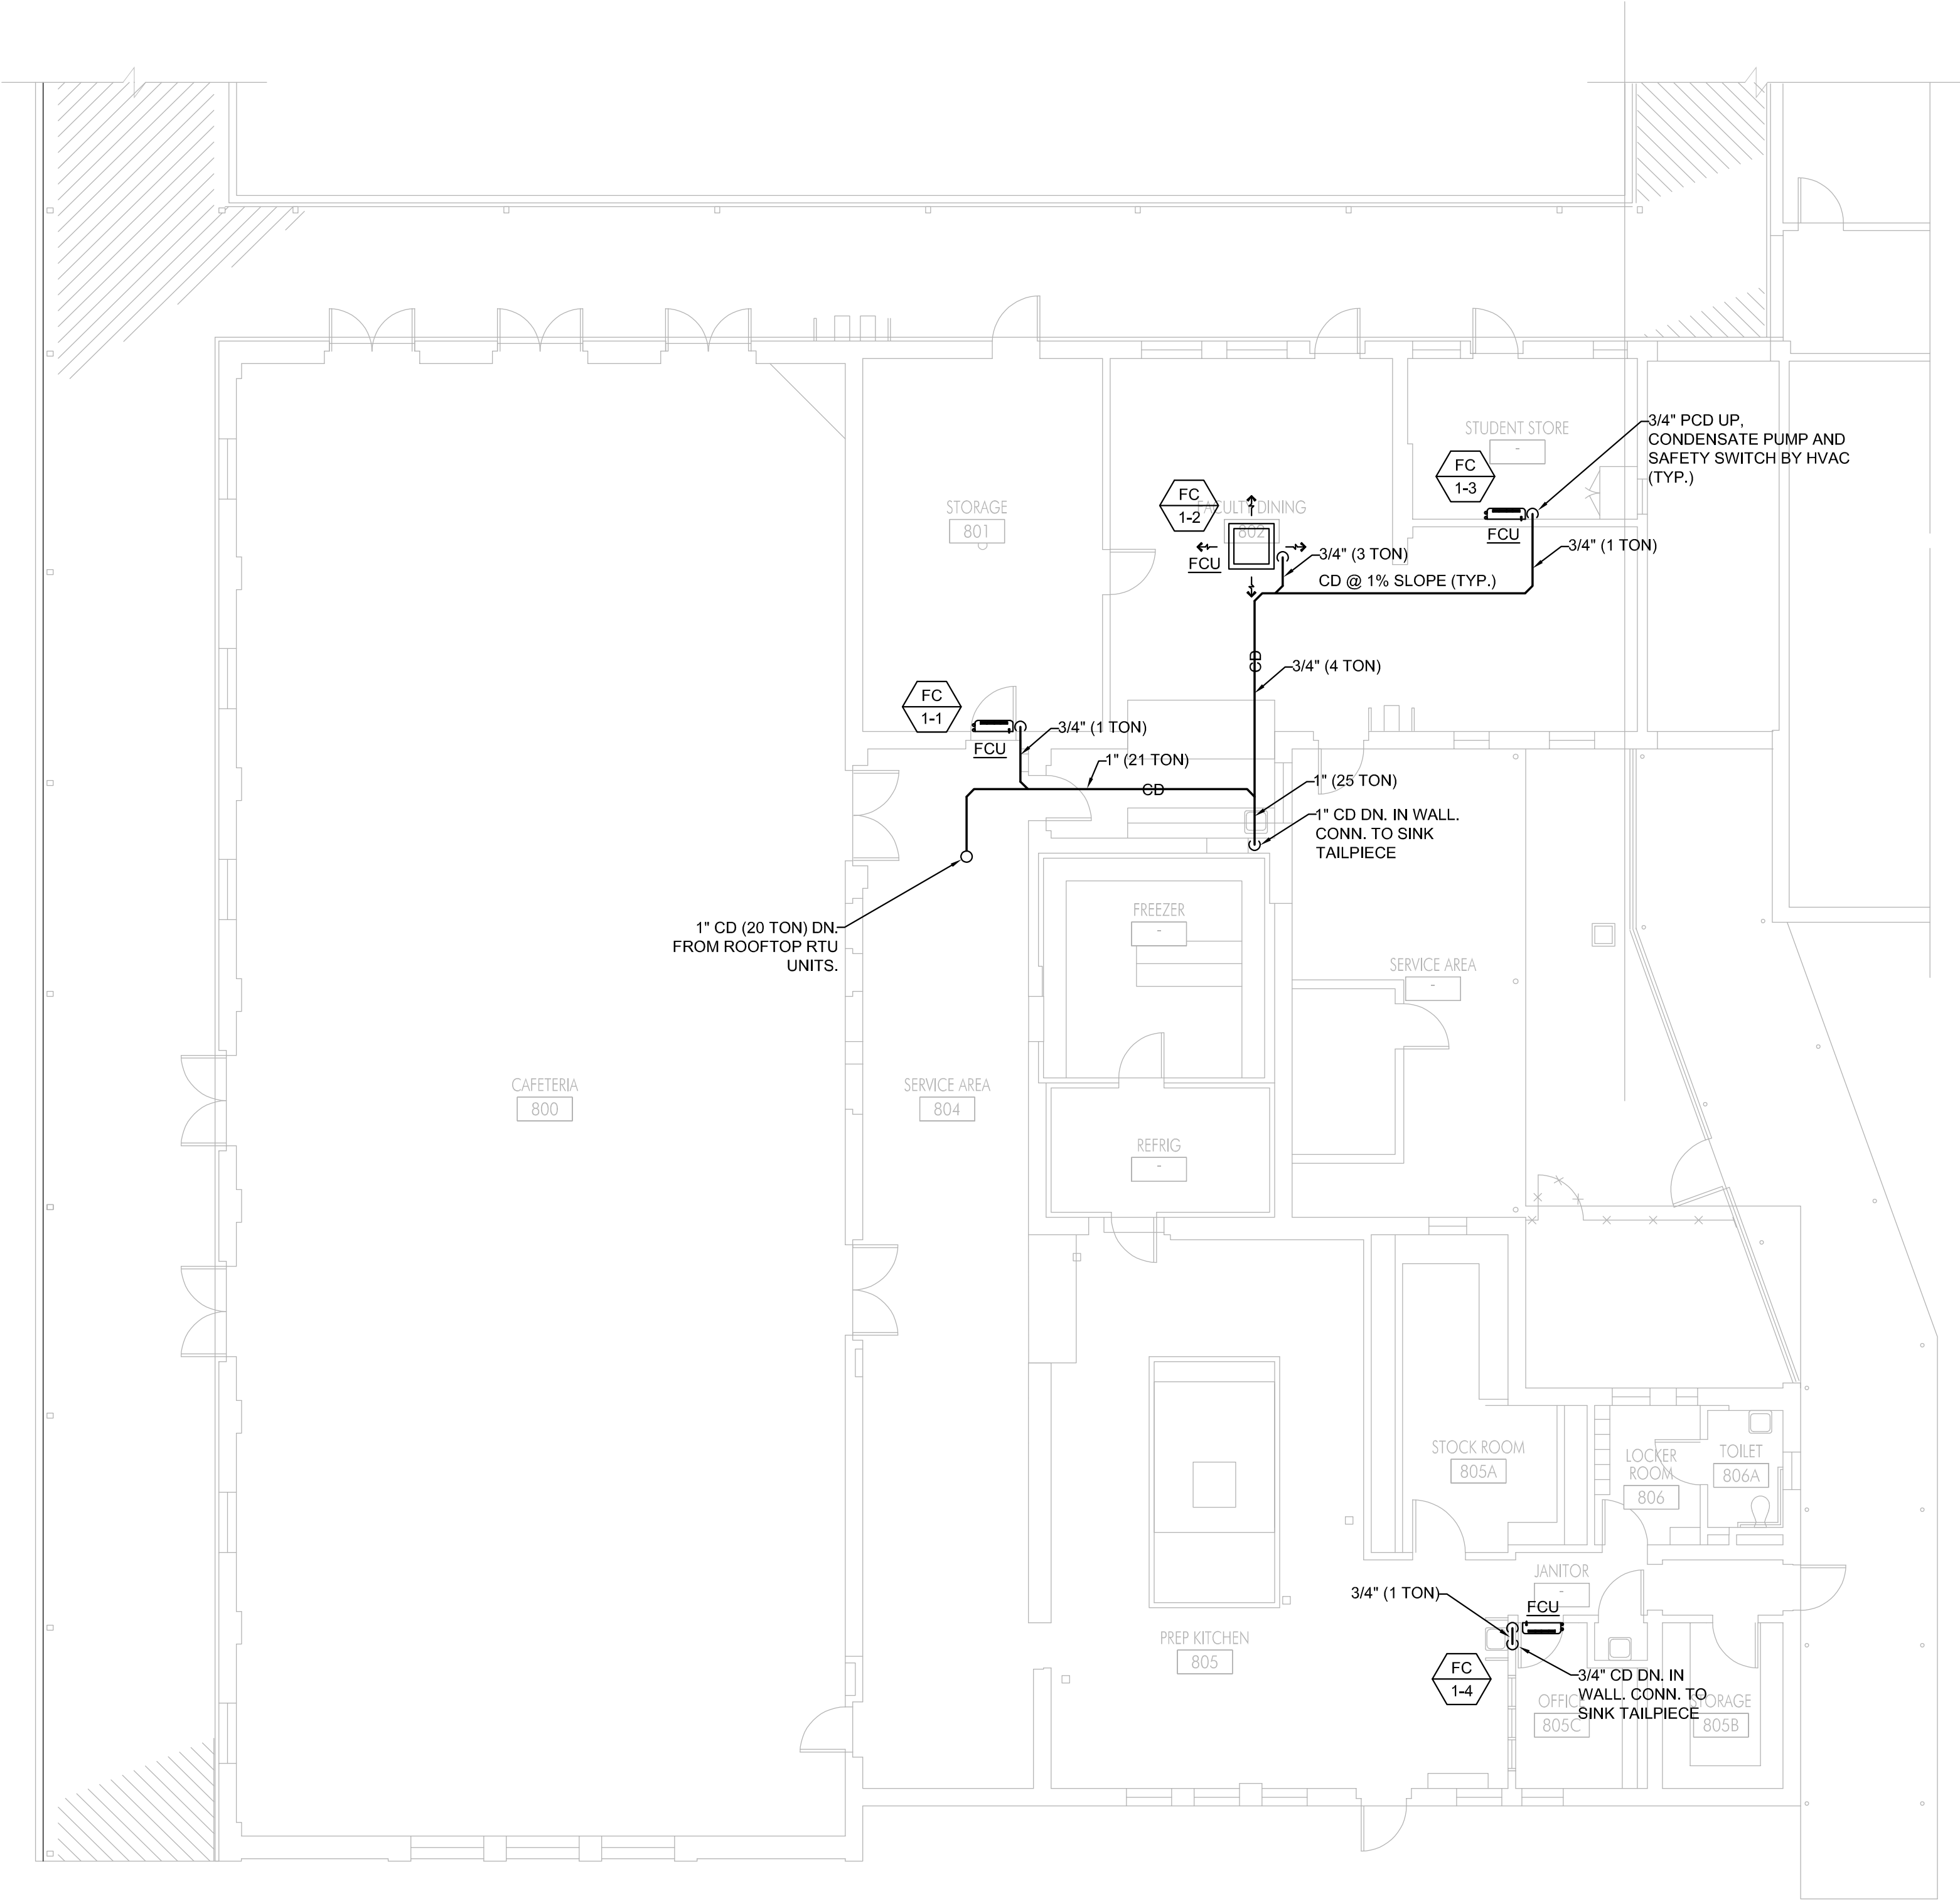Architect




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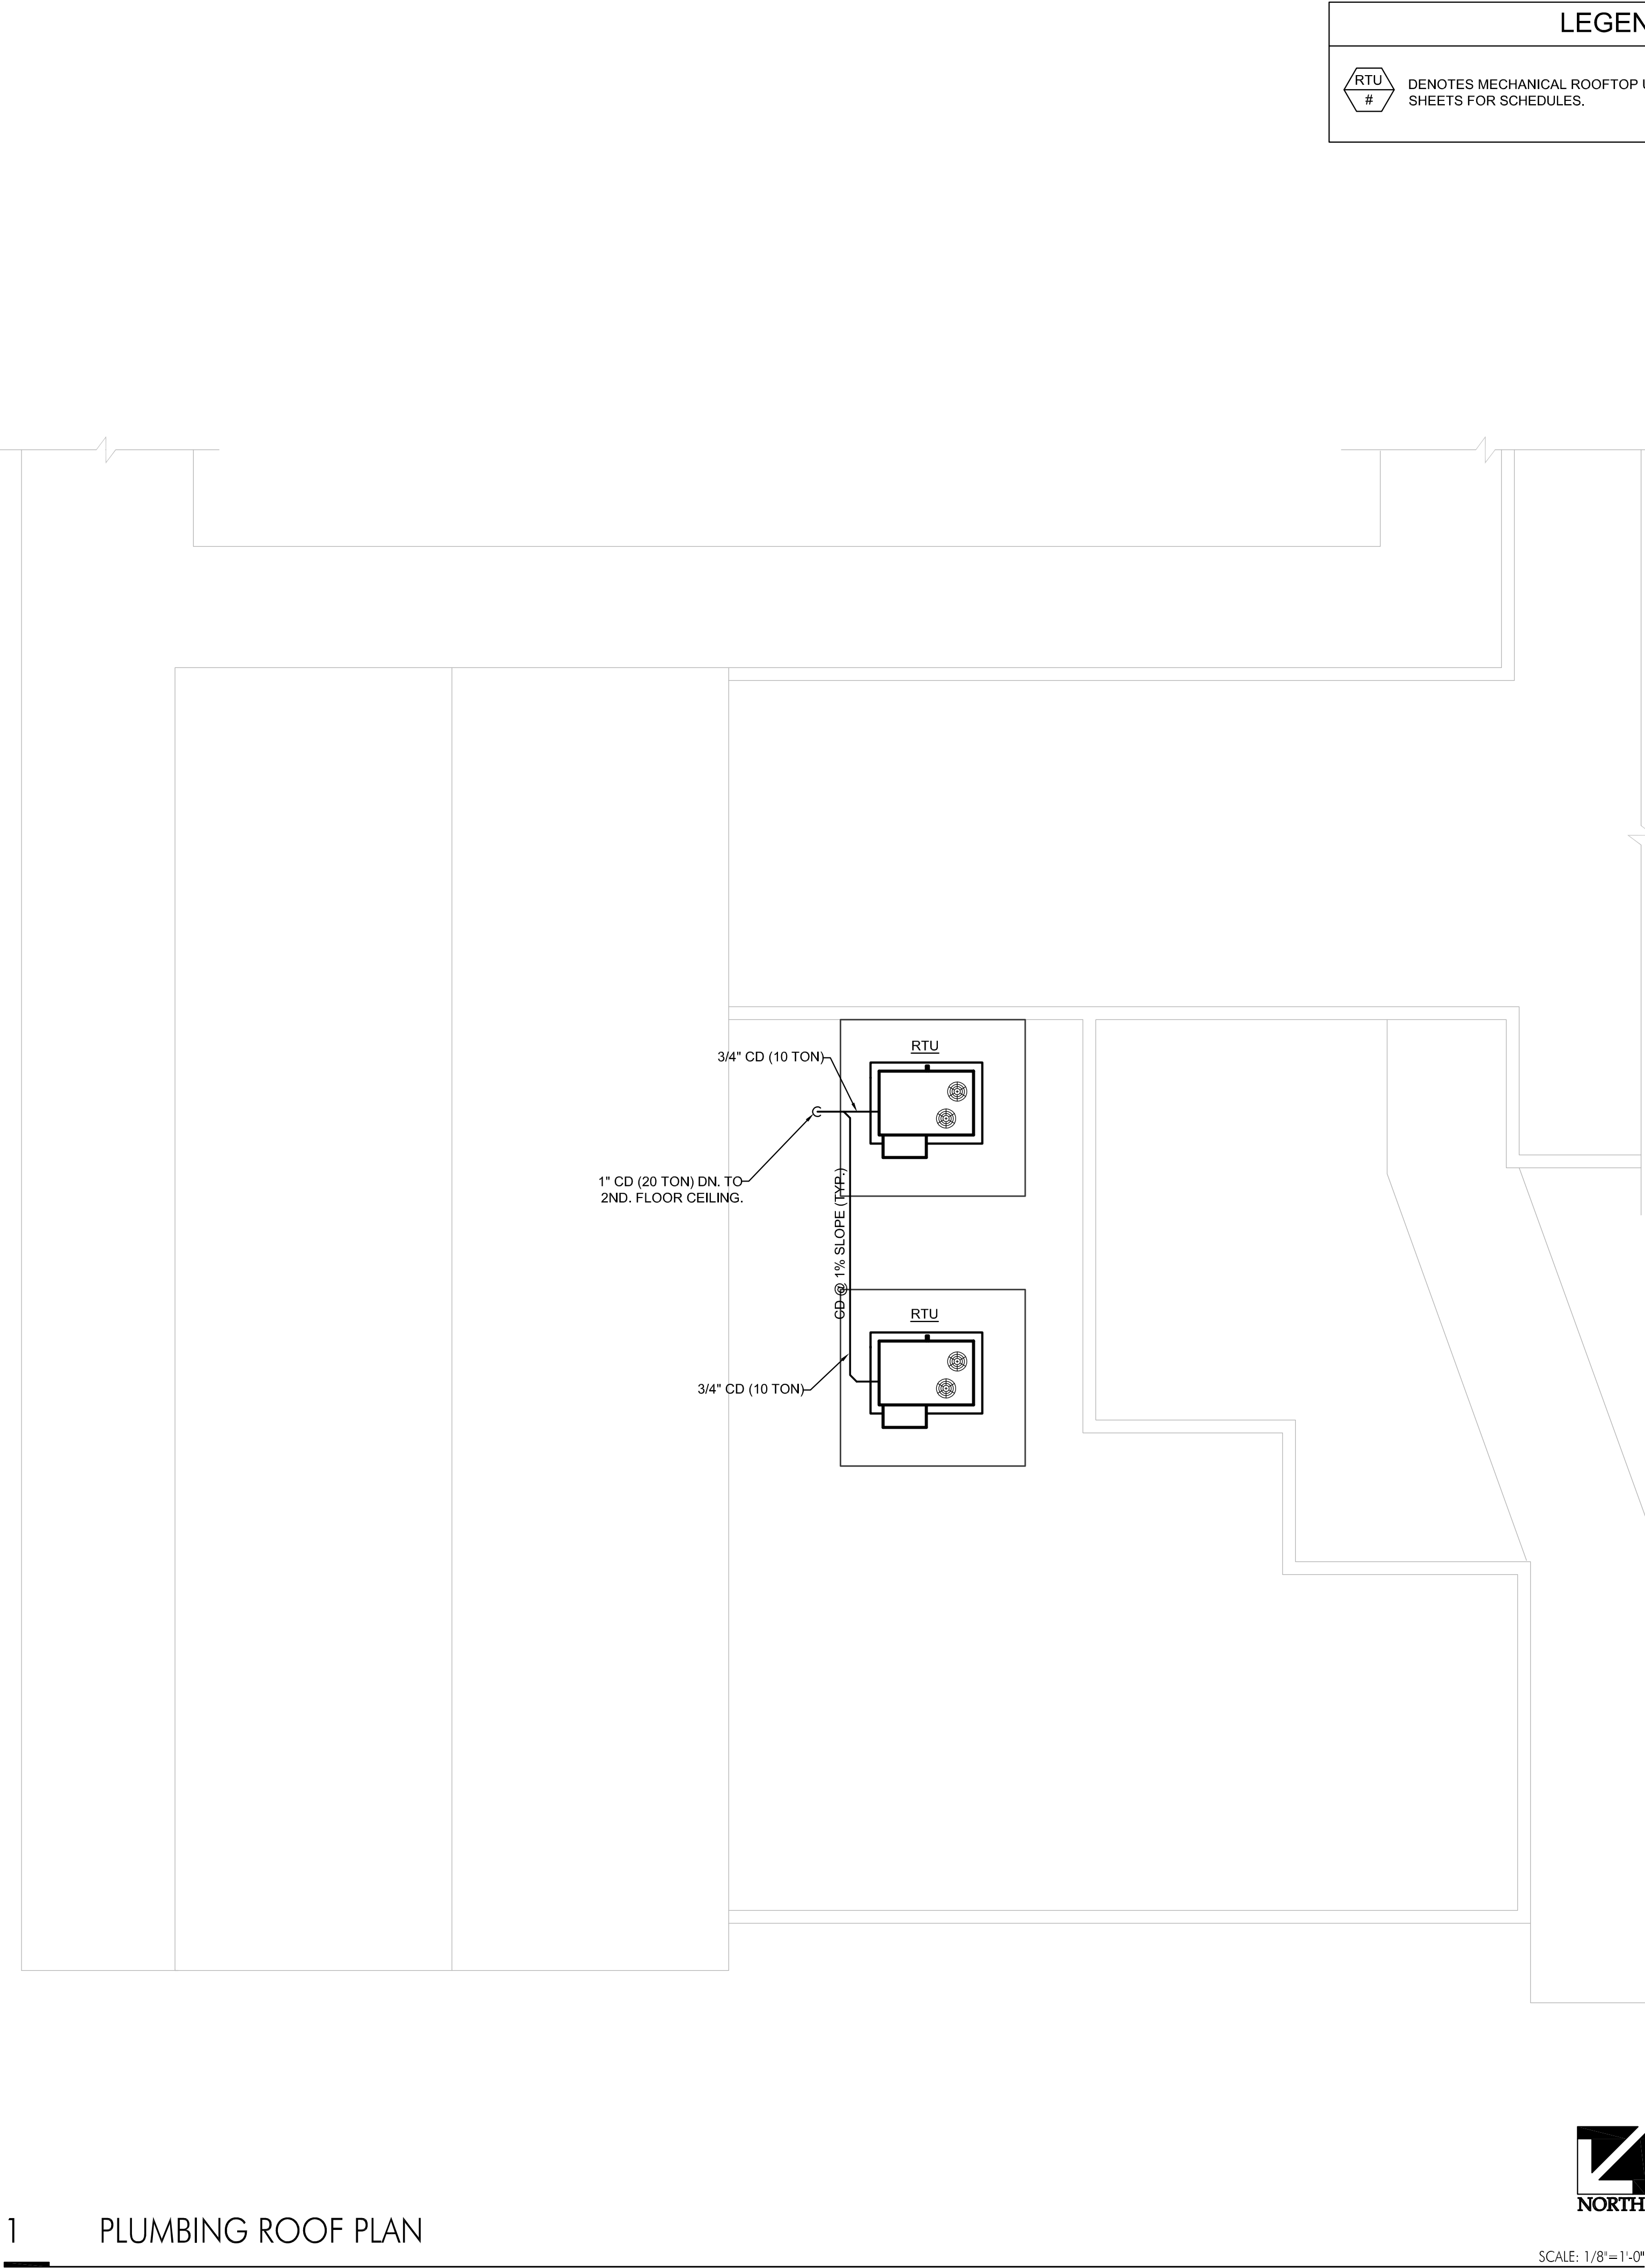
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Project No. 19009


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Building 'D'
First Floor
Plumbing Plans

Sheet Number


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KEYNOTES

1 XX-XX

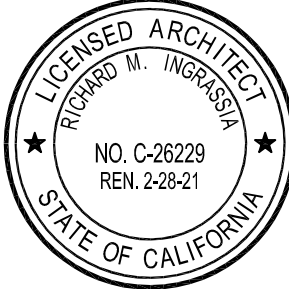

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Architect

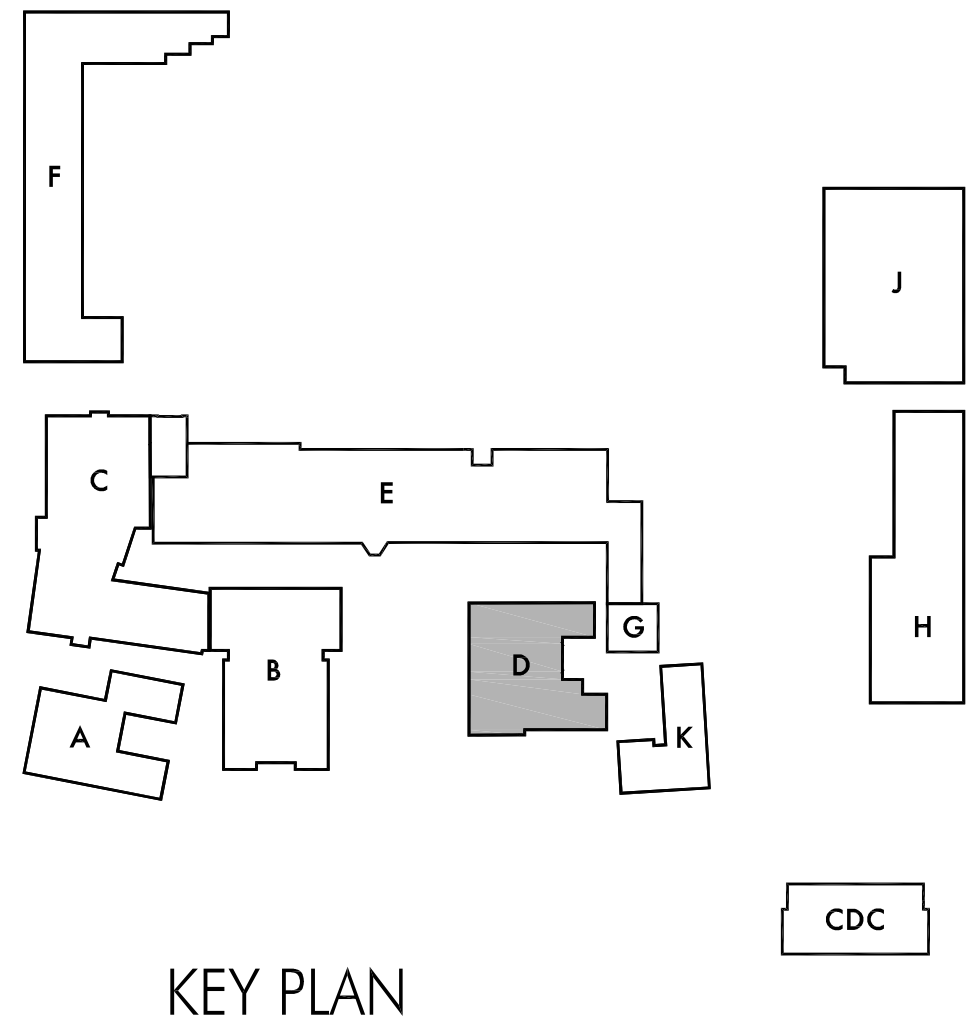


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Santa Monica, California 90403

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Sheet Title
Building 'D'
Plumbing
Roof Plan

Sheet Number

PD202

Architect

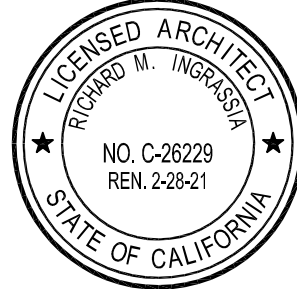


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Lincoln Middle School
1501 California Avenue
Santa Monica, California 90403

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Sheet Title

Building 'E'
First Floor
Plumbing Plan
Segment A

Sheet Number

PE201A

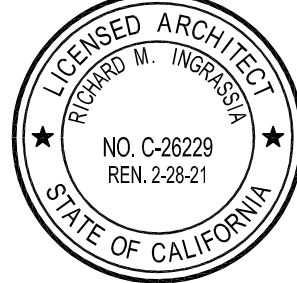LEGEND

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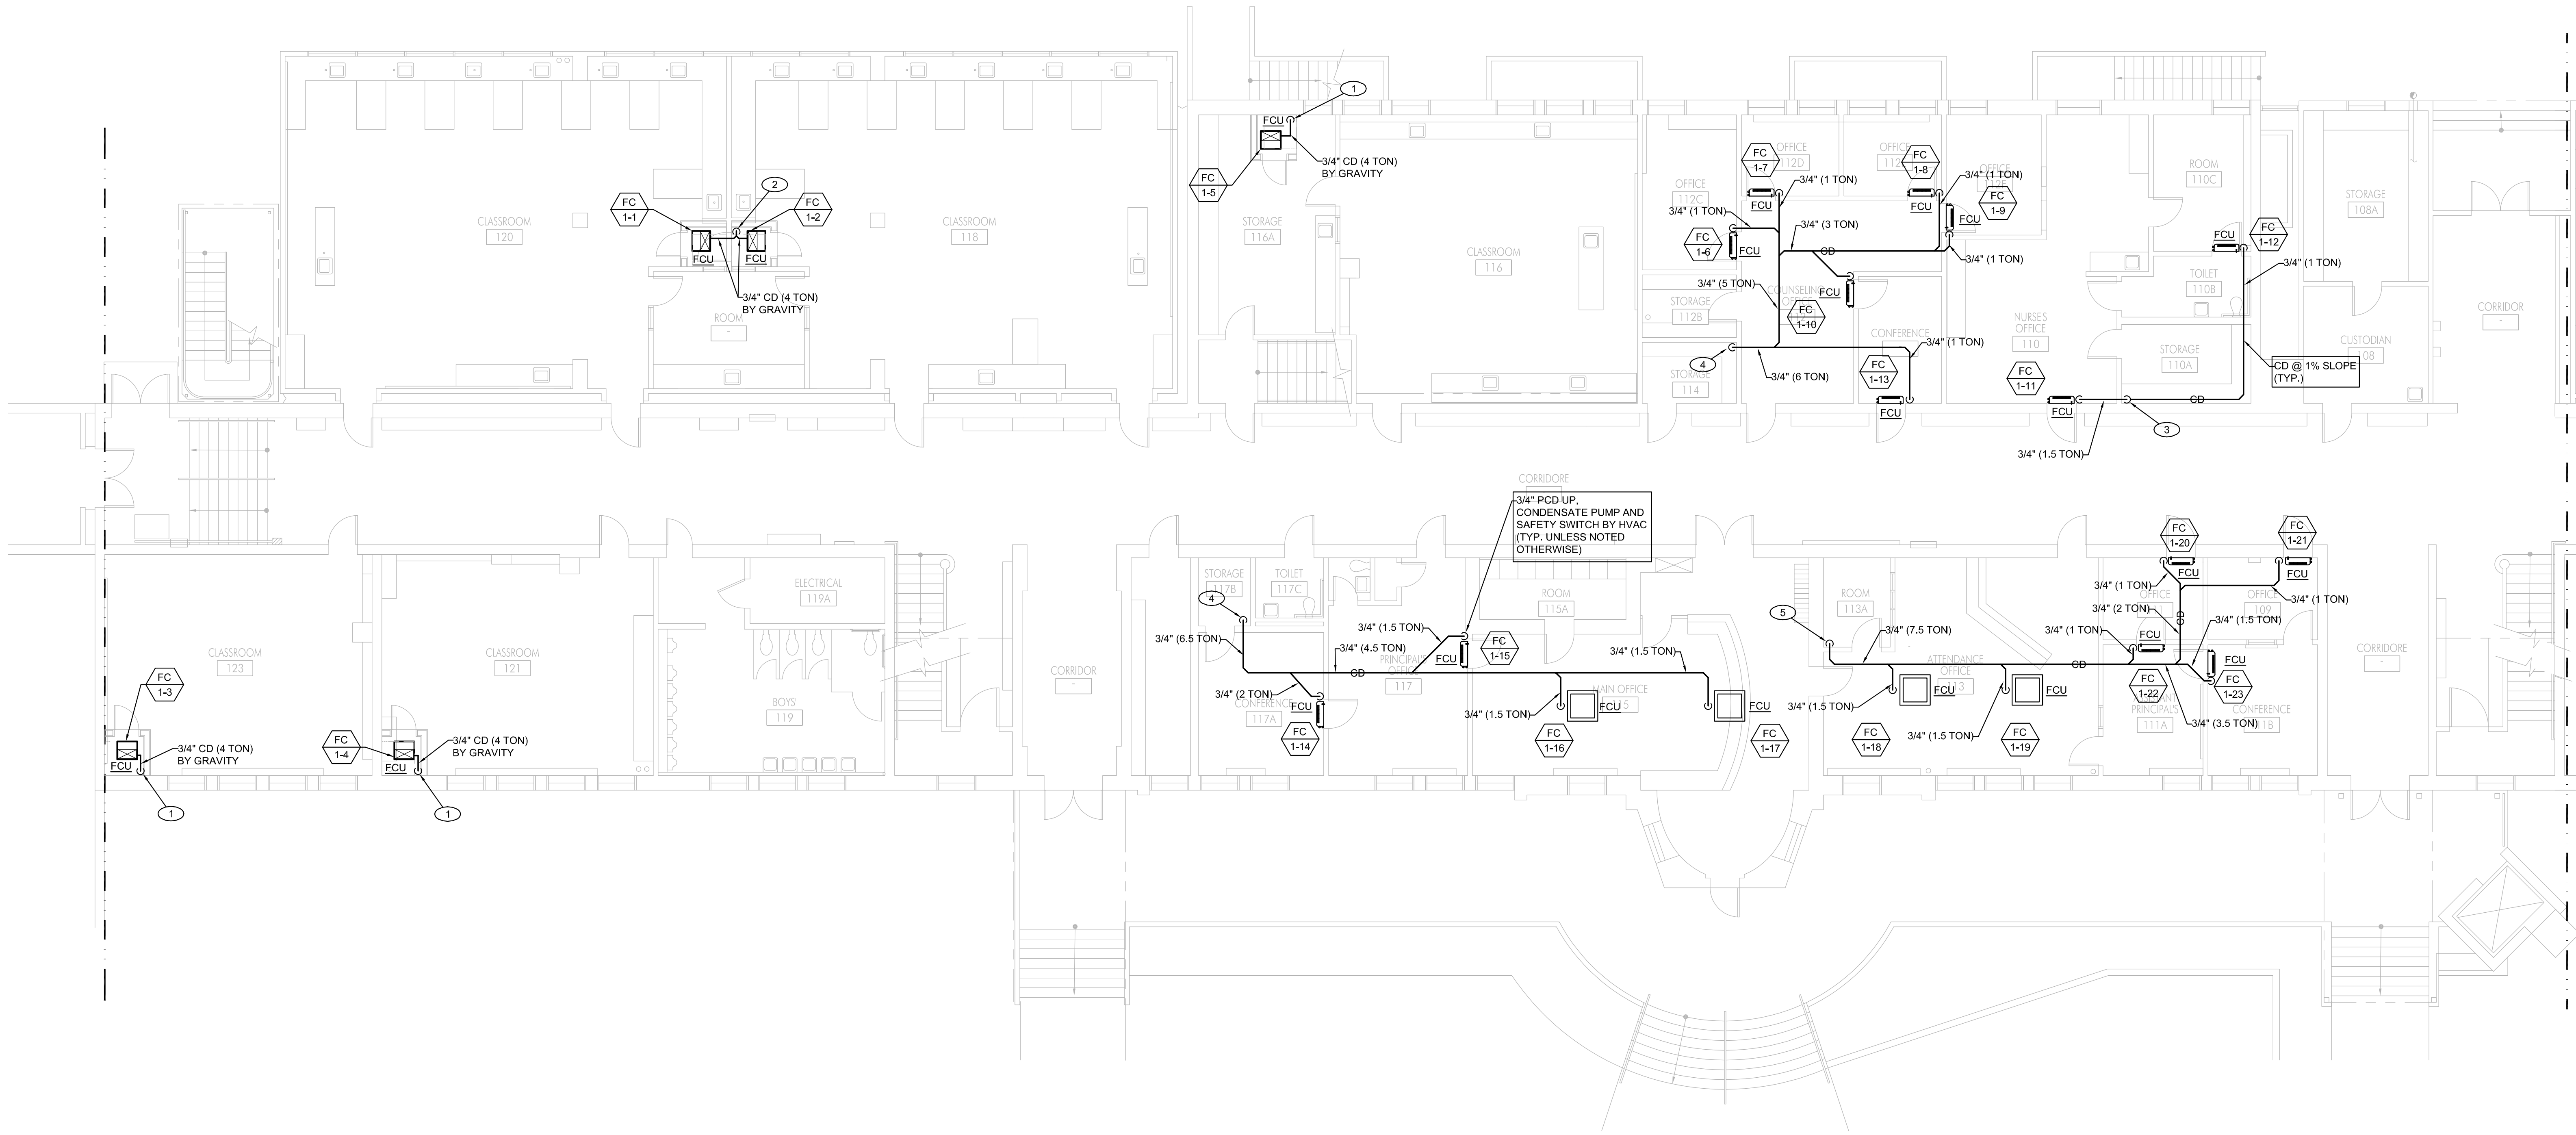
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IF CONTRACTOR OPTED TO COMBINE CONDENSATE DRAINS AT BASEMENT BEFORE IT TERMINATES TO AN ACCEPTABLE RECEPTOR, A SIZING TABLE SHOULD BE FOLLOWED AS SHOWN BELOW:

EQUIPMENT CAPACITY (TONS)	MINIMUM CONDENSATE DRAIN SIZE (INCHES)
0 - 20	3/4"
21 - 40	1"
41 - 90	1-1/4"

KEYNOTES


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- 3/4" CD (8 TON) DN. INTO BASEMENT. CD TO BE ROUTED AND DRAINED ONTO EXISTING FLOOR SINK OR ACCEPTABLE RECEPTOR AT BOILER ROOM. CONTRACTOR TO FIELD VERIFY EXISTING LOCATION.
- 3/4" CD (2.5 TON) DN. ALONG WALL INTO BASEMENT. CD TO BE ROUTED AND DRAINED ONTO EXISTING FLOOR SINK OR ACCEPTABLE RECEPTOR AT BOILER ROOM. CONTRACTOR TO FIELD VERIFY EXISTING LOCATION.
- 3/4" CD (6 TON) DN. ALONG WALL INTO BASEMENT. CD TO BE ROUTED AND DRAINED ONTO EXISTING FLOOR SINK OR ACCEPTABLE RECEPTOR AT BOILER ROOM. CONTRACTOR TO FIELD VERIFY EXISTING LOCATION.
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1 FIRST FLOOR PLUMBING PLAN - SEGMENT A




SCALE: 1/8"=1'-0"



KEY PLAN

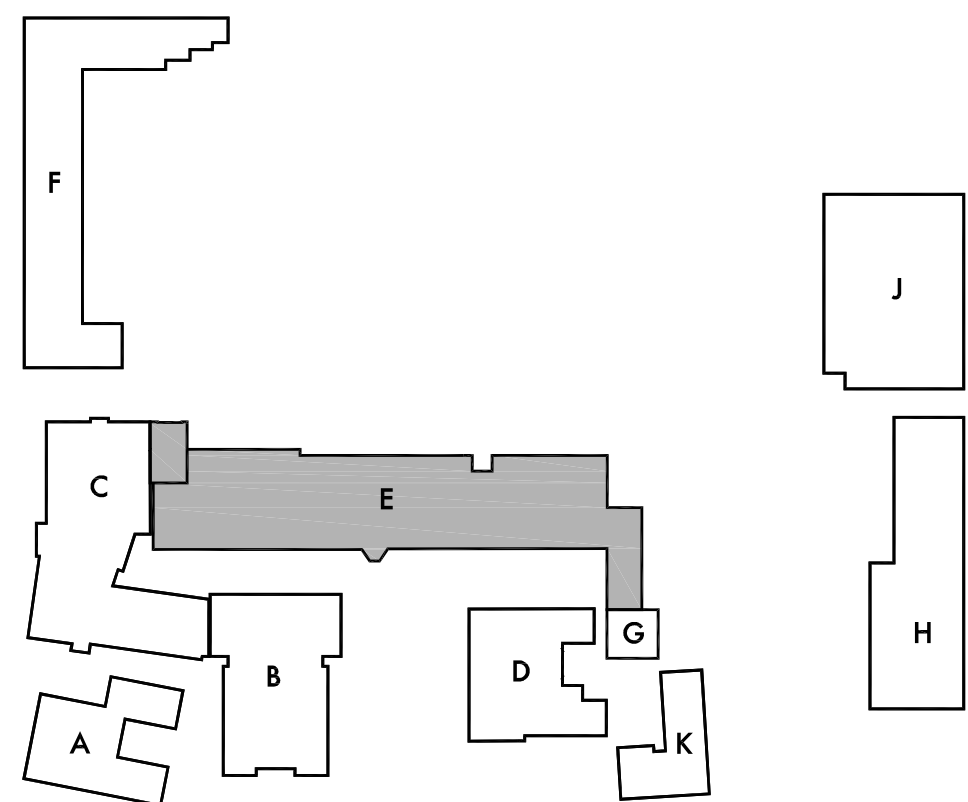1 FIRST FLOOR PLUMBING PLAN - SEGMENT B

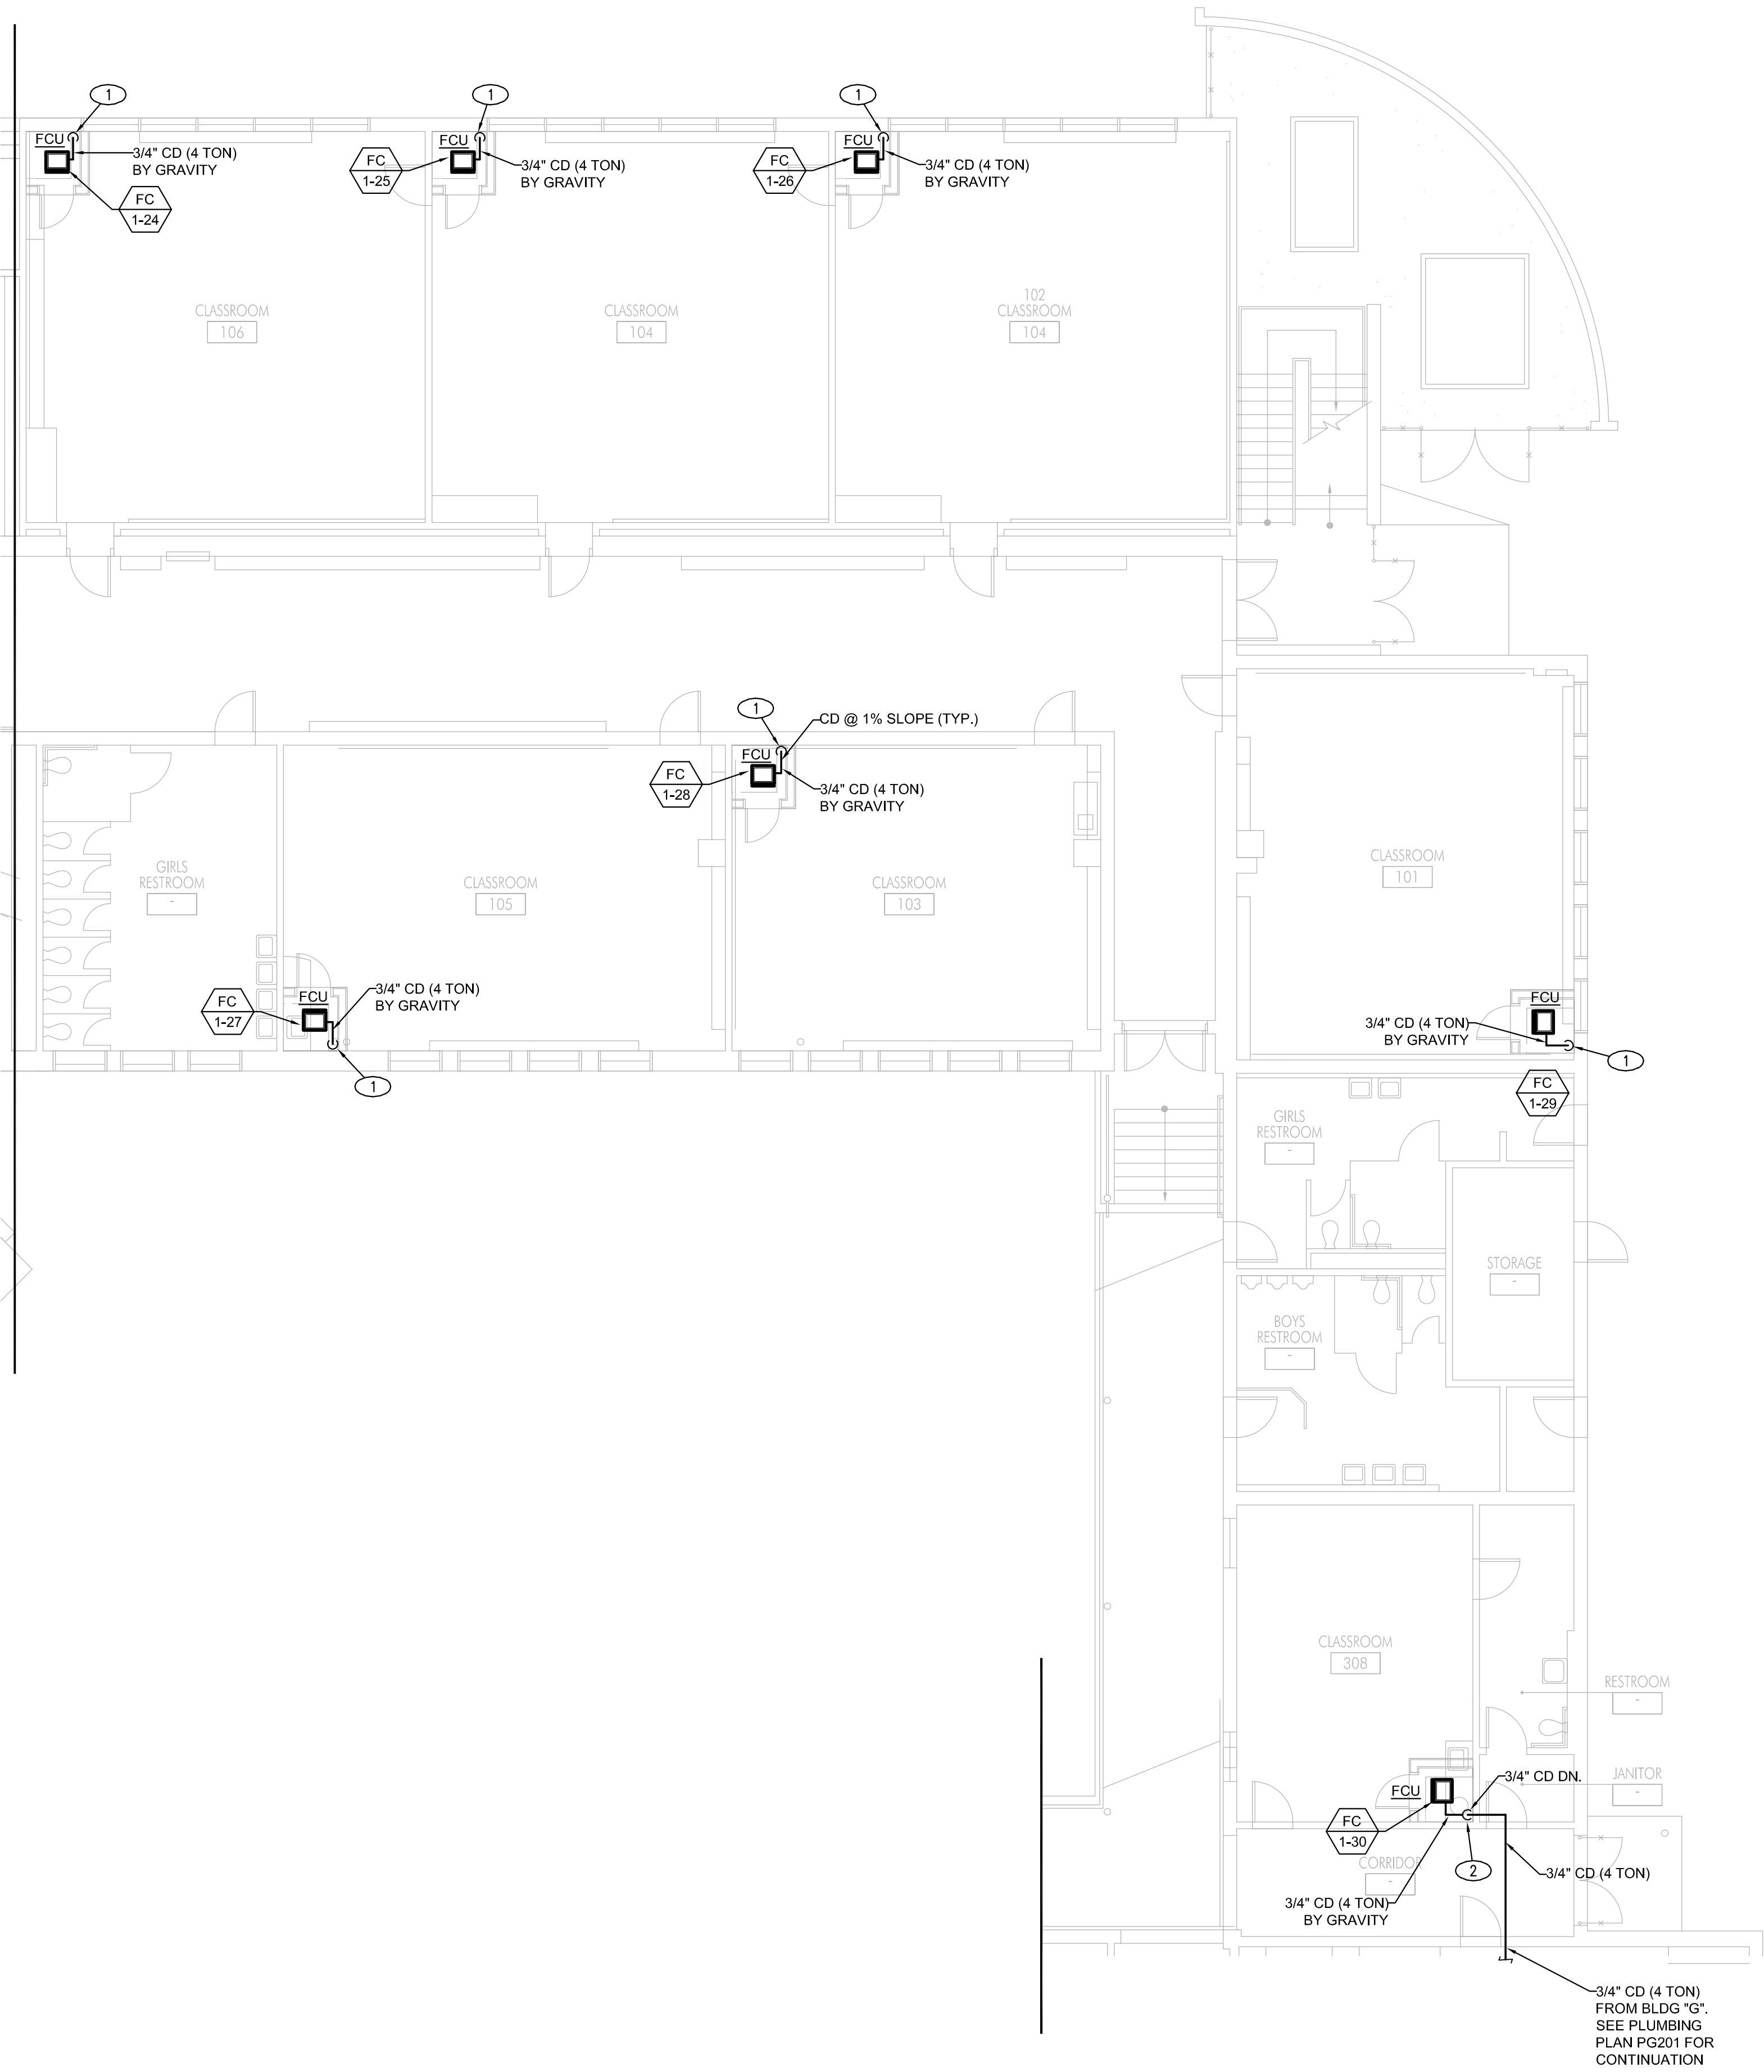

SCALE: 1/8"=1'-0"

KEYNOTES

- ① 3/4" CD (4 TON) DN. INTO BASEMENT. CD TO BE ROUTED AND DRAINED ONTO EXISTING FLOOR SINK OR ACCEPTABLE RECEPTOR AT BOILER ROOM. CONTRACTOR TO FIELD VERIFY EXISTING LOCATION.
- ② 3/4" CD (8 TON) DN. INTO BASEMENT. CD TO BE ROUTED AND DRAINED ONTO EXISTING FLOOR SINK OR ACCEPTABLE RECEPTOR AT BOILER ROOM. CONTRACTOR TO FIELD VERIFY EXISTING LOCATION.


NOTE:

IF CONTRACTOR OPTED TO COMBINE CONDENSATE DRAINS AT BASEMENT BEFORE IT TERMINATES TO AN ACCEPTABLE RECEPTOR, A SIZING TABLE SHOULD BE FOLLOWED AS SHOWN BELOW:

EQUIPMENT CAPACITY (TONS)	MINIMUM CONDENSATE DRAIN SIZE (INCHES)
0 - 20	3/4"
21 - 40	1"
41 - 90	1-1/4"

LEGEND

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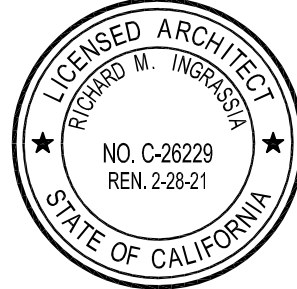
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Lincoln Middle School
1501 California Avenue
Santa Monica, California 90403
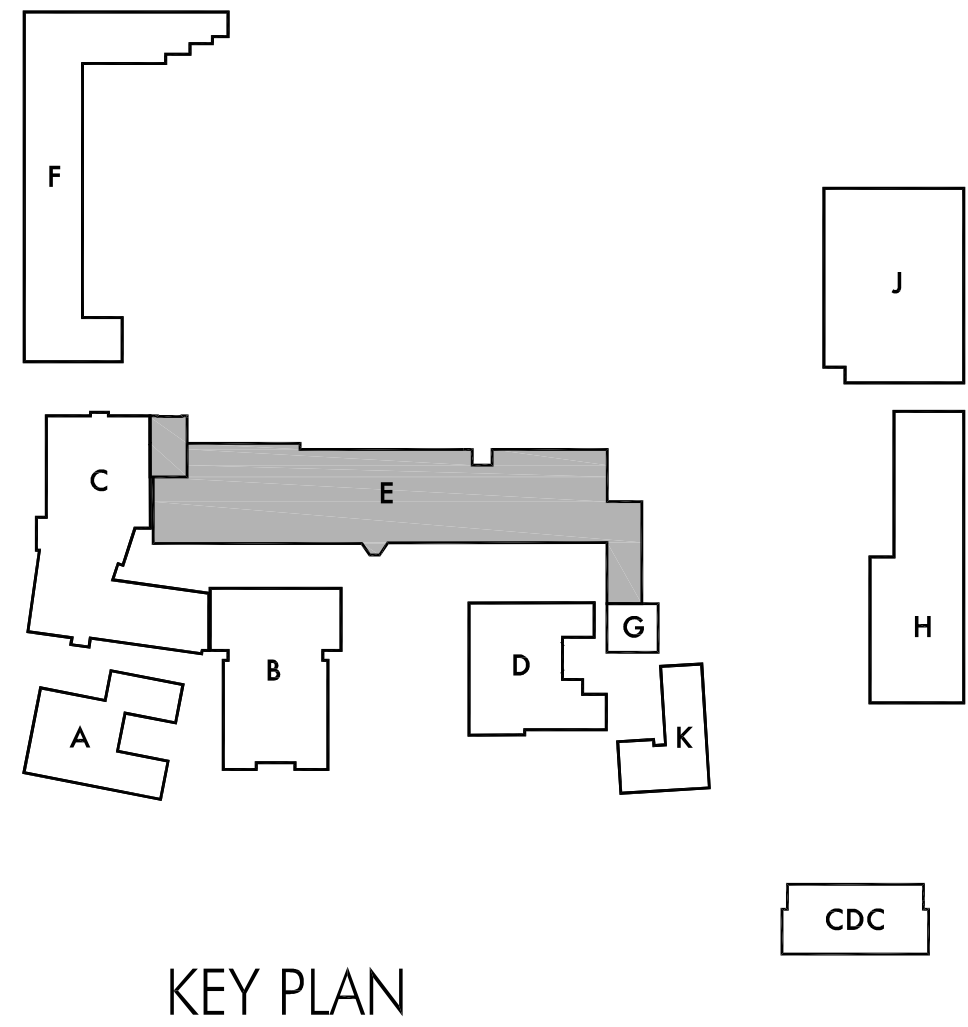
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Sheet Title

Building 'E'
First Floor
Plumbing Plan
Segment B

Sheet Number

PE201B

LEGEND


FC

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DENOTES MECHANICAL FANCOIL UNIT DESIGNATION. SEE MECHANICAL SHEETS FOR SCHEDULES.

KEYNOTES

① XX-XX

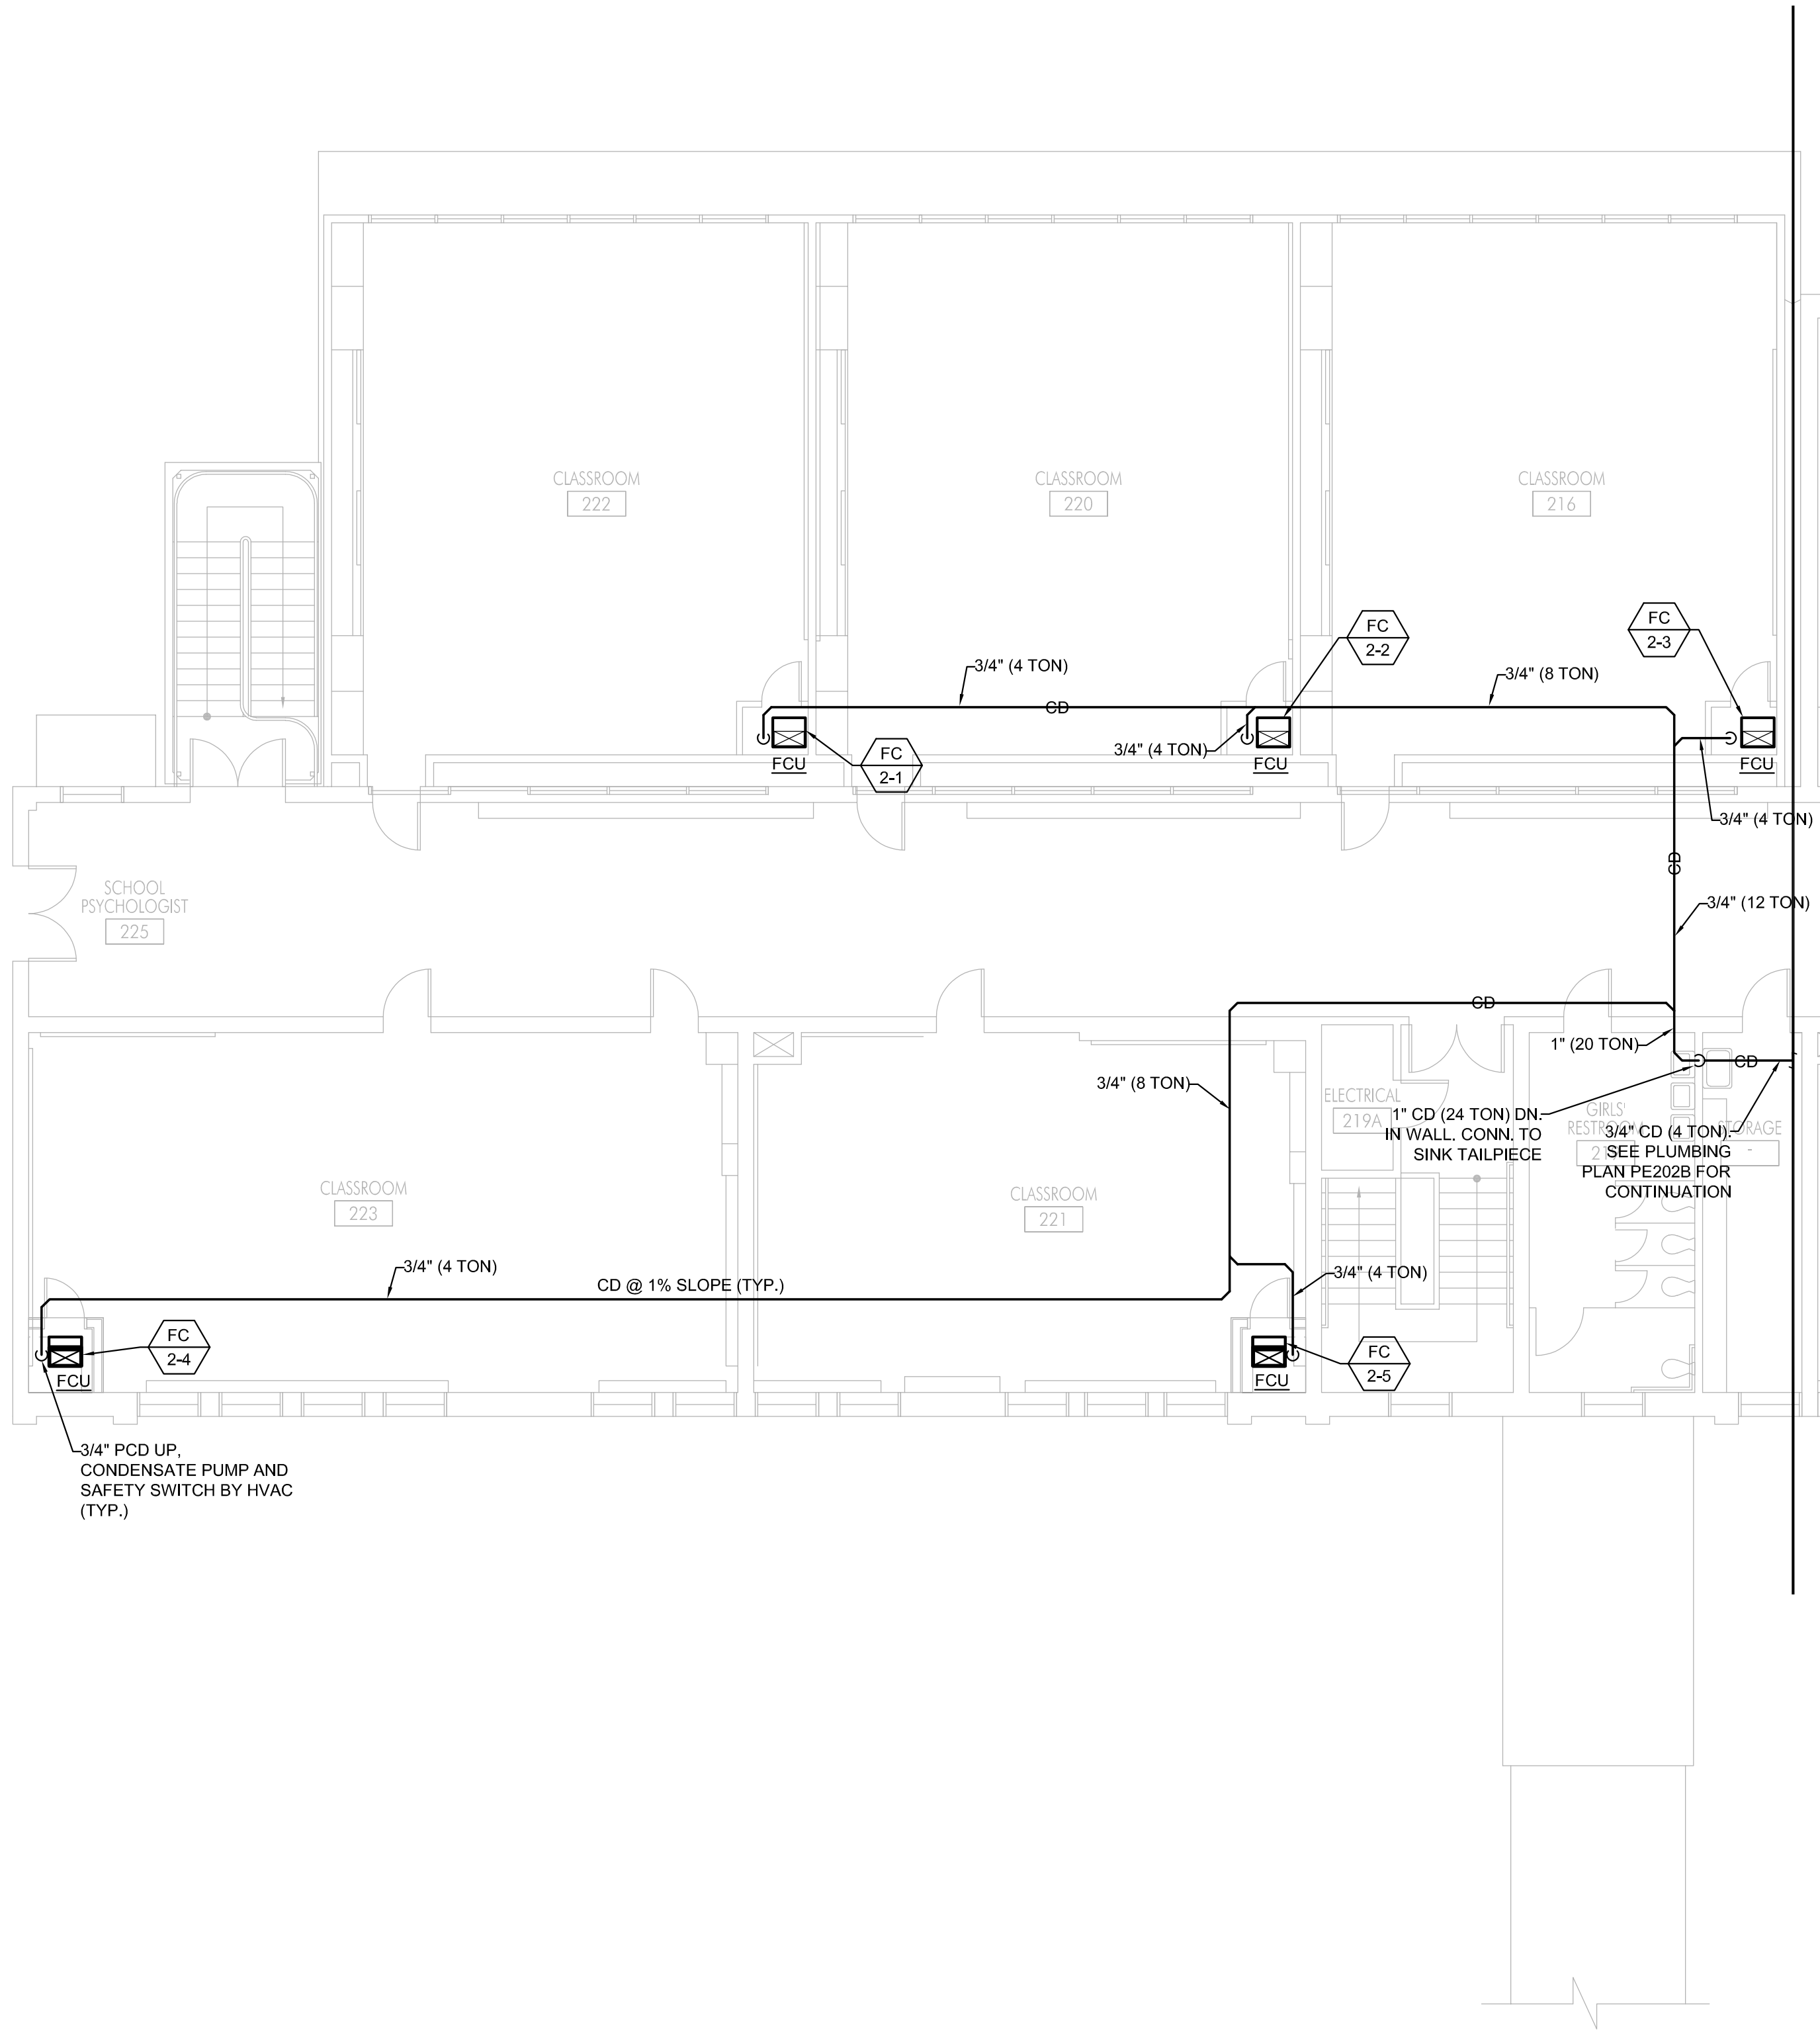

3/4" PCD UP.
CONDENSATE PUMP AND
SAFETY SWITCH BY HVAC
(TYP.)

ELECTRICAL
219: 1" CD (24 TON) DN
IN WALL, CONN TO
SINK TAILPIECE


RESTROOM
219: 3/4" CD (4 TON)
SEE PLUMBING
PLAN PE202B FOR
CONTINUATION

STORAGE
219: 3/4" CD (4 TON)
SEE PLUMBING
PLAN PE202B FOR
CONTINUATION

1 SECOND FLOOR PLUMBING PLAN - SEGMENT A



SCALE: 1/8"=1'-0"

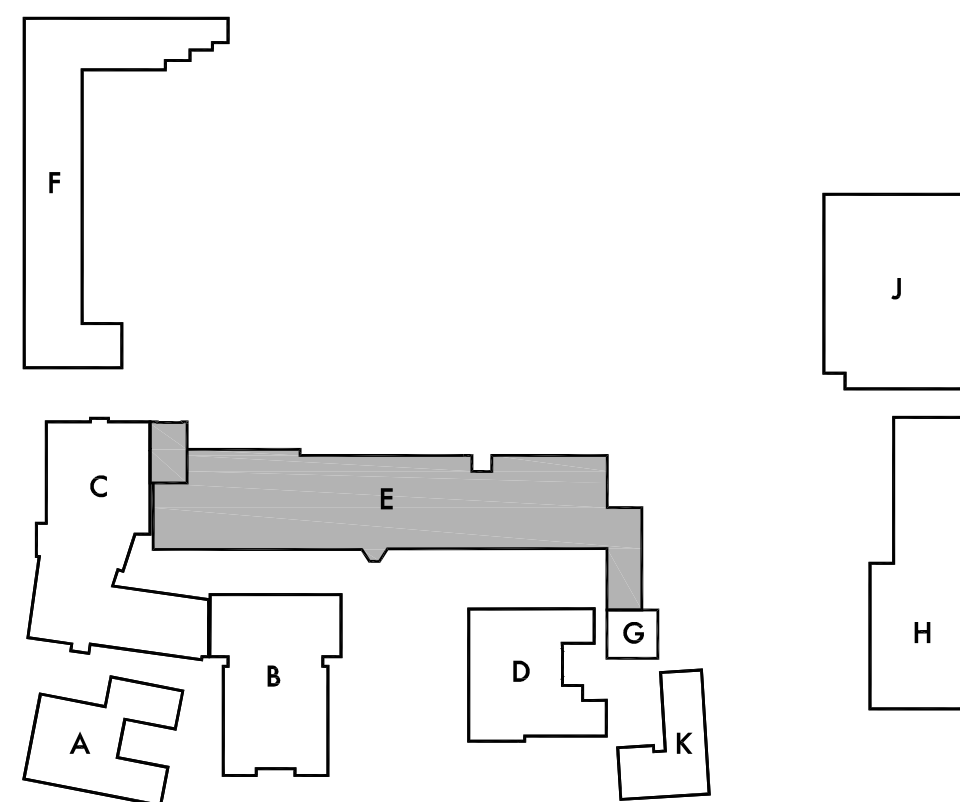

KEY PLAN

Architect




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421 East Huntington Drive
Monrovia, California 91016
P: 626.930.1383 F: 626.930.1385
Project No. 19009

Sheet Title

Building 'E'
Second Floor
Plumbing Plan
Segment A

Sheet Number

PE202A

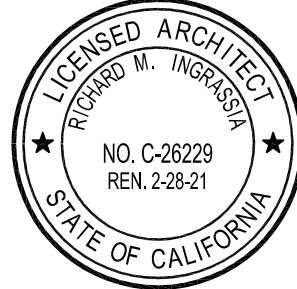LEGEND

FC

#

DENOTES MECHANICAL FANCOIL UNIT DESIGNATION. SEE MECHANICAL SHEETS FOR SCHEDULES.

KEYNOTES

1 XX-XX

Architect




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Lincoln Middle School HVAC Replacement Project
Lincoln Middle School
1501 California Avenue
Santa Monica, California 90403

Rev	Date	Issue
1	07.22.19	-

Date:
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Checked By: RI

Architect / Engineer Stamp

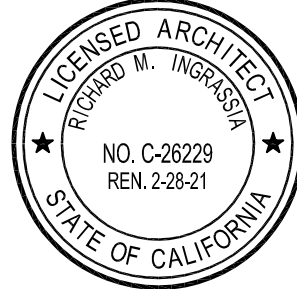


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Sheet Title
Building 'E'
Second Floor
Plumbing Plan
Segment B

Sheet Number


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1 SECOND FLOOR PLUMBING PLAN - SEGMENT B



SCALE: 1/8"=1'-0"

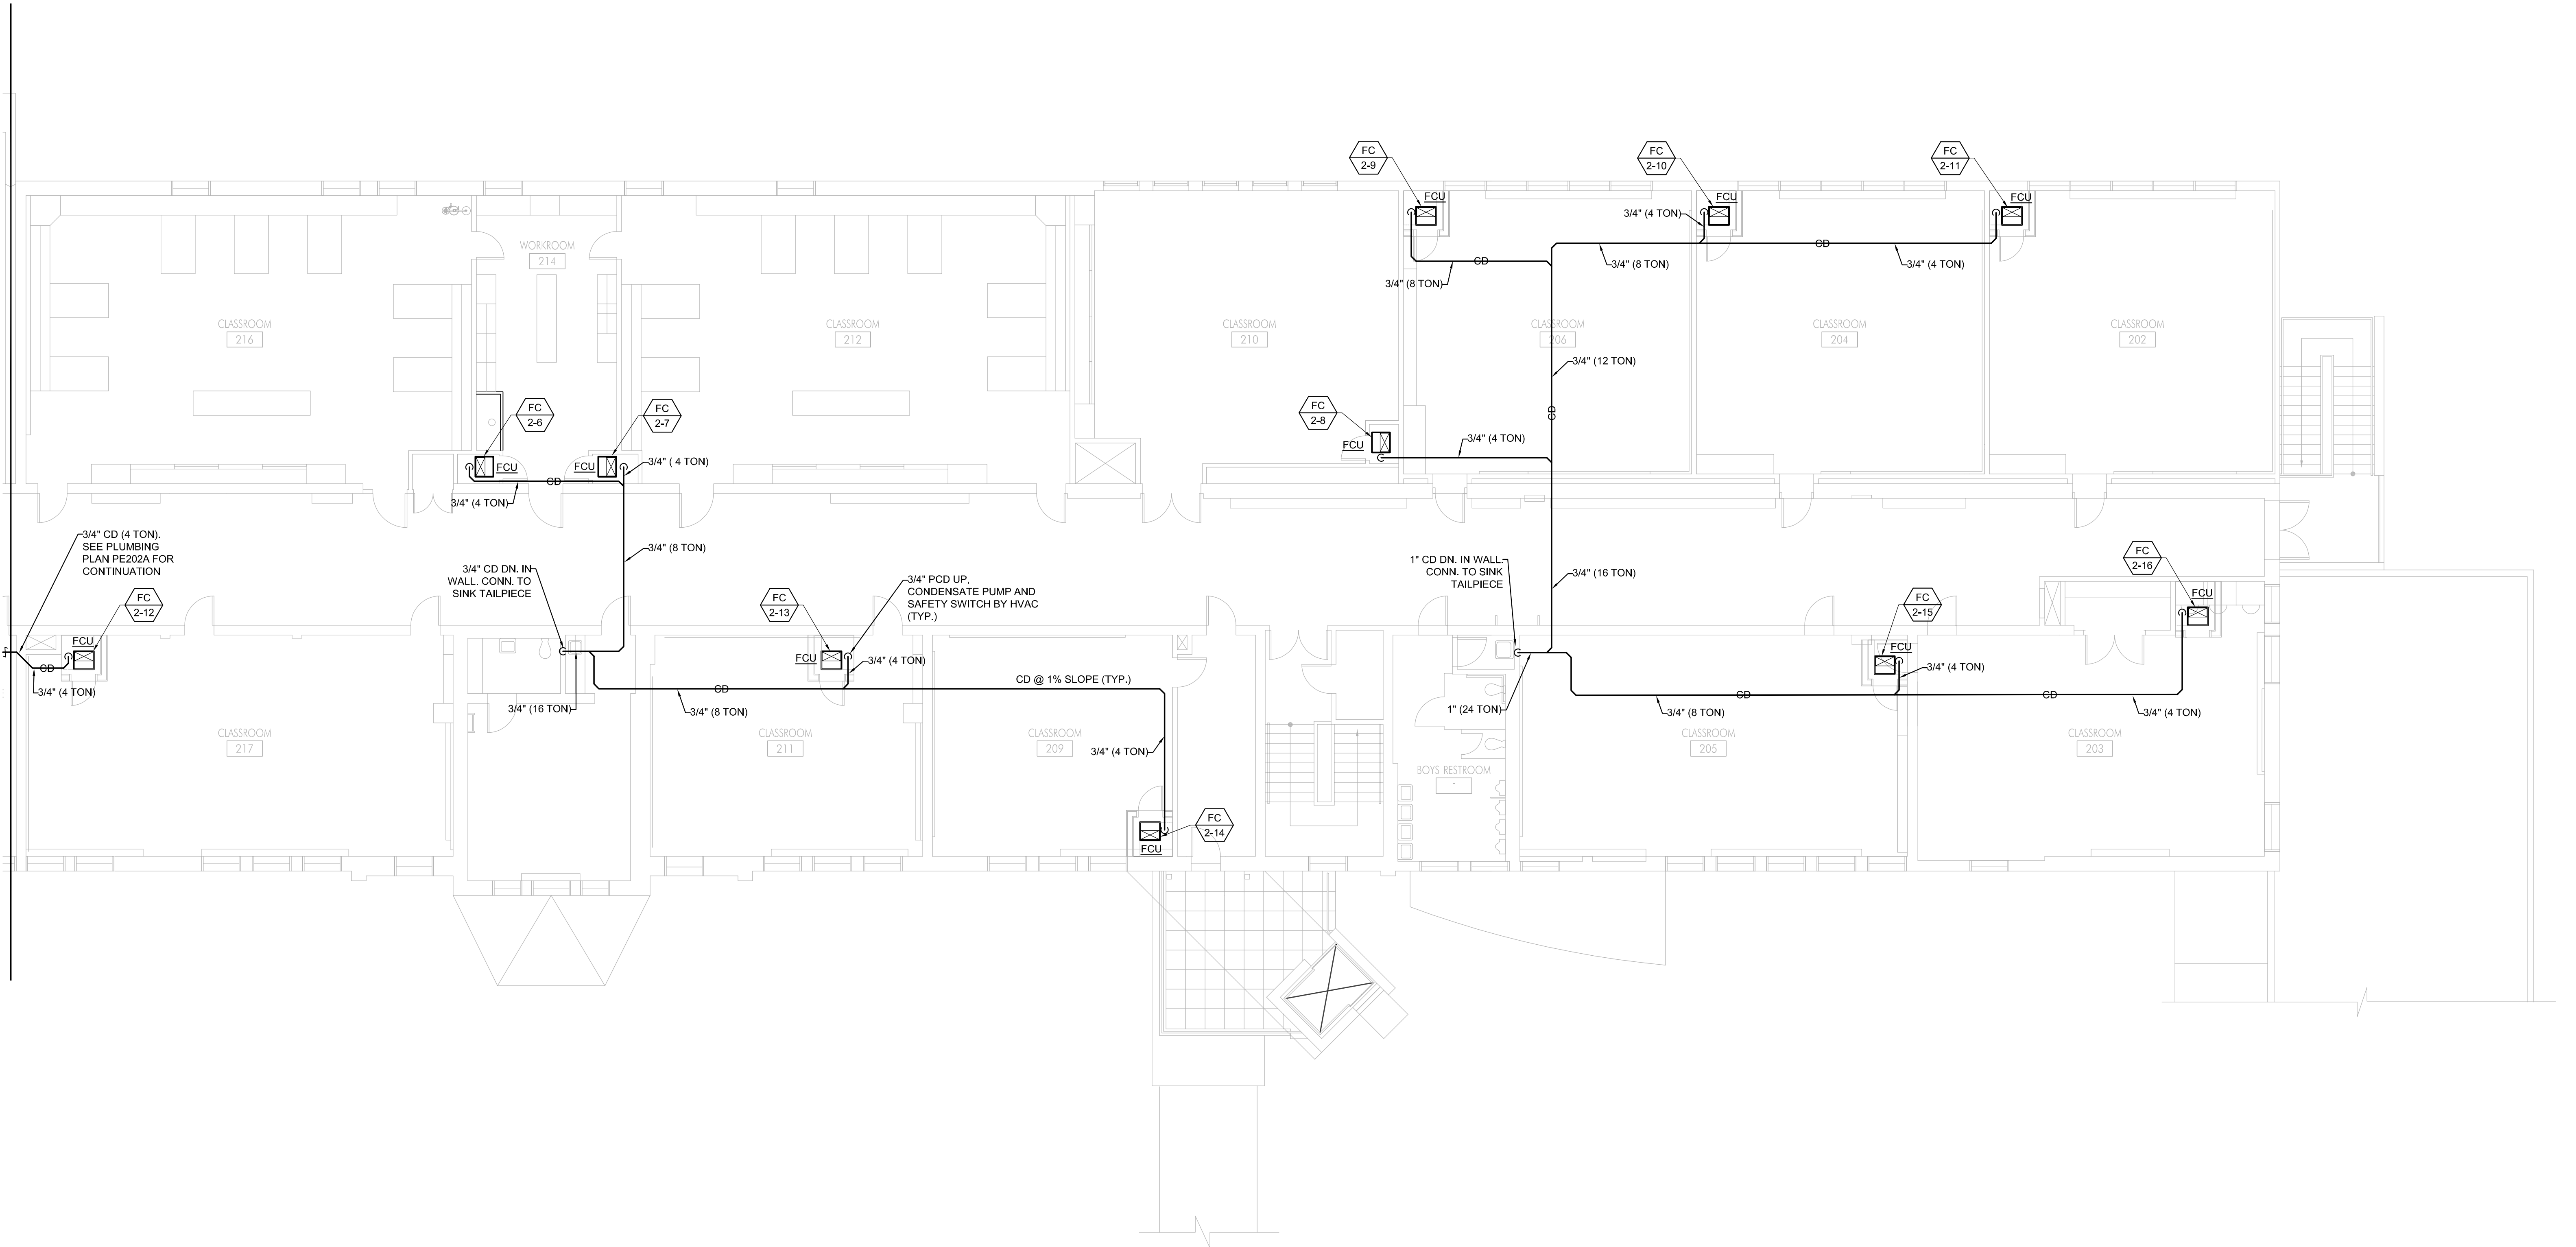

KEY PLAN

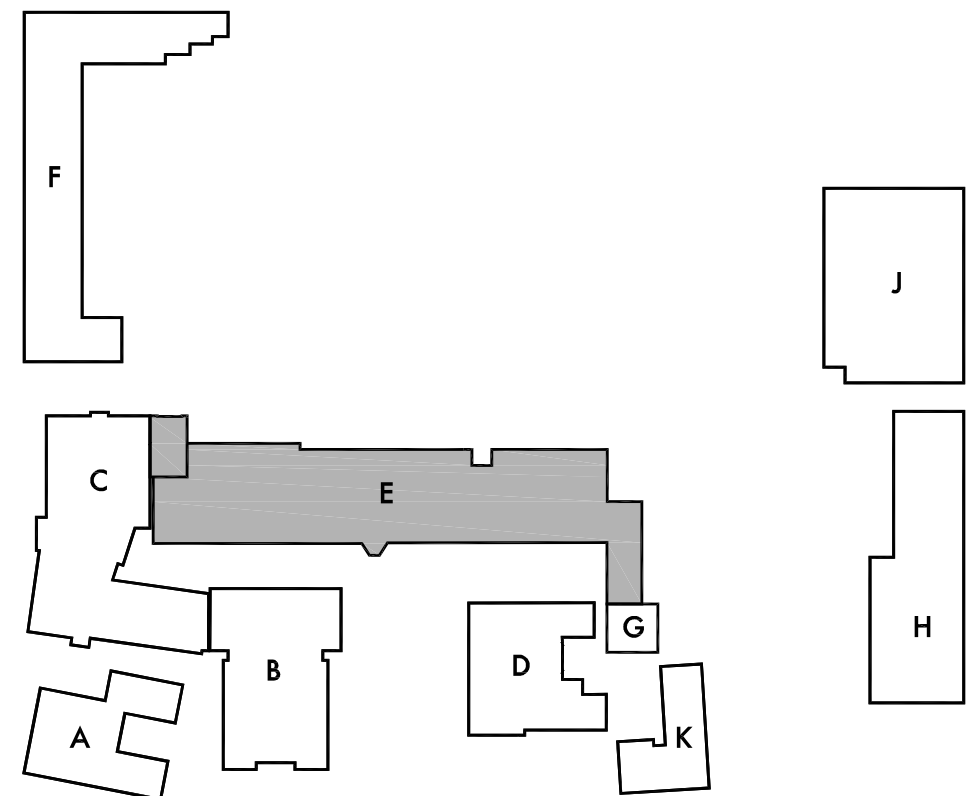LEGEND

→ DENOTES MECHANICAL ROOFTOP UNIT DESIGNATION. SEE MECHANICAL SHEETS FOR SCHEDULES.

KEYNOTES

① XX-XX


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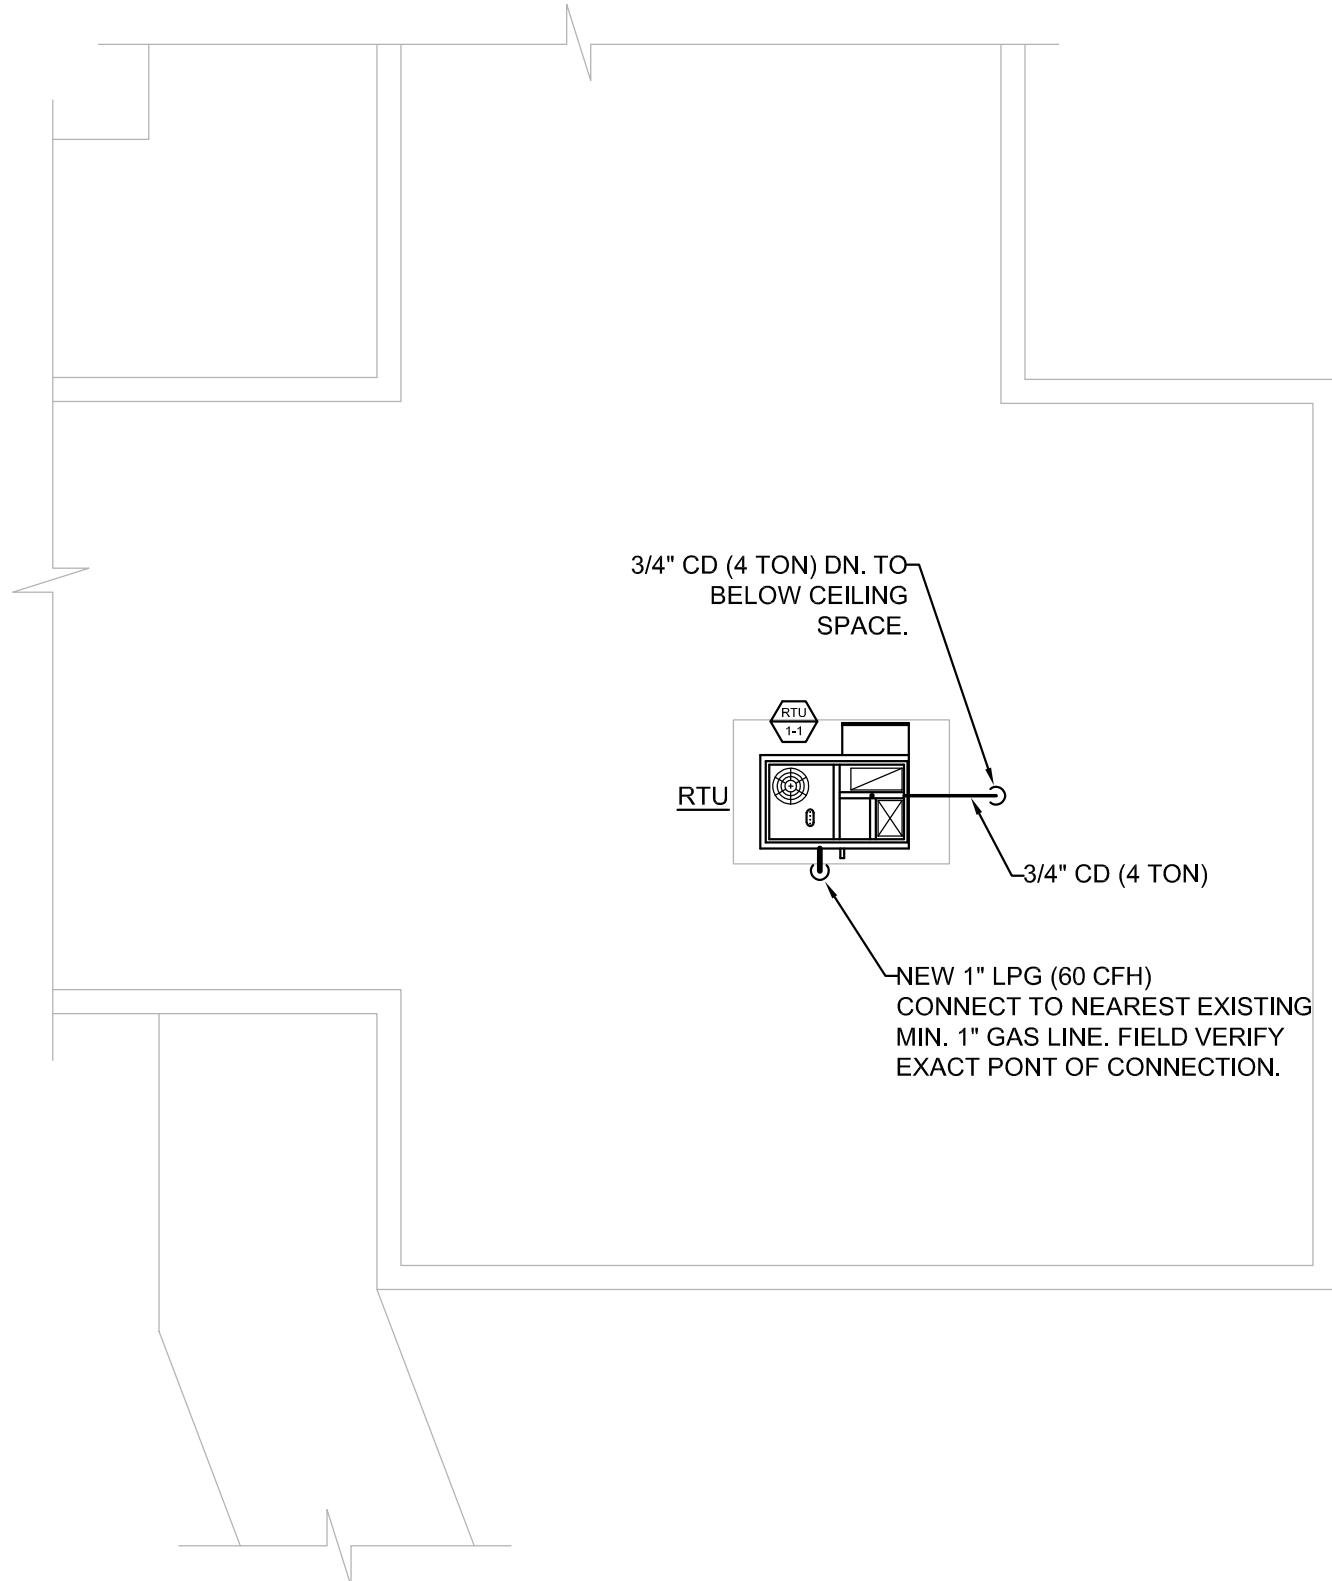
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1 PLUMBING PLAN




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E PLUMBING ROOF PLAN



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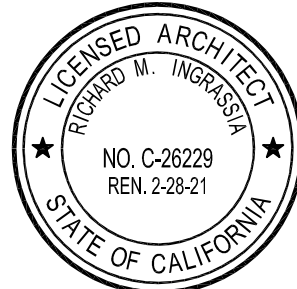

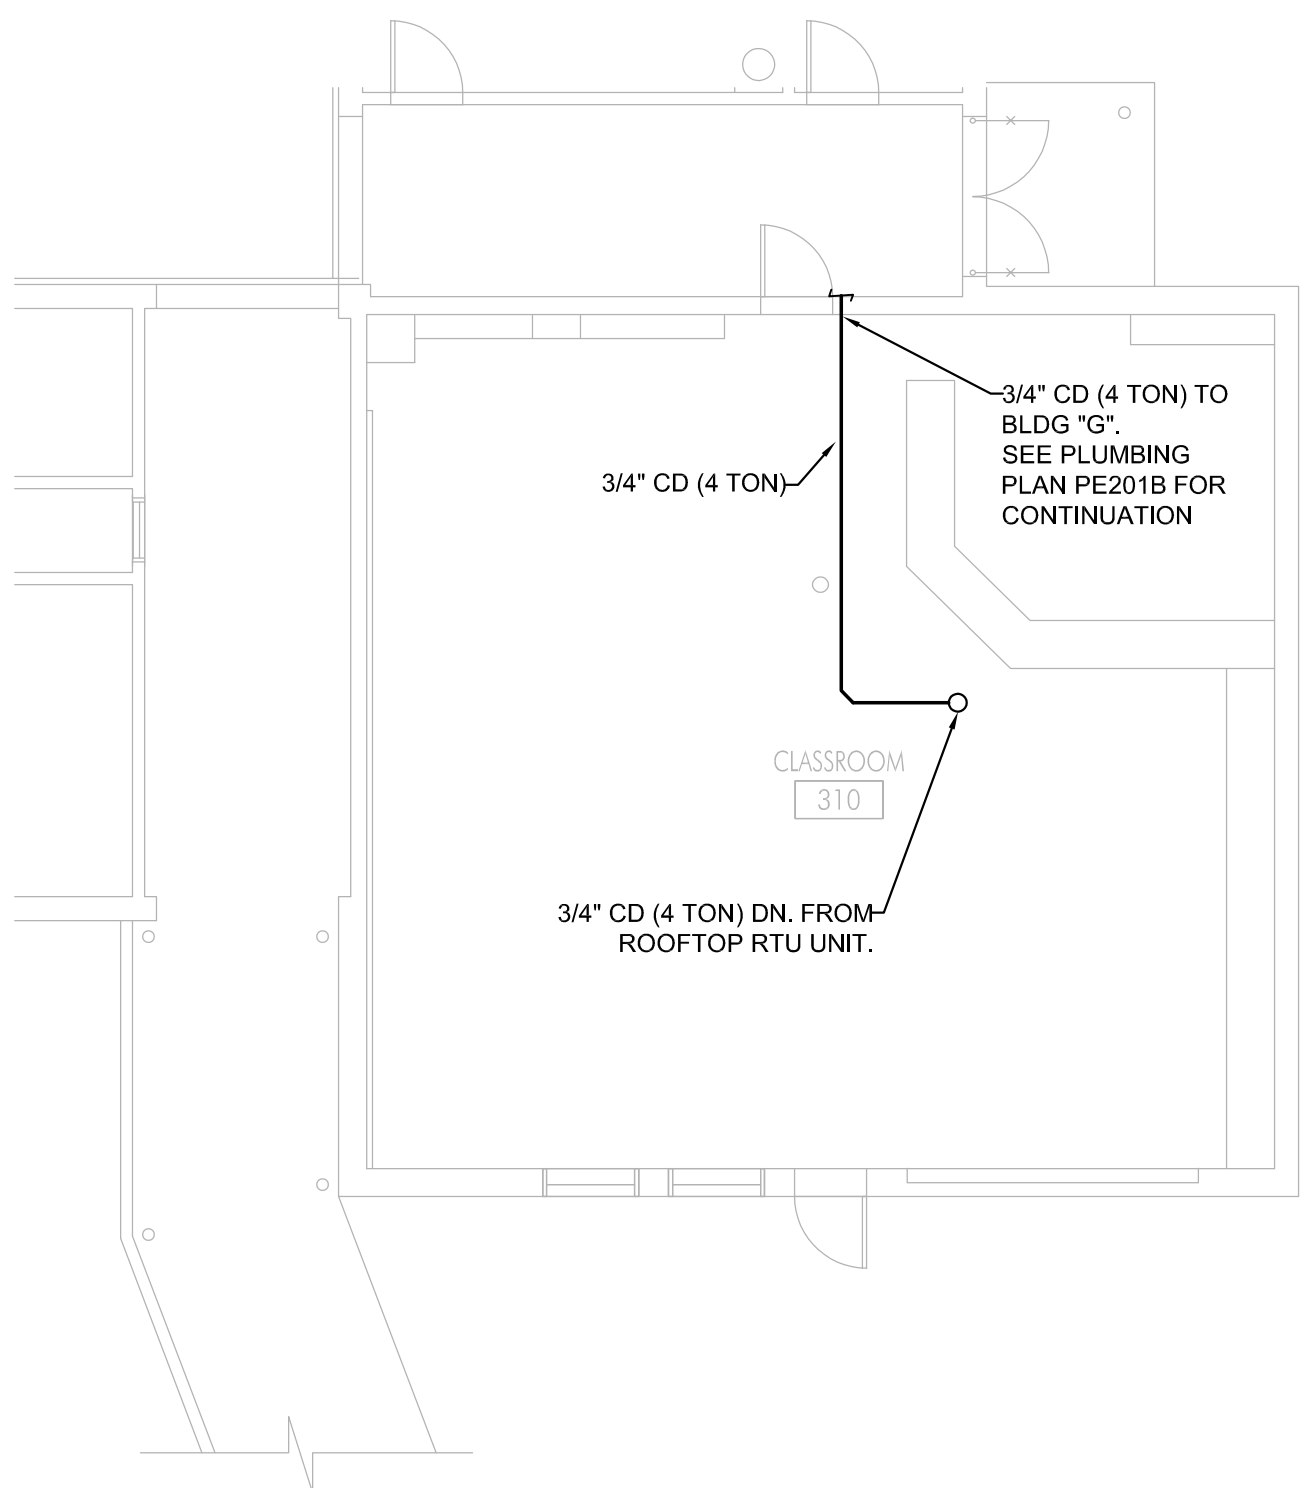
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Project No. 19009

Sheet Title

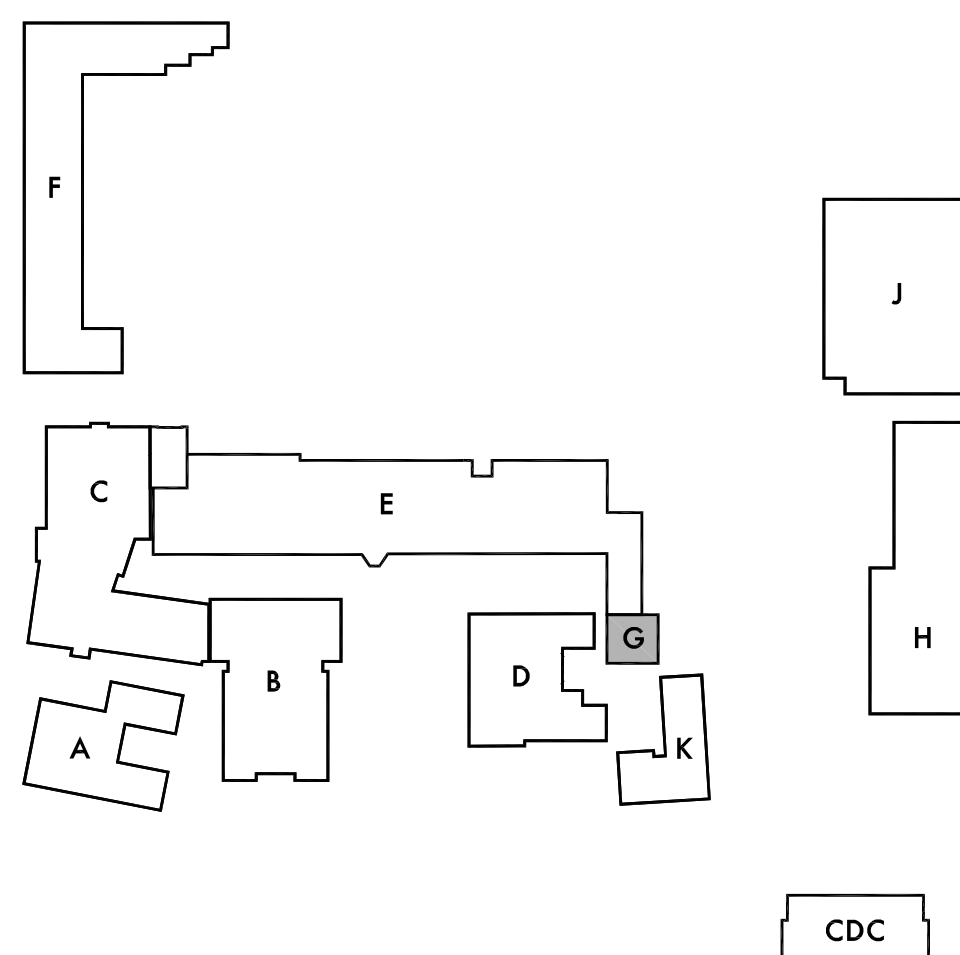Building 'G'


Plumbing First Floor and Roof Plans

Sheet Number


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1 PLUMBING PLAN



SCALE: 1/8"=1'-0"

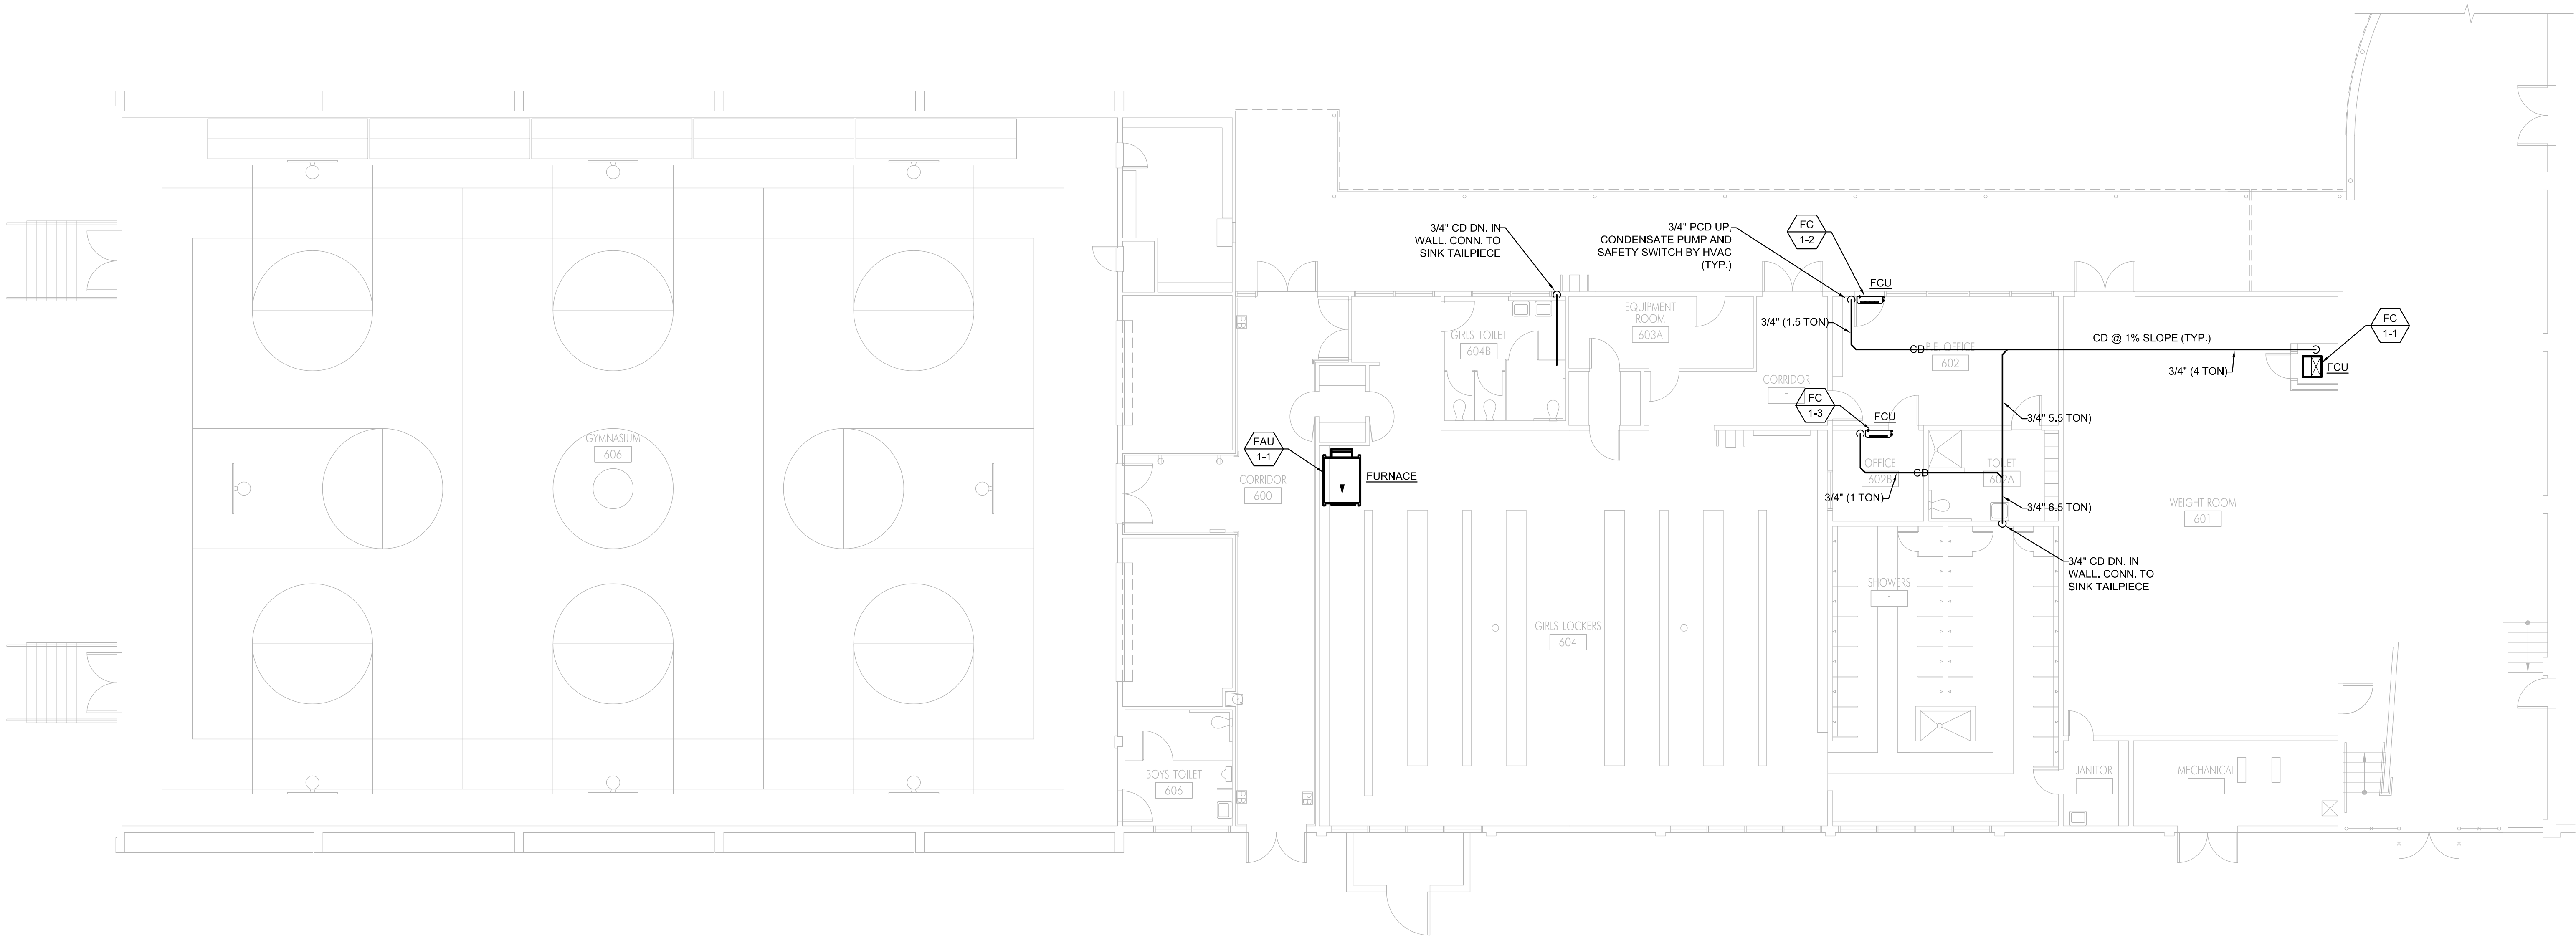

KEY PLAN

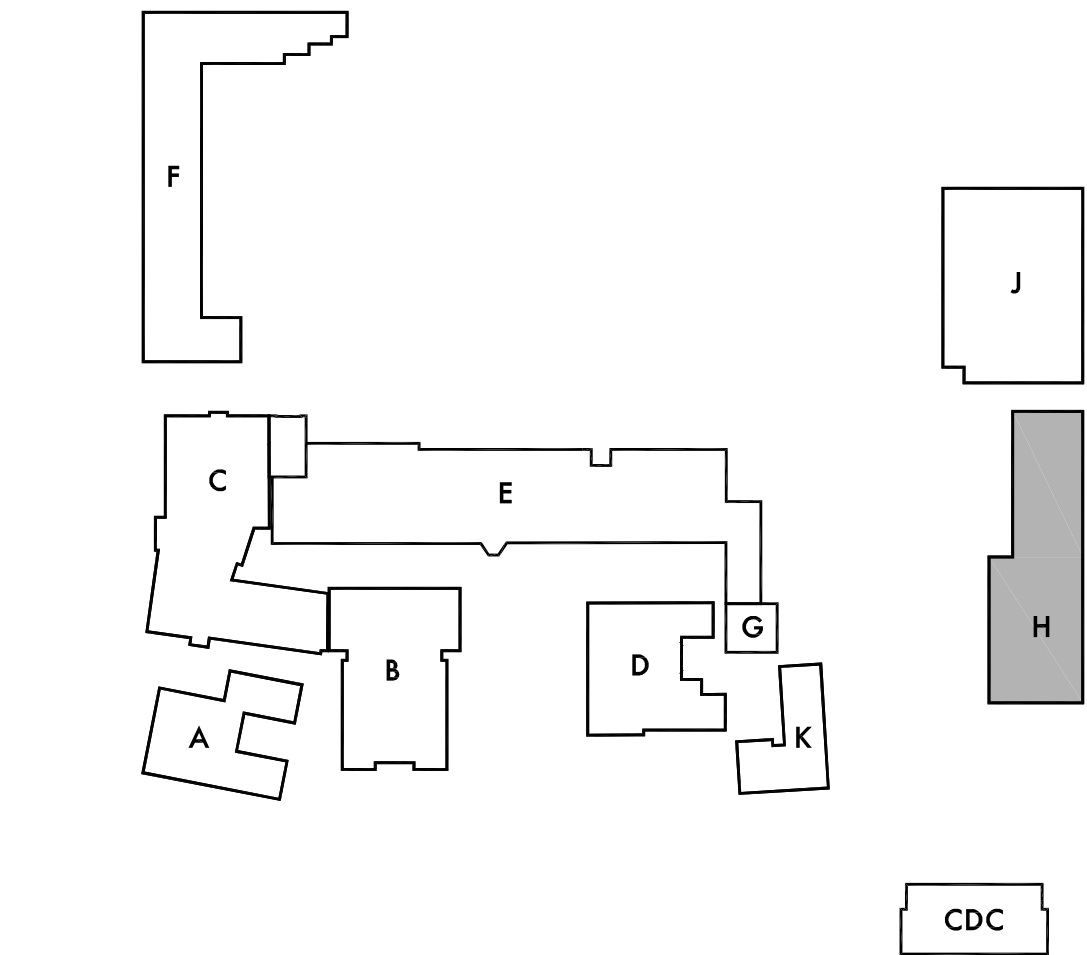LEGEND	
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KEYNOTES

① XX-XX

DSA Stamp

Architect




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Lincoln Middle School
1501 California Avenue
Santa Monica, California 90403

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Sheet Title
Building 'H'
First Floor
Plumbing Plan

Sheet Number

PH201

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KEYNOTES

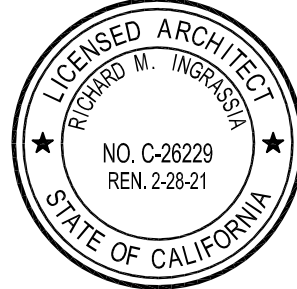1 XX-XX

Architect




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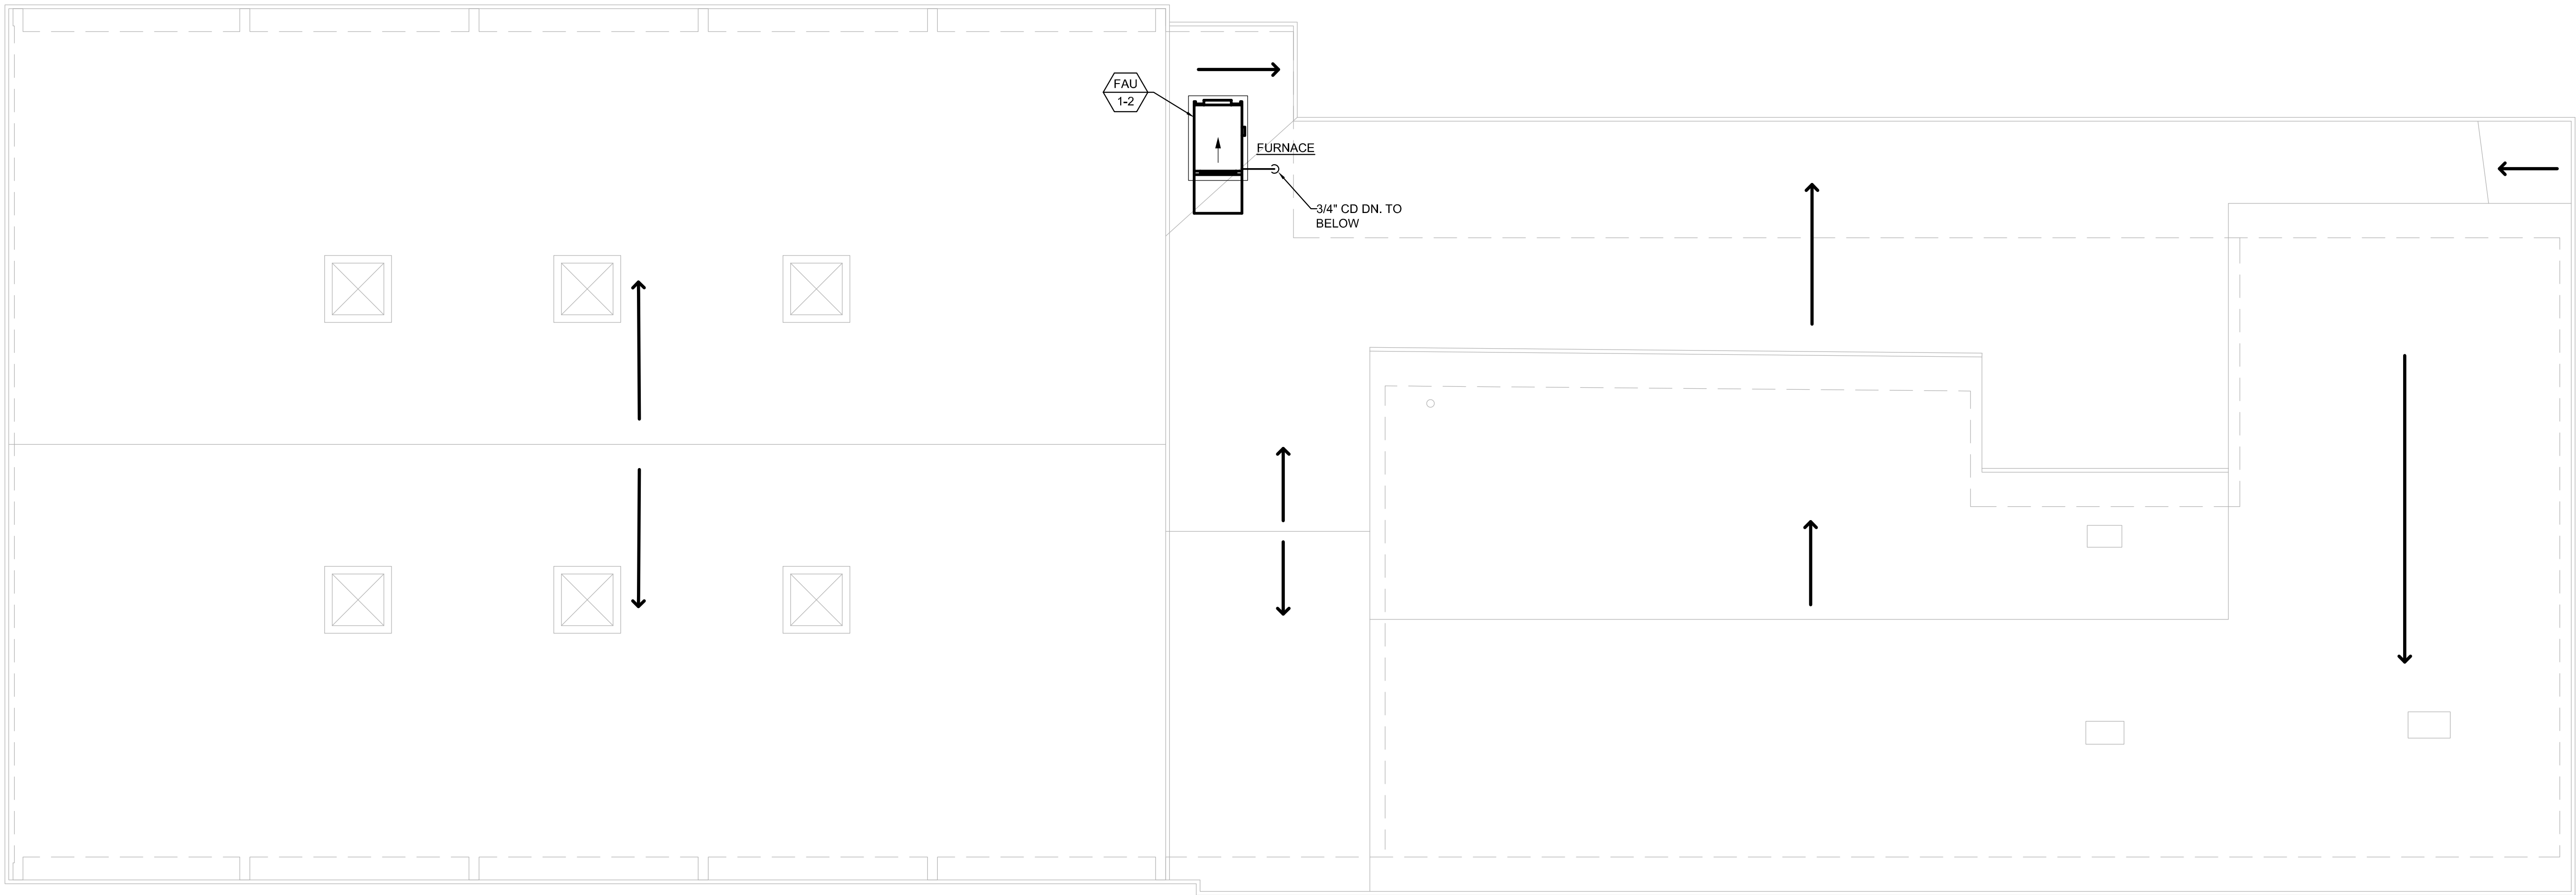
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Project No. 19009

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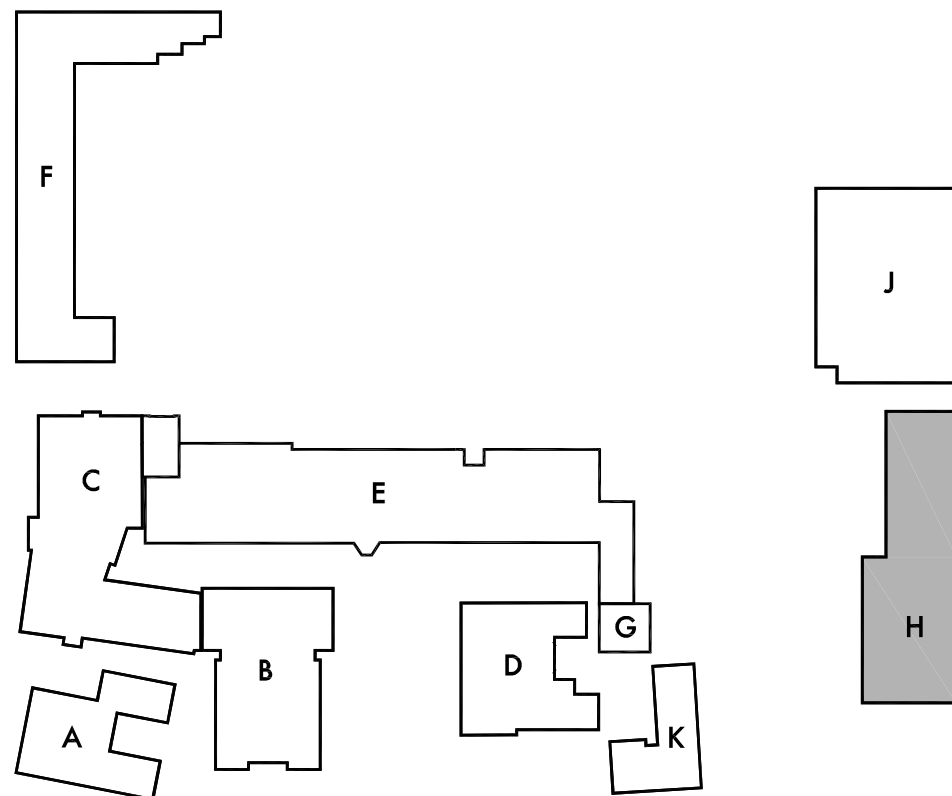
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Sheet Number

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KEYNOTES

1 XX-XX

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KEYNOTES

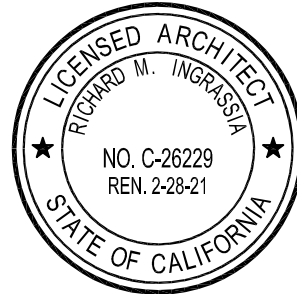1 XX-XX

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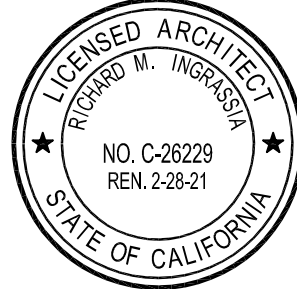
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Lincoln Middle School
1501 California Avenue
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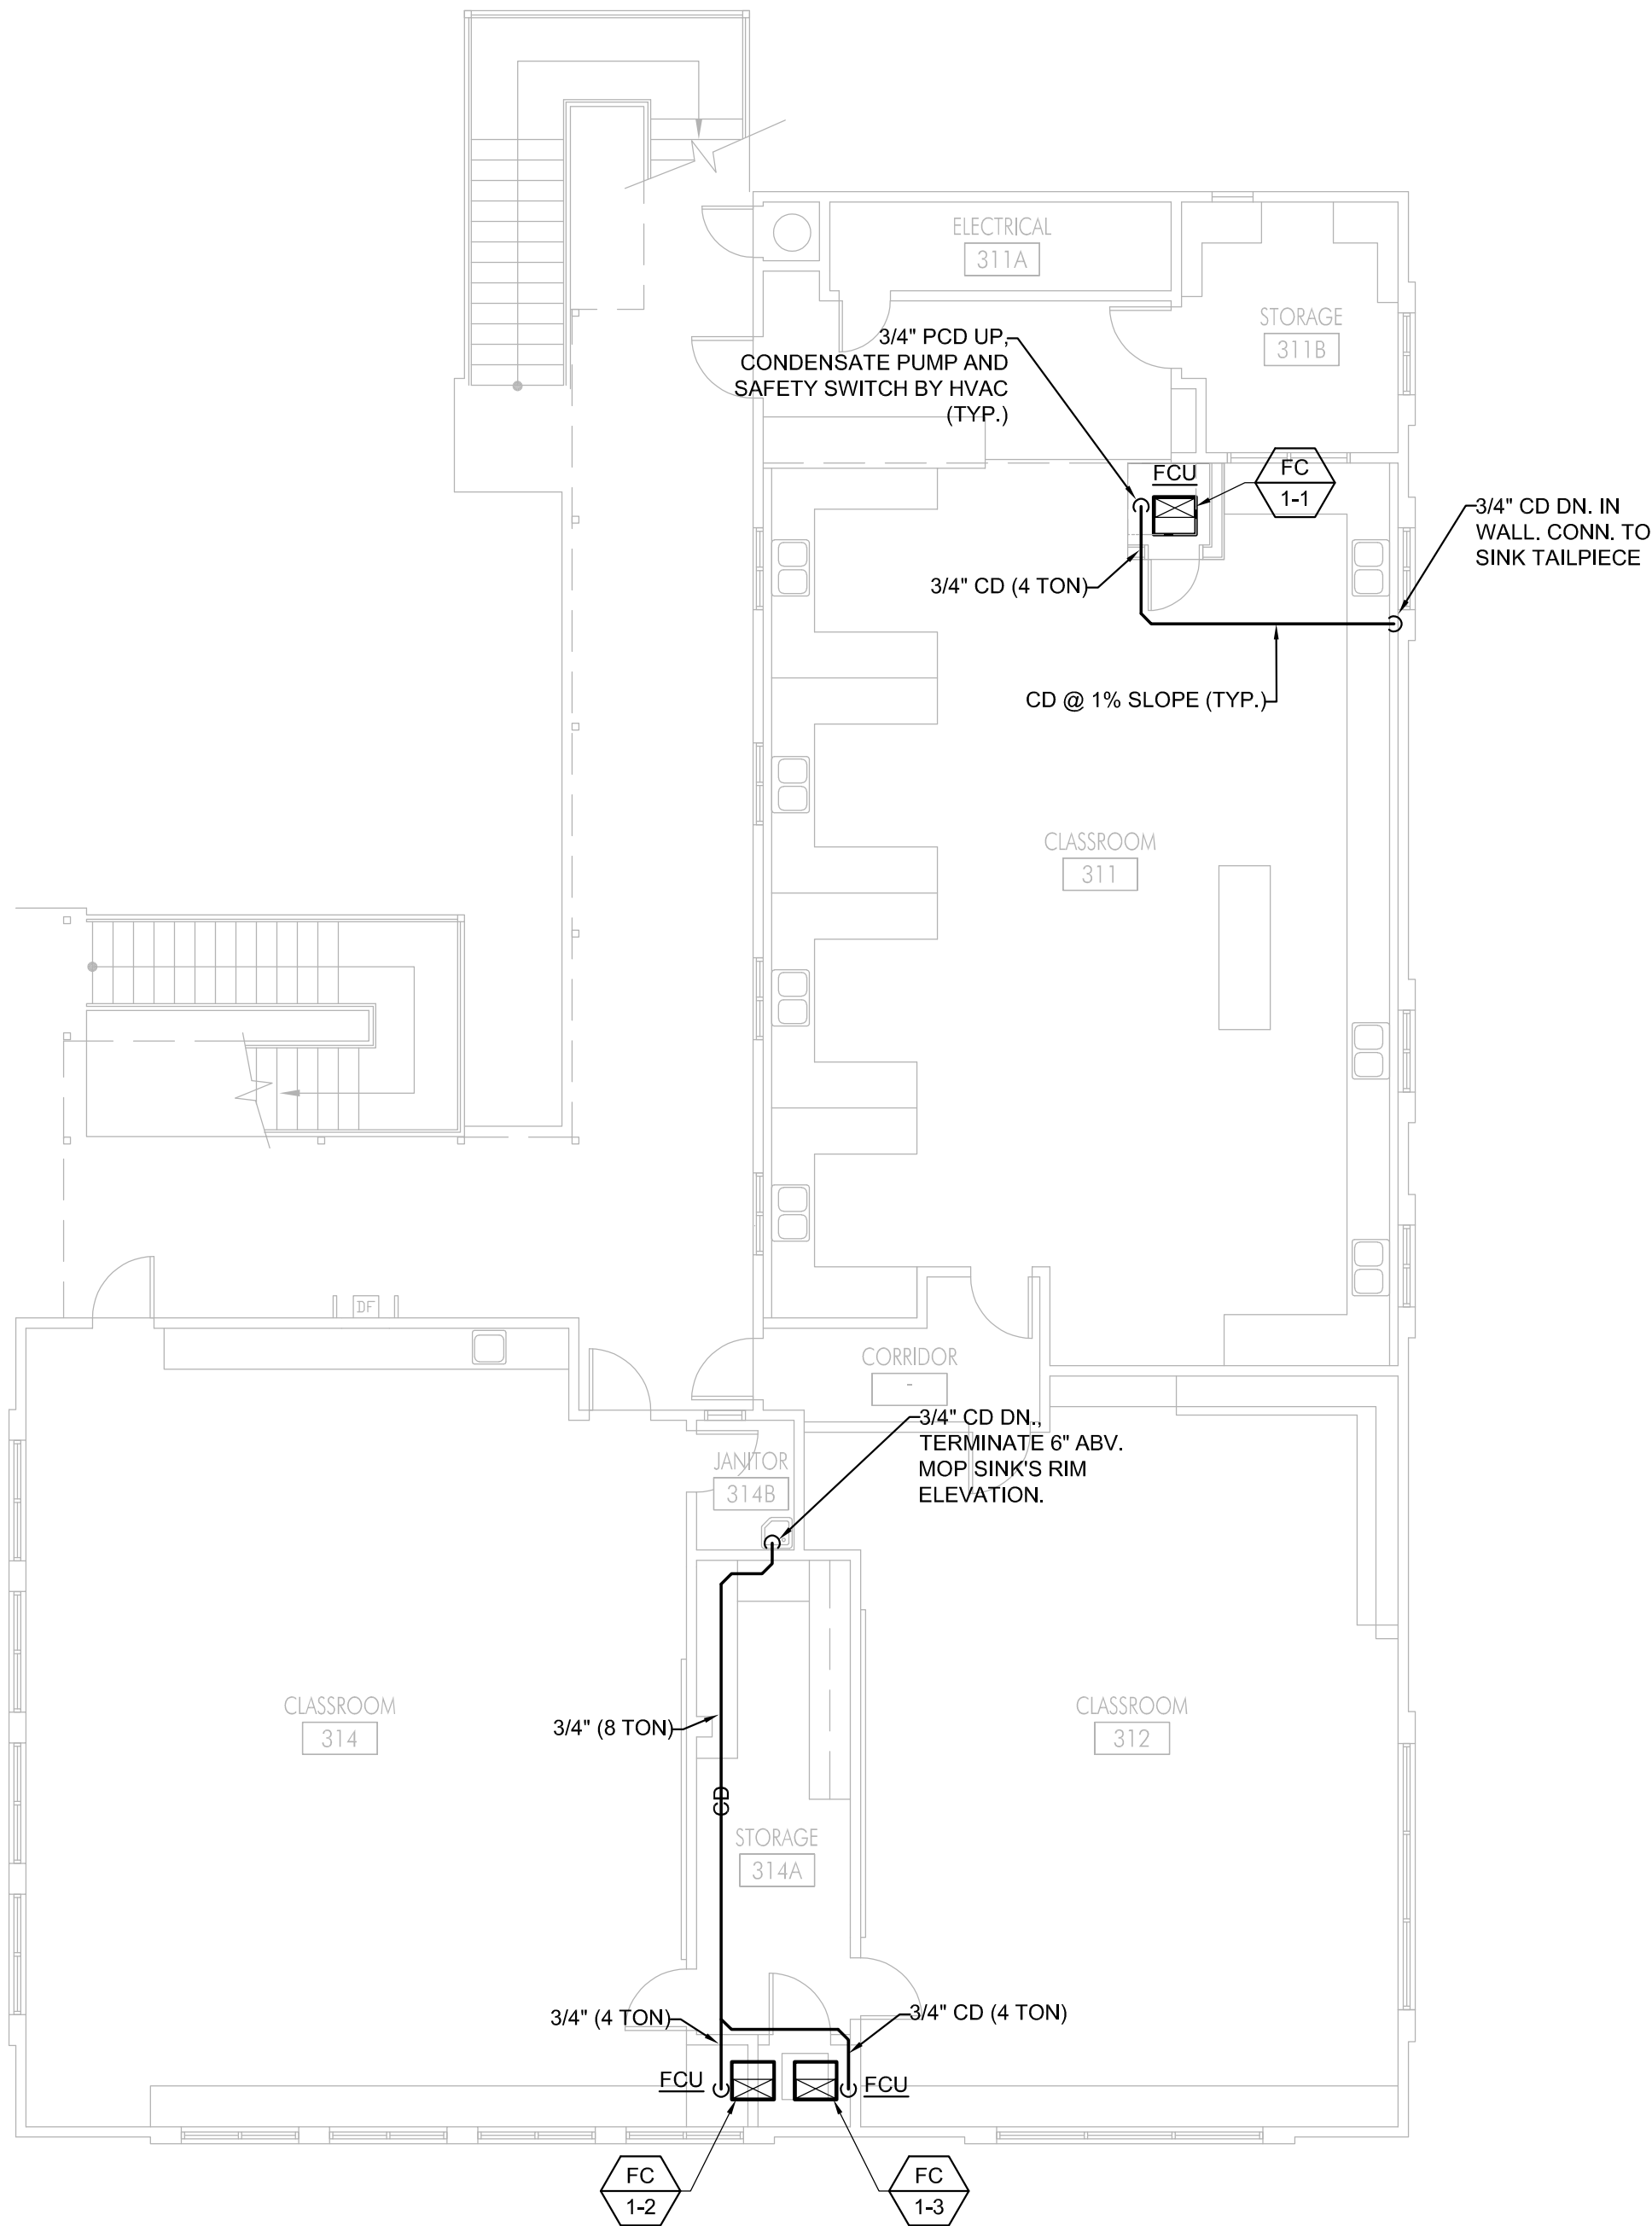


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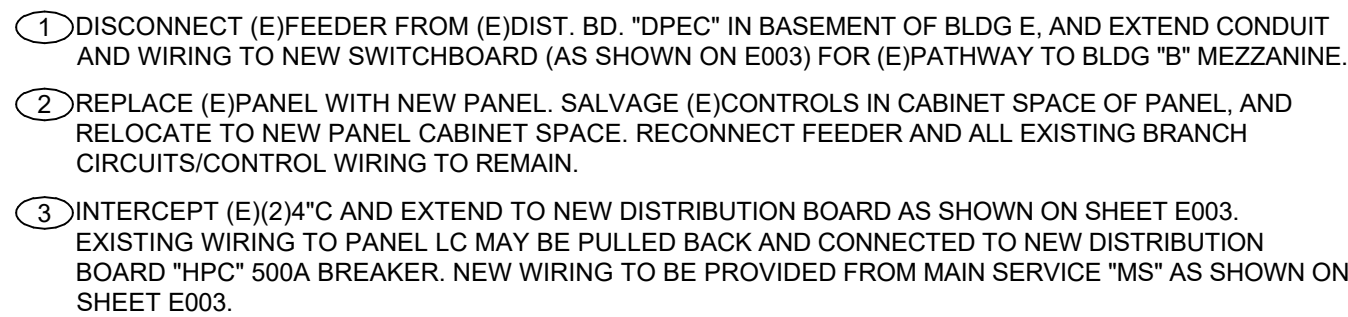
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PK201

1 FIRST FLOOR PLUMBING PLAN



E002



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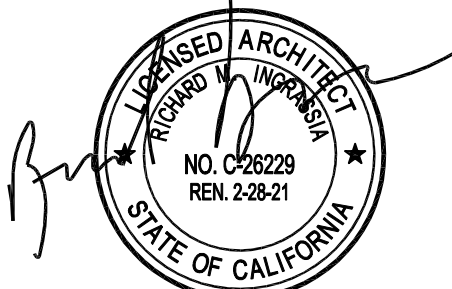
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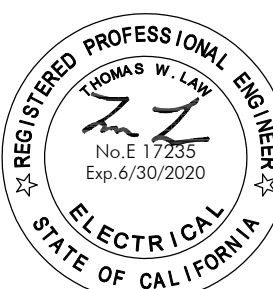
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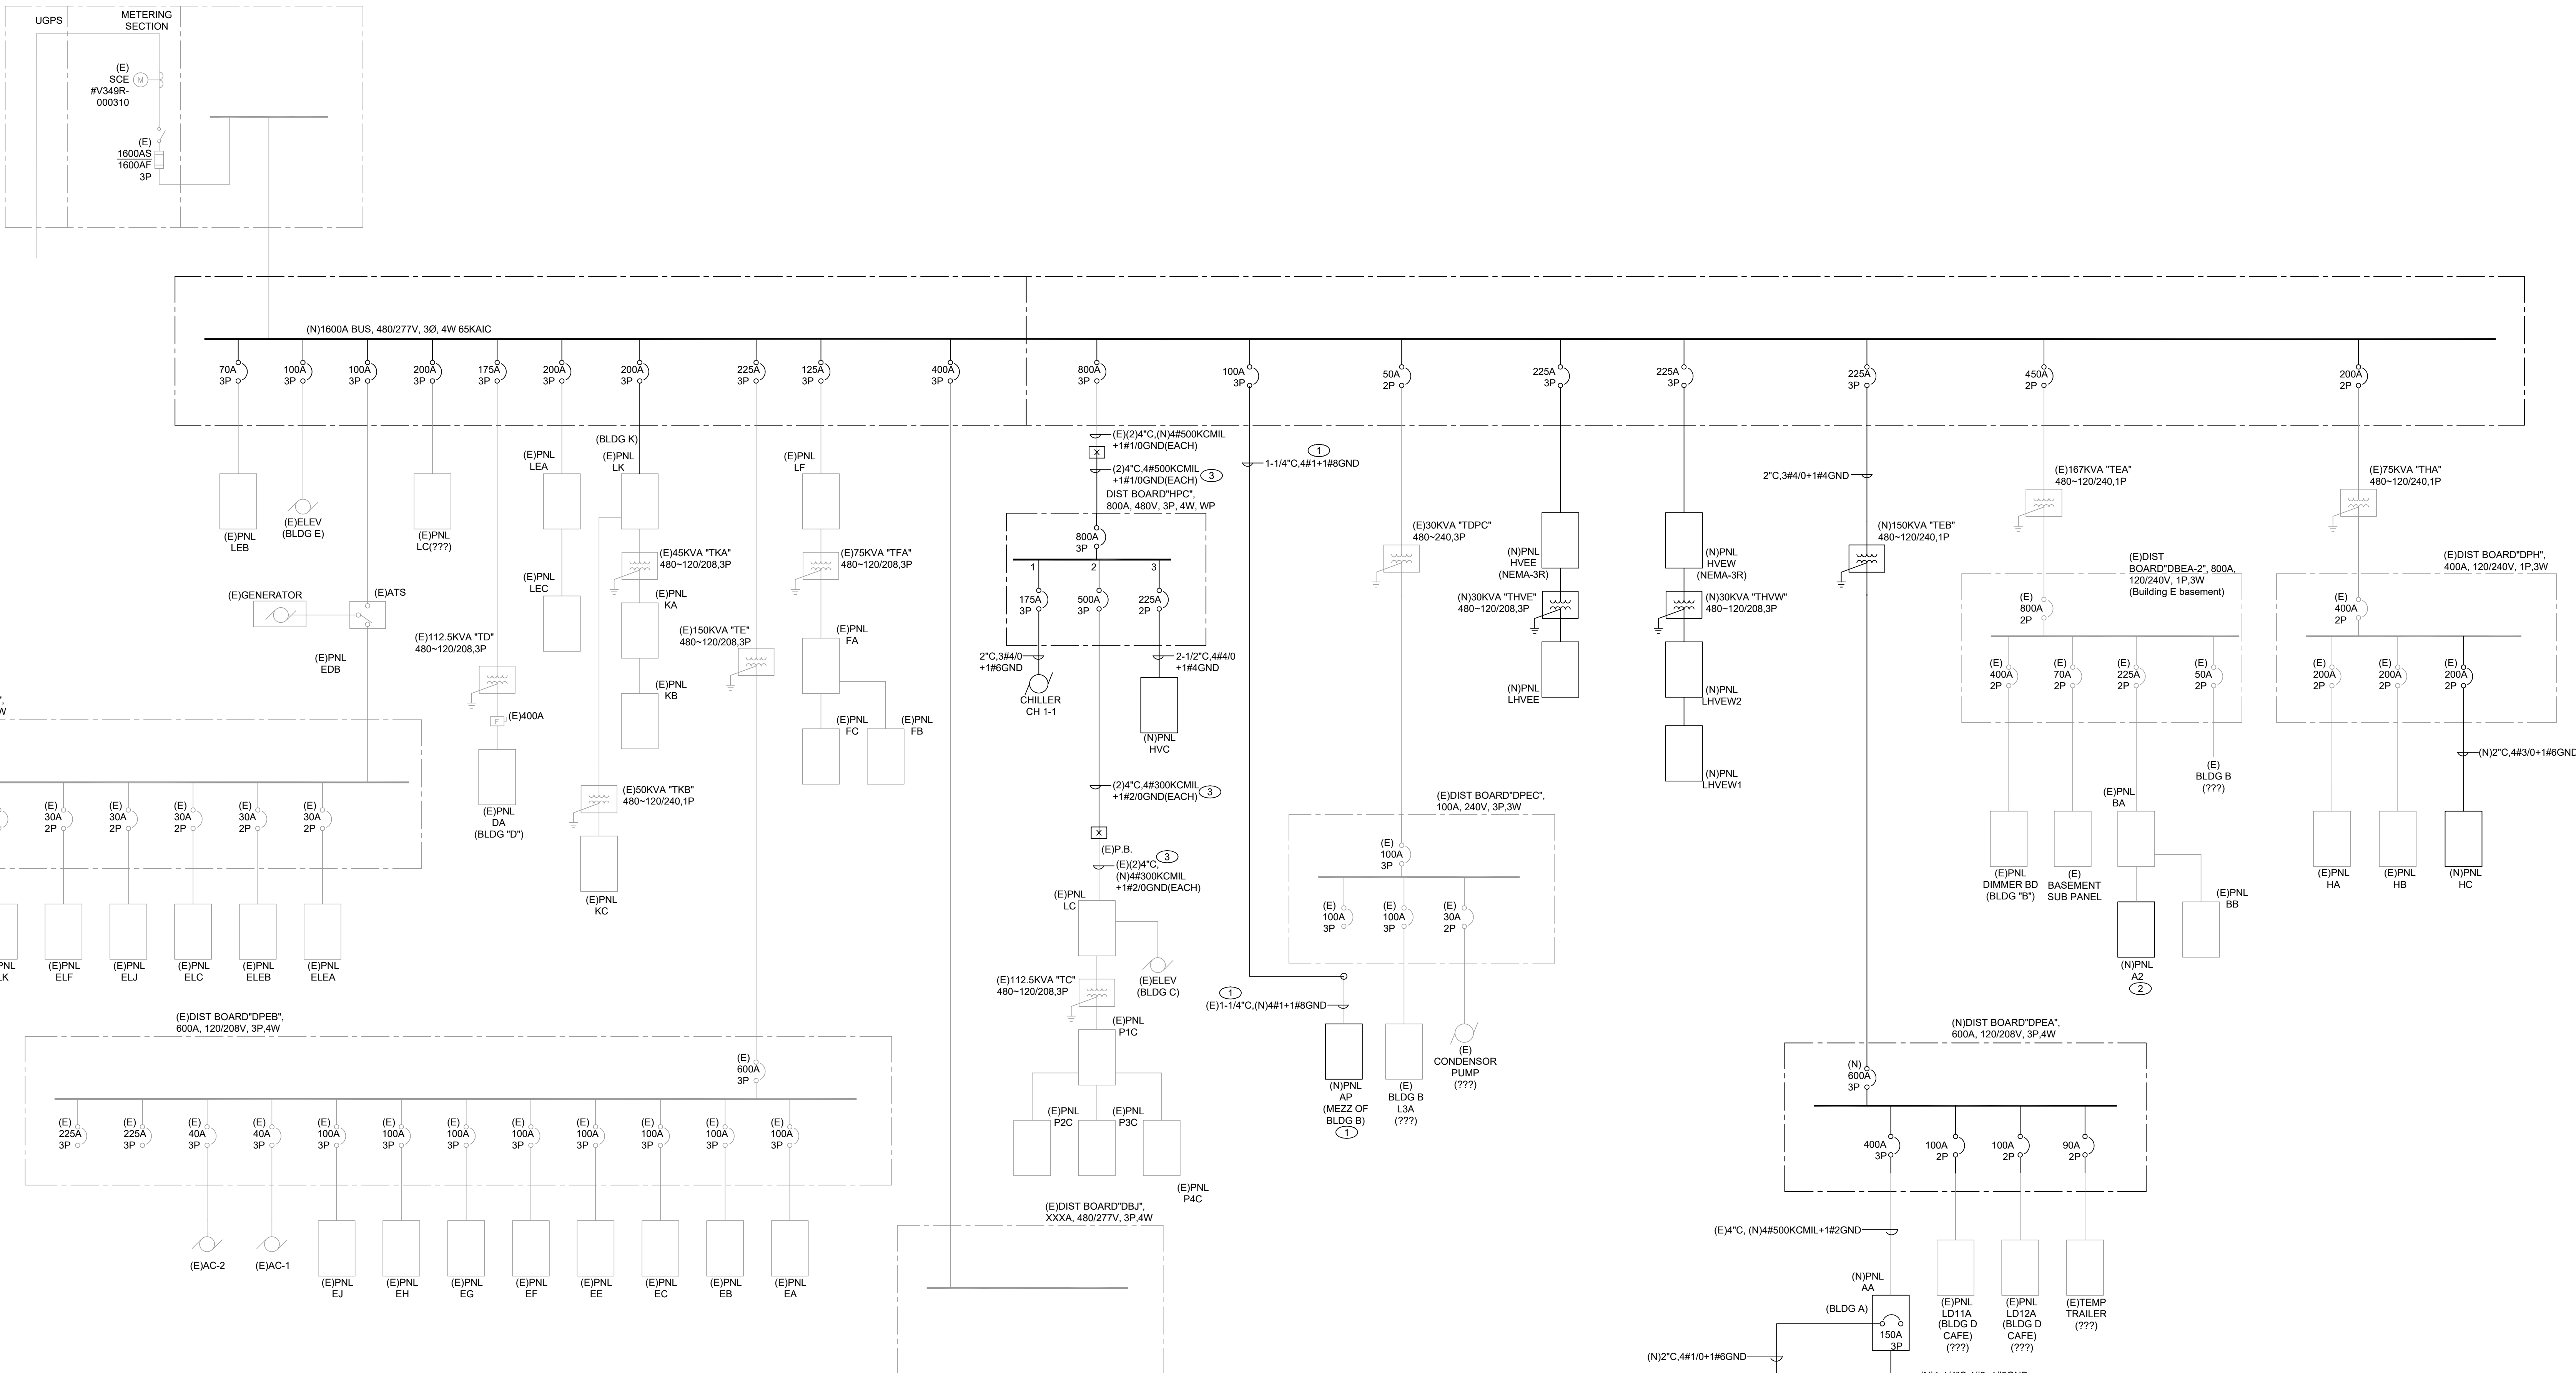
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Electrical
New Single Line
Diagram

Sheet Number

E003

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REFERENCE NOTES

- 1) PROVIDE (N)CONDUIT AND WIRING TO INTERCEPT (E)FEEDER (IN BASEMENT OF BLDG E) TO MEZZANINE OF BLDG B. REPLACE (E)PANEL 240V, 3P, 3W PANEL "AP" WITH (N)480V, 3P, 3W PANEL "AP".
- 2) PROVIDE NEW PANEL WITH CABINET TO SPACE TO MATCH EXISTING PANEL BEING REMOVED. SALVAGE (E)CONTROLS IN CABINET SPACE OF (E)PANEL, AND RELOCATE TO NEW PANEL CABINET SPACE. RECONNECT FEEDER AND ALL EXISTING BRANCH CIRCUITS/CONTROL WIRING TO REMAIN.
- 3) INTERCEPT (E)24" C AND EXTEND TO NEW DISTRIBUTION BOARD "HPC". EXISTING WIRING TO PANEL LC MAY BE PULLED BACK AND CONNECTED TO NEW DISTRIBUTION BOARD "HPC" 500A BREAKER. NEW WIRING TO BE PROVIDED FROM MAIN SERVICE "MS" AS SHOWN.

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Lincoln Middle School
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Santa Monica, California 90403


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Sheet Title

Electrical
Site Plan

Sheet Number

E111

WASHINGTON AVENUE

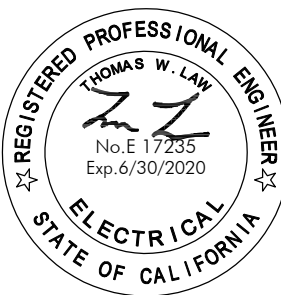14TH STREET

16TH STREET

CALIFORNIA AVENUE



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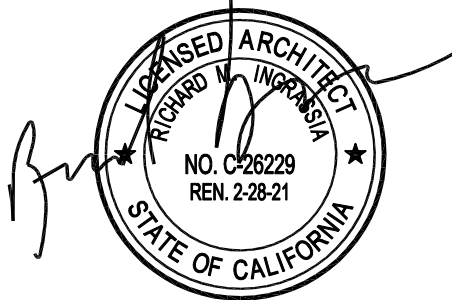
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Lincoln Middle School
1501 California Avenue
Santa Monica, California 90403


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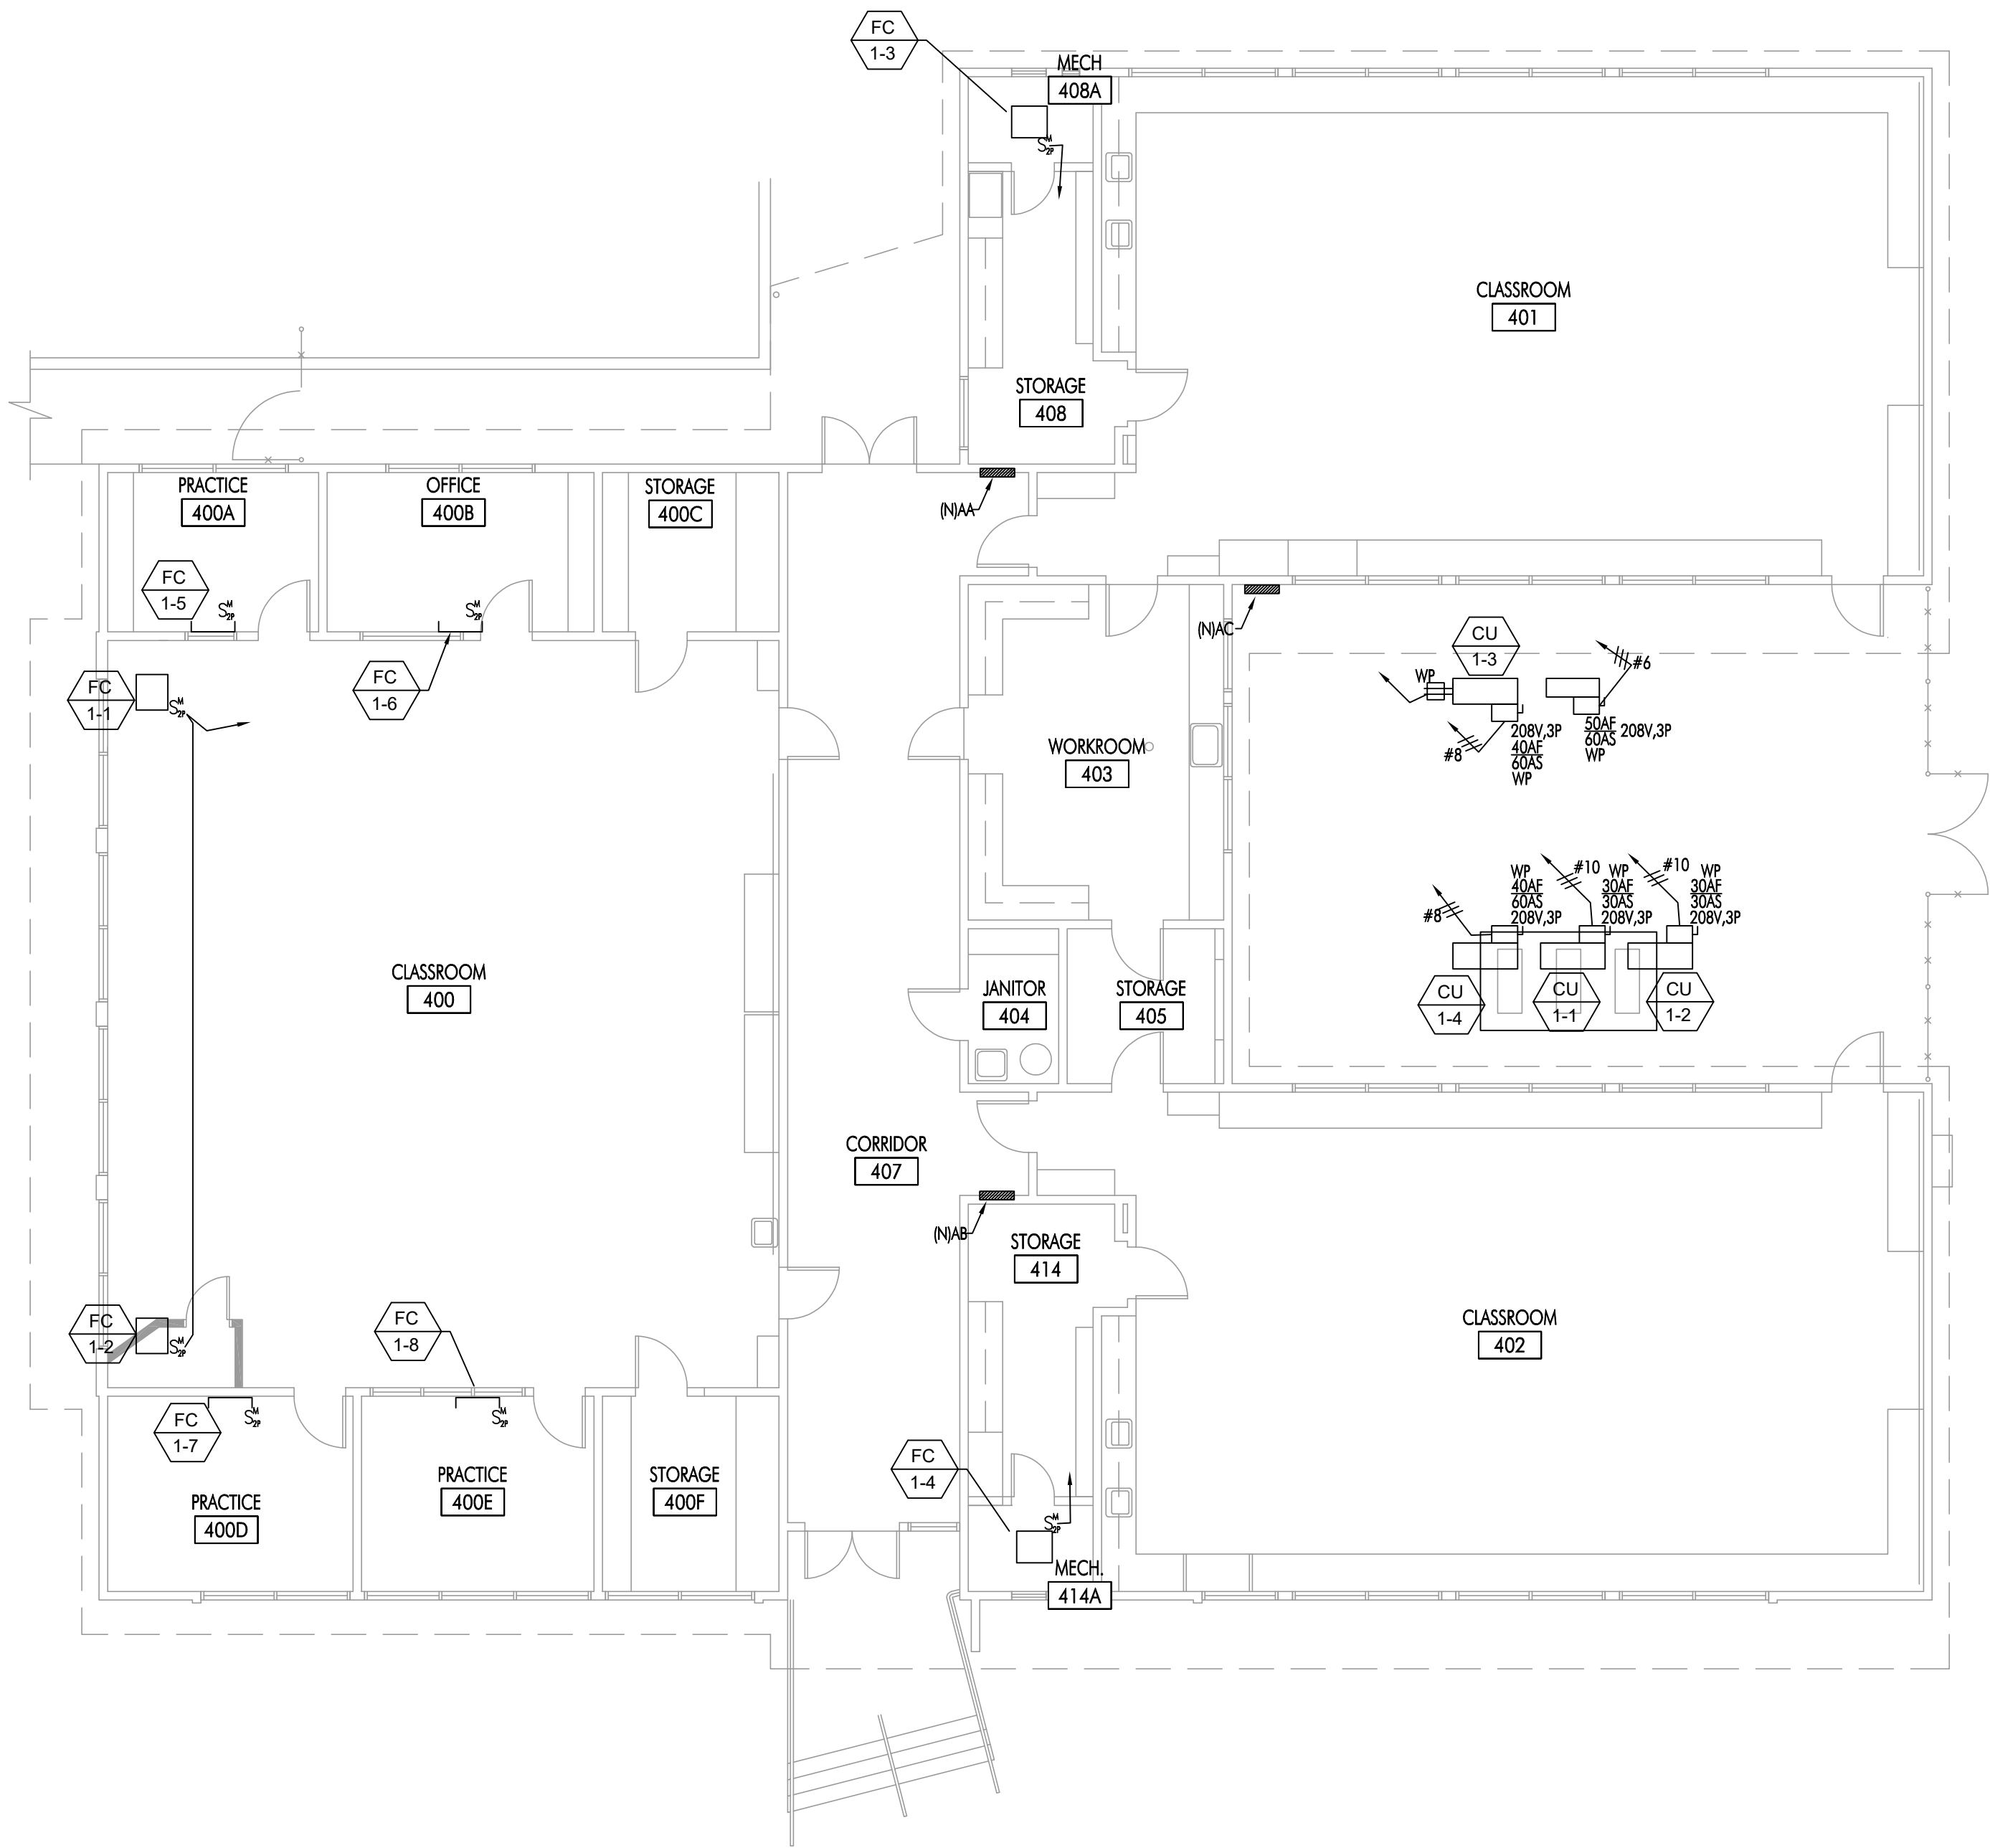
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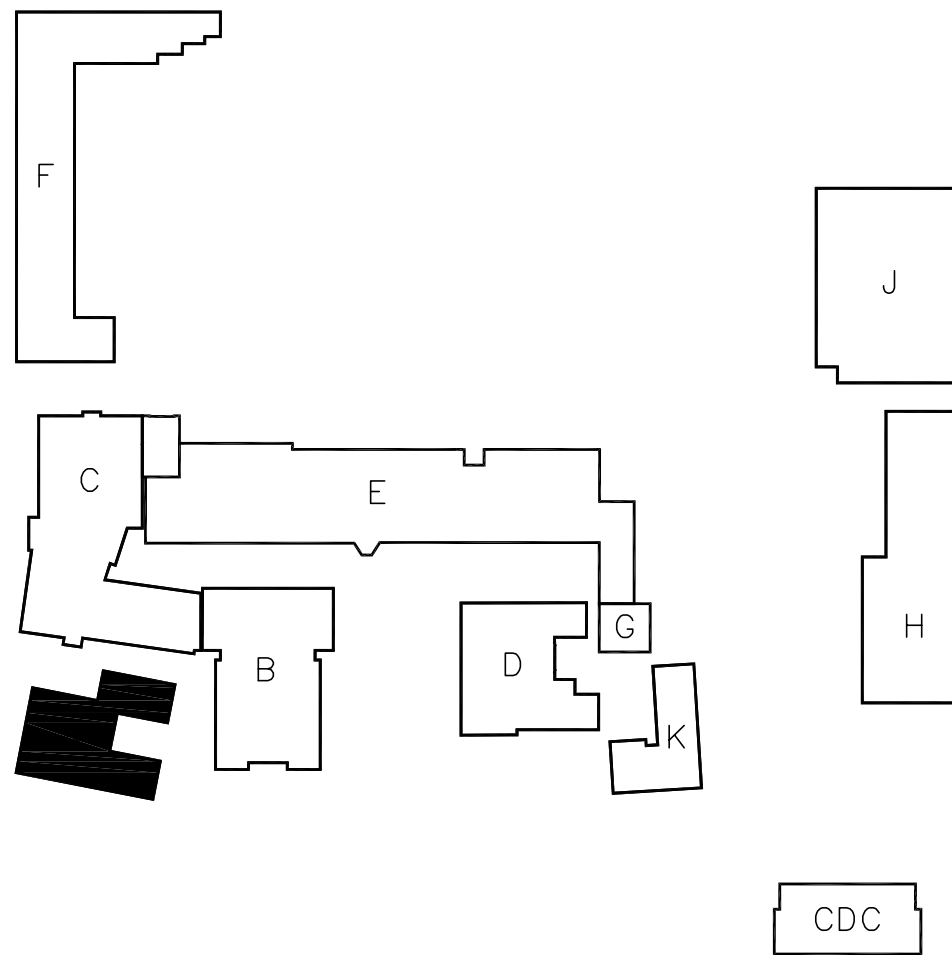
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Power Plan

Sheet Number

EA211



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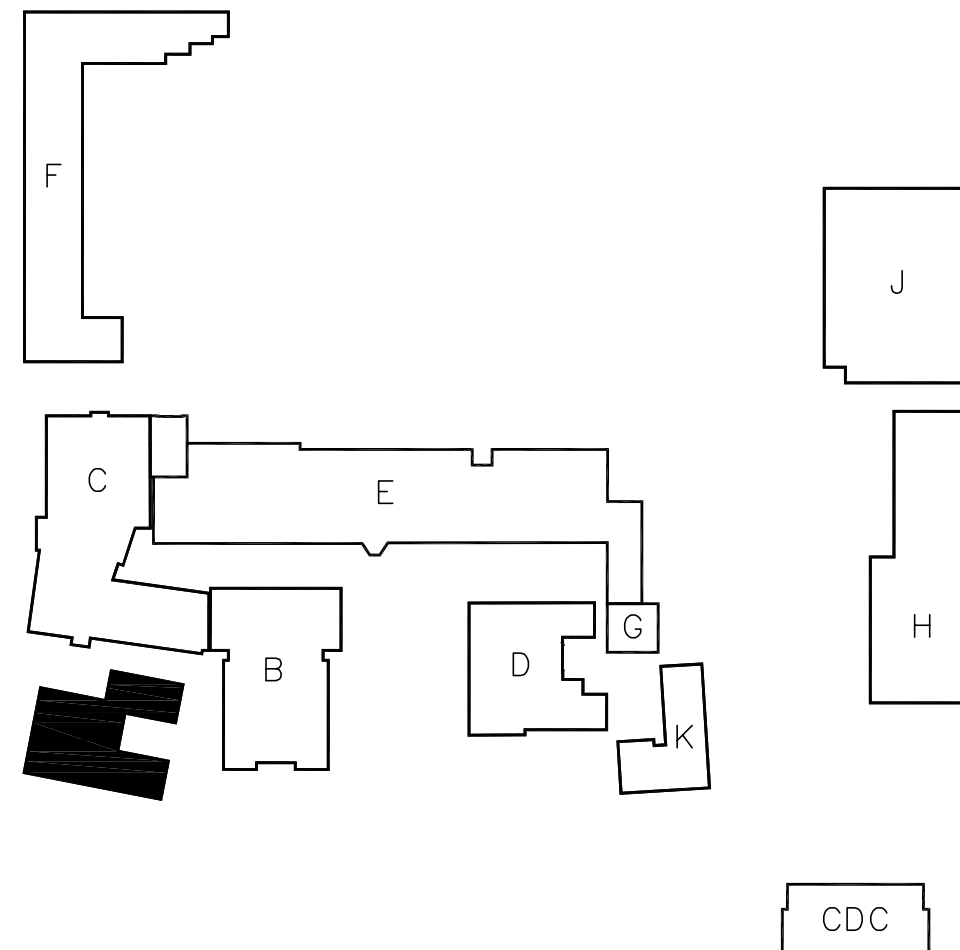

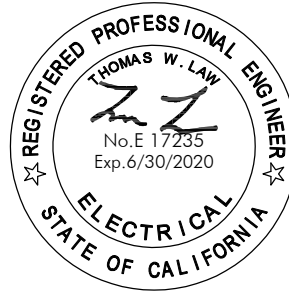
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REFERENCE NOTES

① INDOOR UNIT POWERED FROM CORRESPONDING ROOFTOP UNIT. PROVIDE 3/4"C,2#12+1#12GND BETWEEN UNITS.

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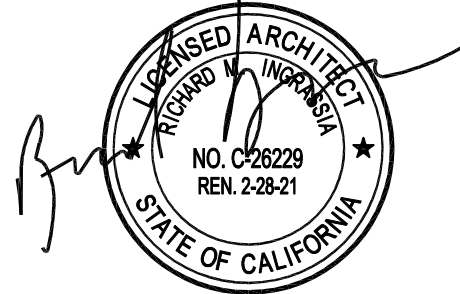
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Santa Monica, California 90403


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Sheet Title
Building 'A'
Roof Power Plan

Sheet Number

EA212

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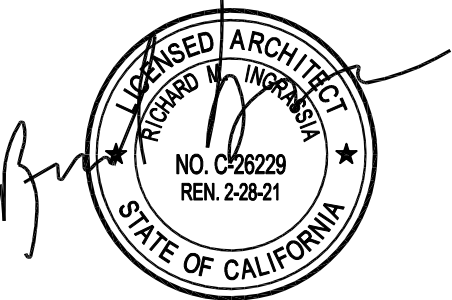
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Santa Monica, California 90403


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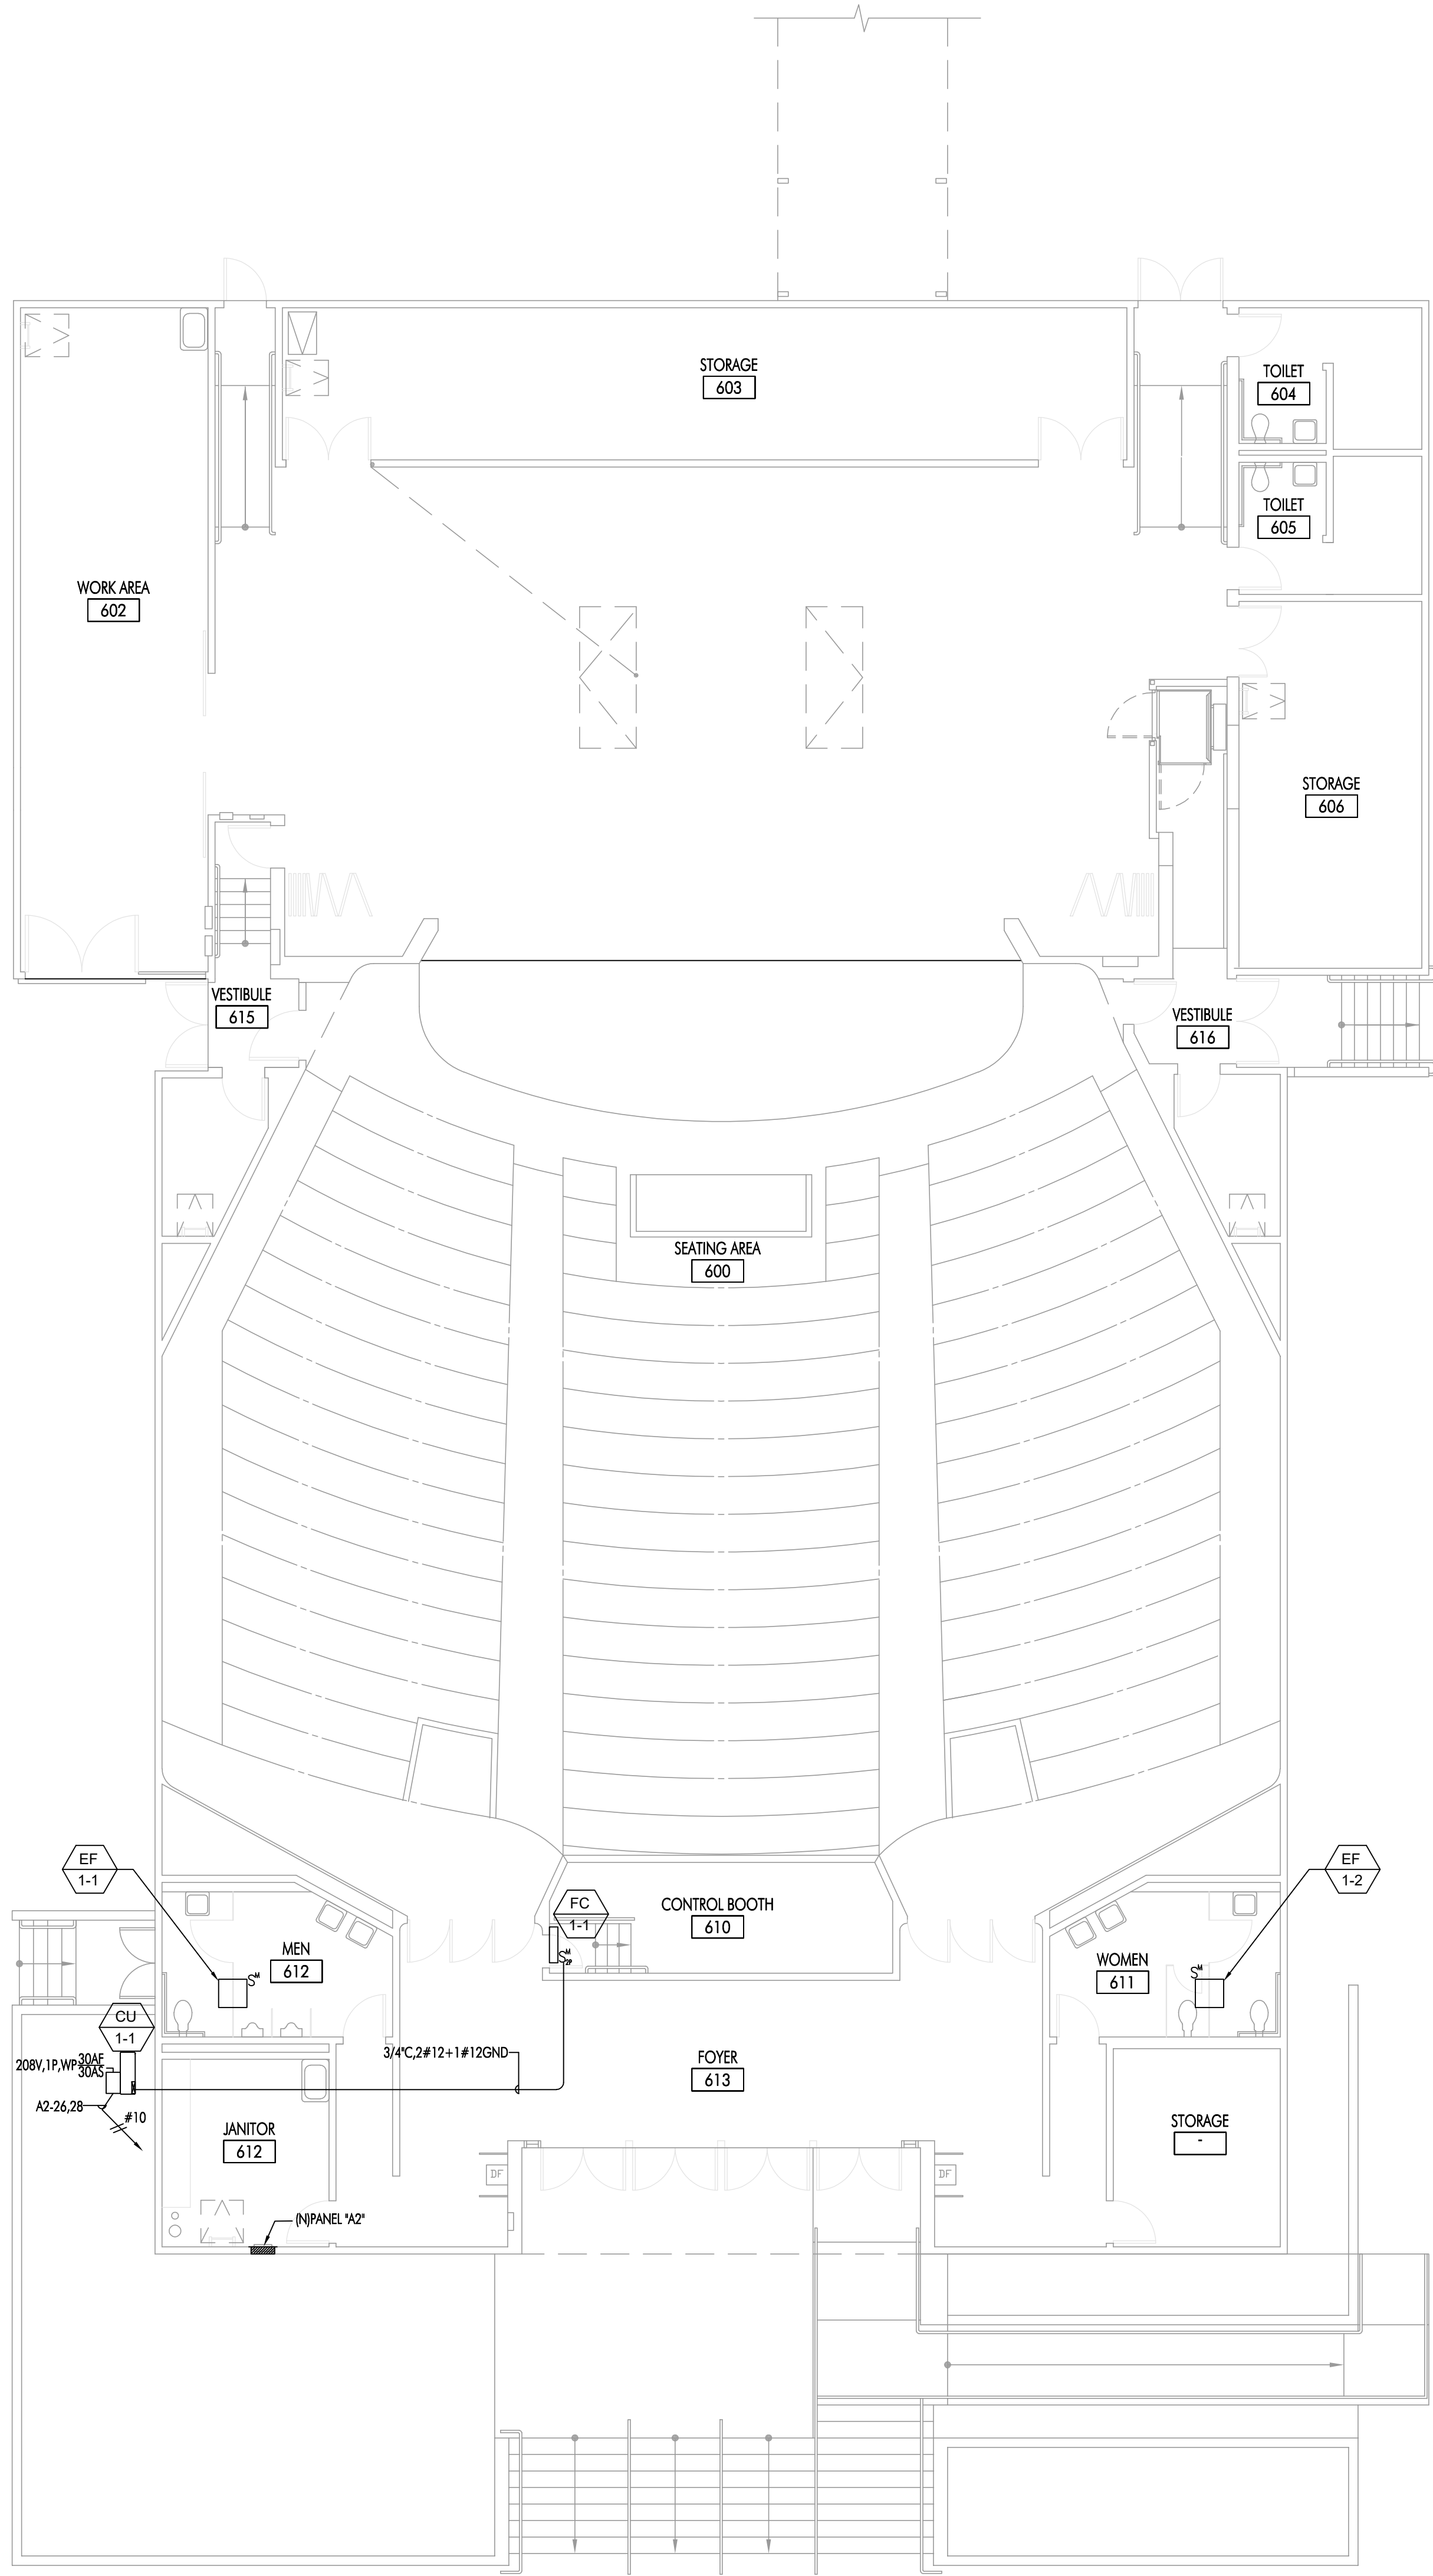
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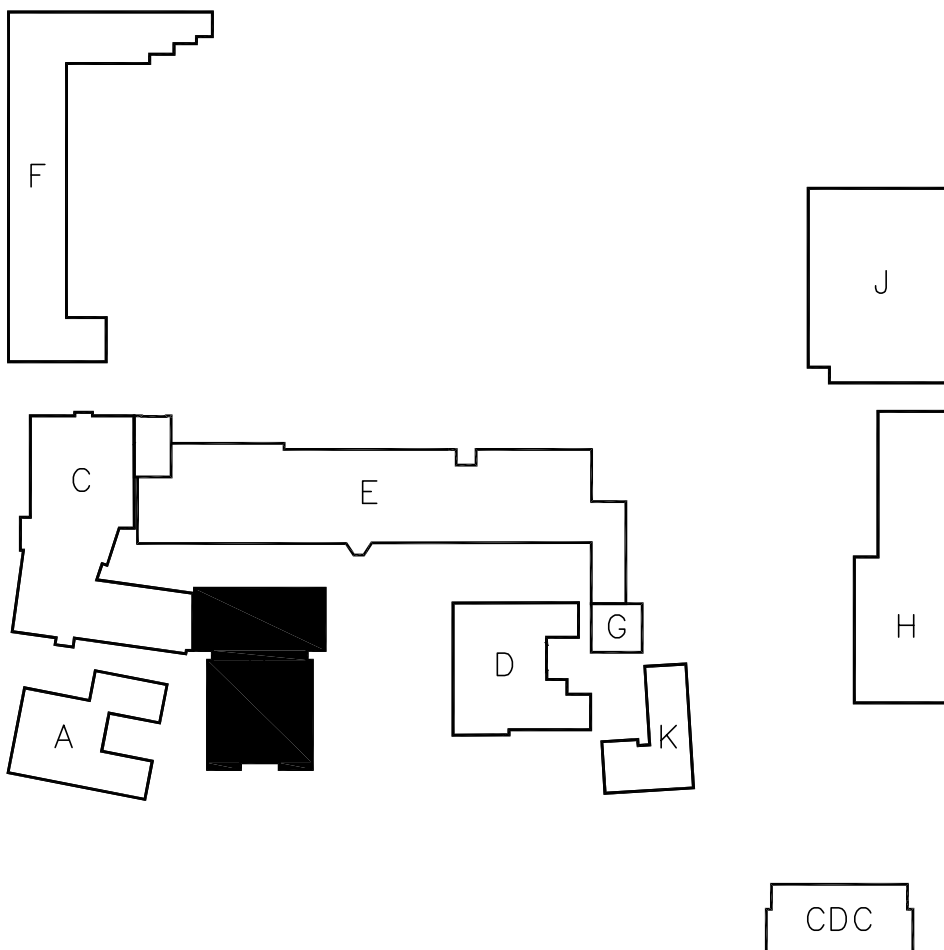
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Sheet Number
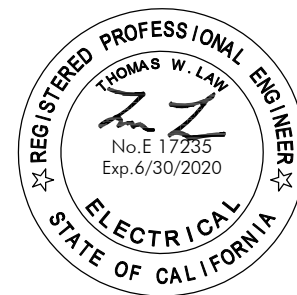
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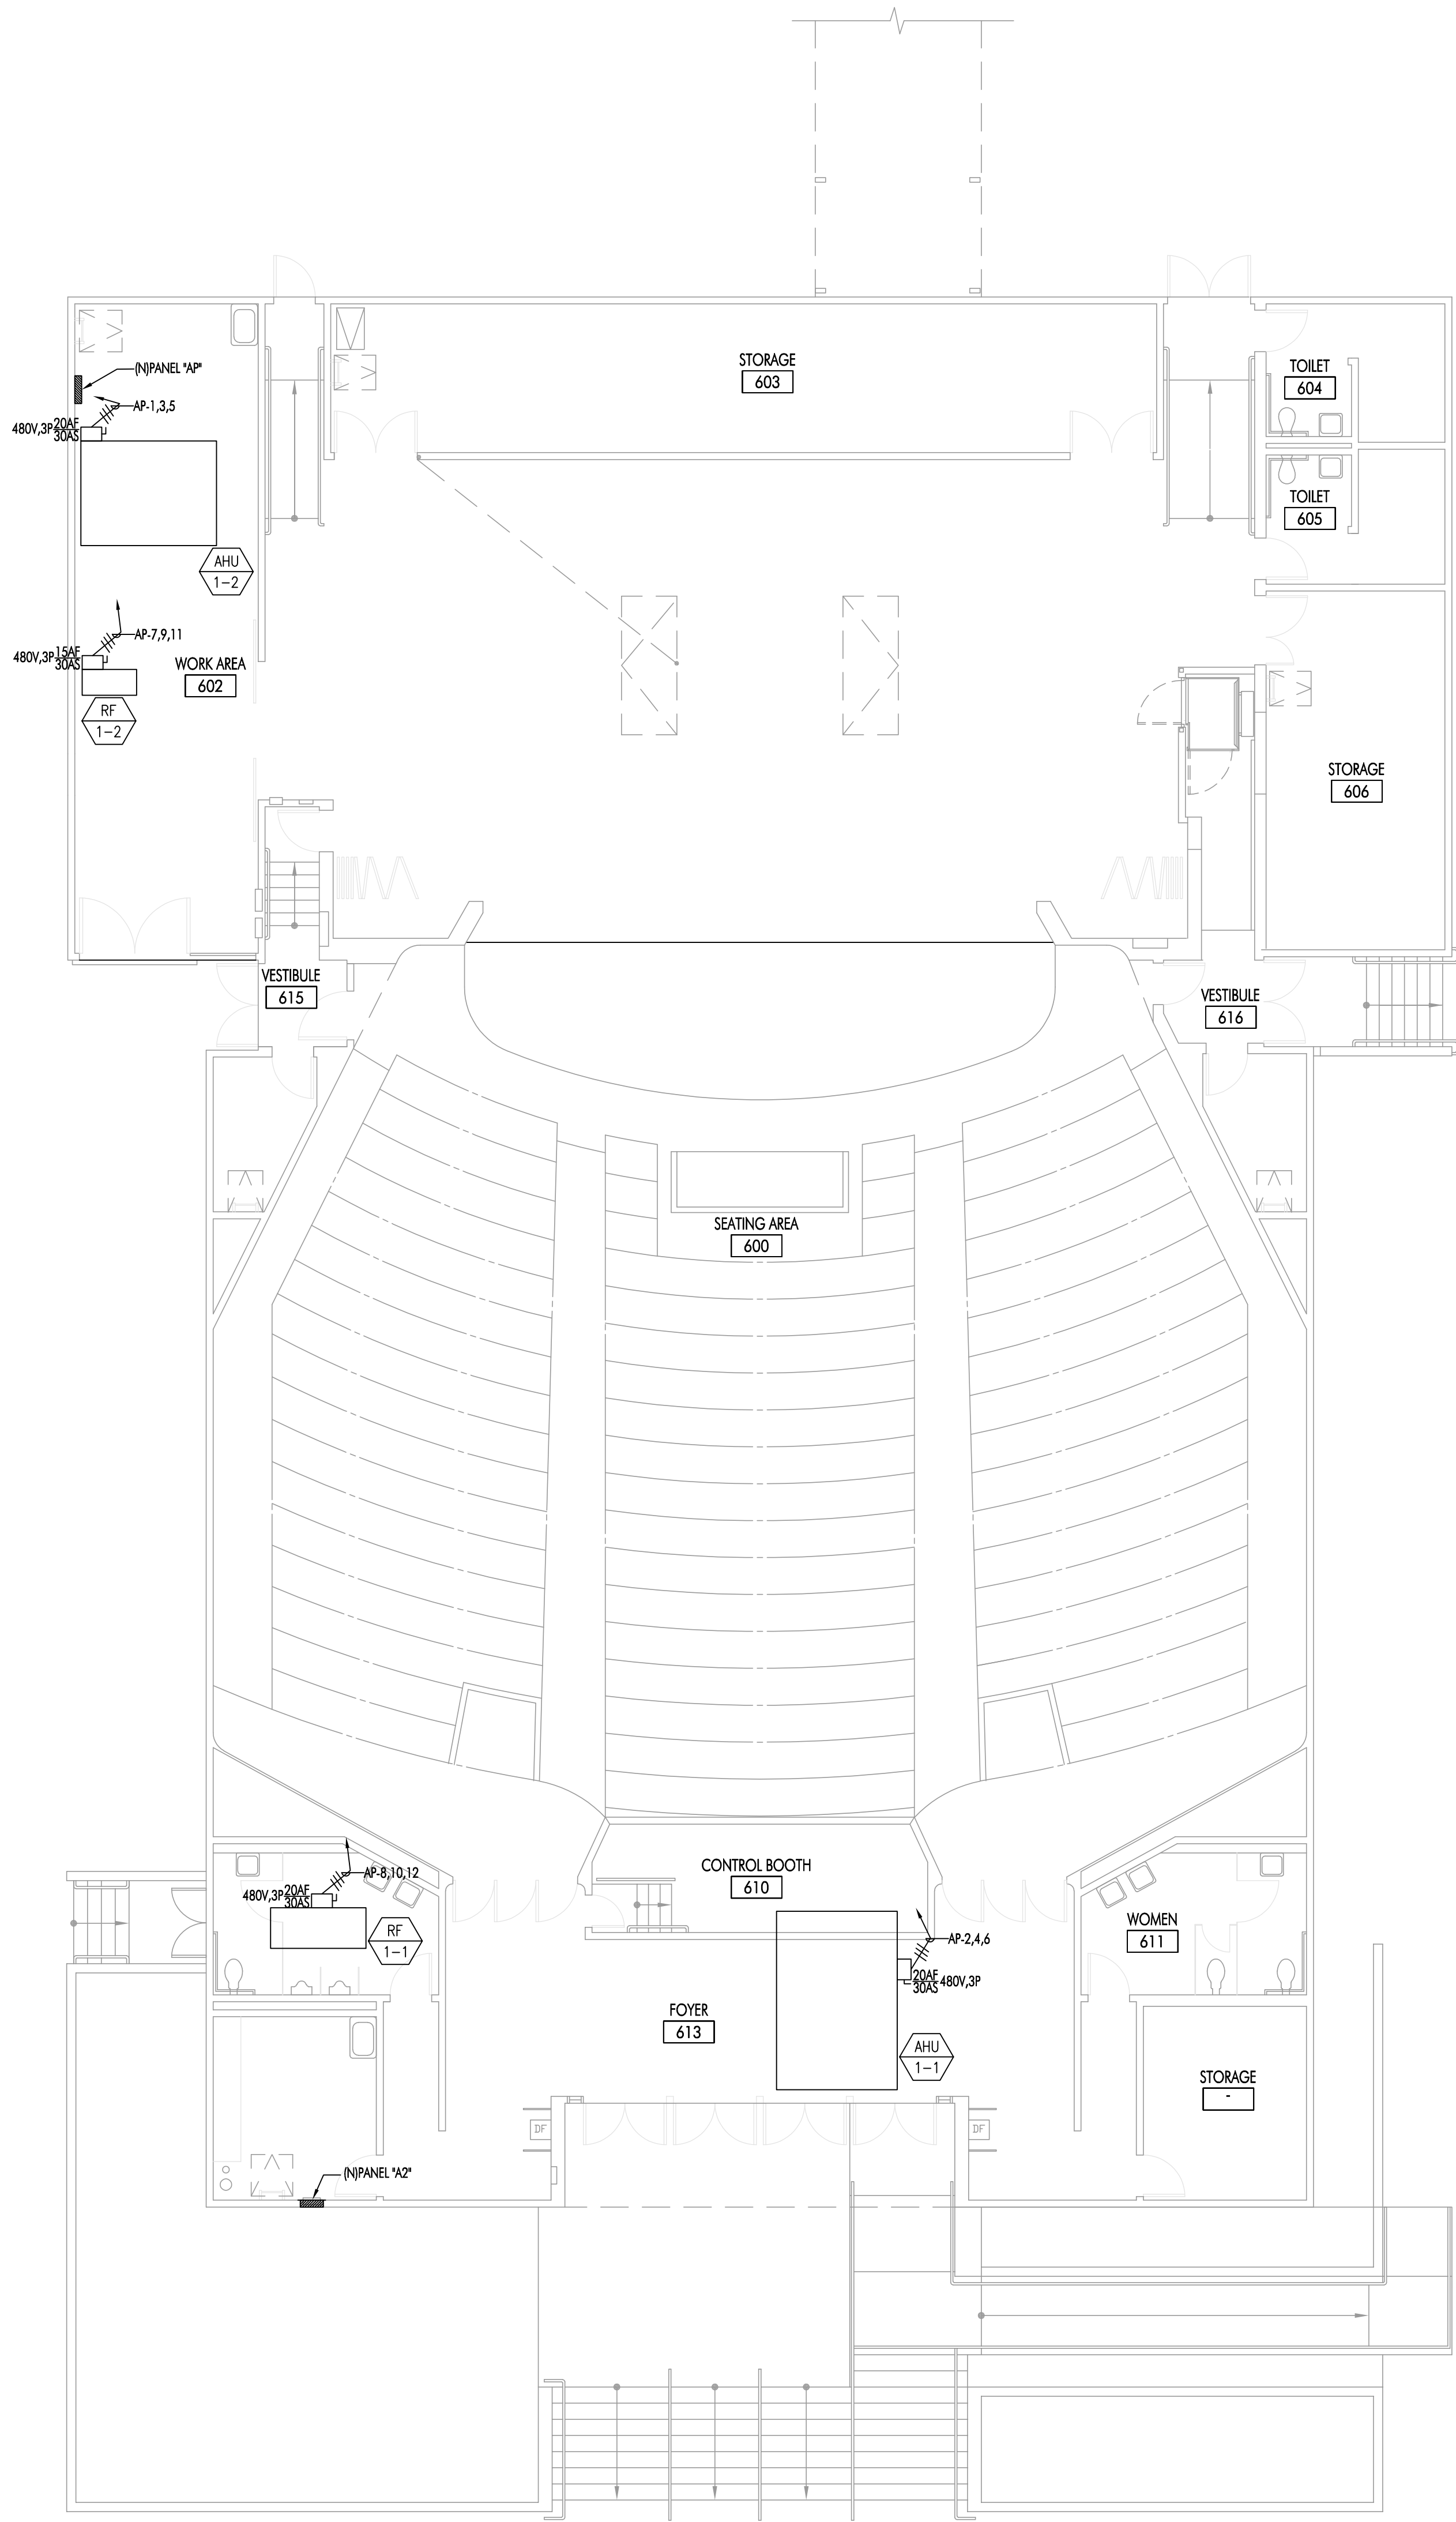


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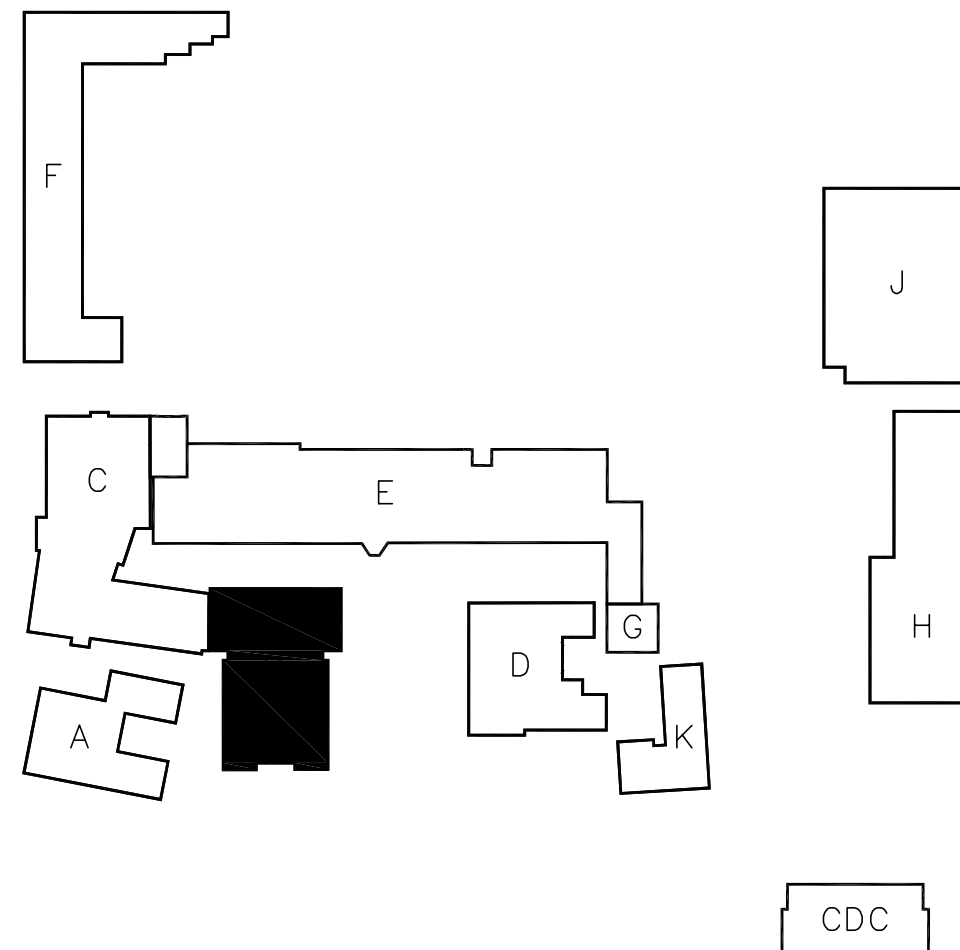


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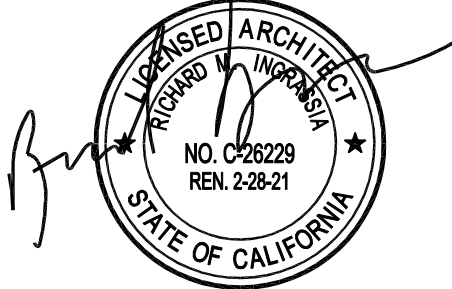
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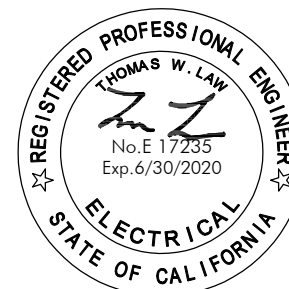
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Sheet Title
Building 'B'
Mezzanine
Power Plan

Sheet Number

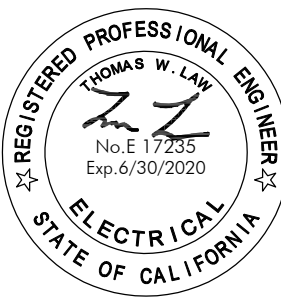EB212

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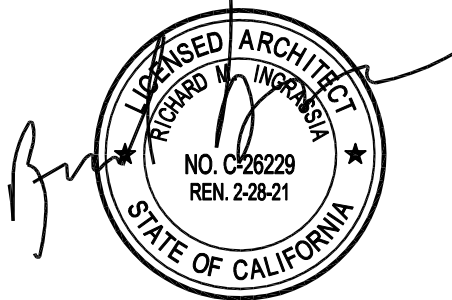
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Lincoln Middle School
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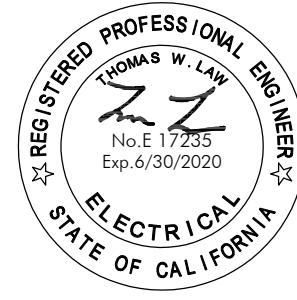
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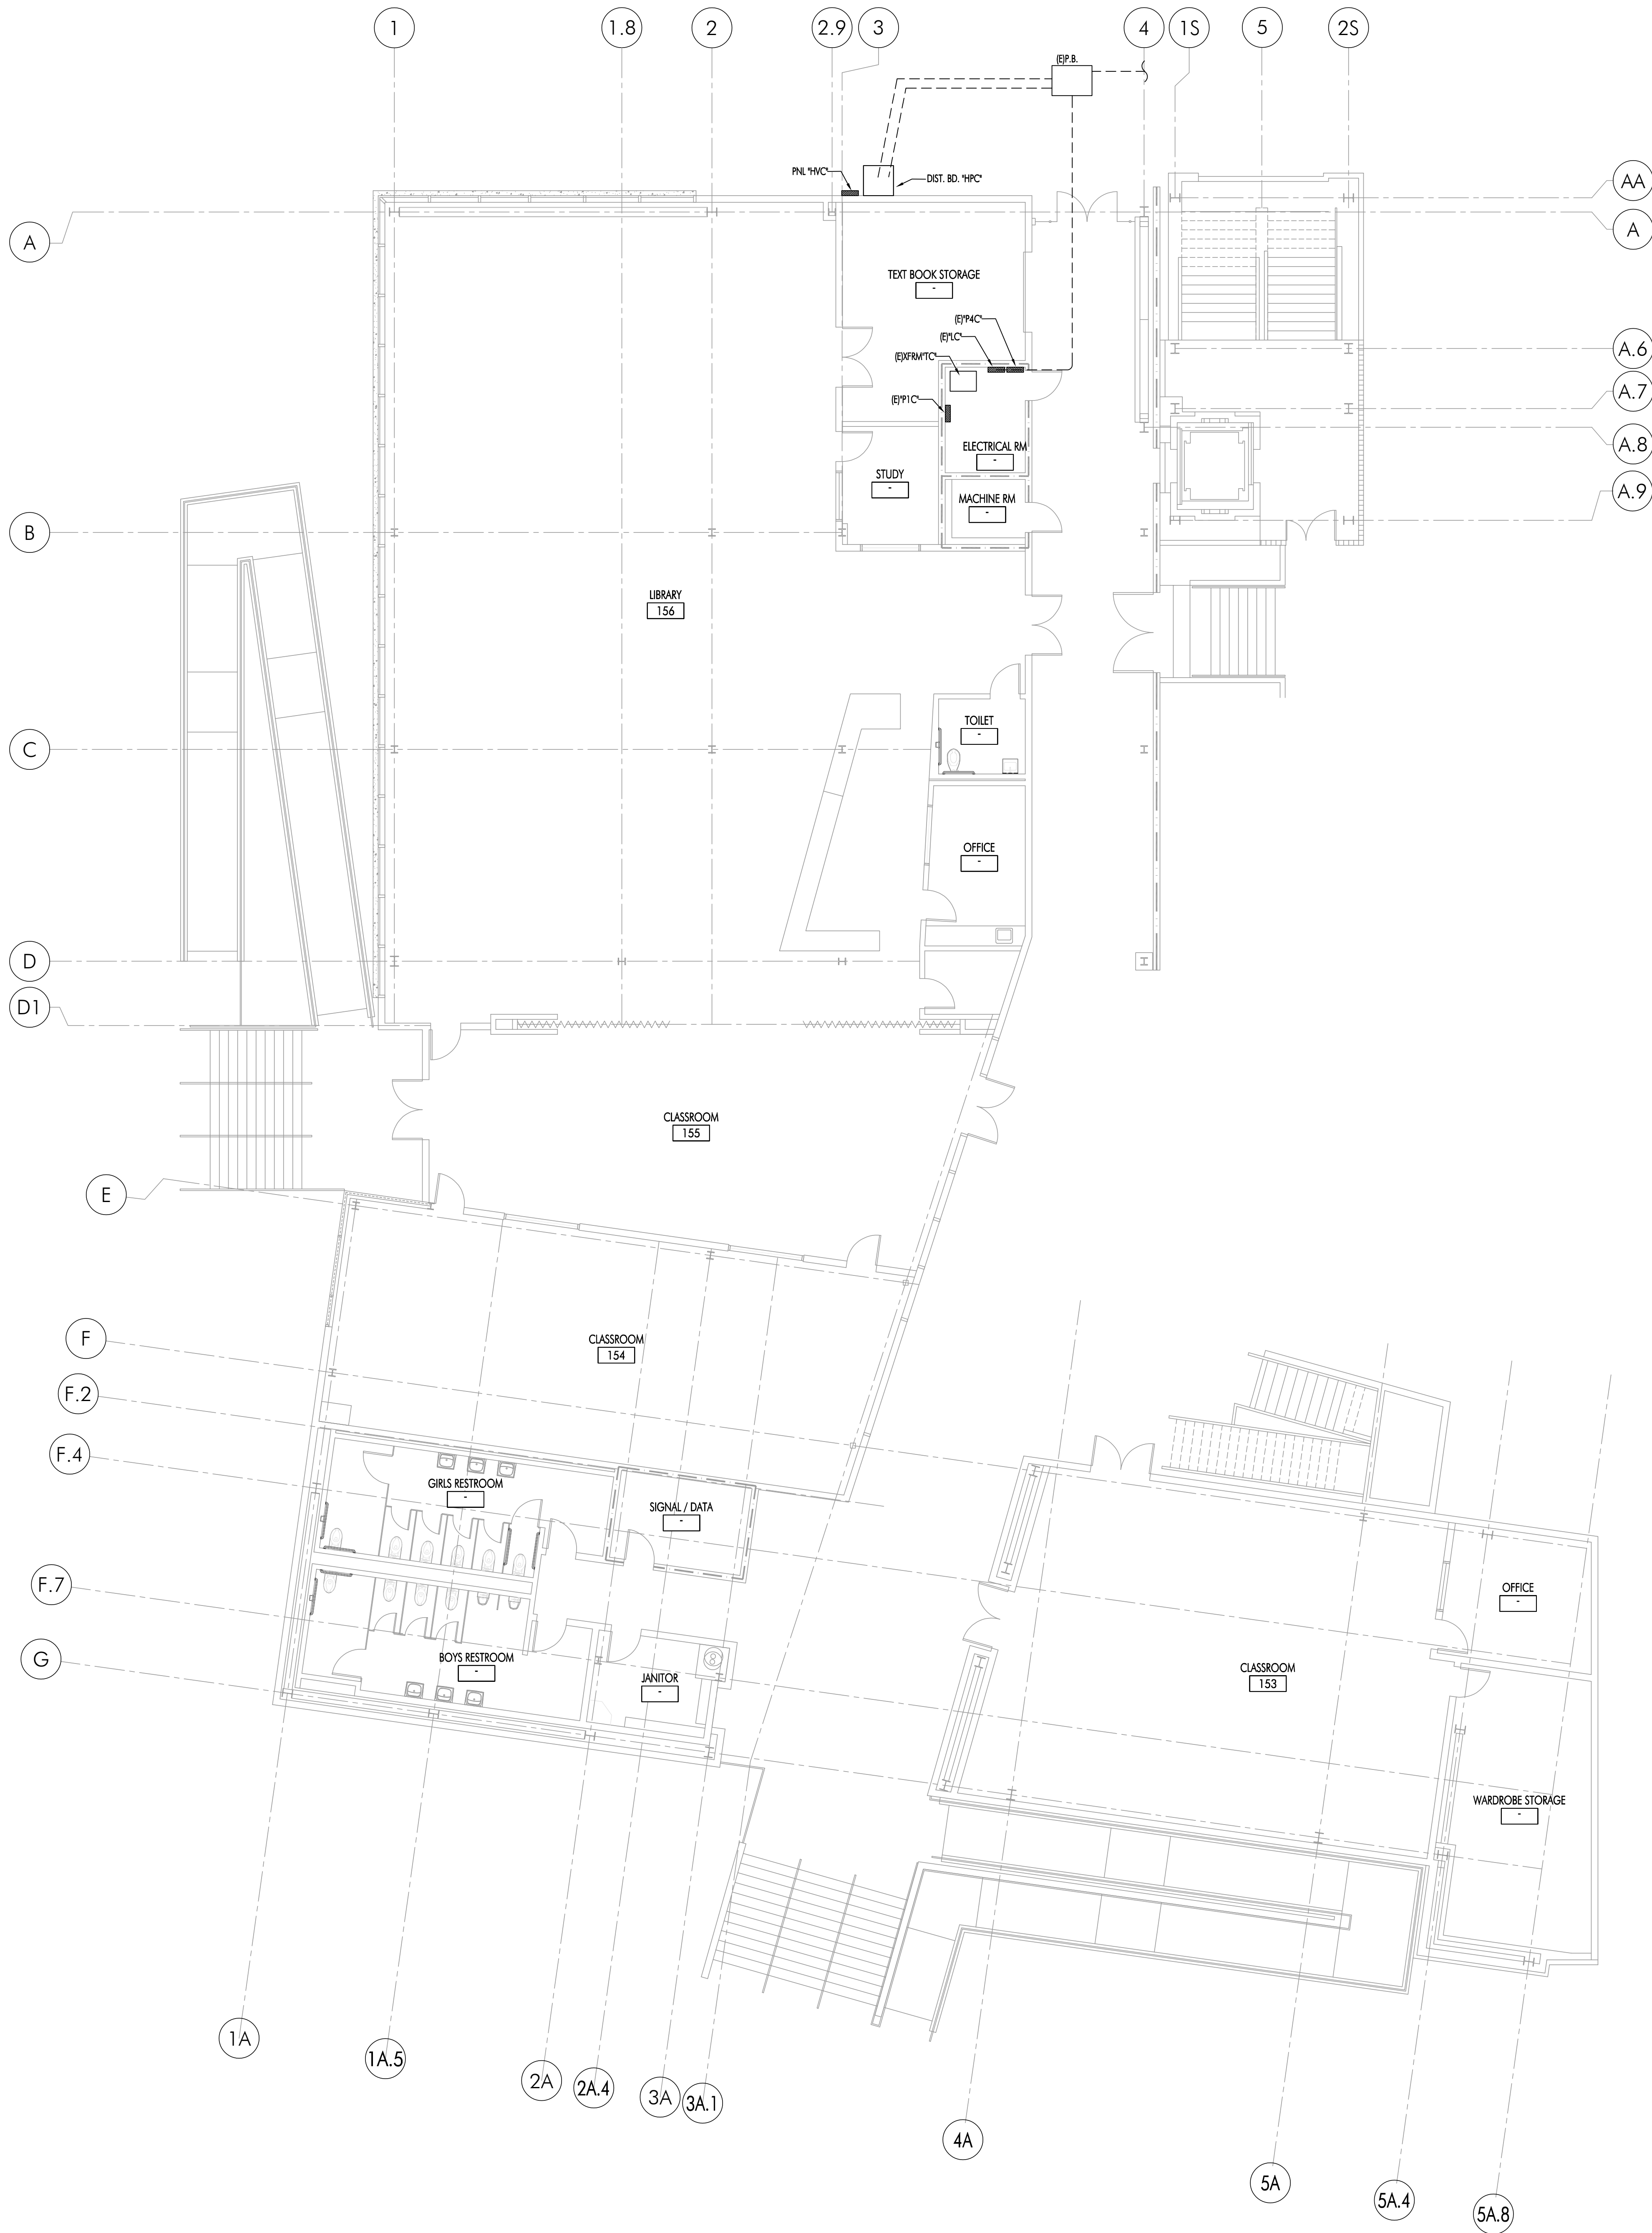
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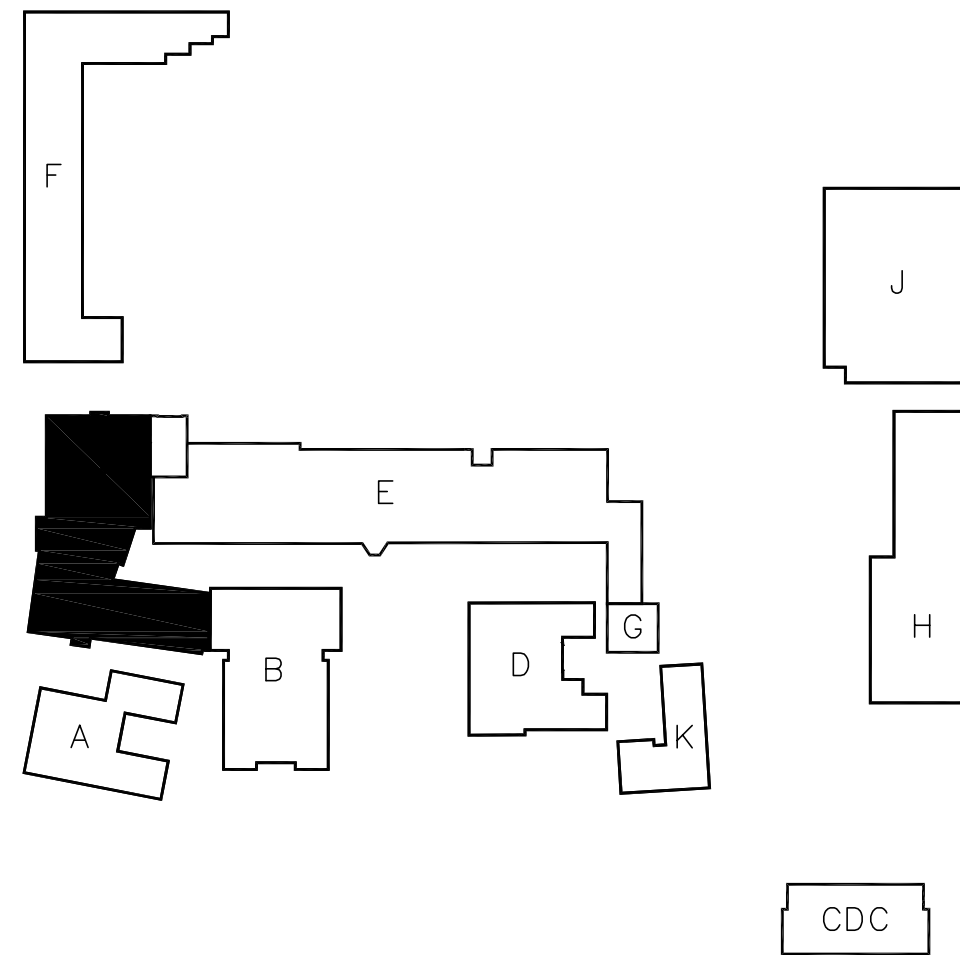
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**Building 'C1' First
Floor Power Plan**

Sheet Number

EC211




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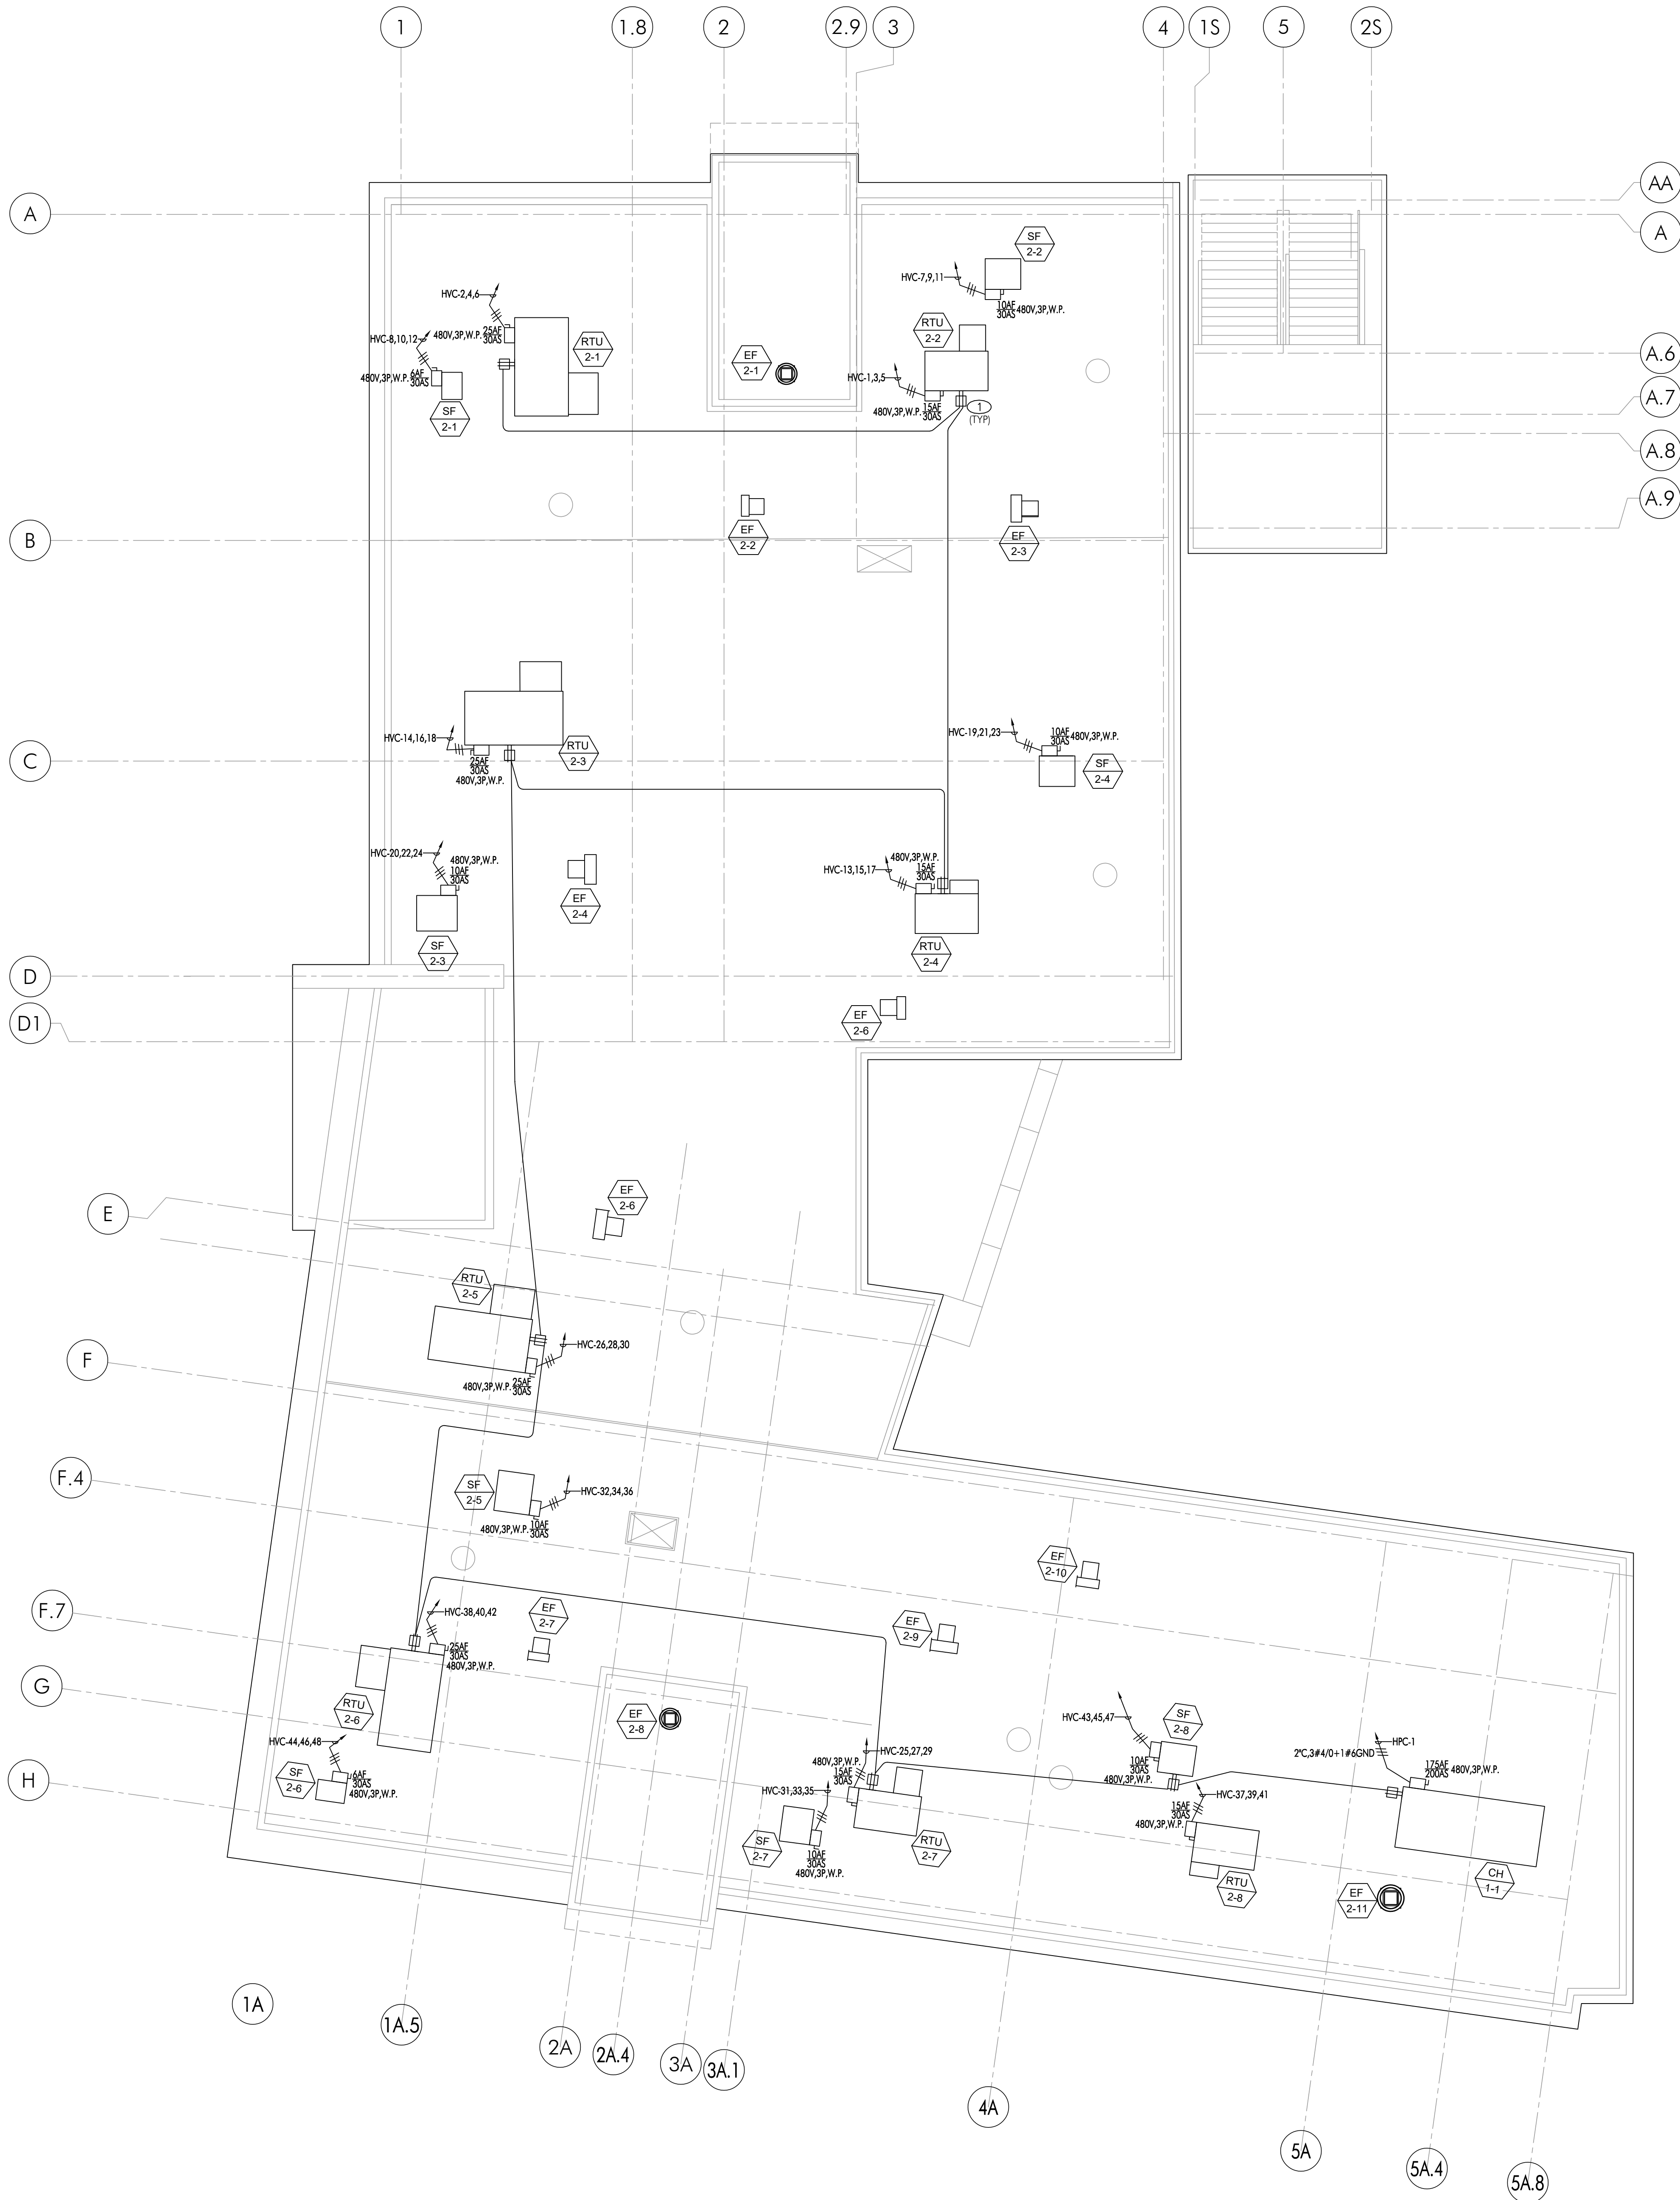
KEY PLAN

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EC212




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KEY PLAN

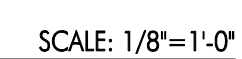

GENERAL NOTES

1. ALL ROOFTOP EQUIPMENT TO BE NEMA-3R RATED.
2. COORDINATE LOCATION FOR EQUIPMENT POINTS OF CONNECTION/DISCONNECT SWITCHES. MAINTAIN ALL CODE REQUIRED CLEARANCES.
3. PROVIDE DURA-BLOK (OR EQUAL) SUPPORTS FOR ALL CONDUITS RUN ON ROOF.

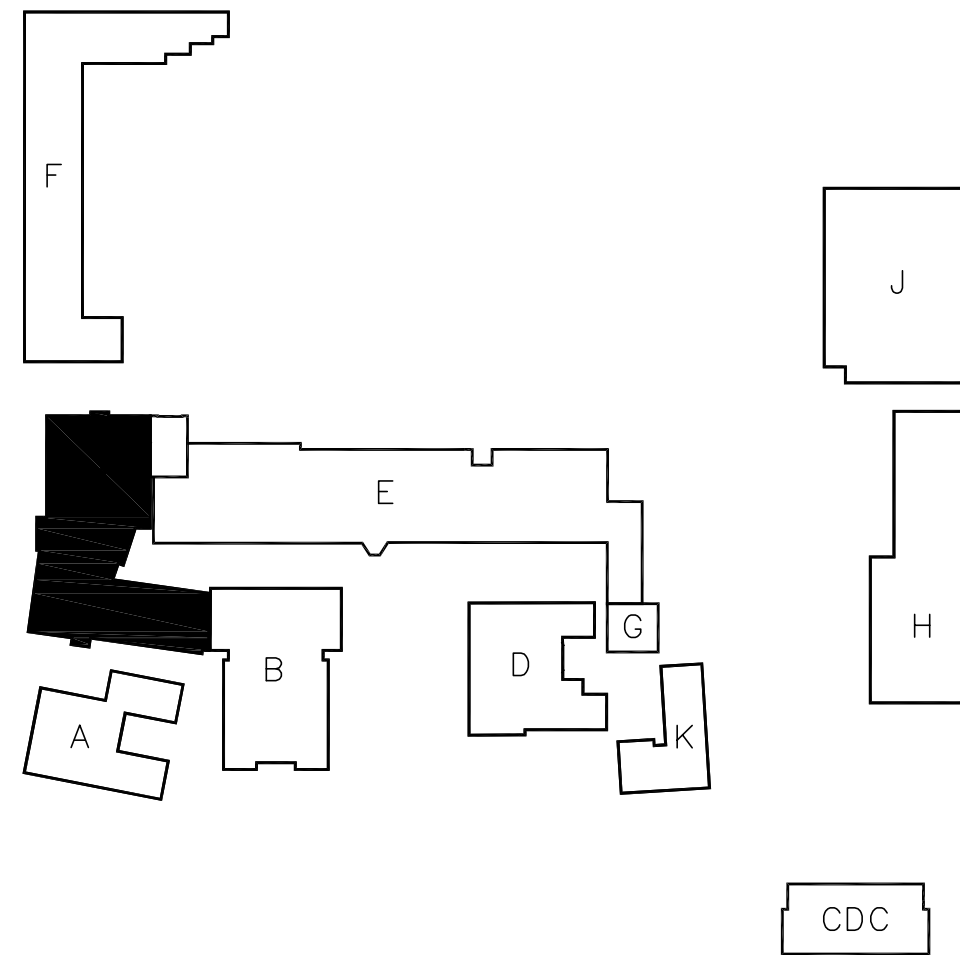REFERENCE NOTES

- ① PROVIDE WEATHER RESISTANT, GFI PROTECTED RECEPTACLE, IN WEATHERPROOF ENCLOSURE, LISTED/IDENTIFIED AS 'EXTRA DUTY' COVER, MOUNTED ON UNISTRUT SUPPORTING WIREWAY/DISCONNECT SWITCHES

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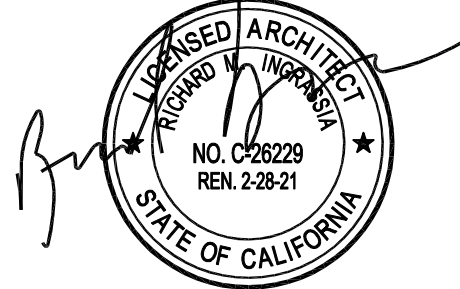
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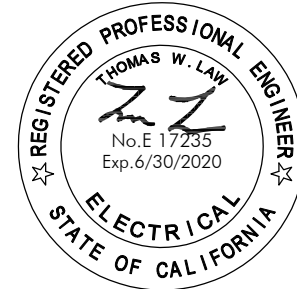
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Checked By: BA

Architect / Engineer Stamp



Consultants



Sheet Title
Building 'C1' Roof
Power Plan

Sheet Number

EC241

DSA Stamp

Architect




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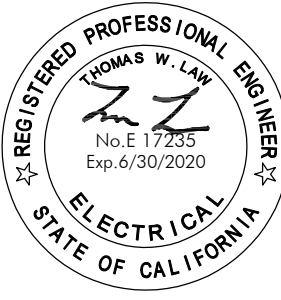
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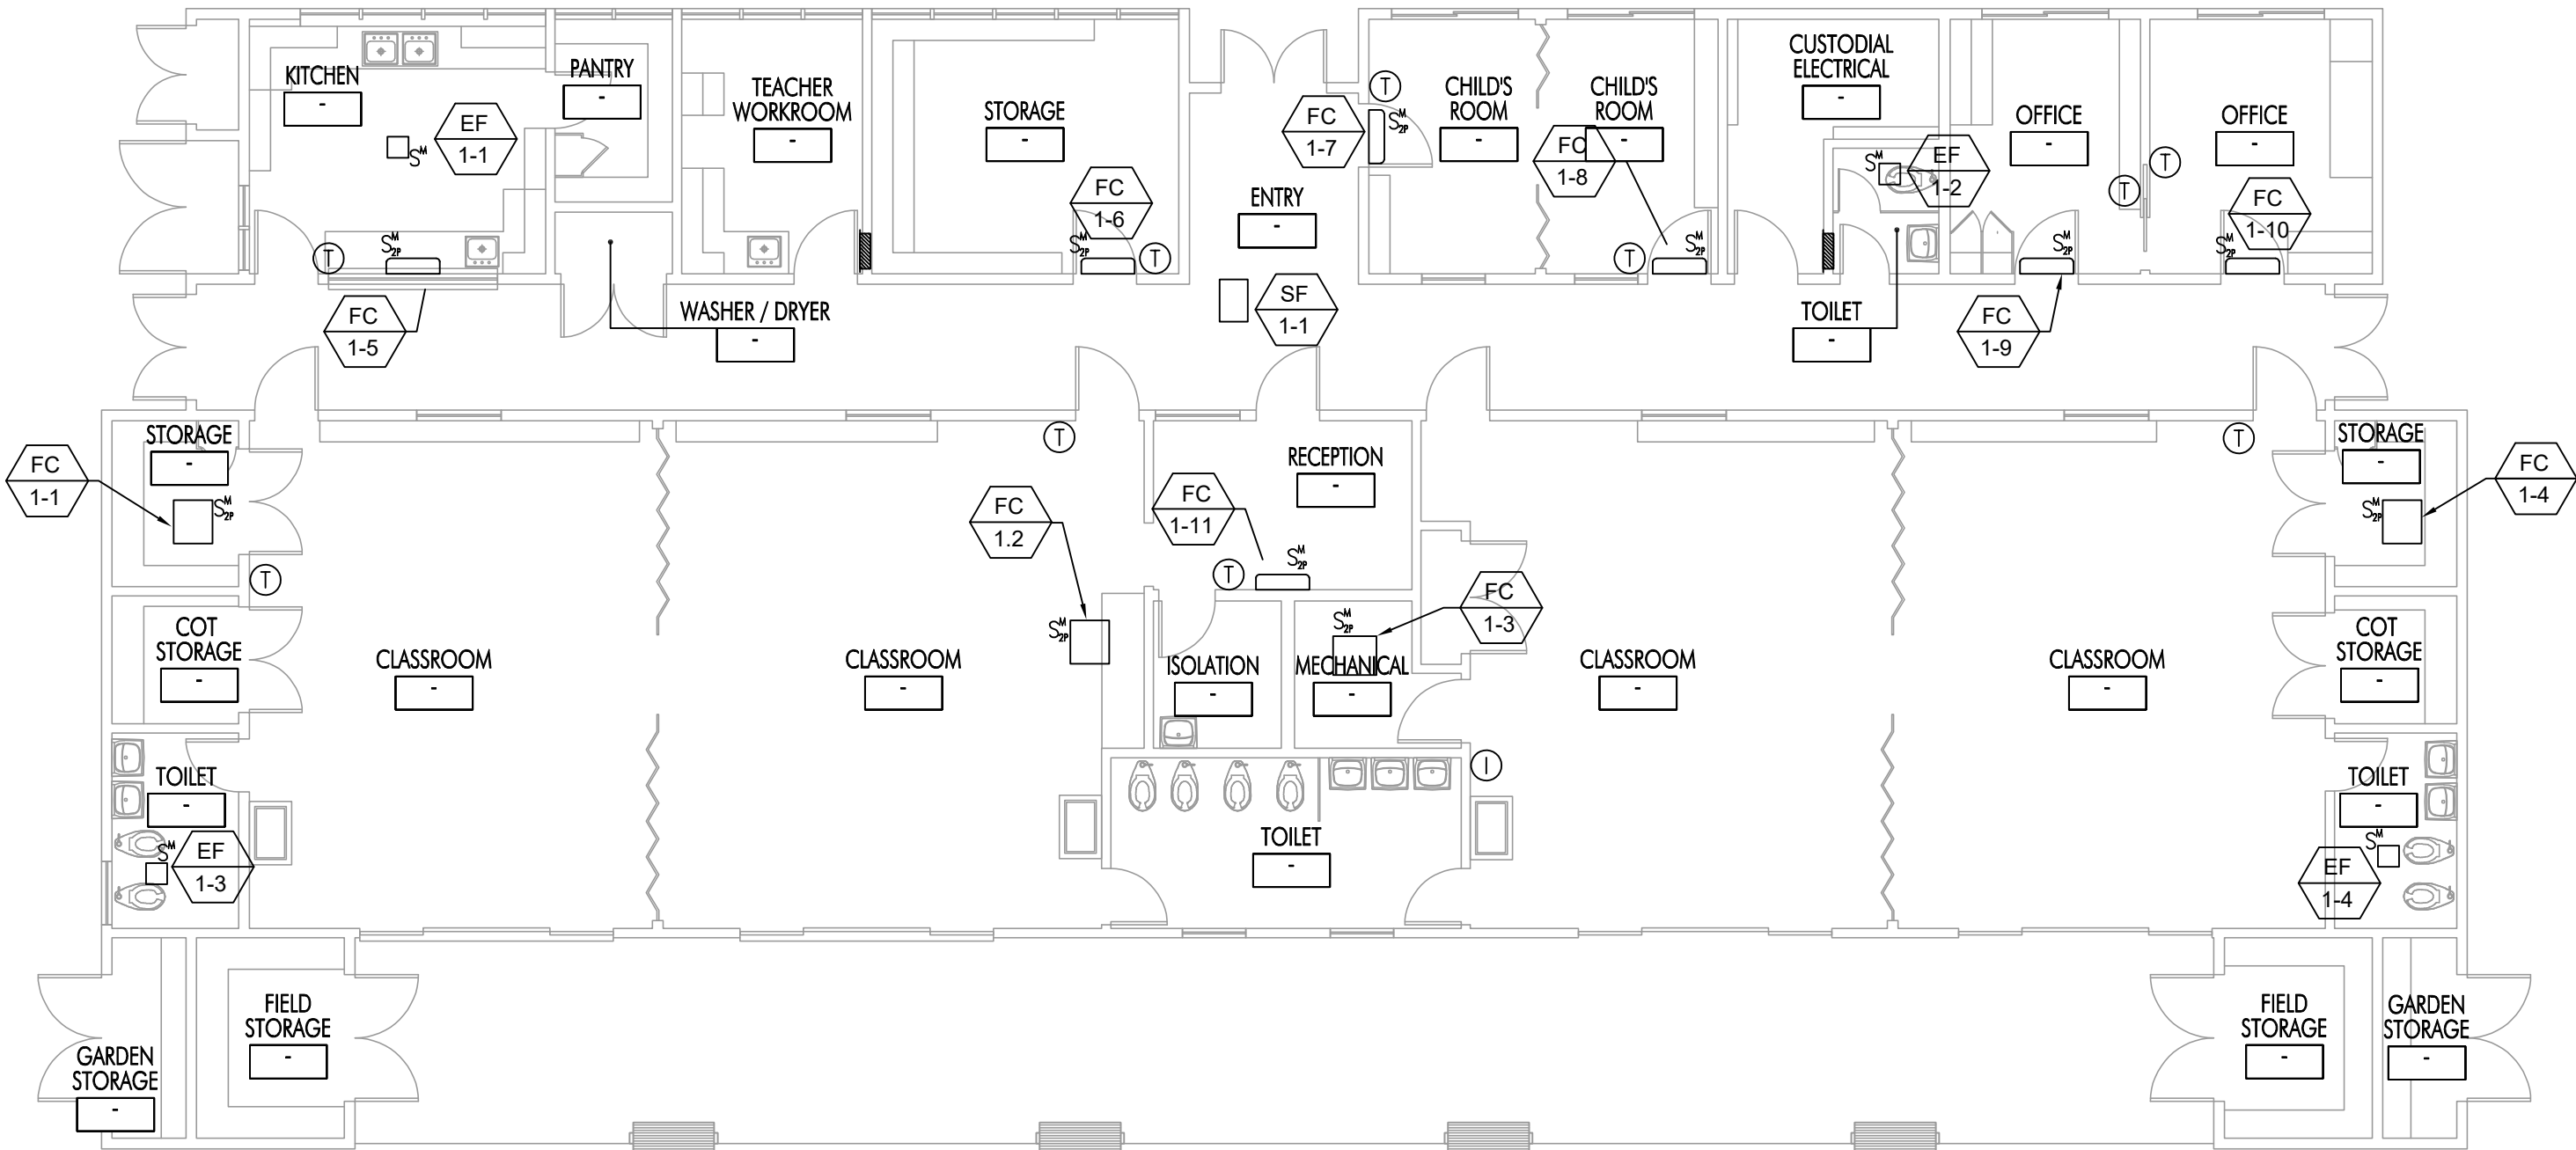
Consultants



Sheet Title
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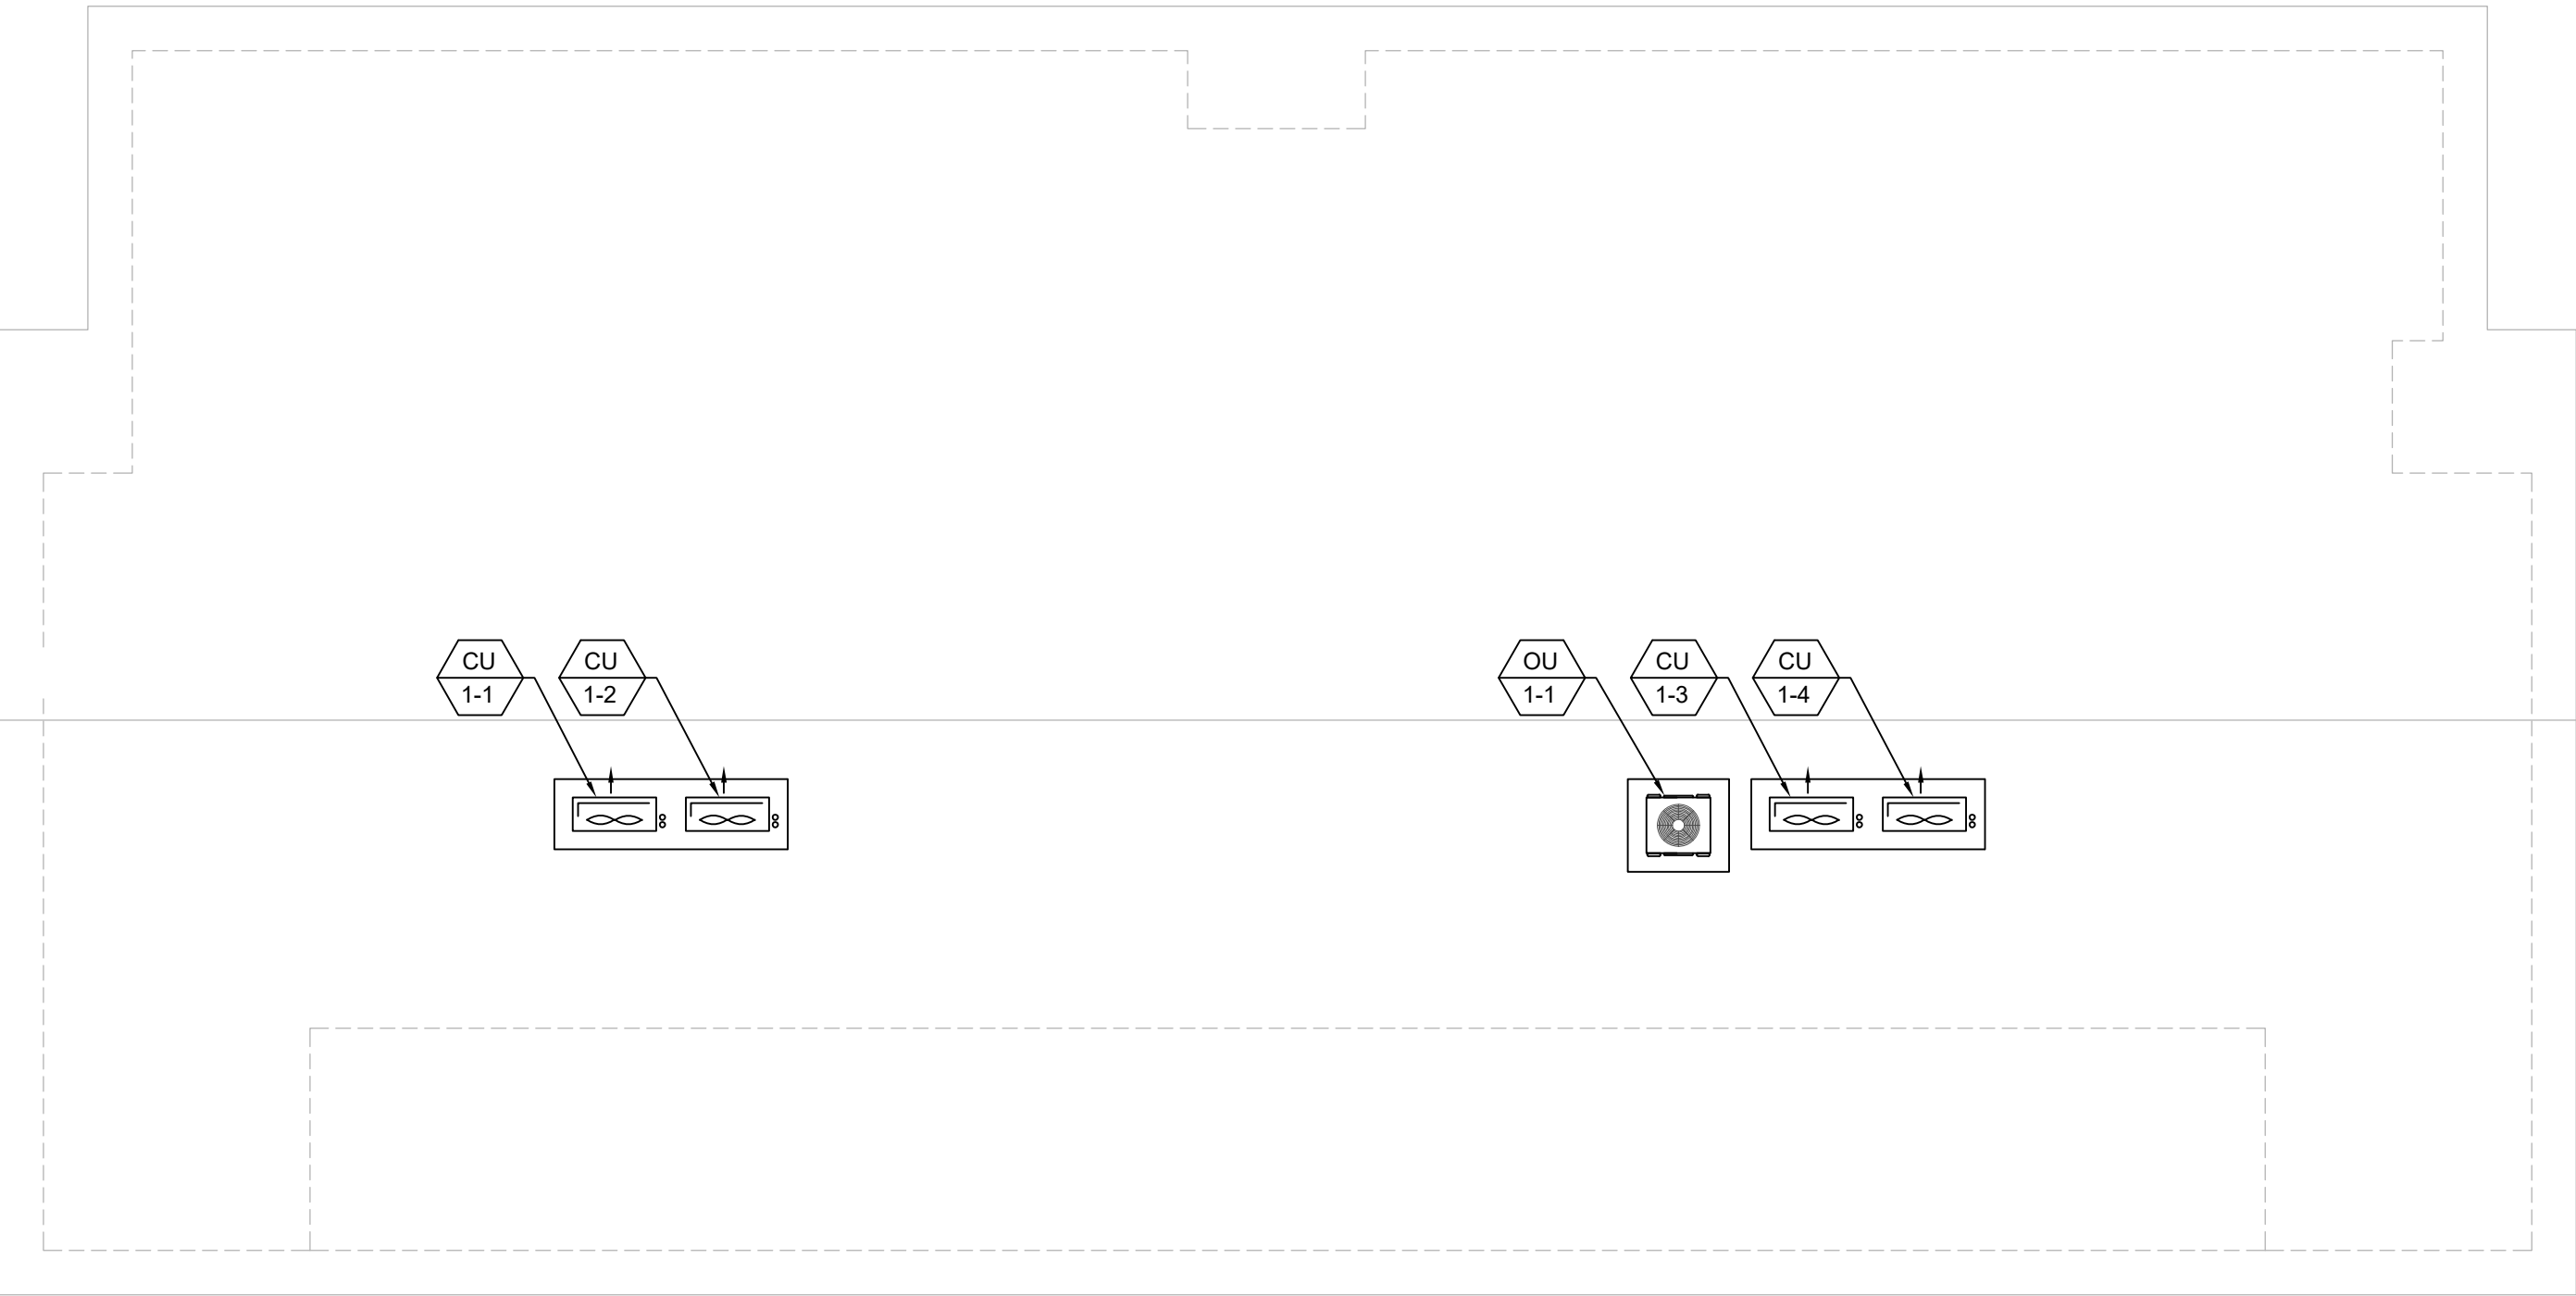
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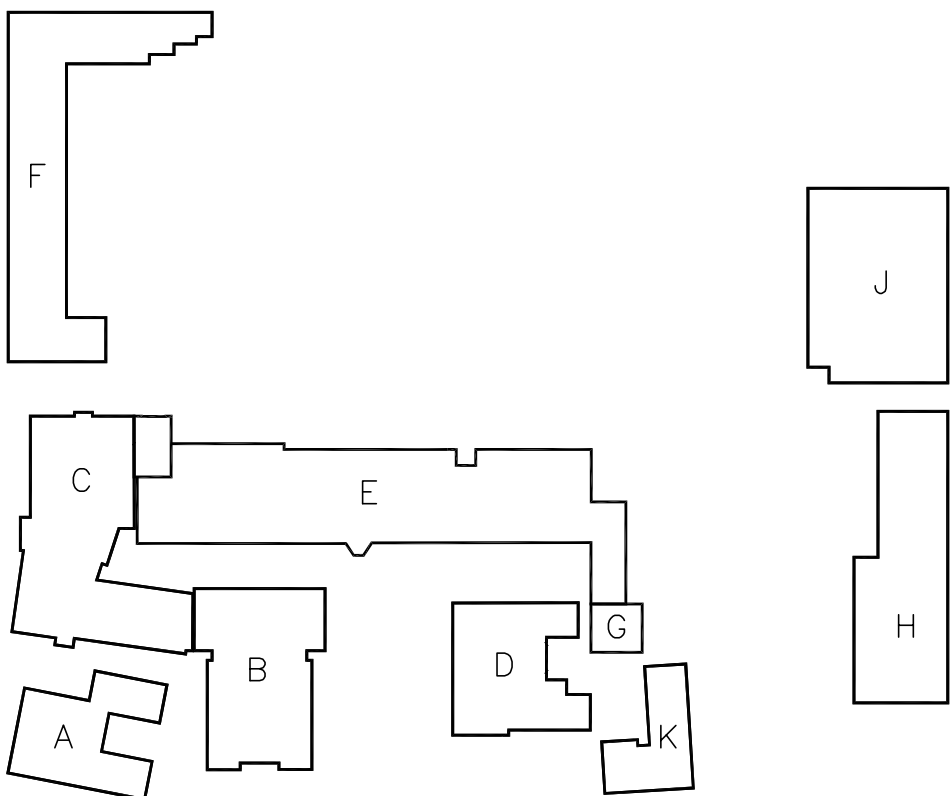
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1 FLOOR PLAN



SCALE: 1/8"=1'-0"

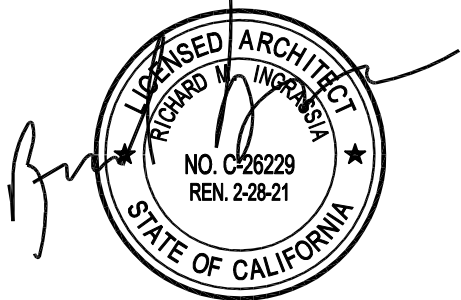2 ROOF PLAN




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SCALE: 1/8"=1'-0"



KEY PLAN

REFERENCE NOTES

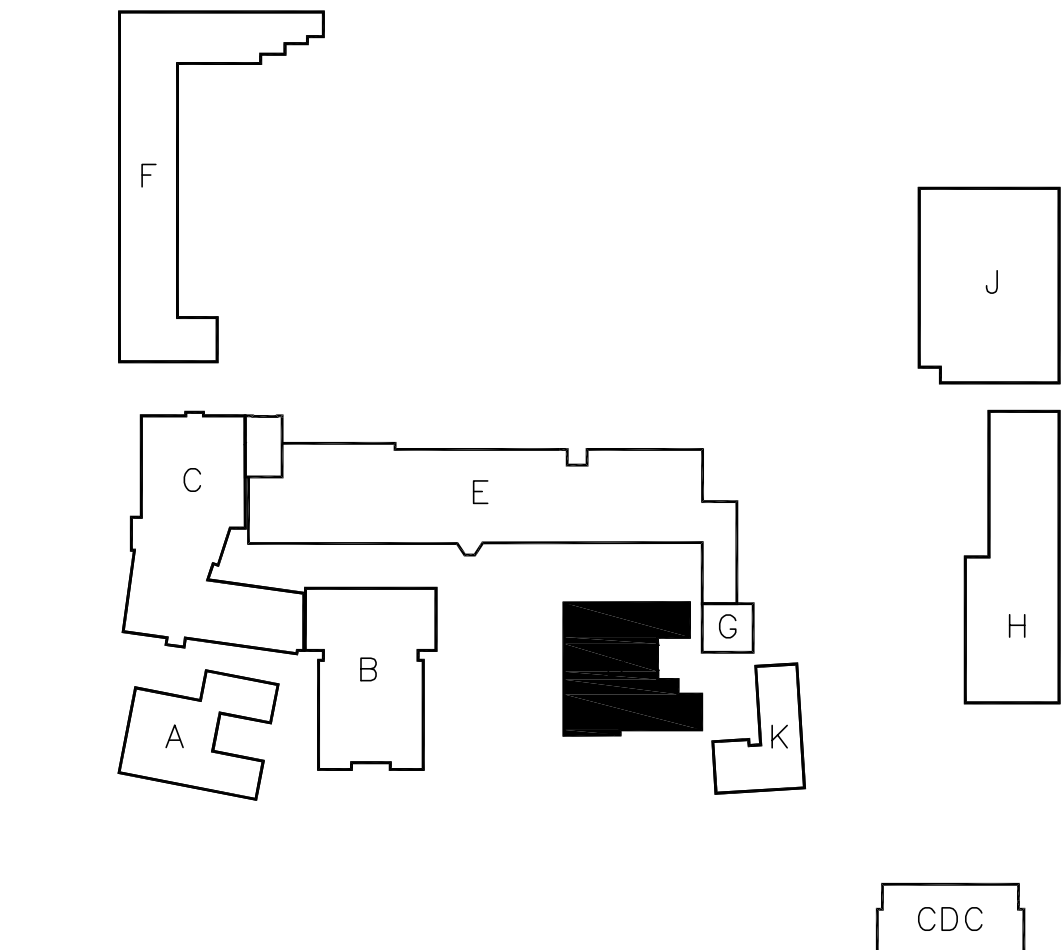- ① INDOOR UNIT POWERED FROM CORRESPONDING ROOFTOP UNIT. PROVIDE 3/4" C, 2#12 + 1#12 GND BETWEEN UNITS.

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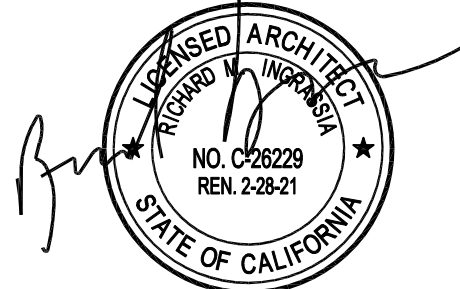
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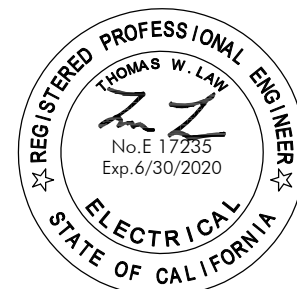
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Consultants



Building 'D' Power Plan

Sheet Number

ED211

1. ALL ROOFTOP EQUIPMENT TO BE NEMA-3R RATED.
2. COORDINATE LOCATION FOR EQUIPMENT POINTS OF CONNECTION/DISCONNECT SWITCHES. MAINTAIN ALL CODE REQUIRED CLEARANCES.
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② W.P. WIREWAY 8'x8"LENGTH AS REQUIRED(MIN.), MOUNT WIREWAY + 18"AFF WITH GALVANIZED UNISTRUT SUPPORTS. W.P. FUSIBLE DISCONNECTS MOUNTED TO UNISTRUT SUPPORT



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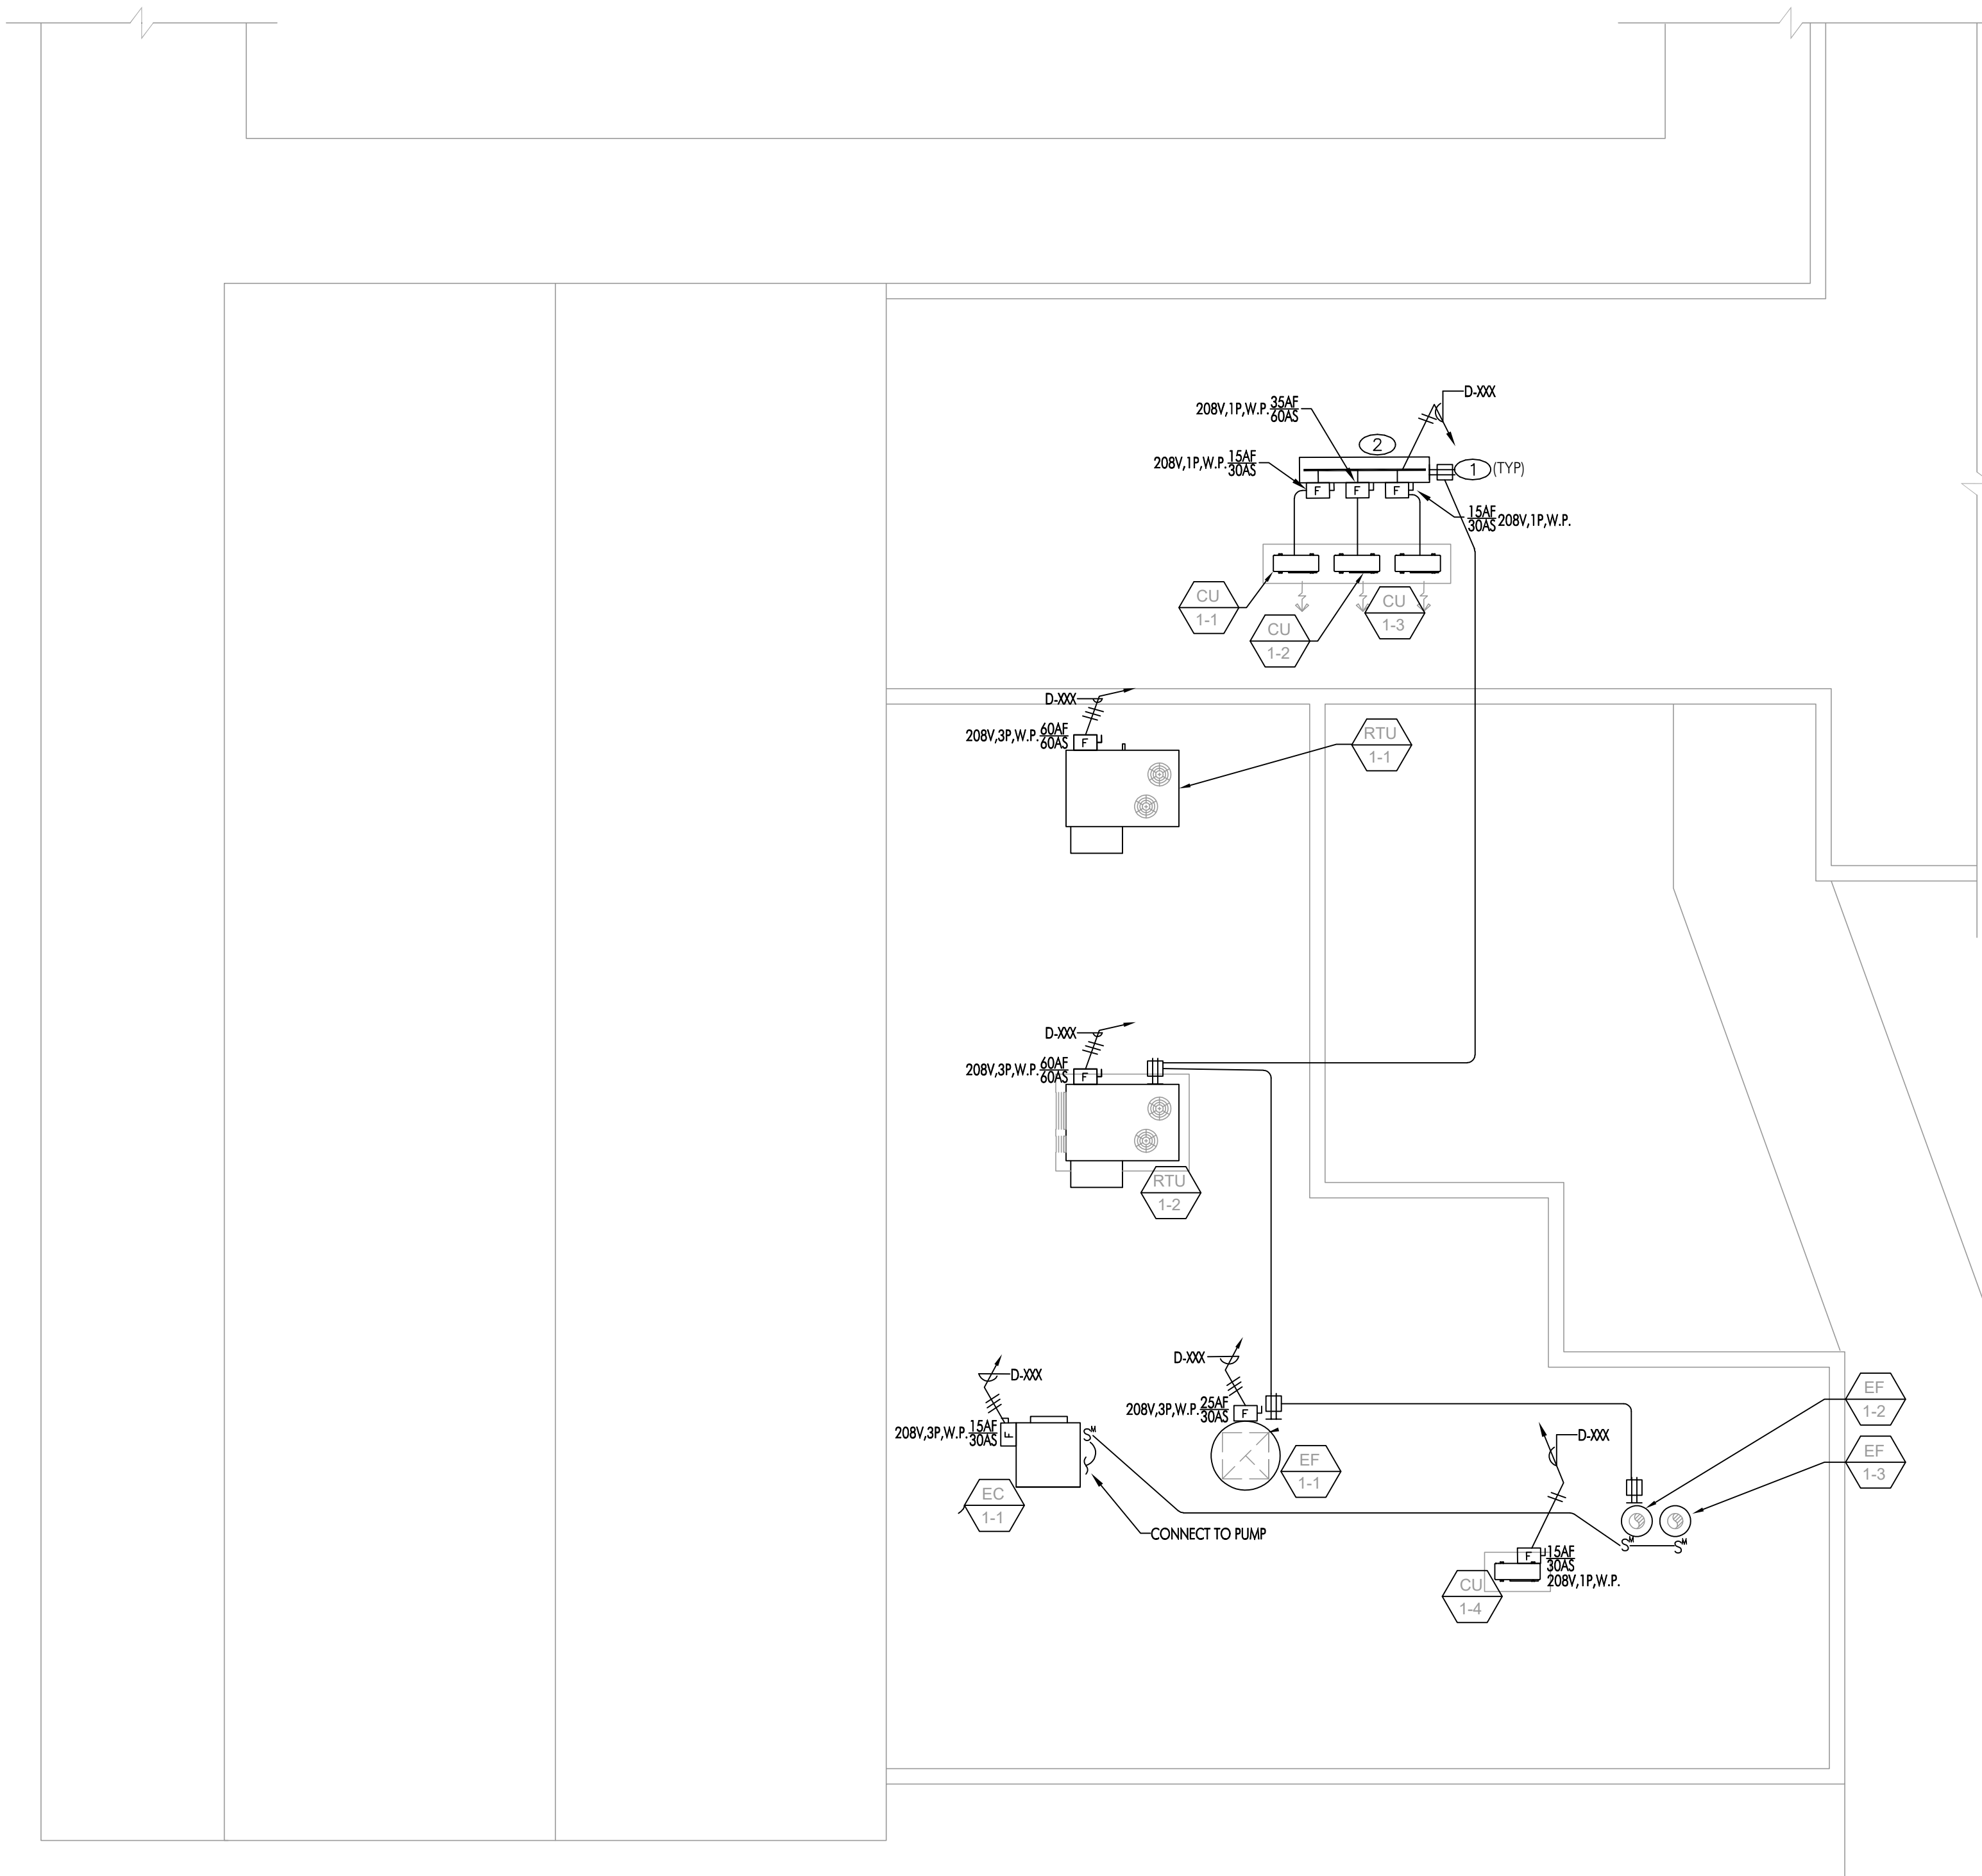
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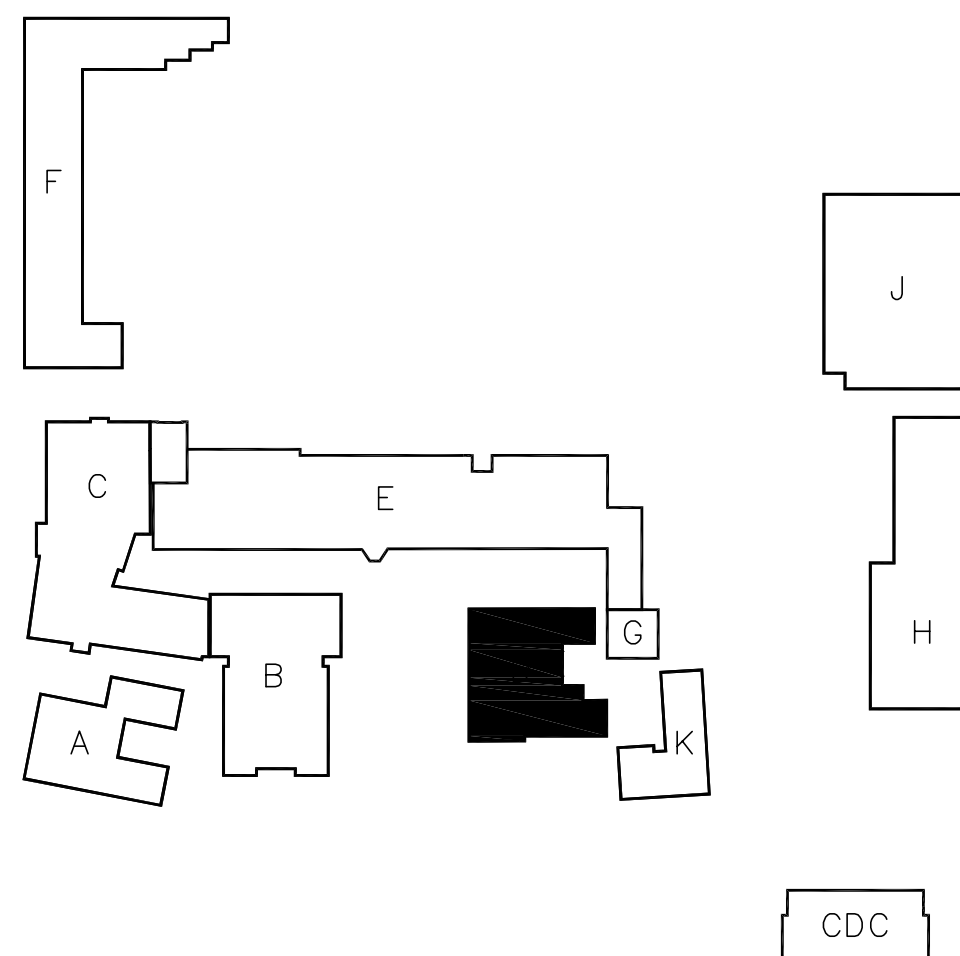
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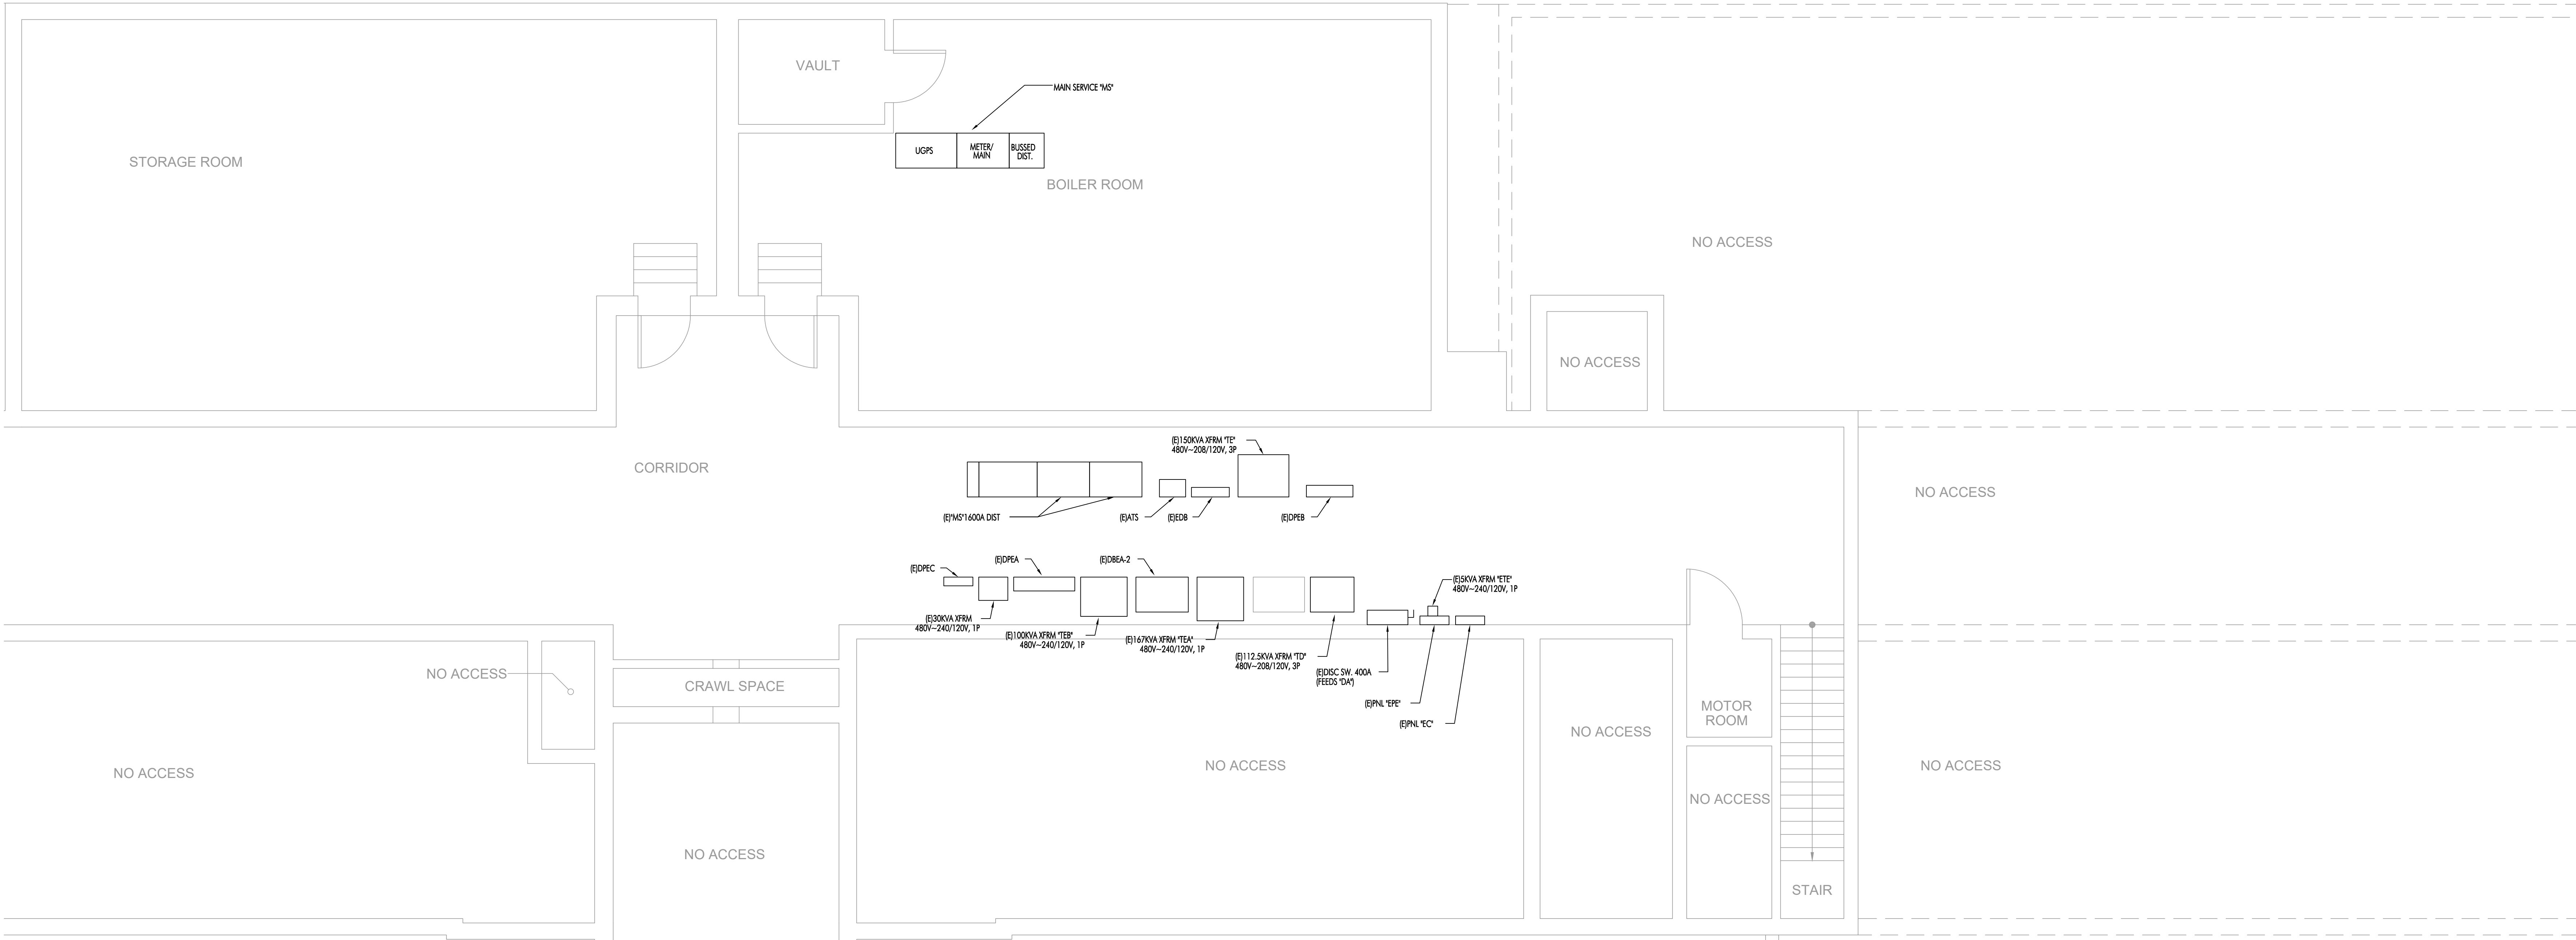
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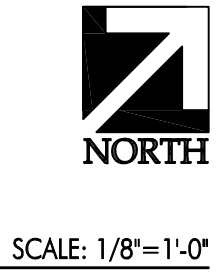
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KEY PLAN






1 FLOOR PLAN



SCALE: 1/8"=1'-0"

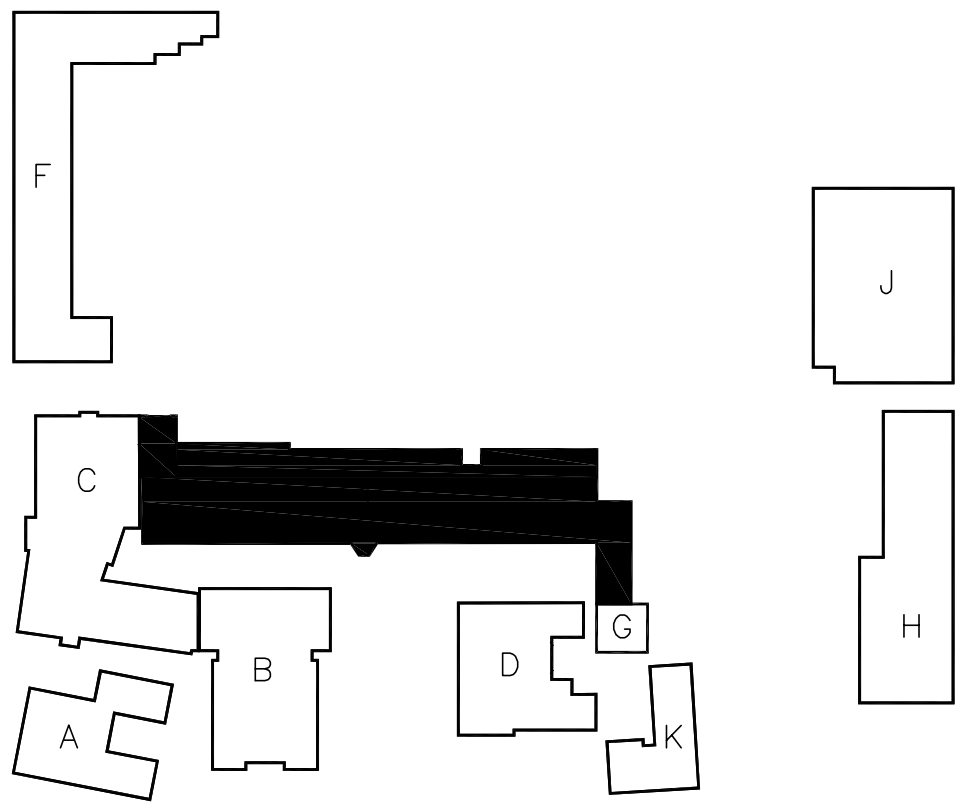

KEY PLAN

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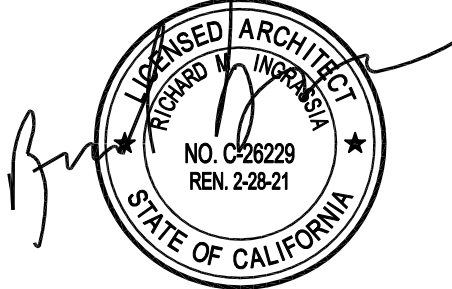
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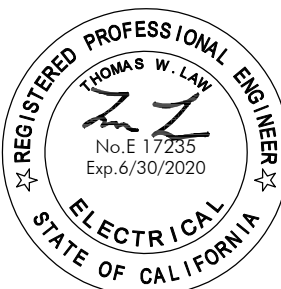
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Sheet Title
Building 'E'
Basement
Power Plan

Sheet Number

EE201

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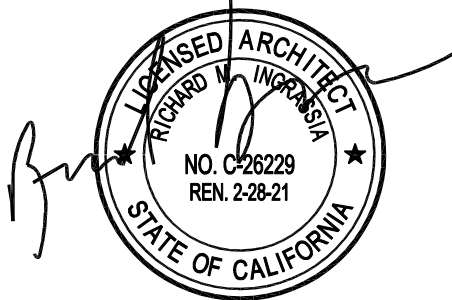
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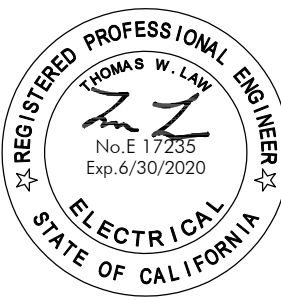
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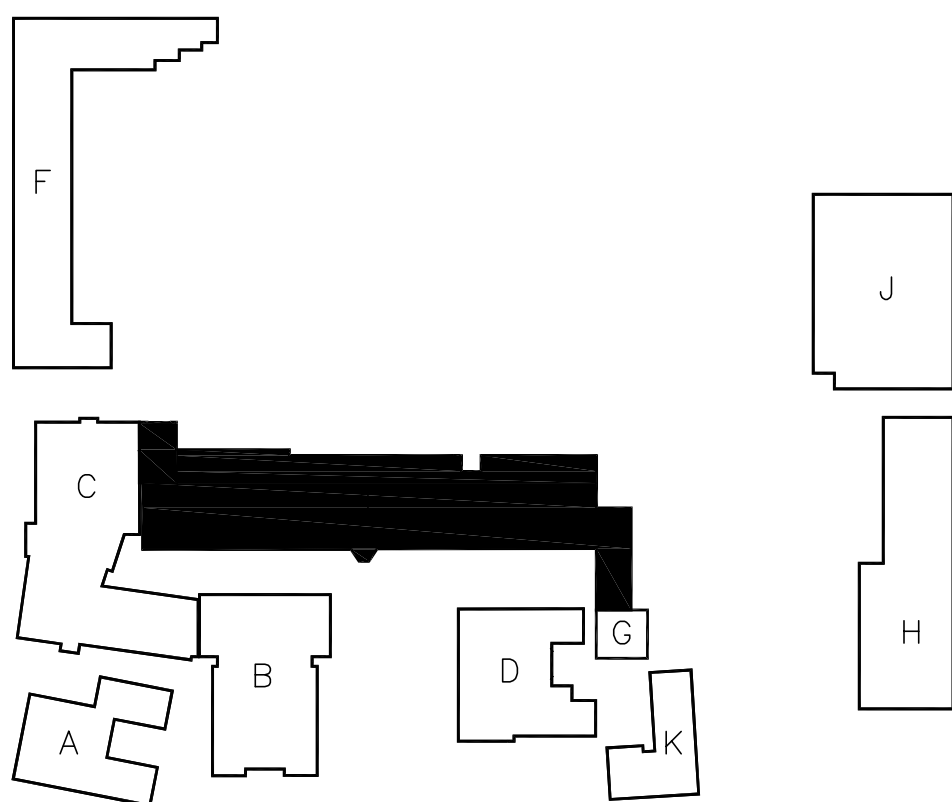
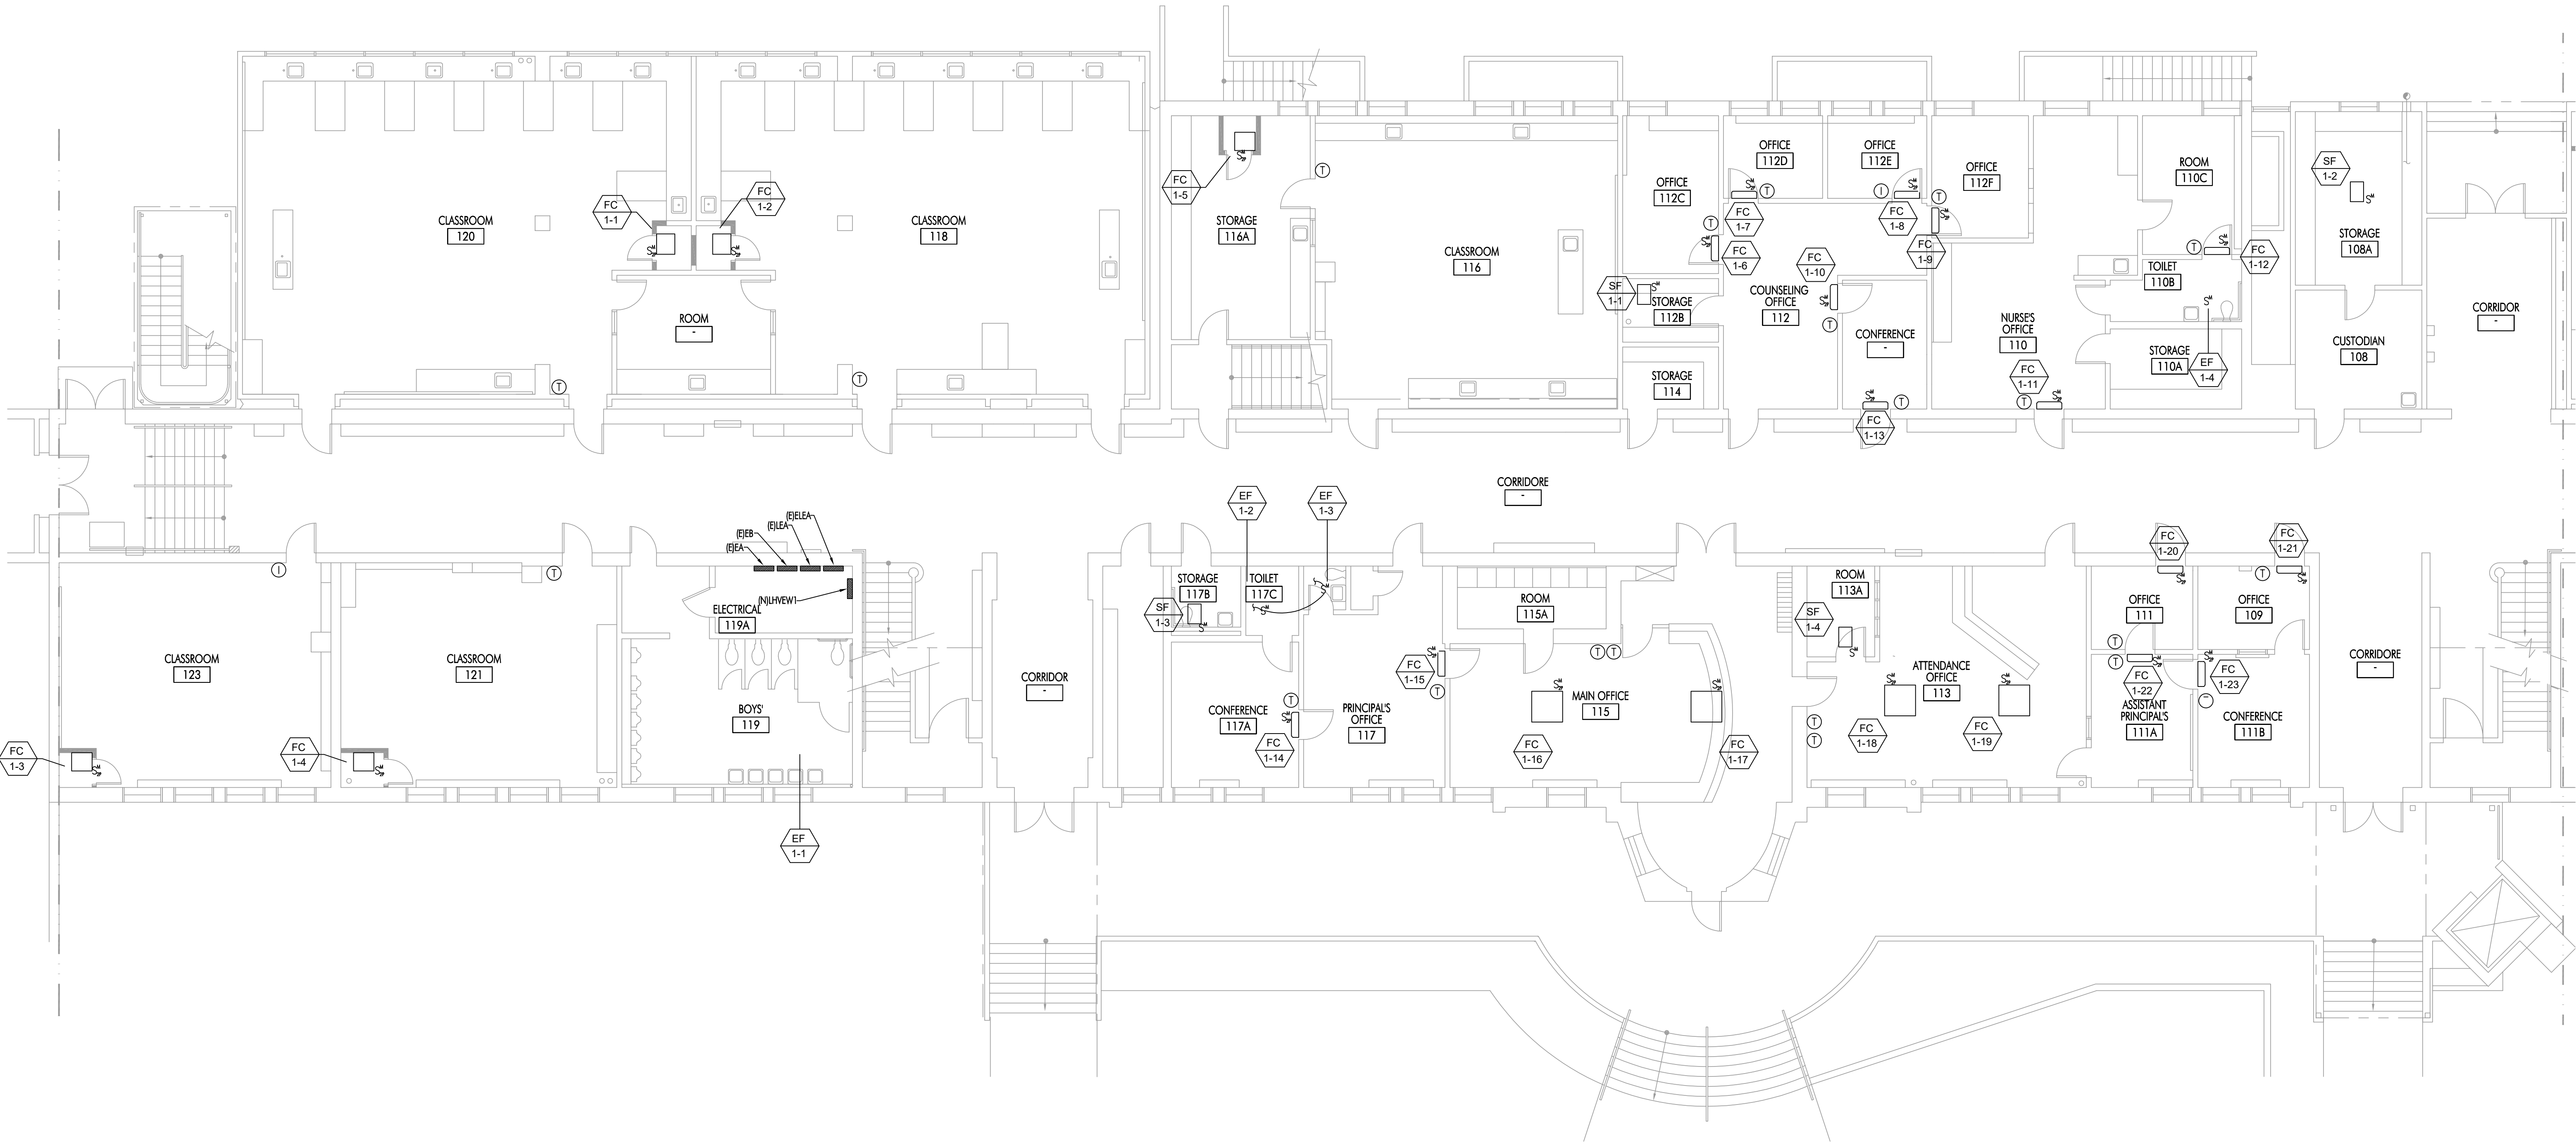
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Sheet Title
Building 'E' First
Floor Power Plan

Sheet Number

EE211A





KEY PLAN

CDC

1 FLOOR PLAN

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1 FLOOR PLAN

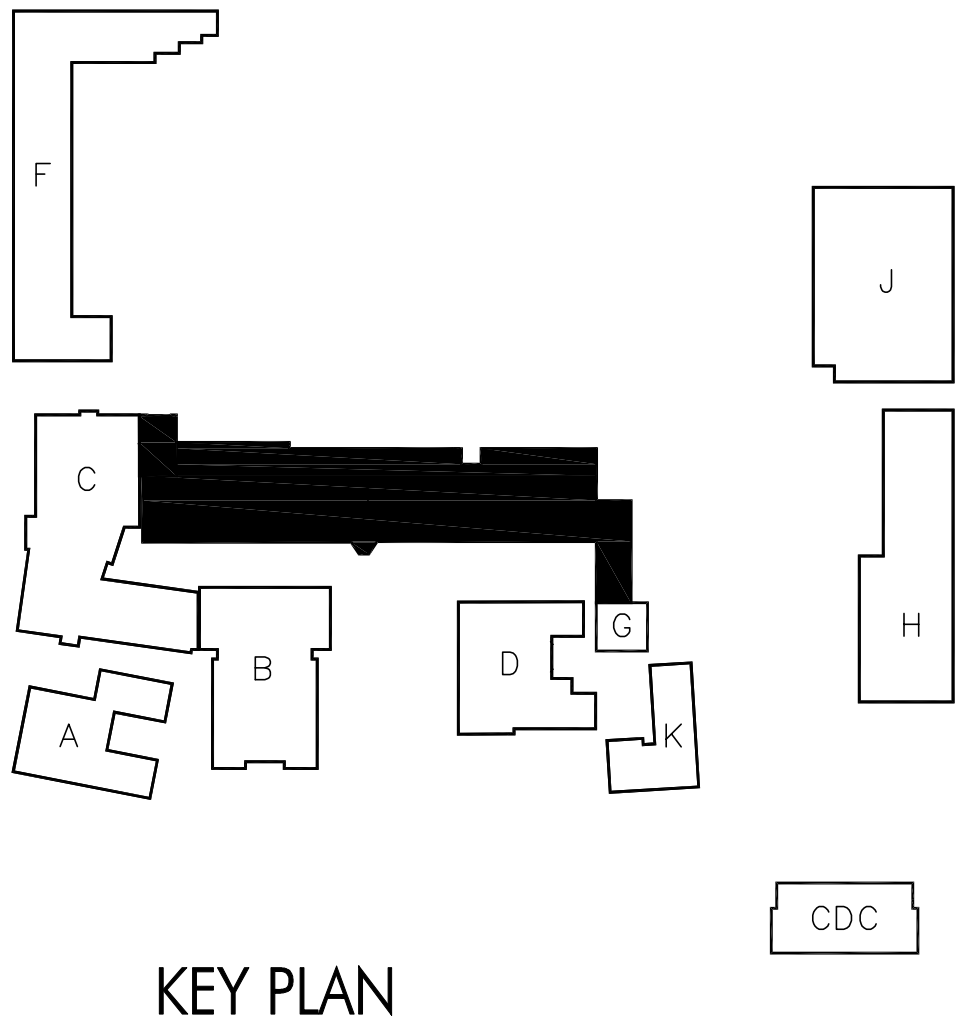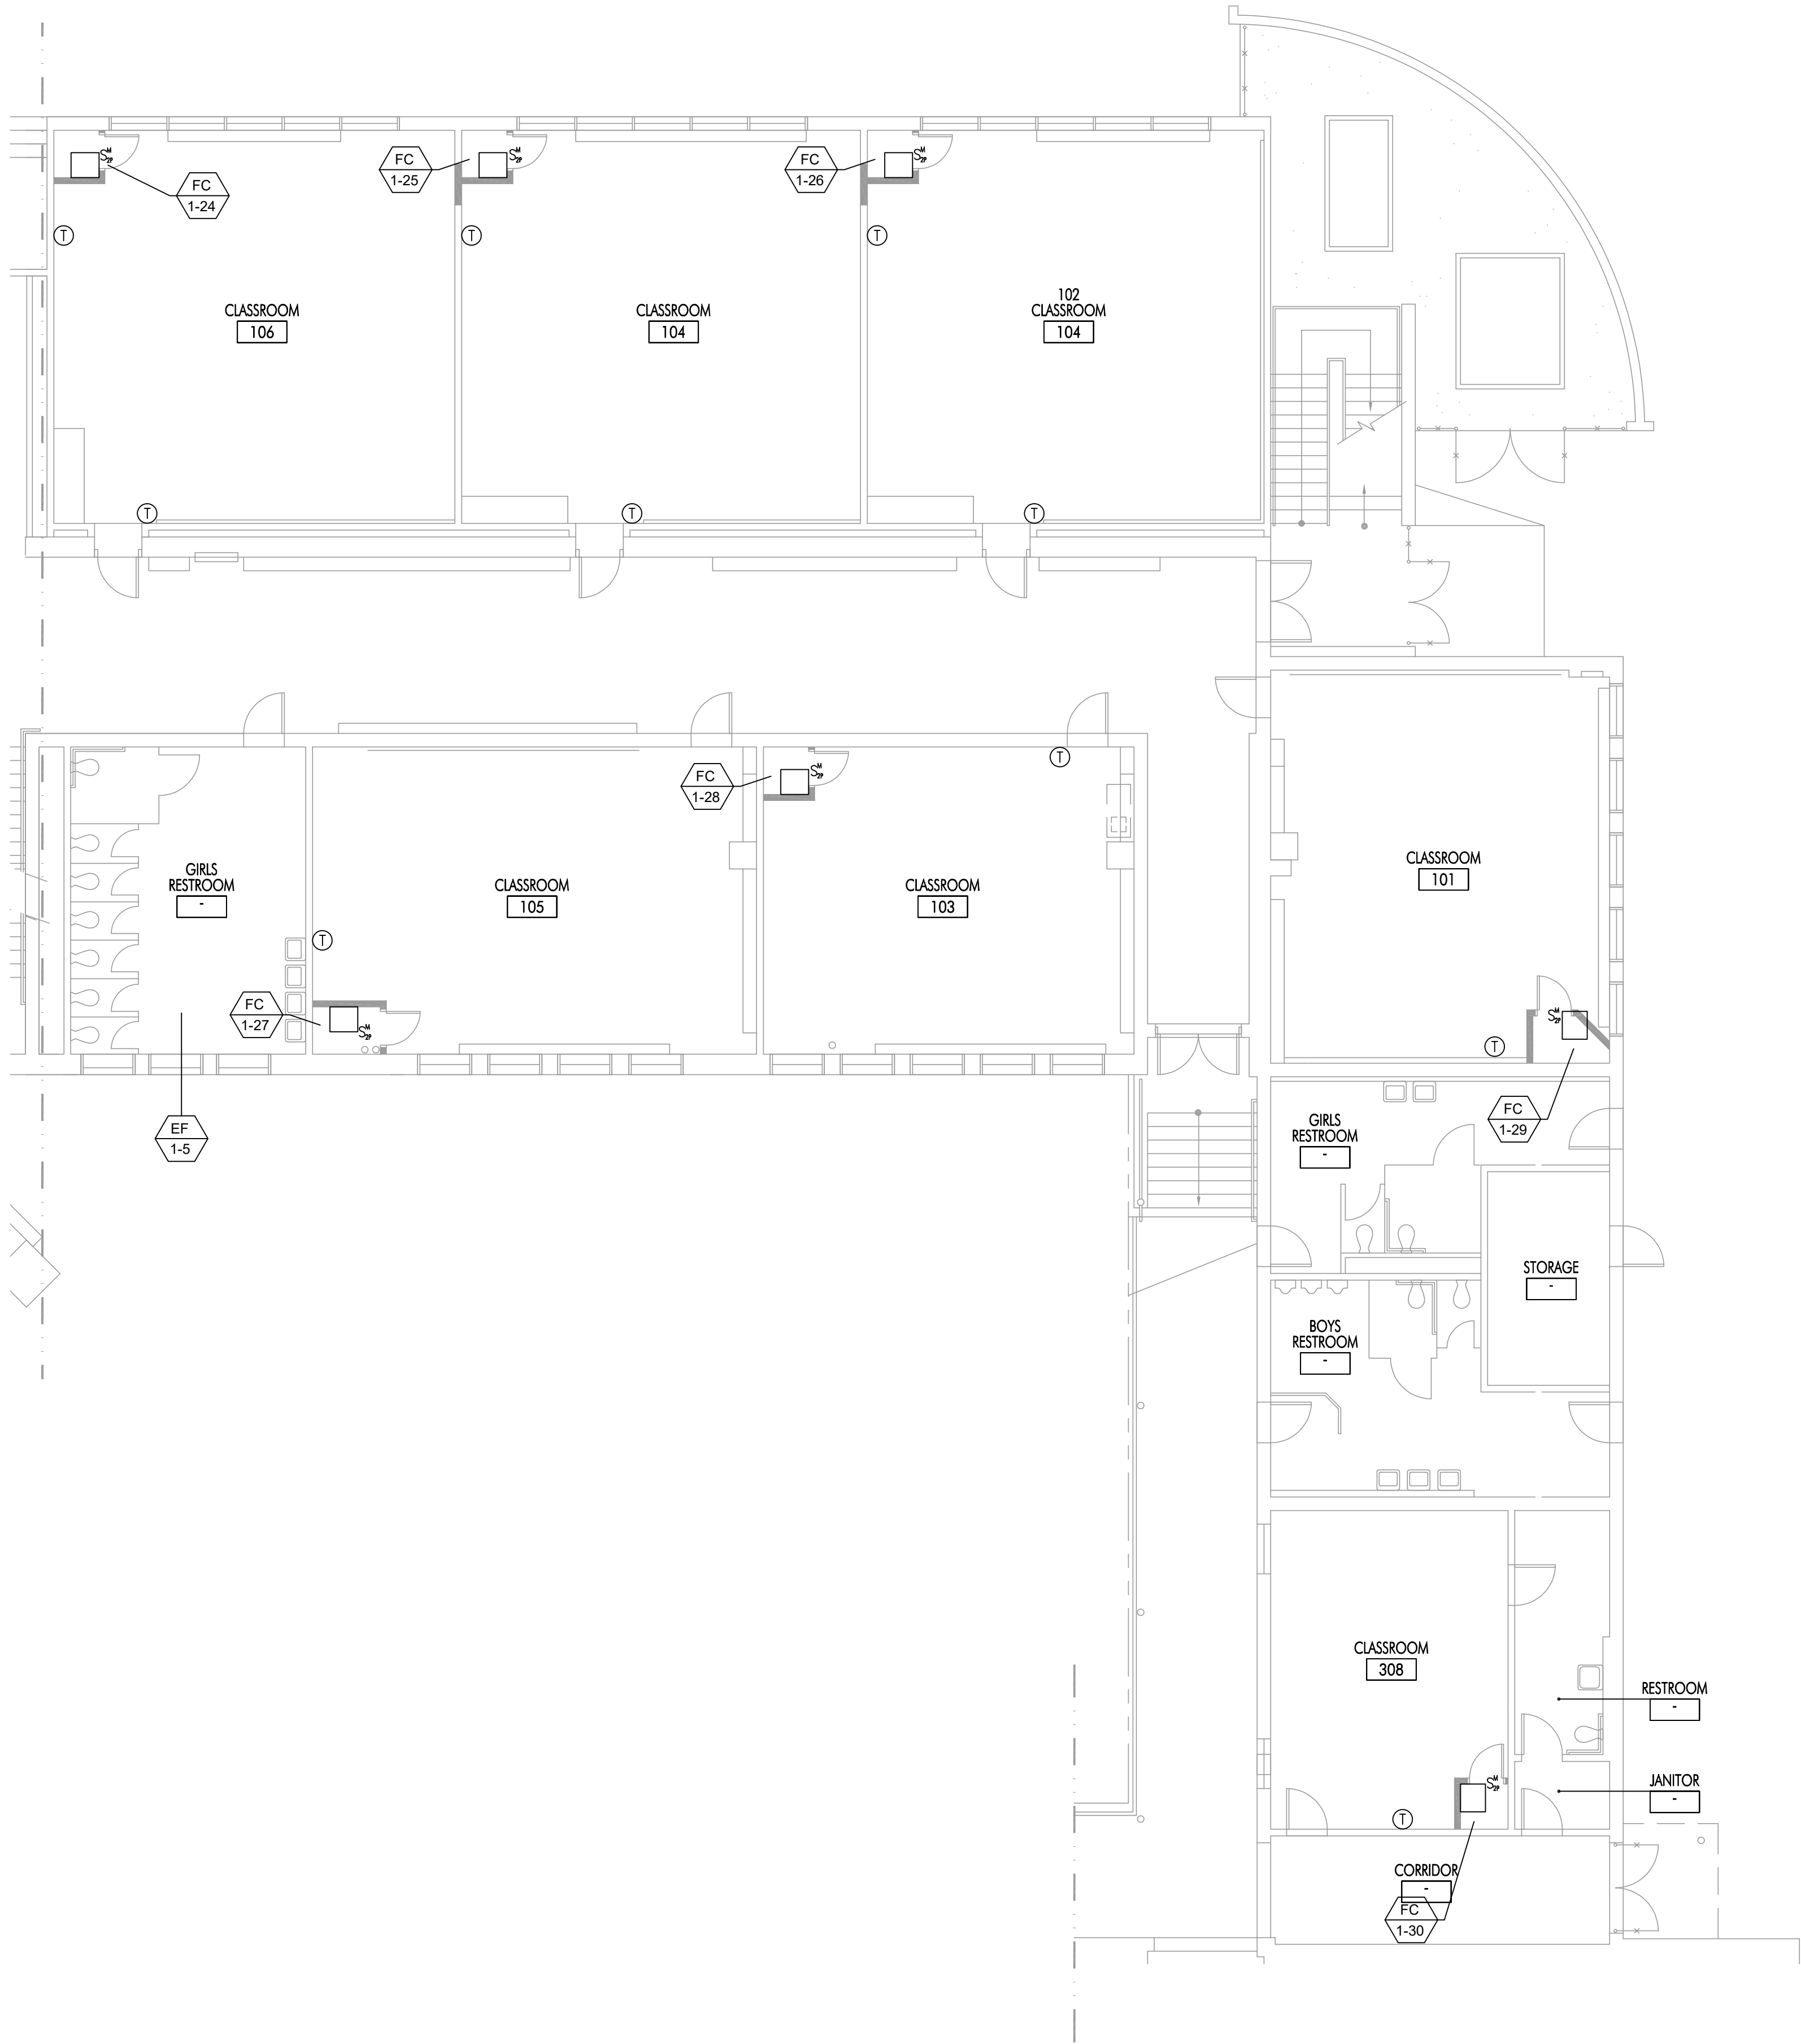

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Architect




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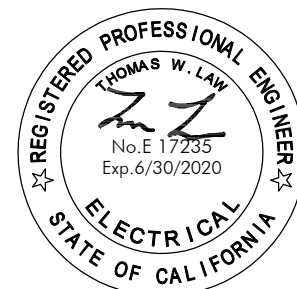
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Architect / Engineer Stamp



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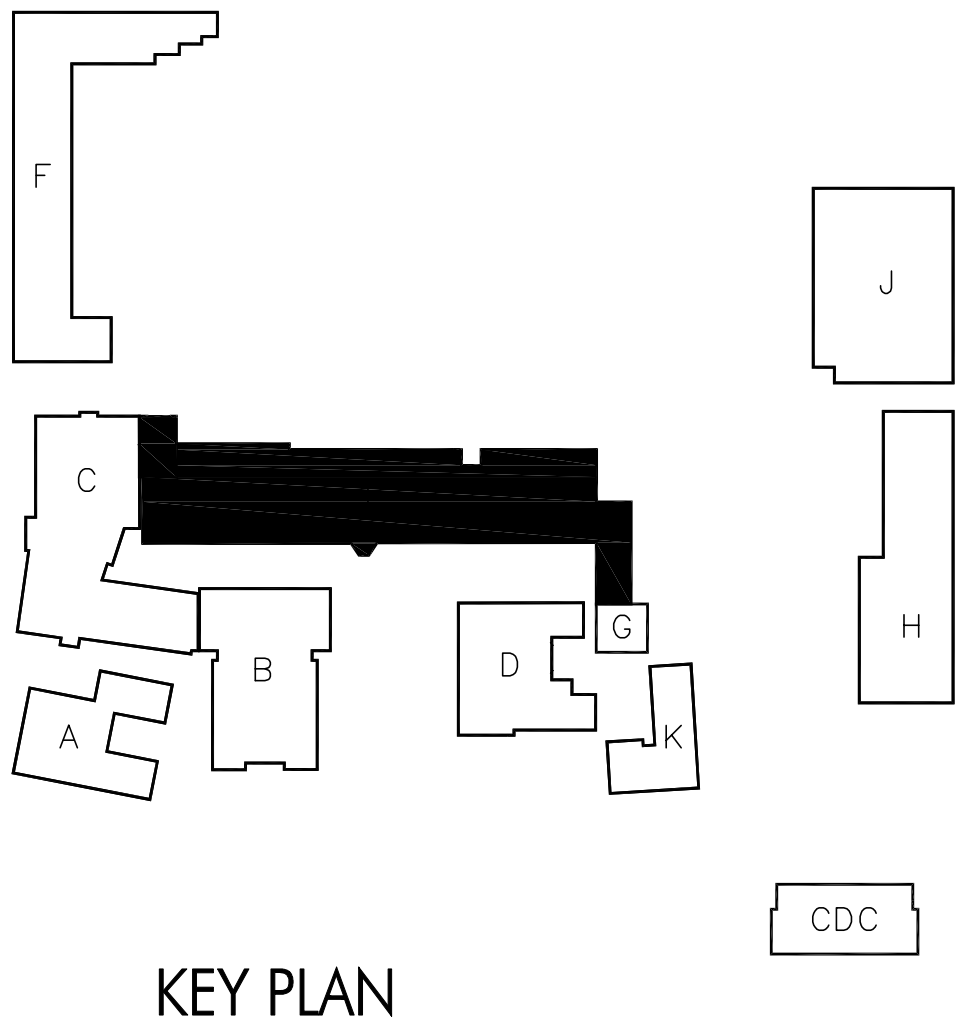
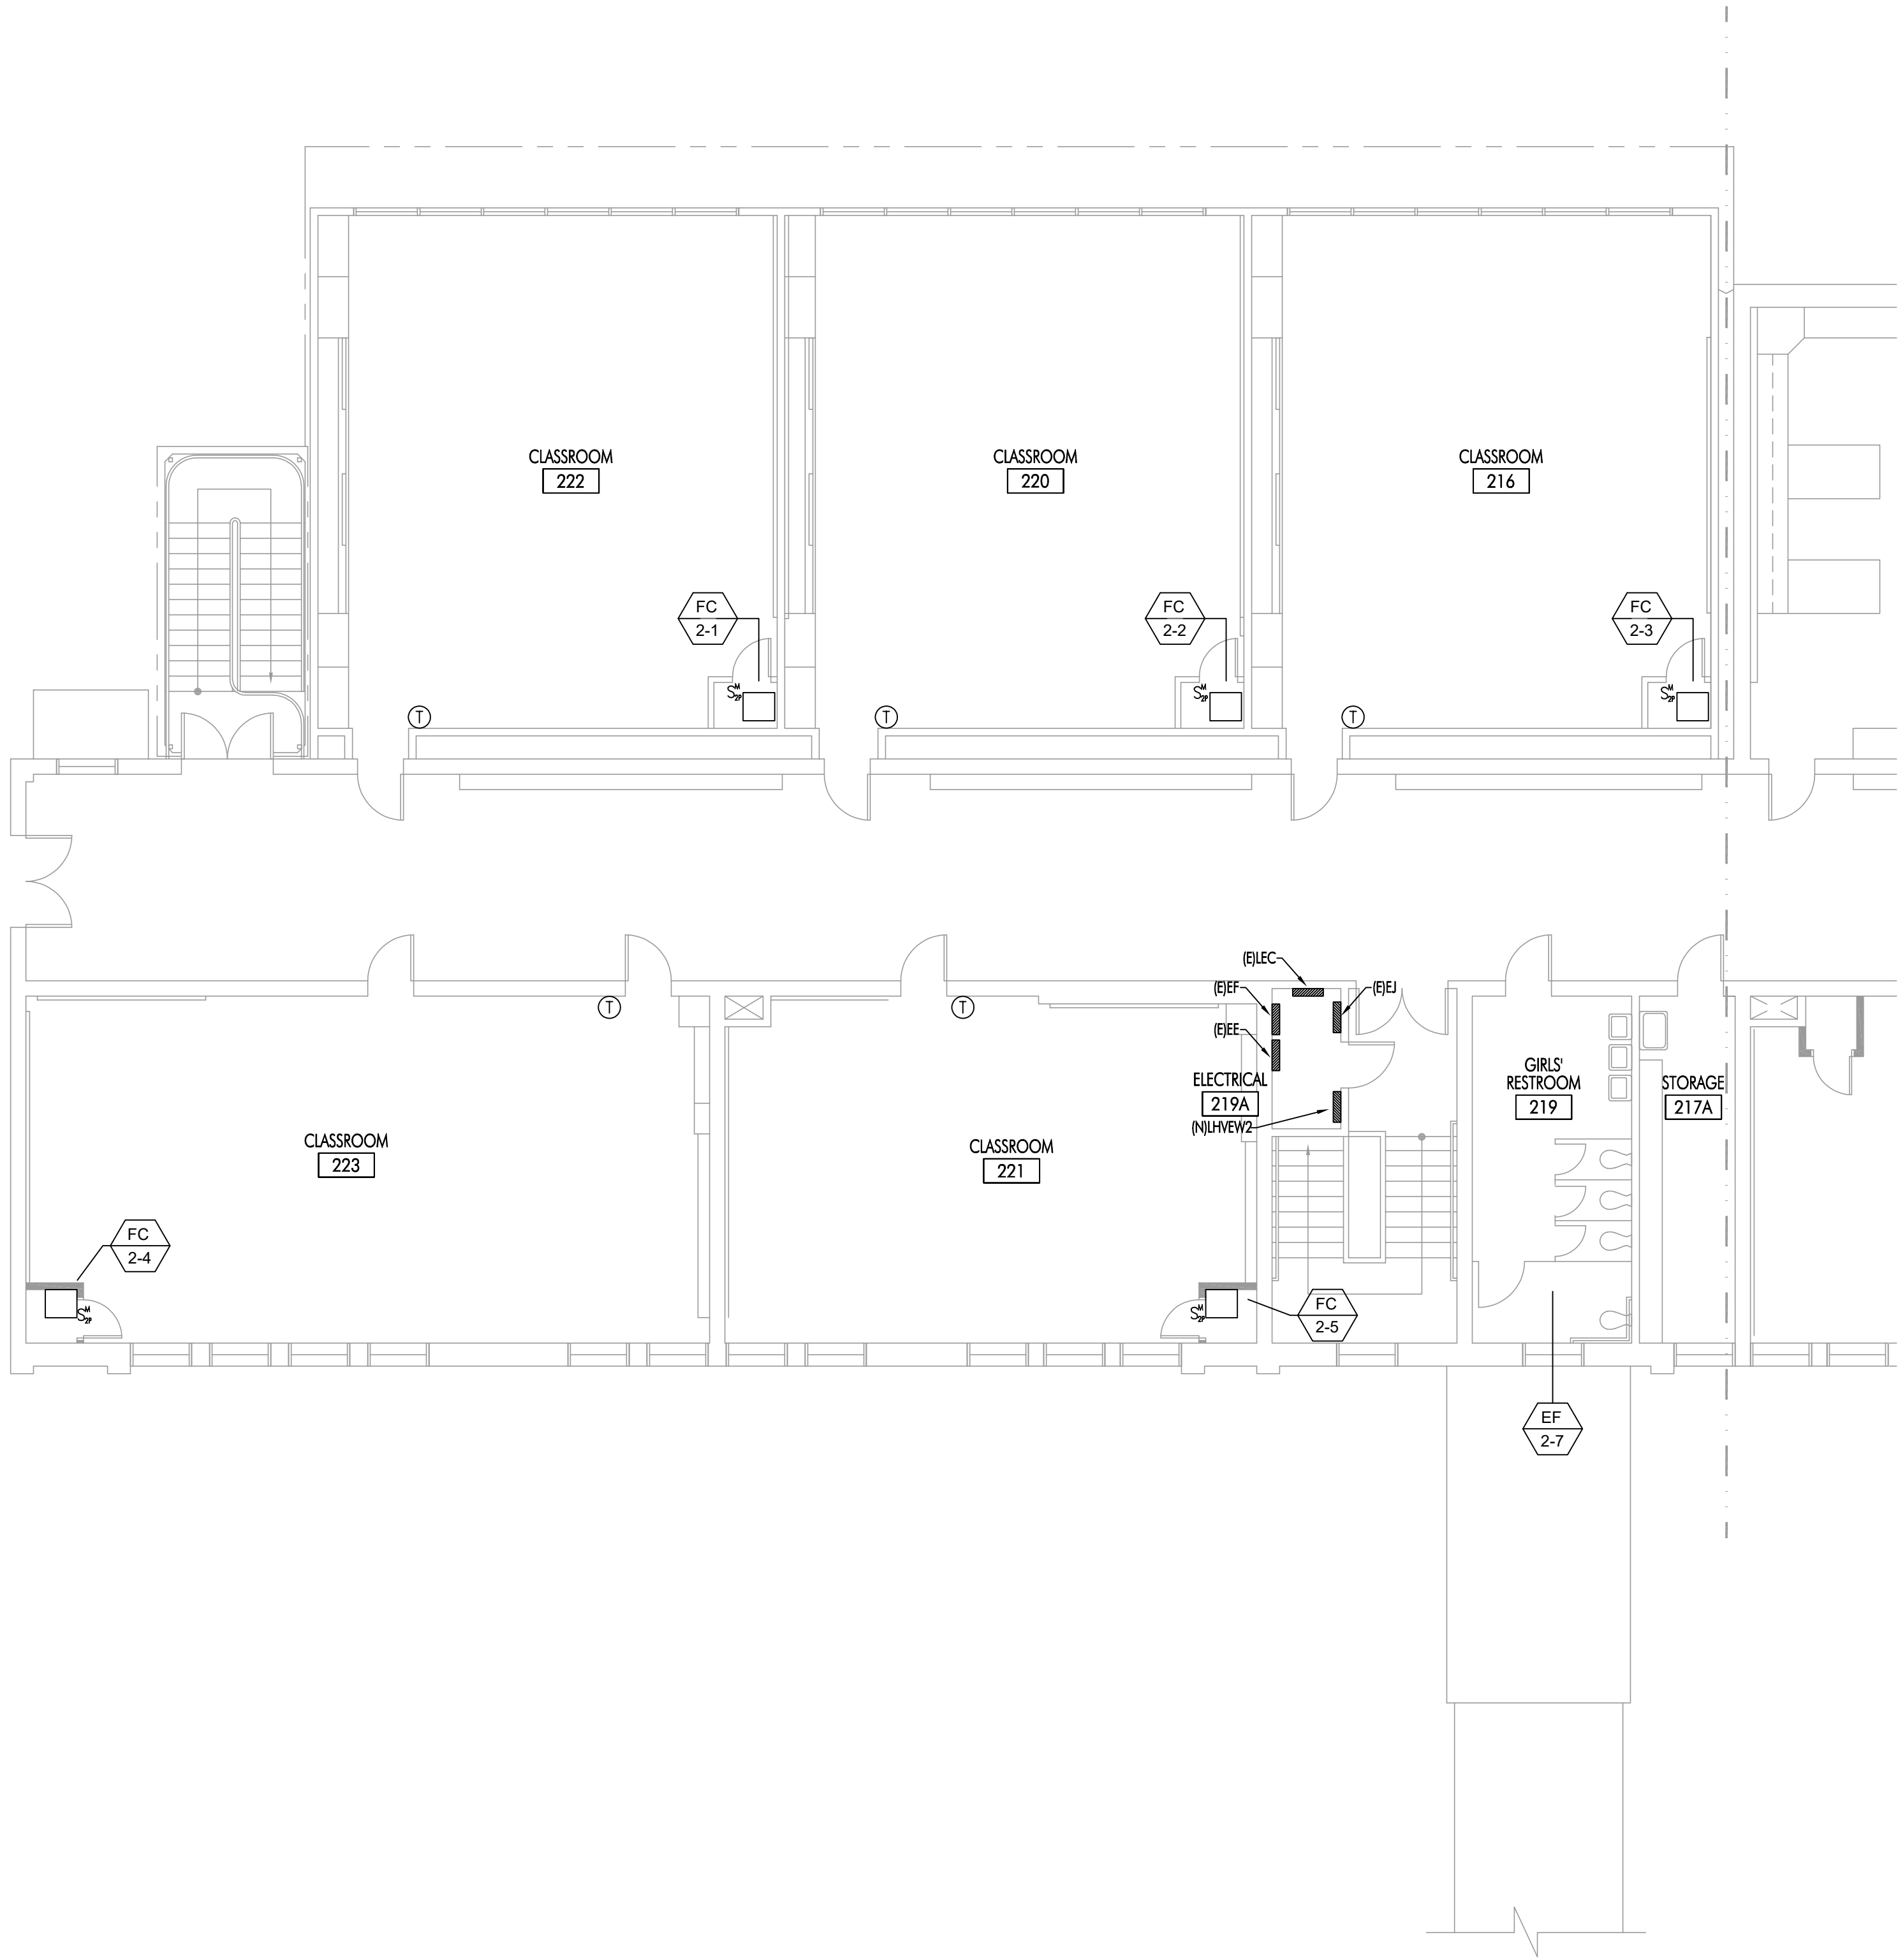
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Building 'E' First
Floor Power Plan

Sheet Number

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1 FLOOR PLAN

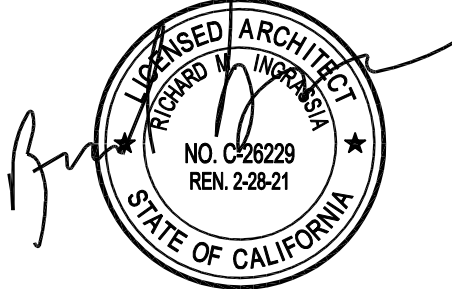

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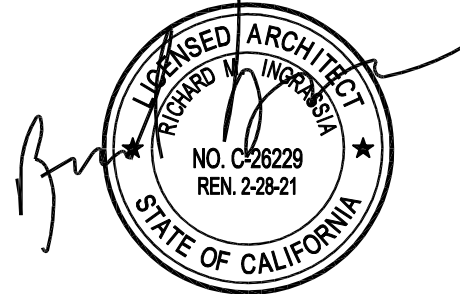
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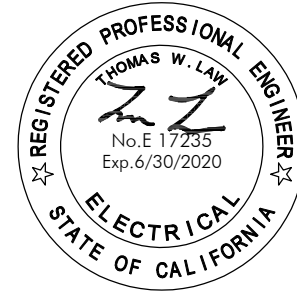
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Sheet Title
Building 'E' Second
Floor Power Plan

Sheet Number

EE212A

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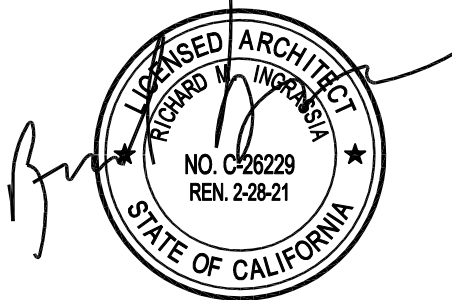
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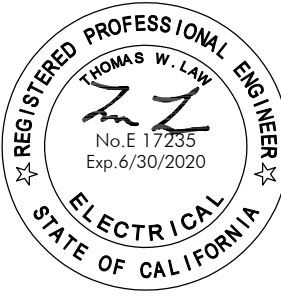
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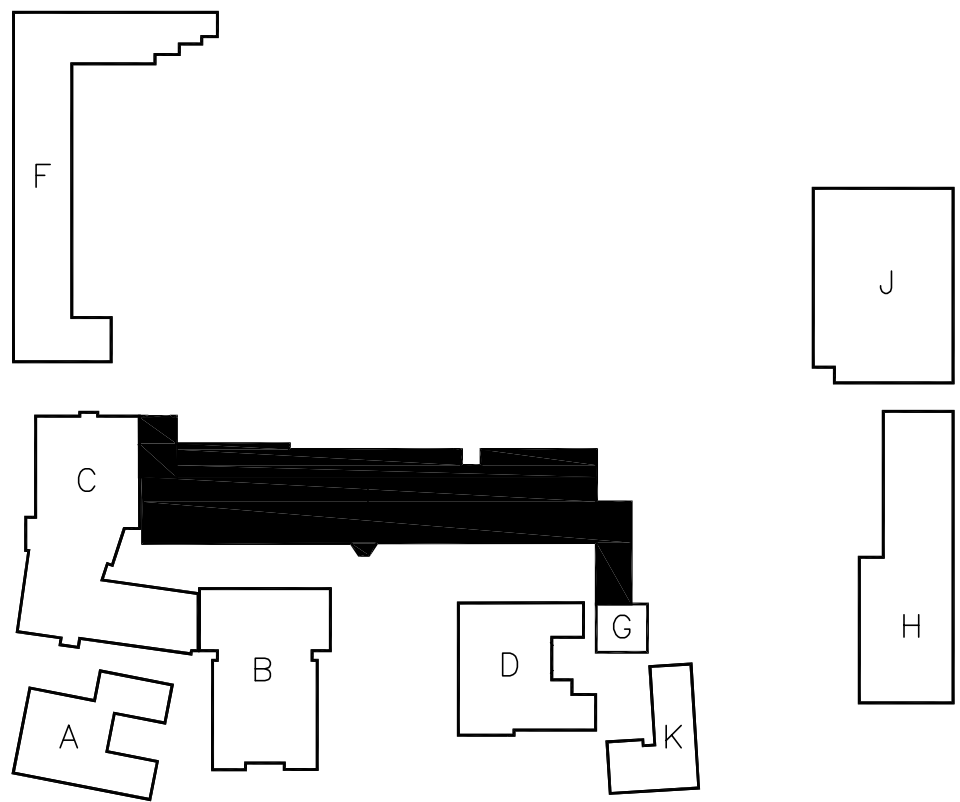
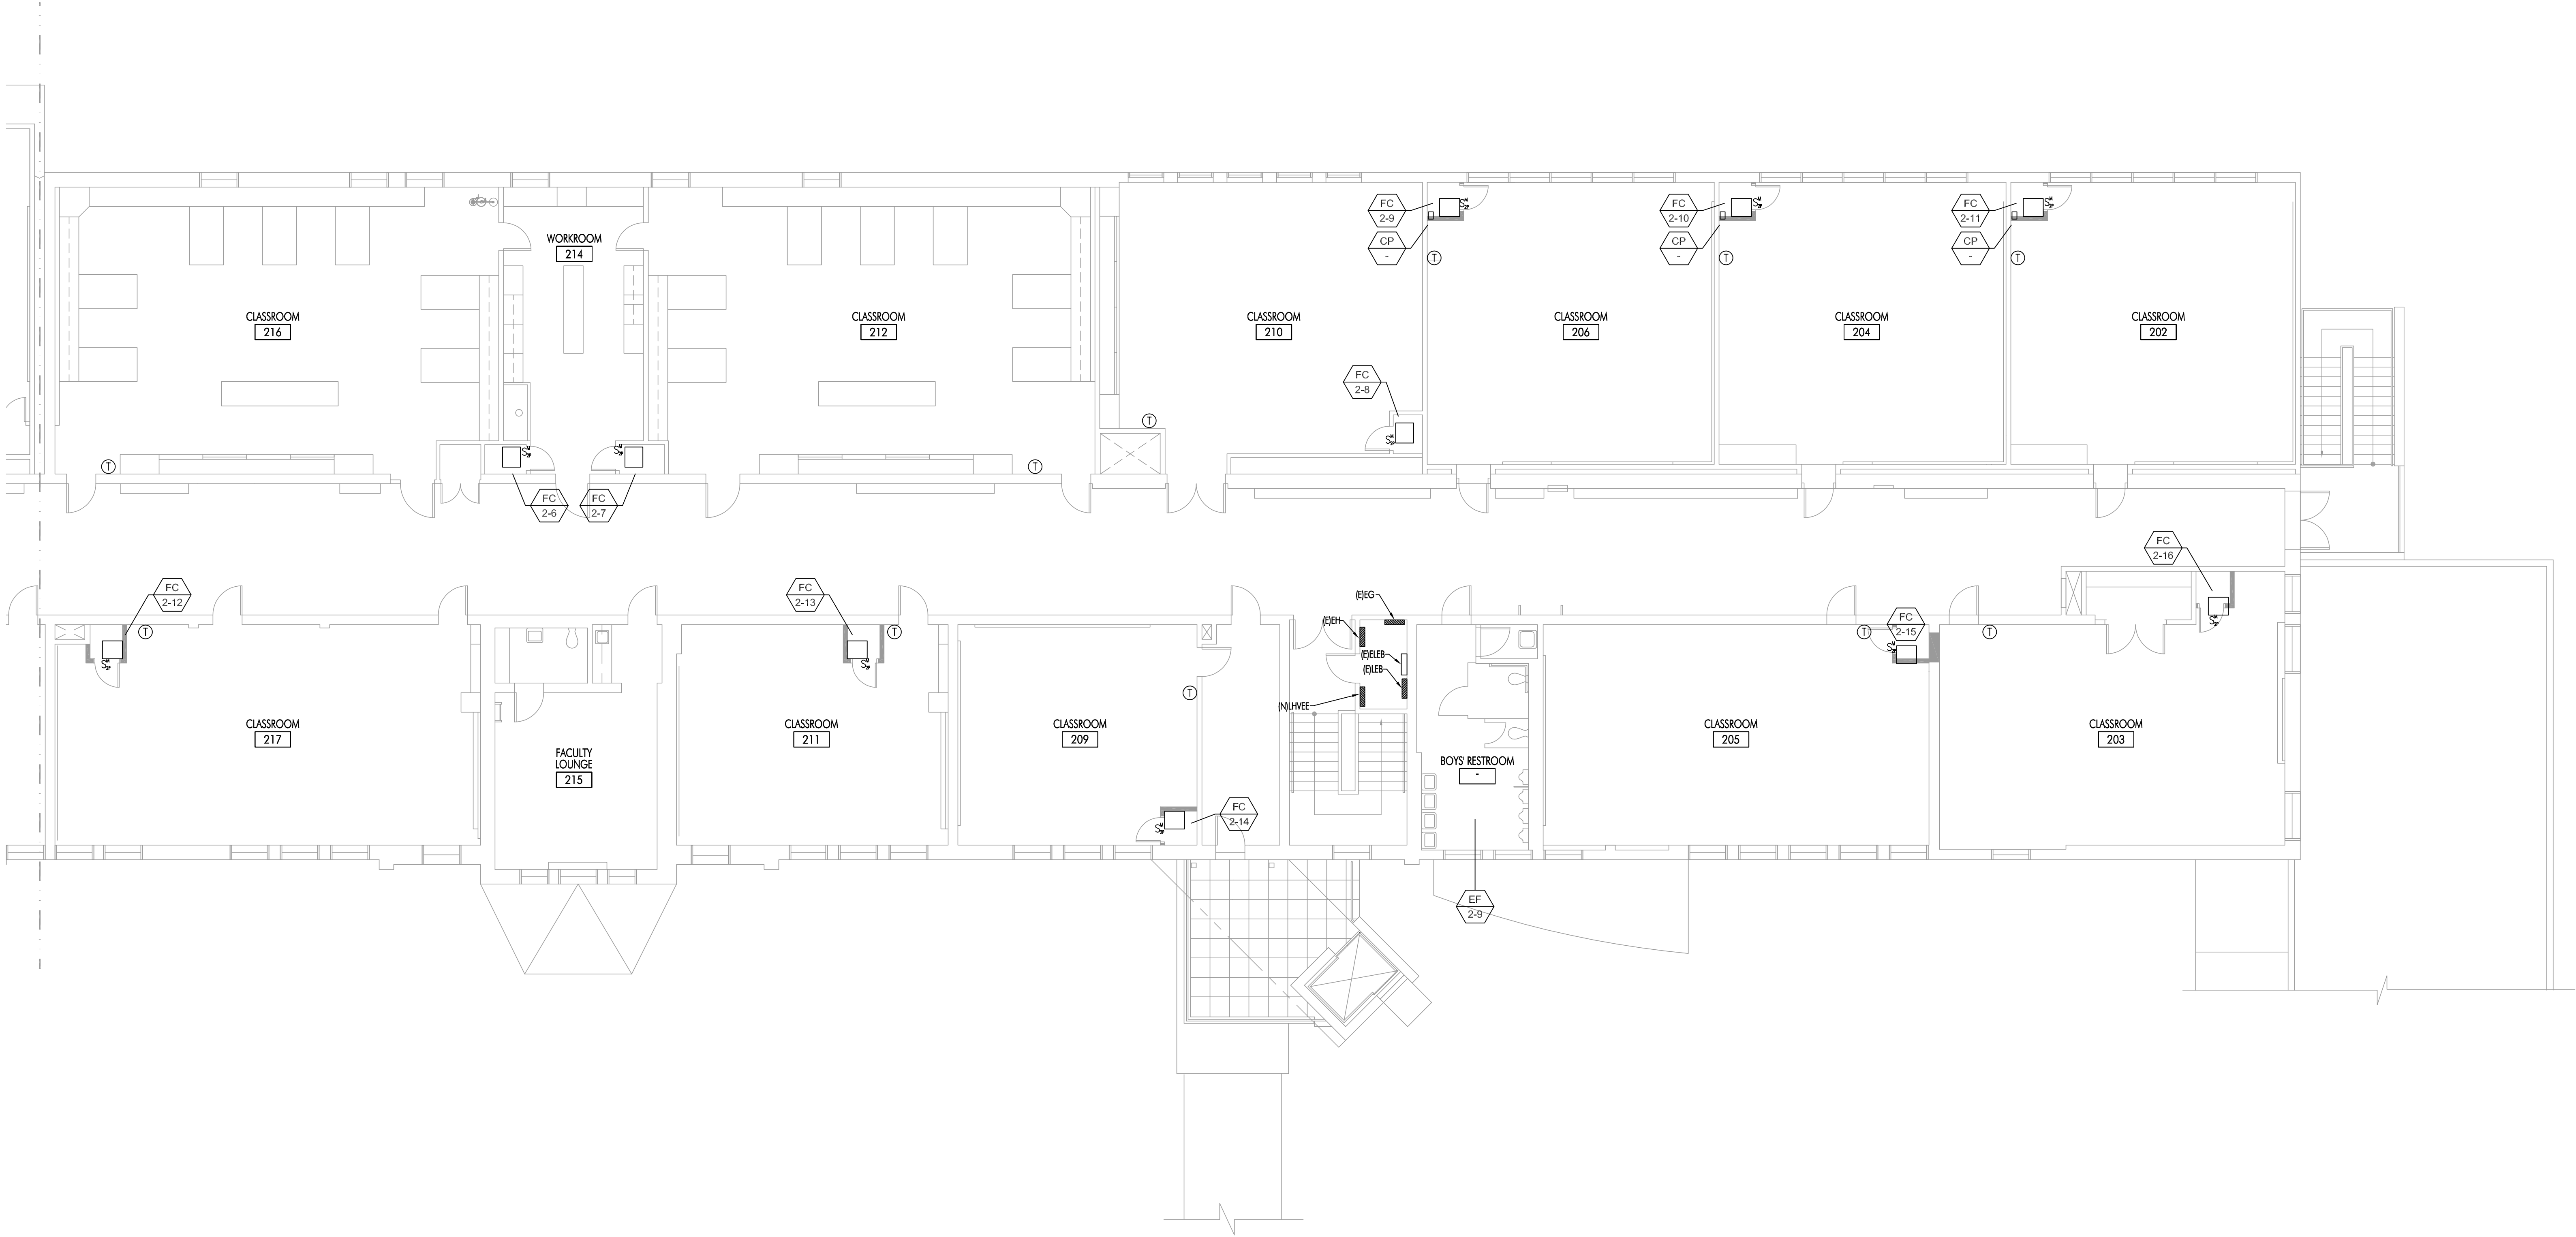
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Sheet Title
Building 'E' Second
Floor Power Plan

Sheet Number

EE212B



KEY PLAN

1 FLOOR PLAN

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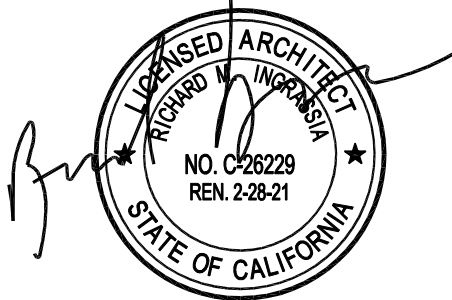
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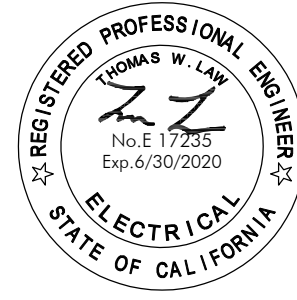
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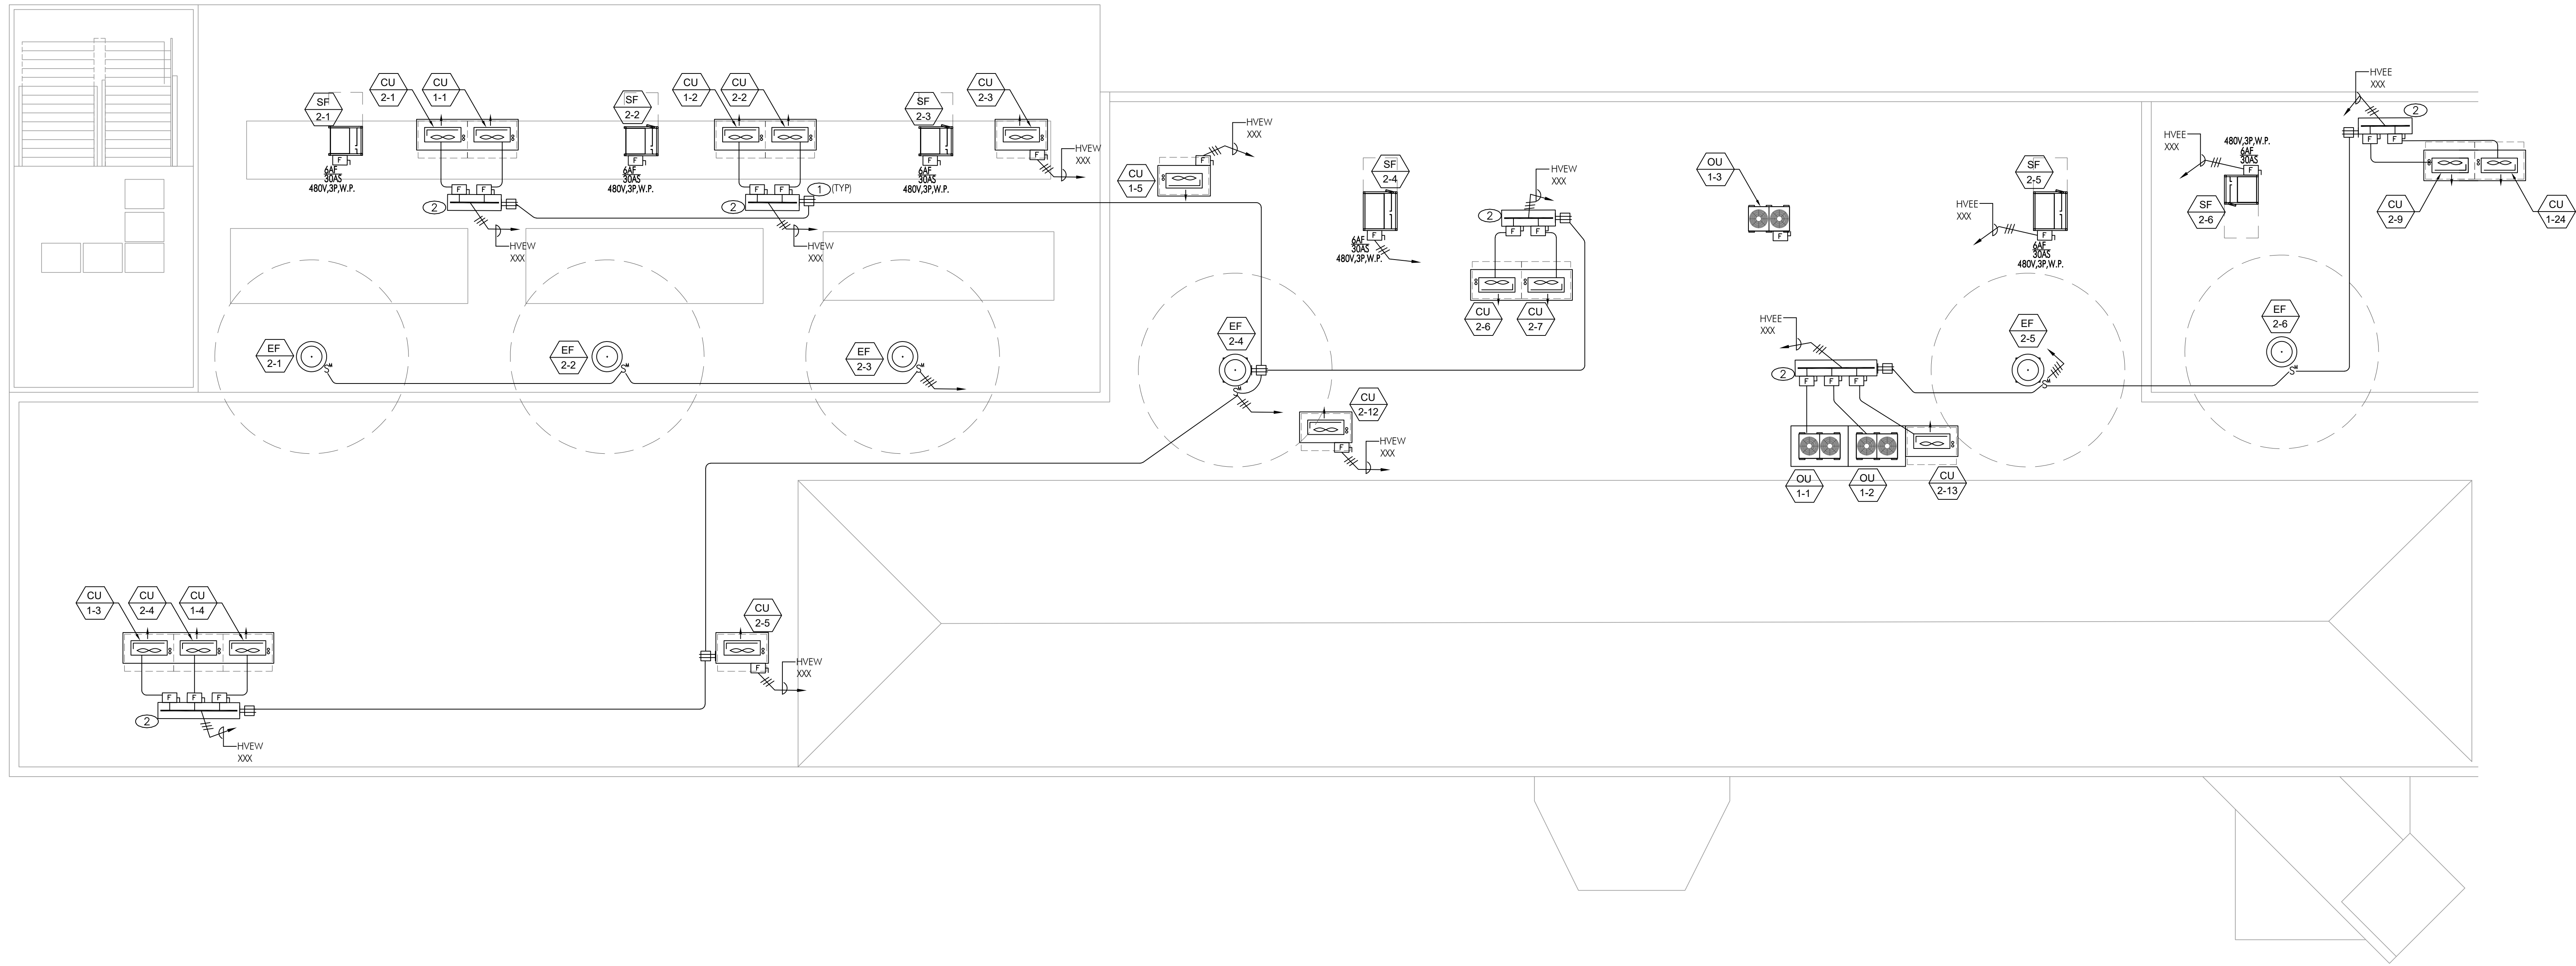
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Sheet Title
Building 'E' Second
Roof Power Plan

Sheet Number

EE241A



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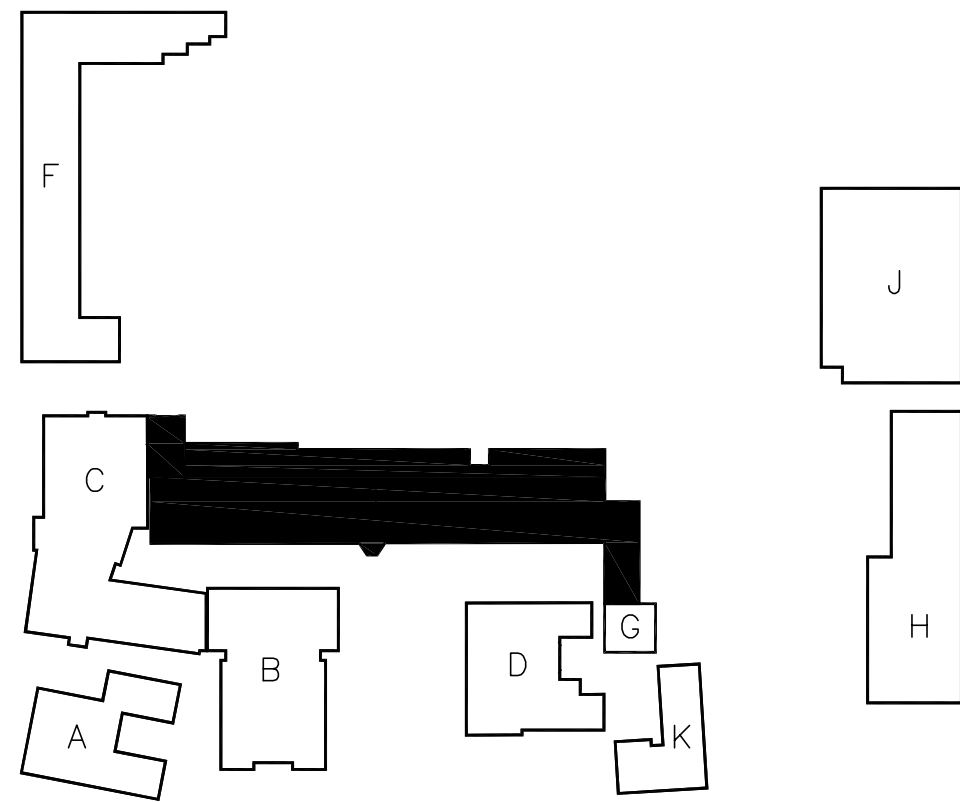
1 ROOF PLAN

GENERAL NOTES

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REFERENCE NOTES

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- W.P. WIREWAY 6"x6" LENGTH AS REQUIRED (MIN.). MOUNT WIREWAY + 18" AFF WITH GALVANIZED UNISTRUT SUPPORTS. W.P. FUSIBLE DISCONNECTS MOUNTED TO UNISTRUT SUPPORT.



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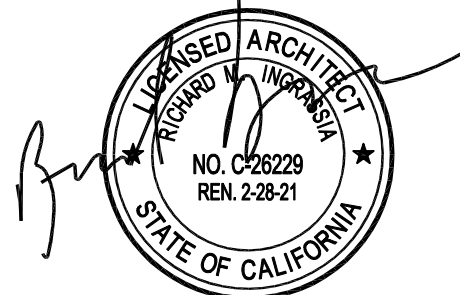
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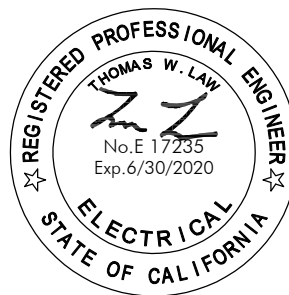
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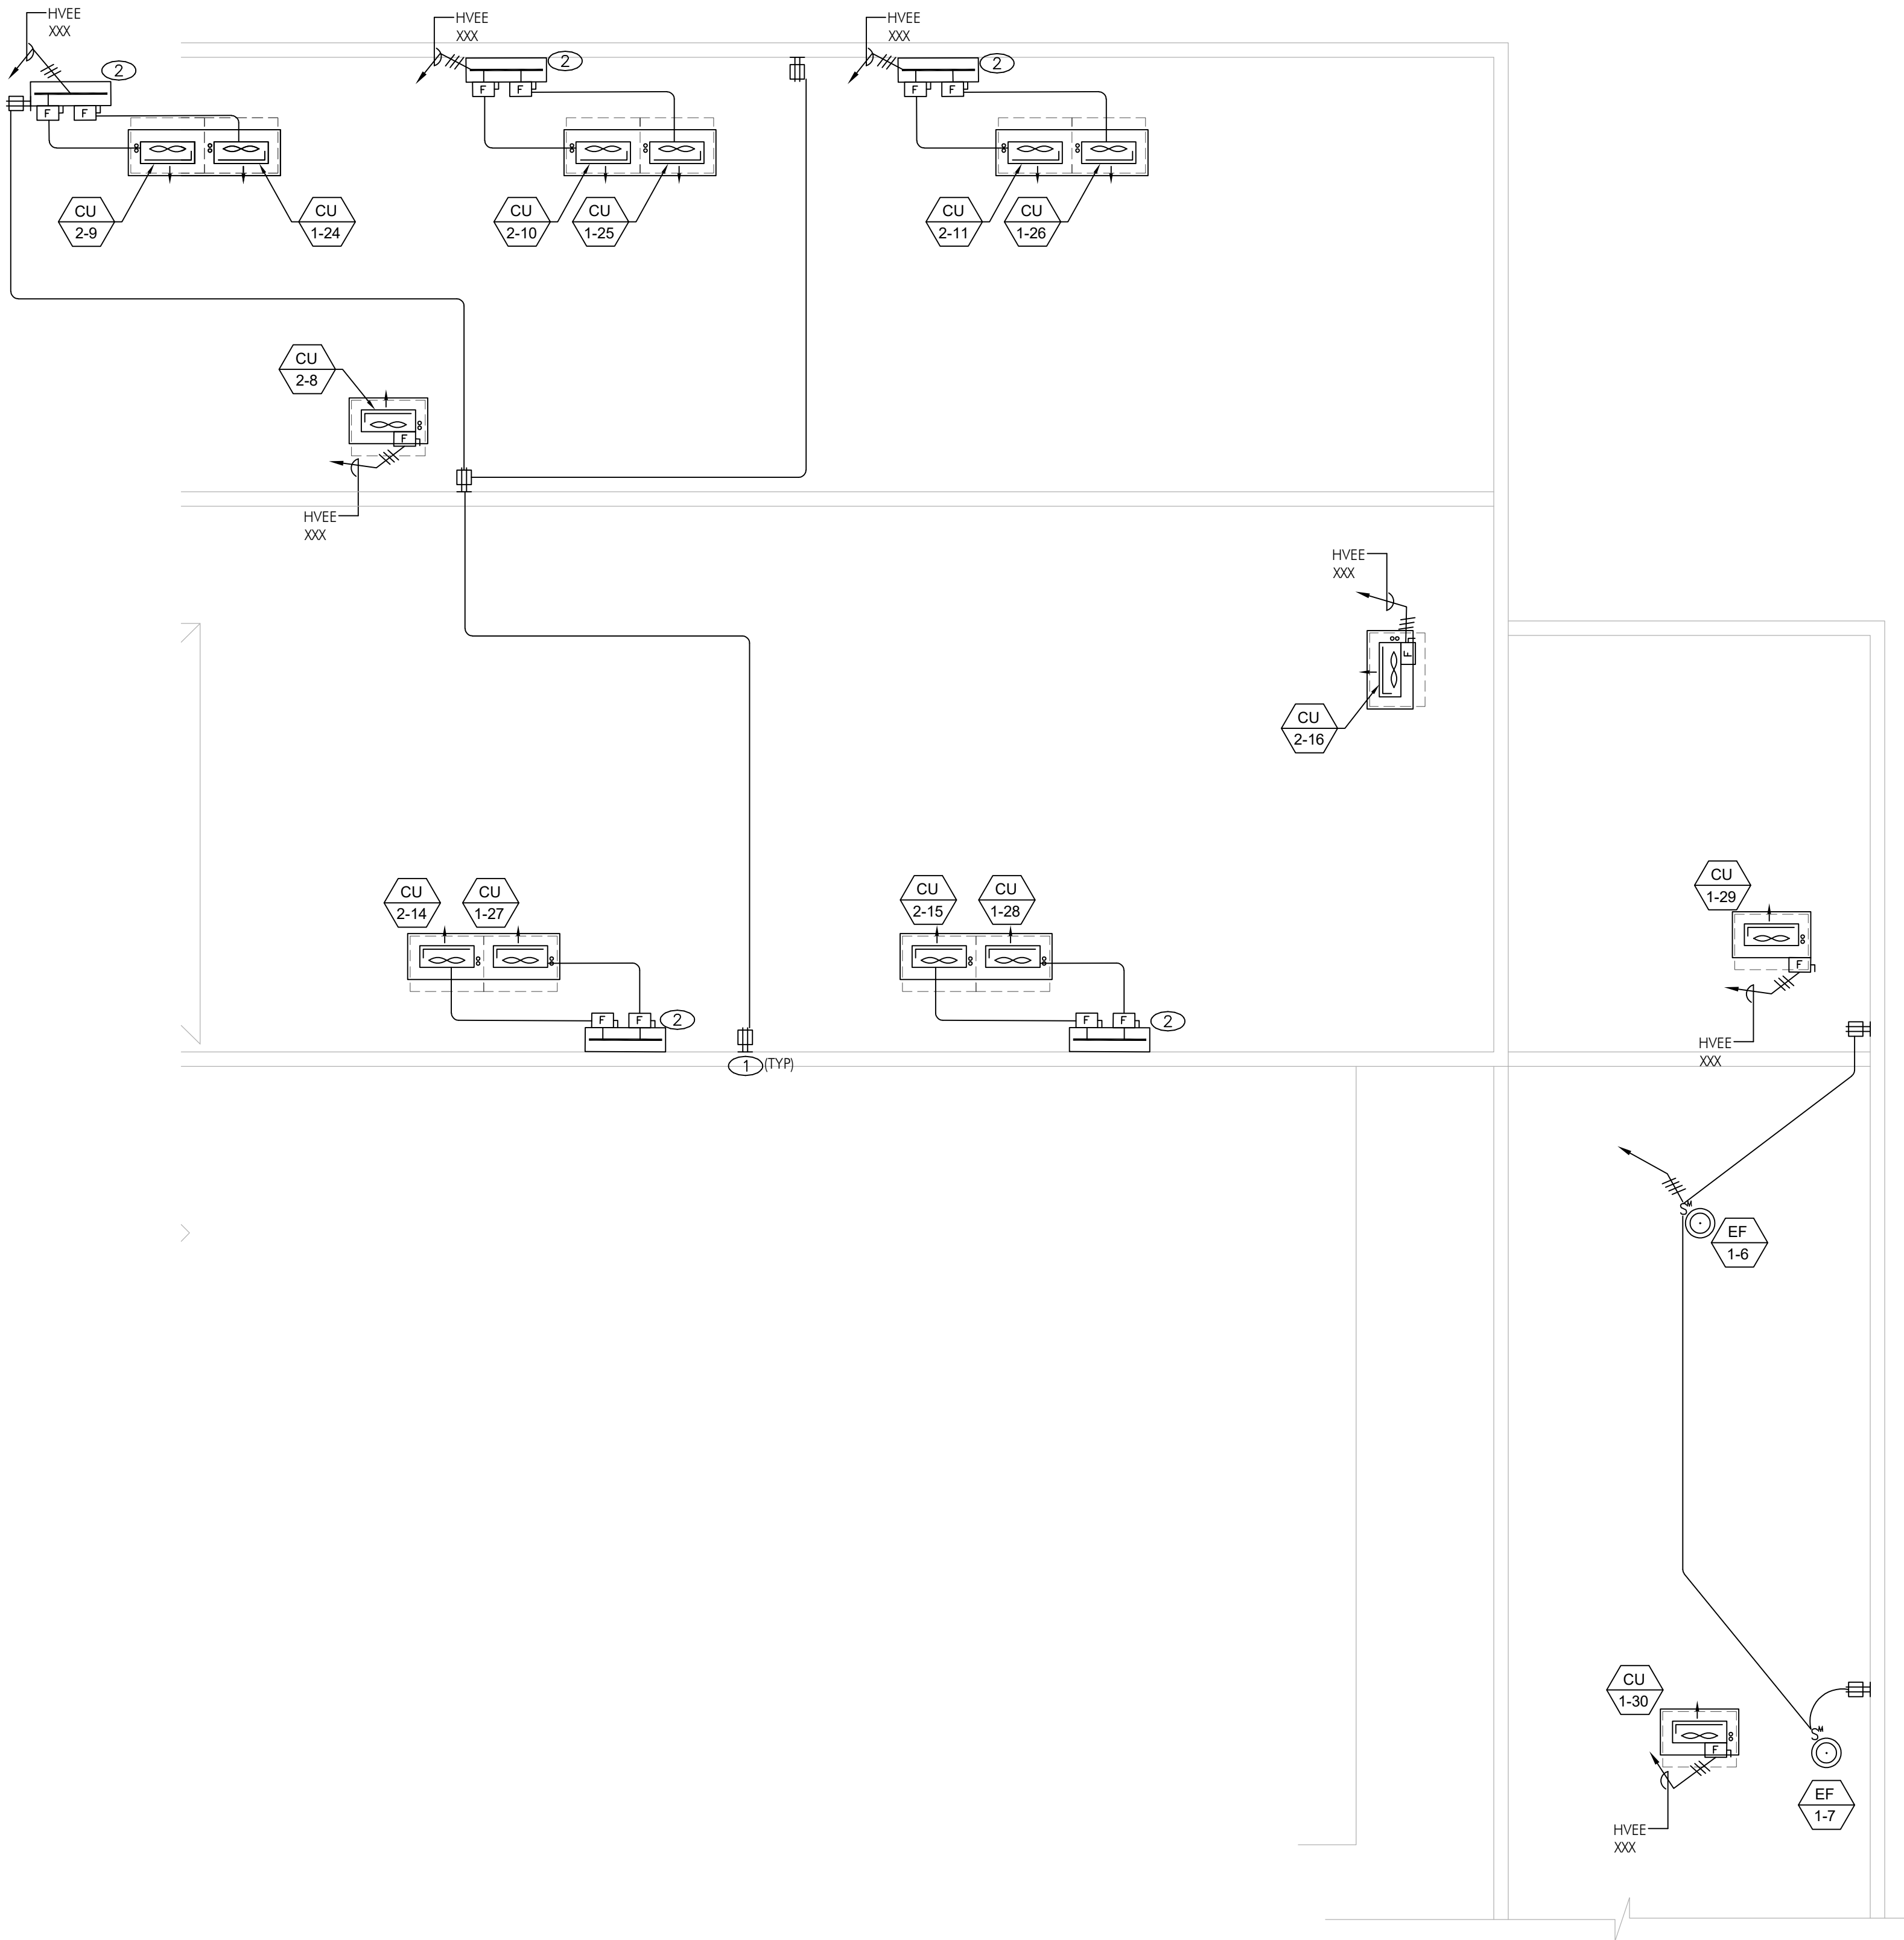
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Sheet Title
Building 'E' Second
Roof Power Plan

Sheet Number

EE241B




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GENERAL NOTES

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KEY PLAN

CDC

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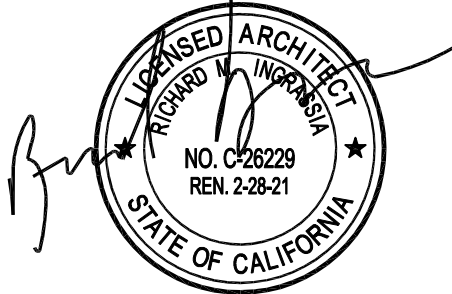
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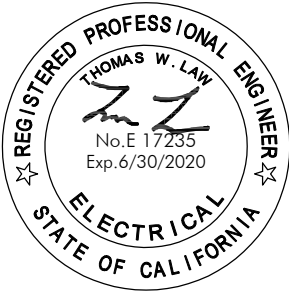
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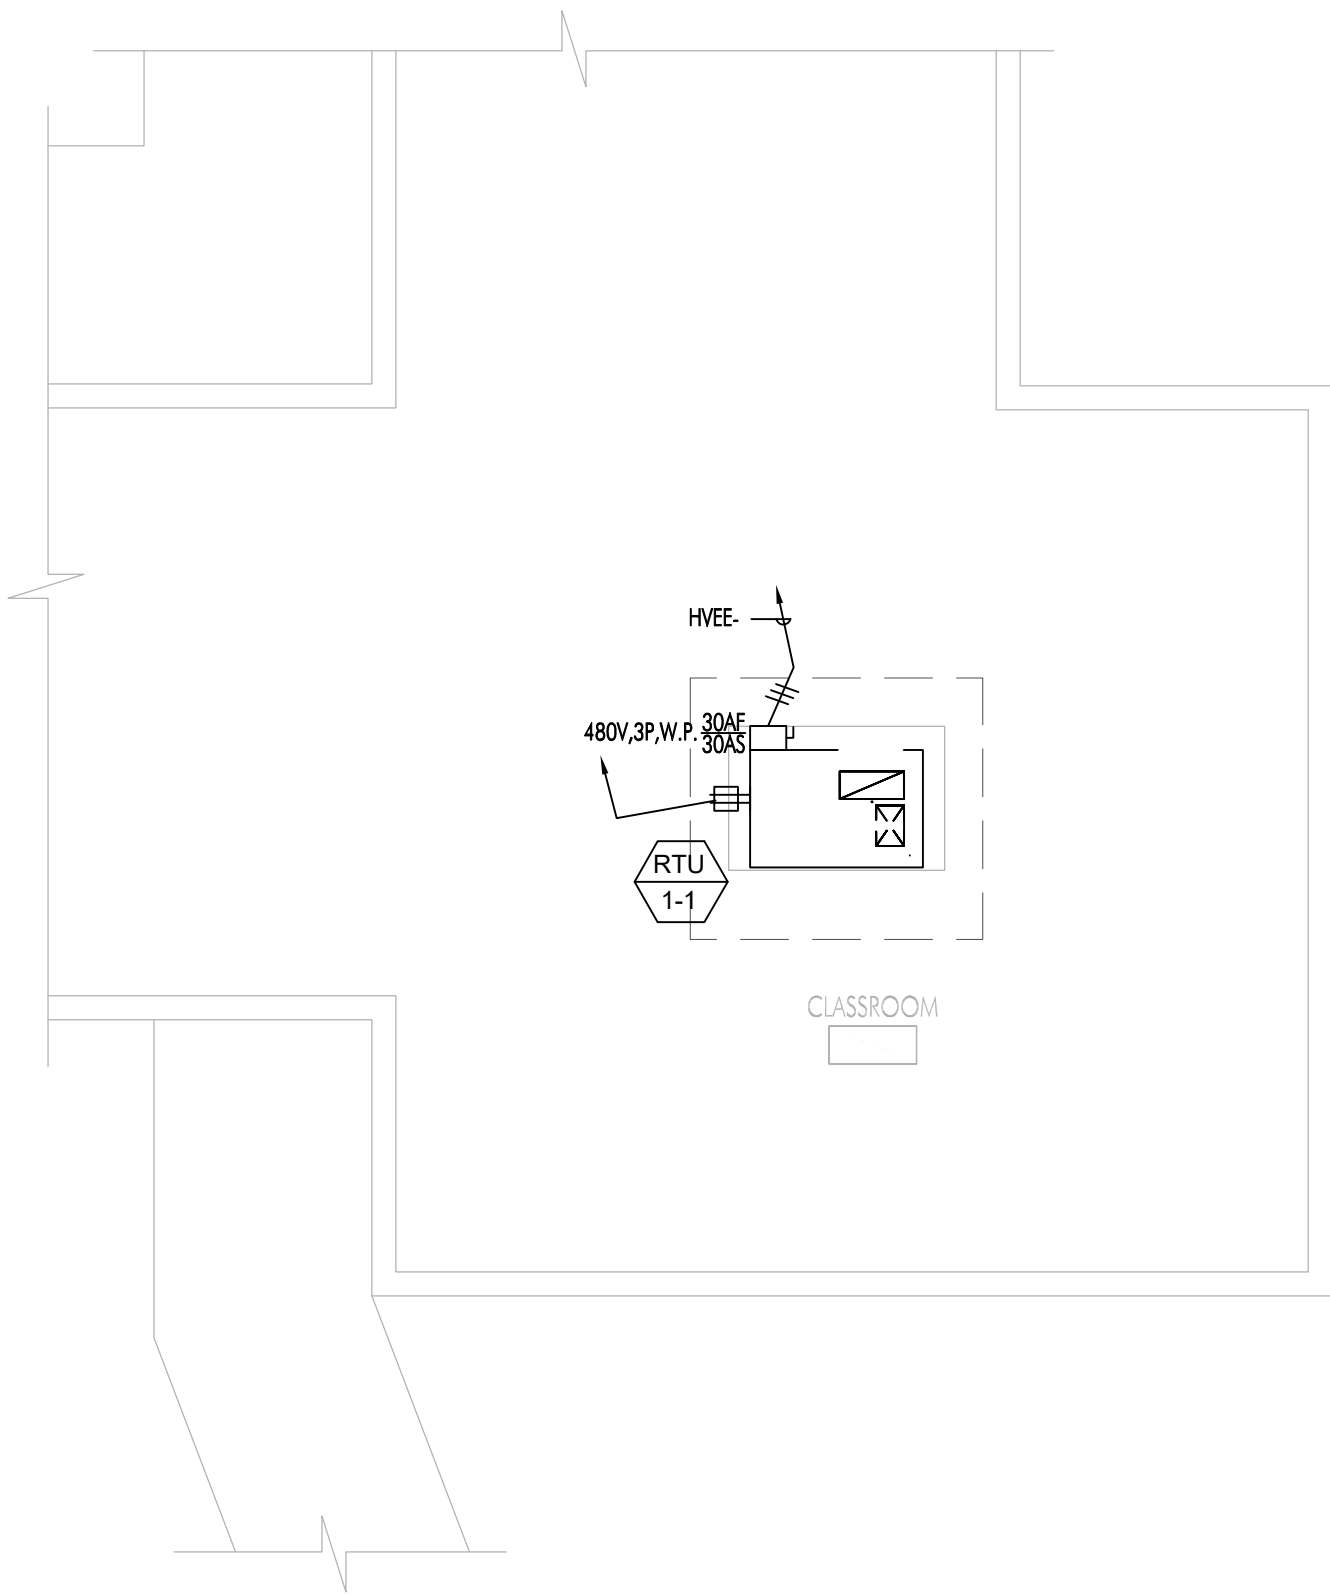


Sheet Title
Building 'G'
Power Plan


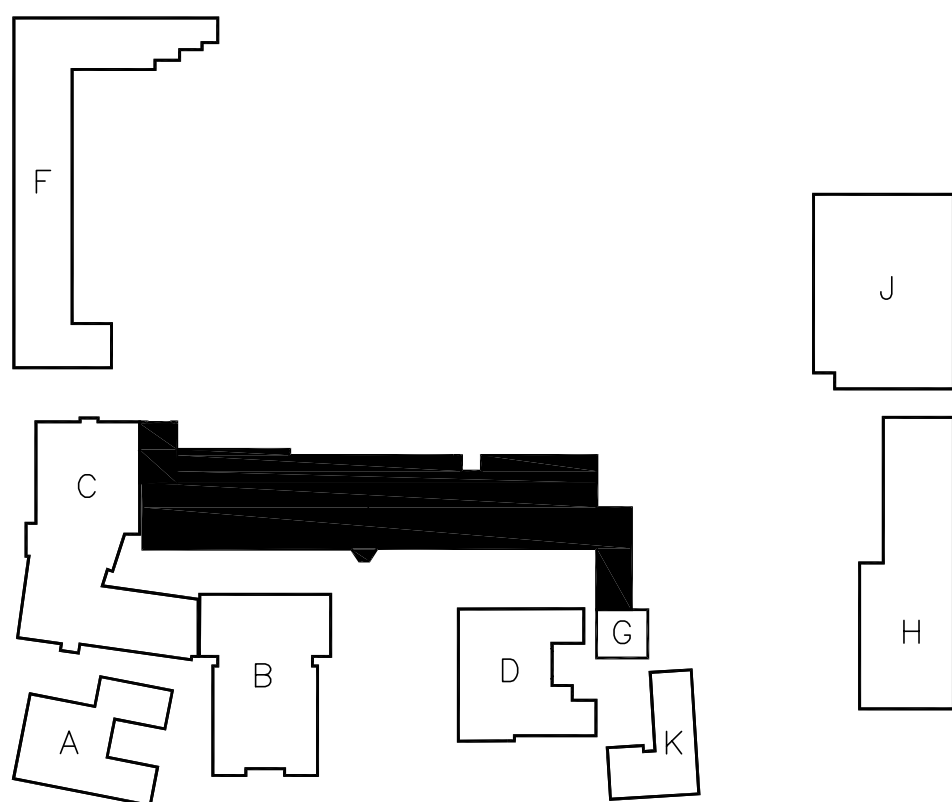
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EG211

2 ROOF PLAN




1 FLOOR PLAN

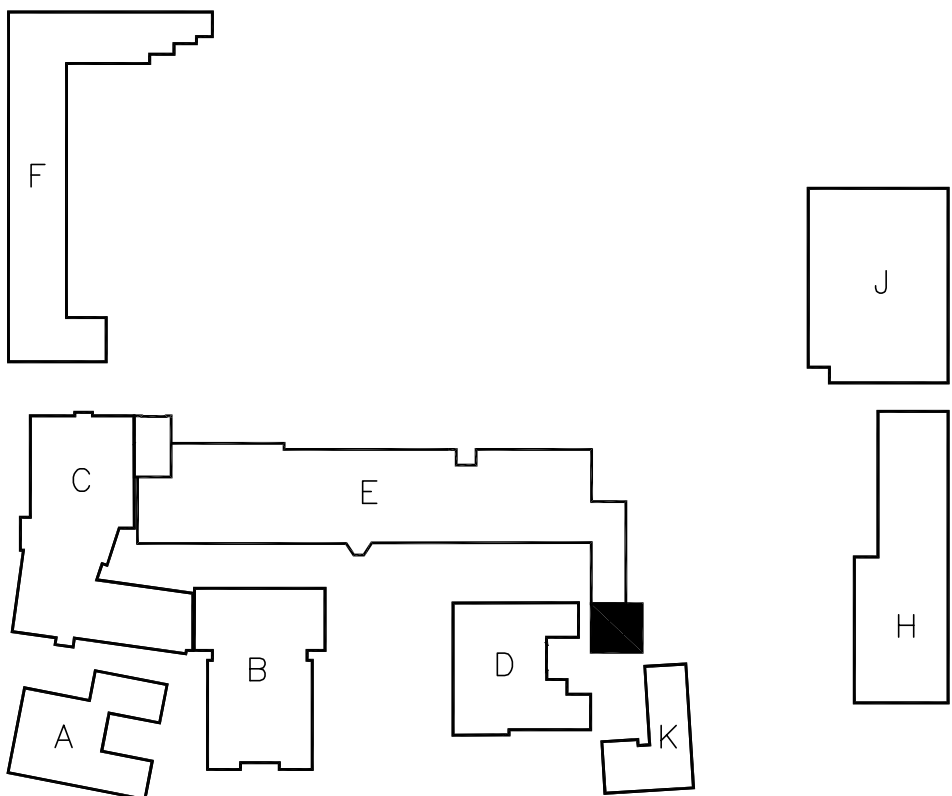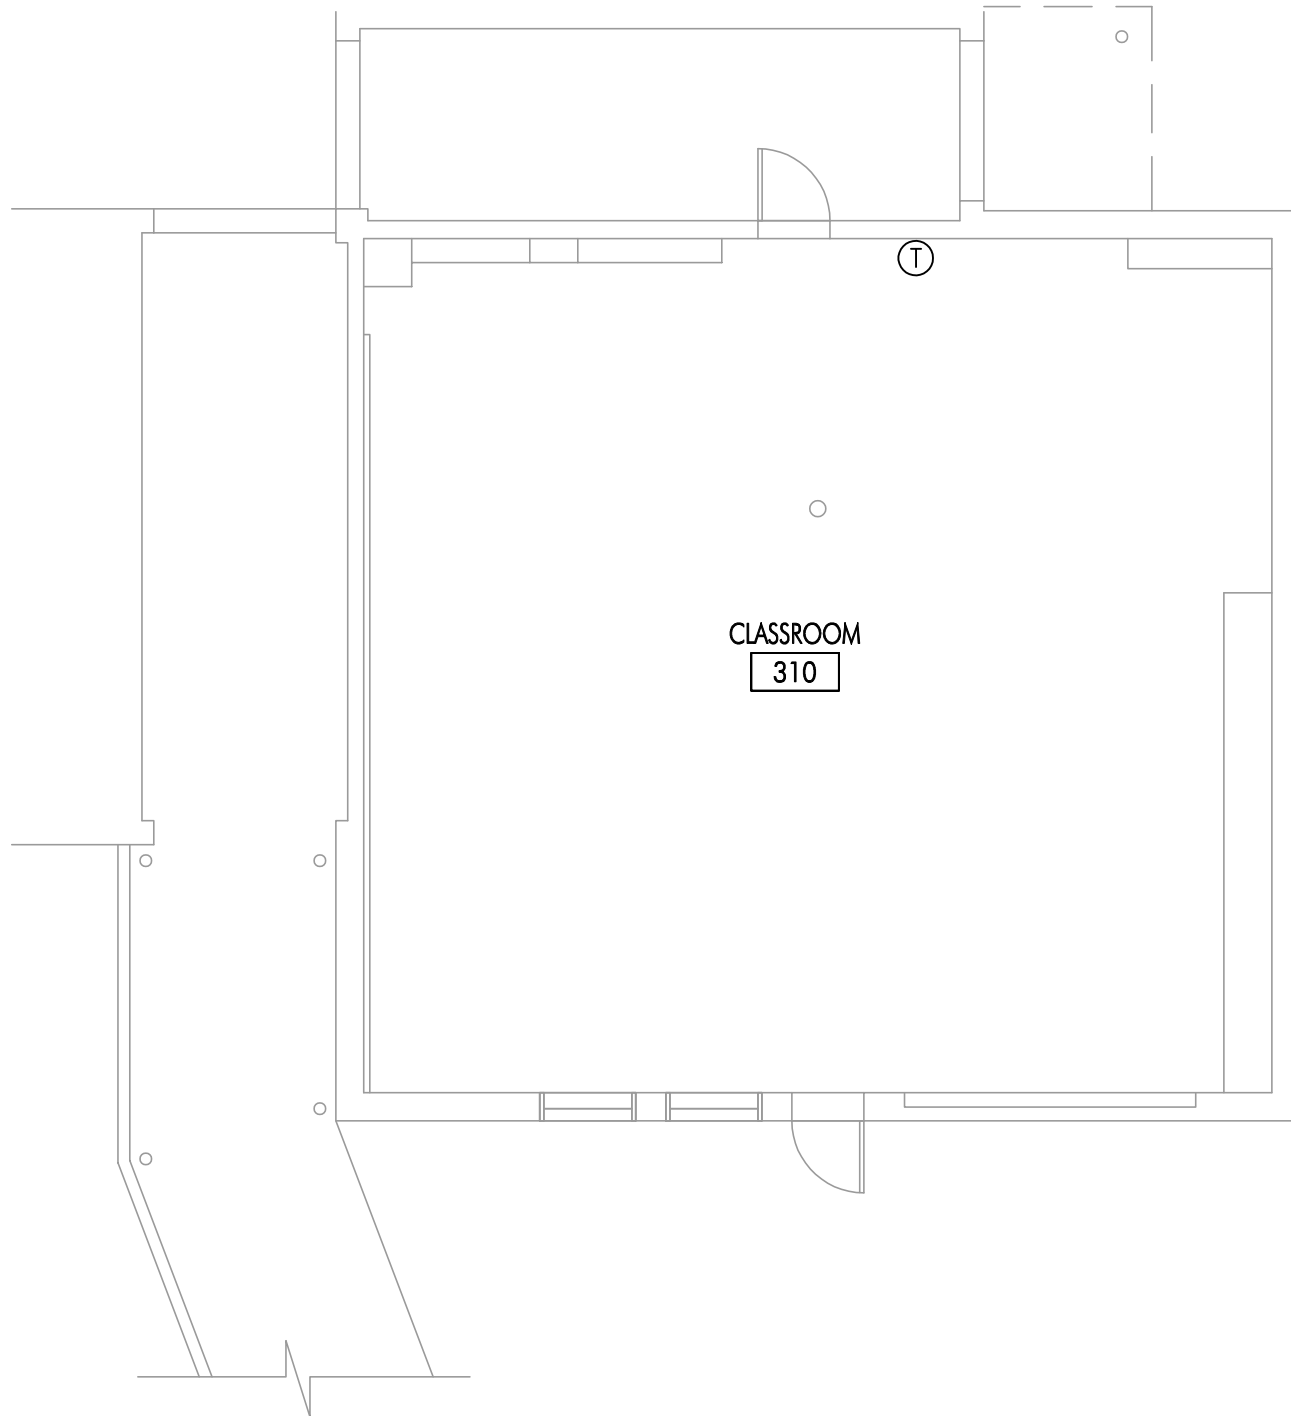

KEY PLAN


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1 FLOOR PLAN

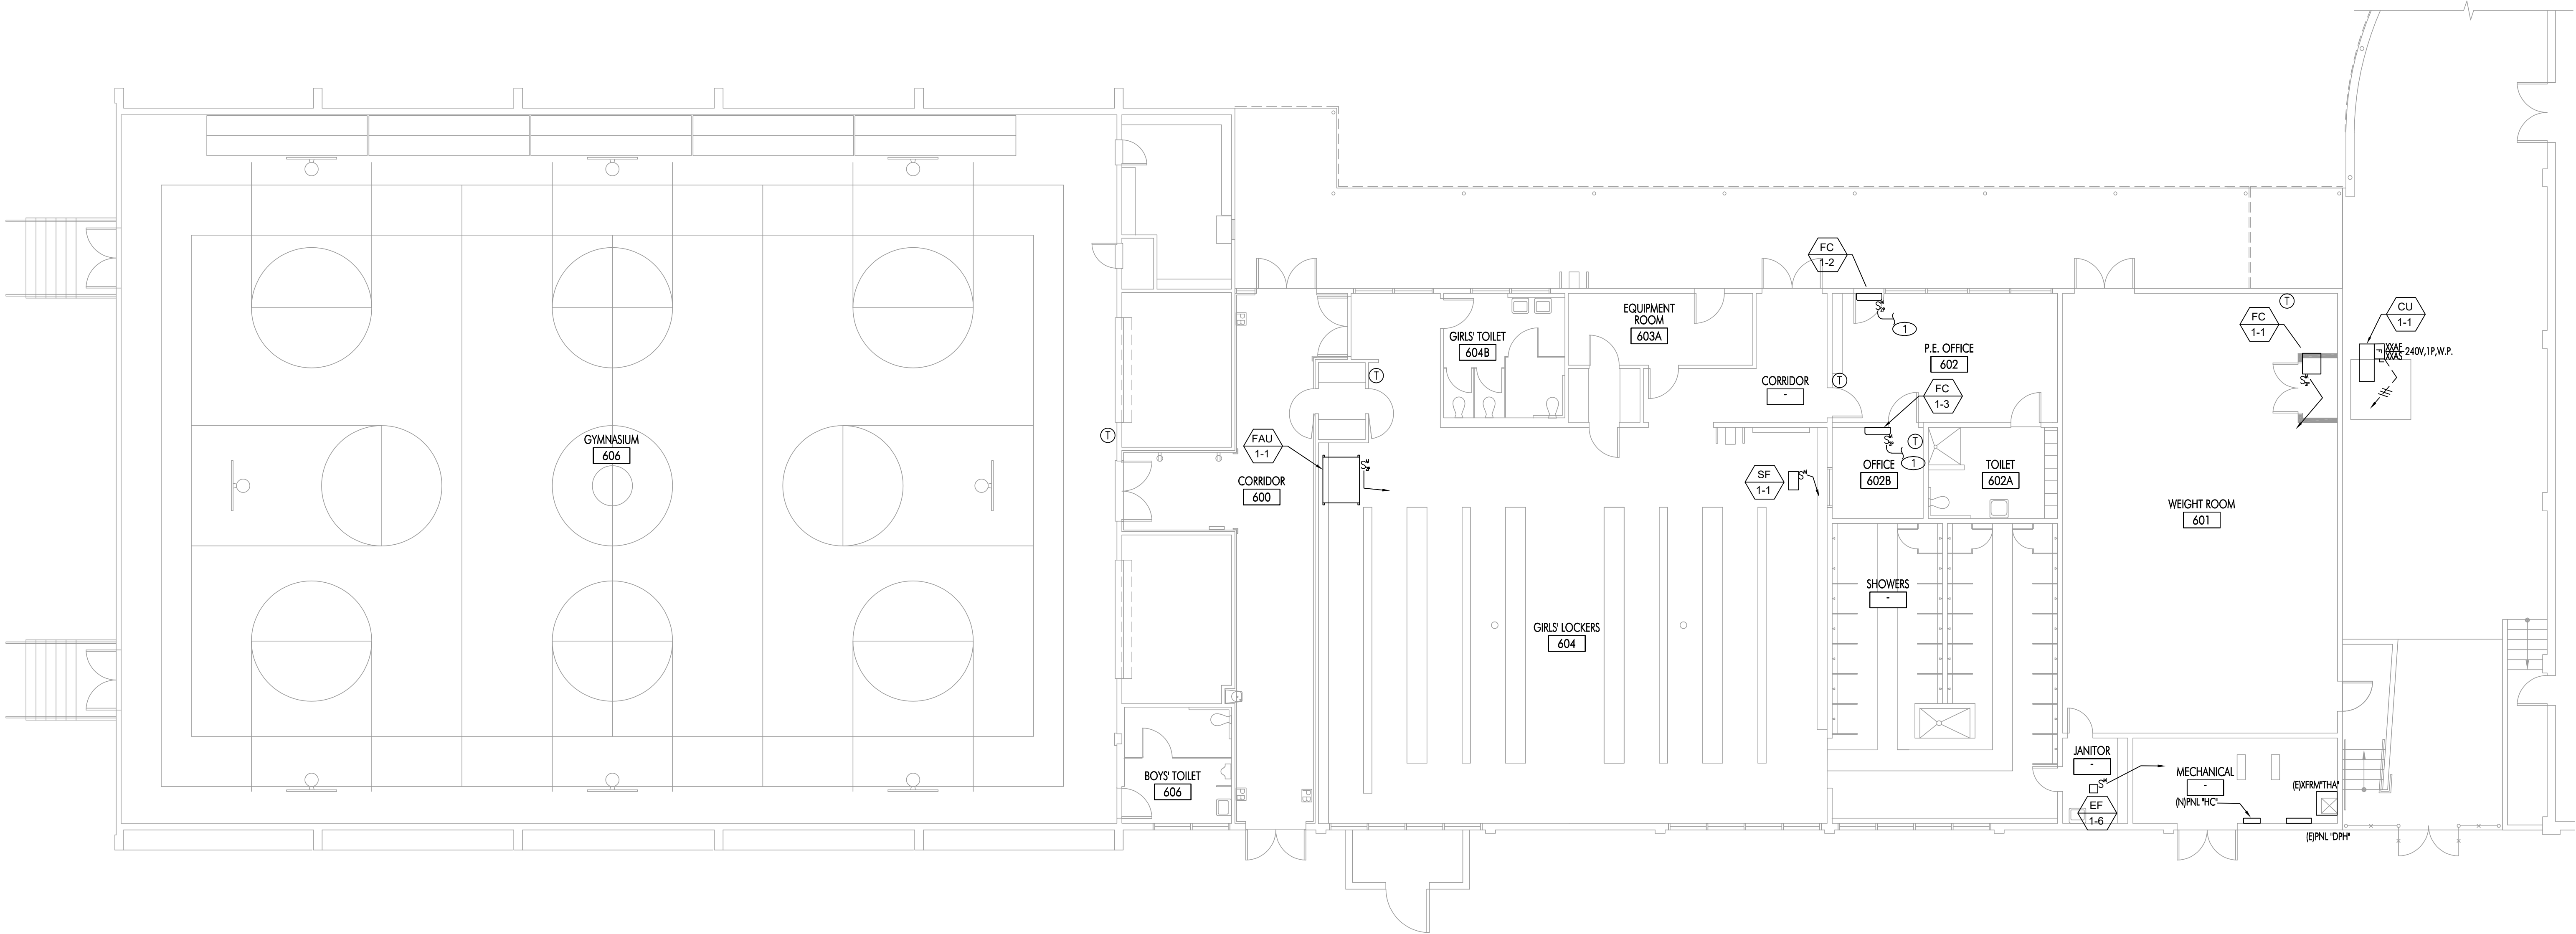

REFERENCE NOTES

- ① INDOOR UNIT POWERED FROM CORRESPONDING ROOFTOP UNIT. PROVIDE 3/4" C, 2#12 + 1#12 GND BETWEEN UNITS.

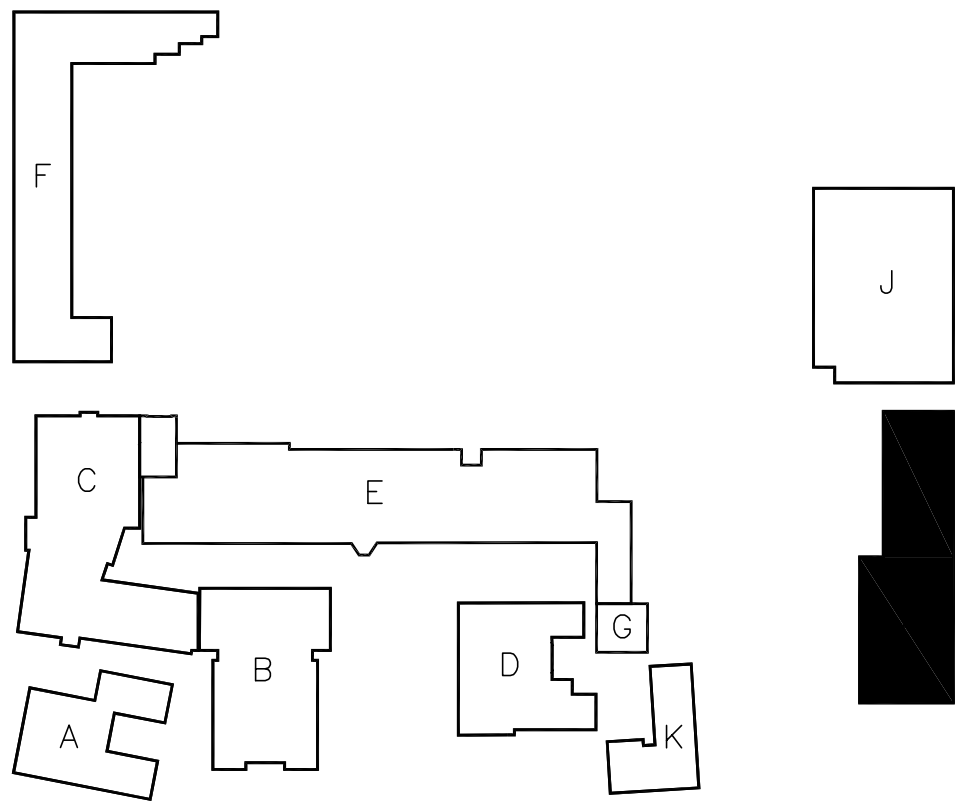

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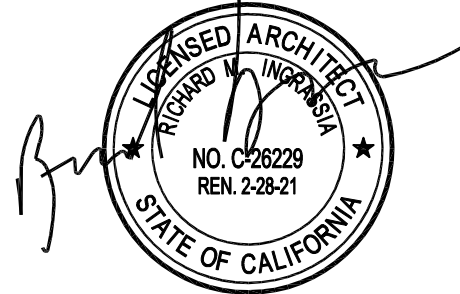
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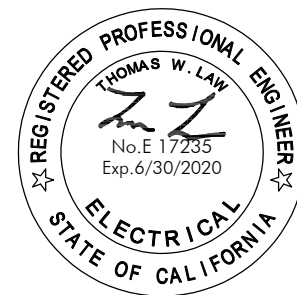
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Sheet Title
Building 'H'
Power Plan

Sheet Number

EH211



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NORTH

SCALE: 1/8" = 1'-0"

A circular professional engineer seal for Richard M. Indiana, State of California. The seal contains the text: "LICENSED ARCHITECT", "RICHARD M. INDIANA", "NO. C-26229", "REN. 2-28-21", and "STATE OF CALIFORNIA". There are two stars on either side of the license number. A handwritten signature is written over the seal.

EH241

KEY PLAN

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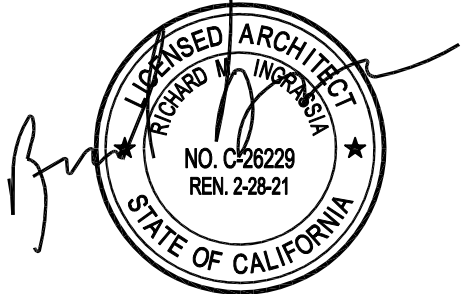
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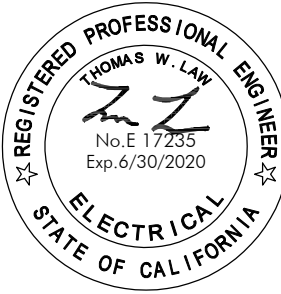
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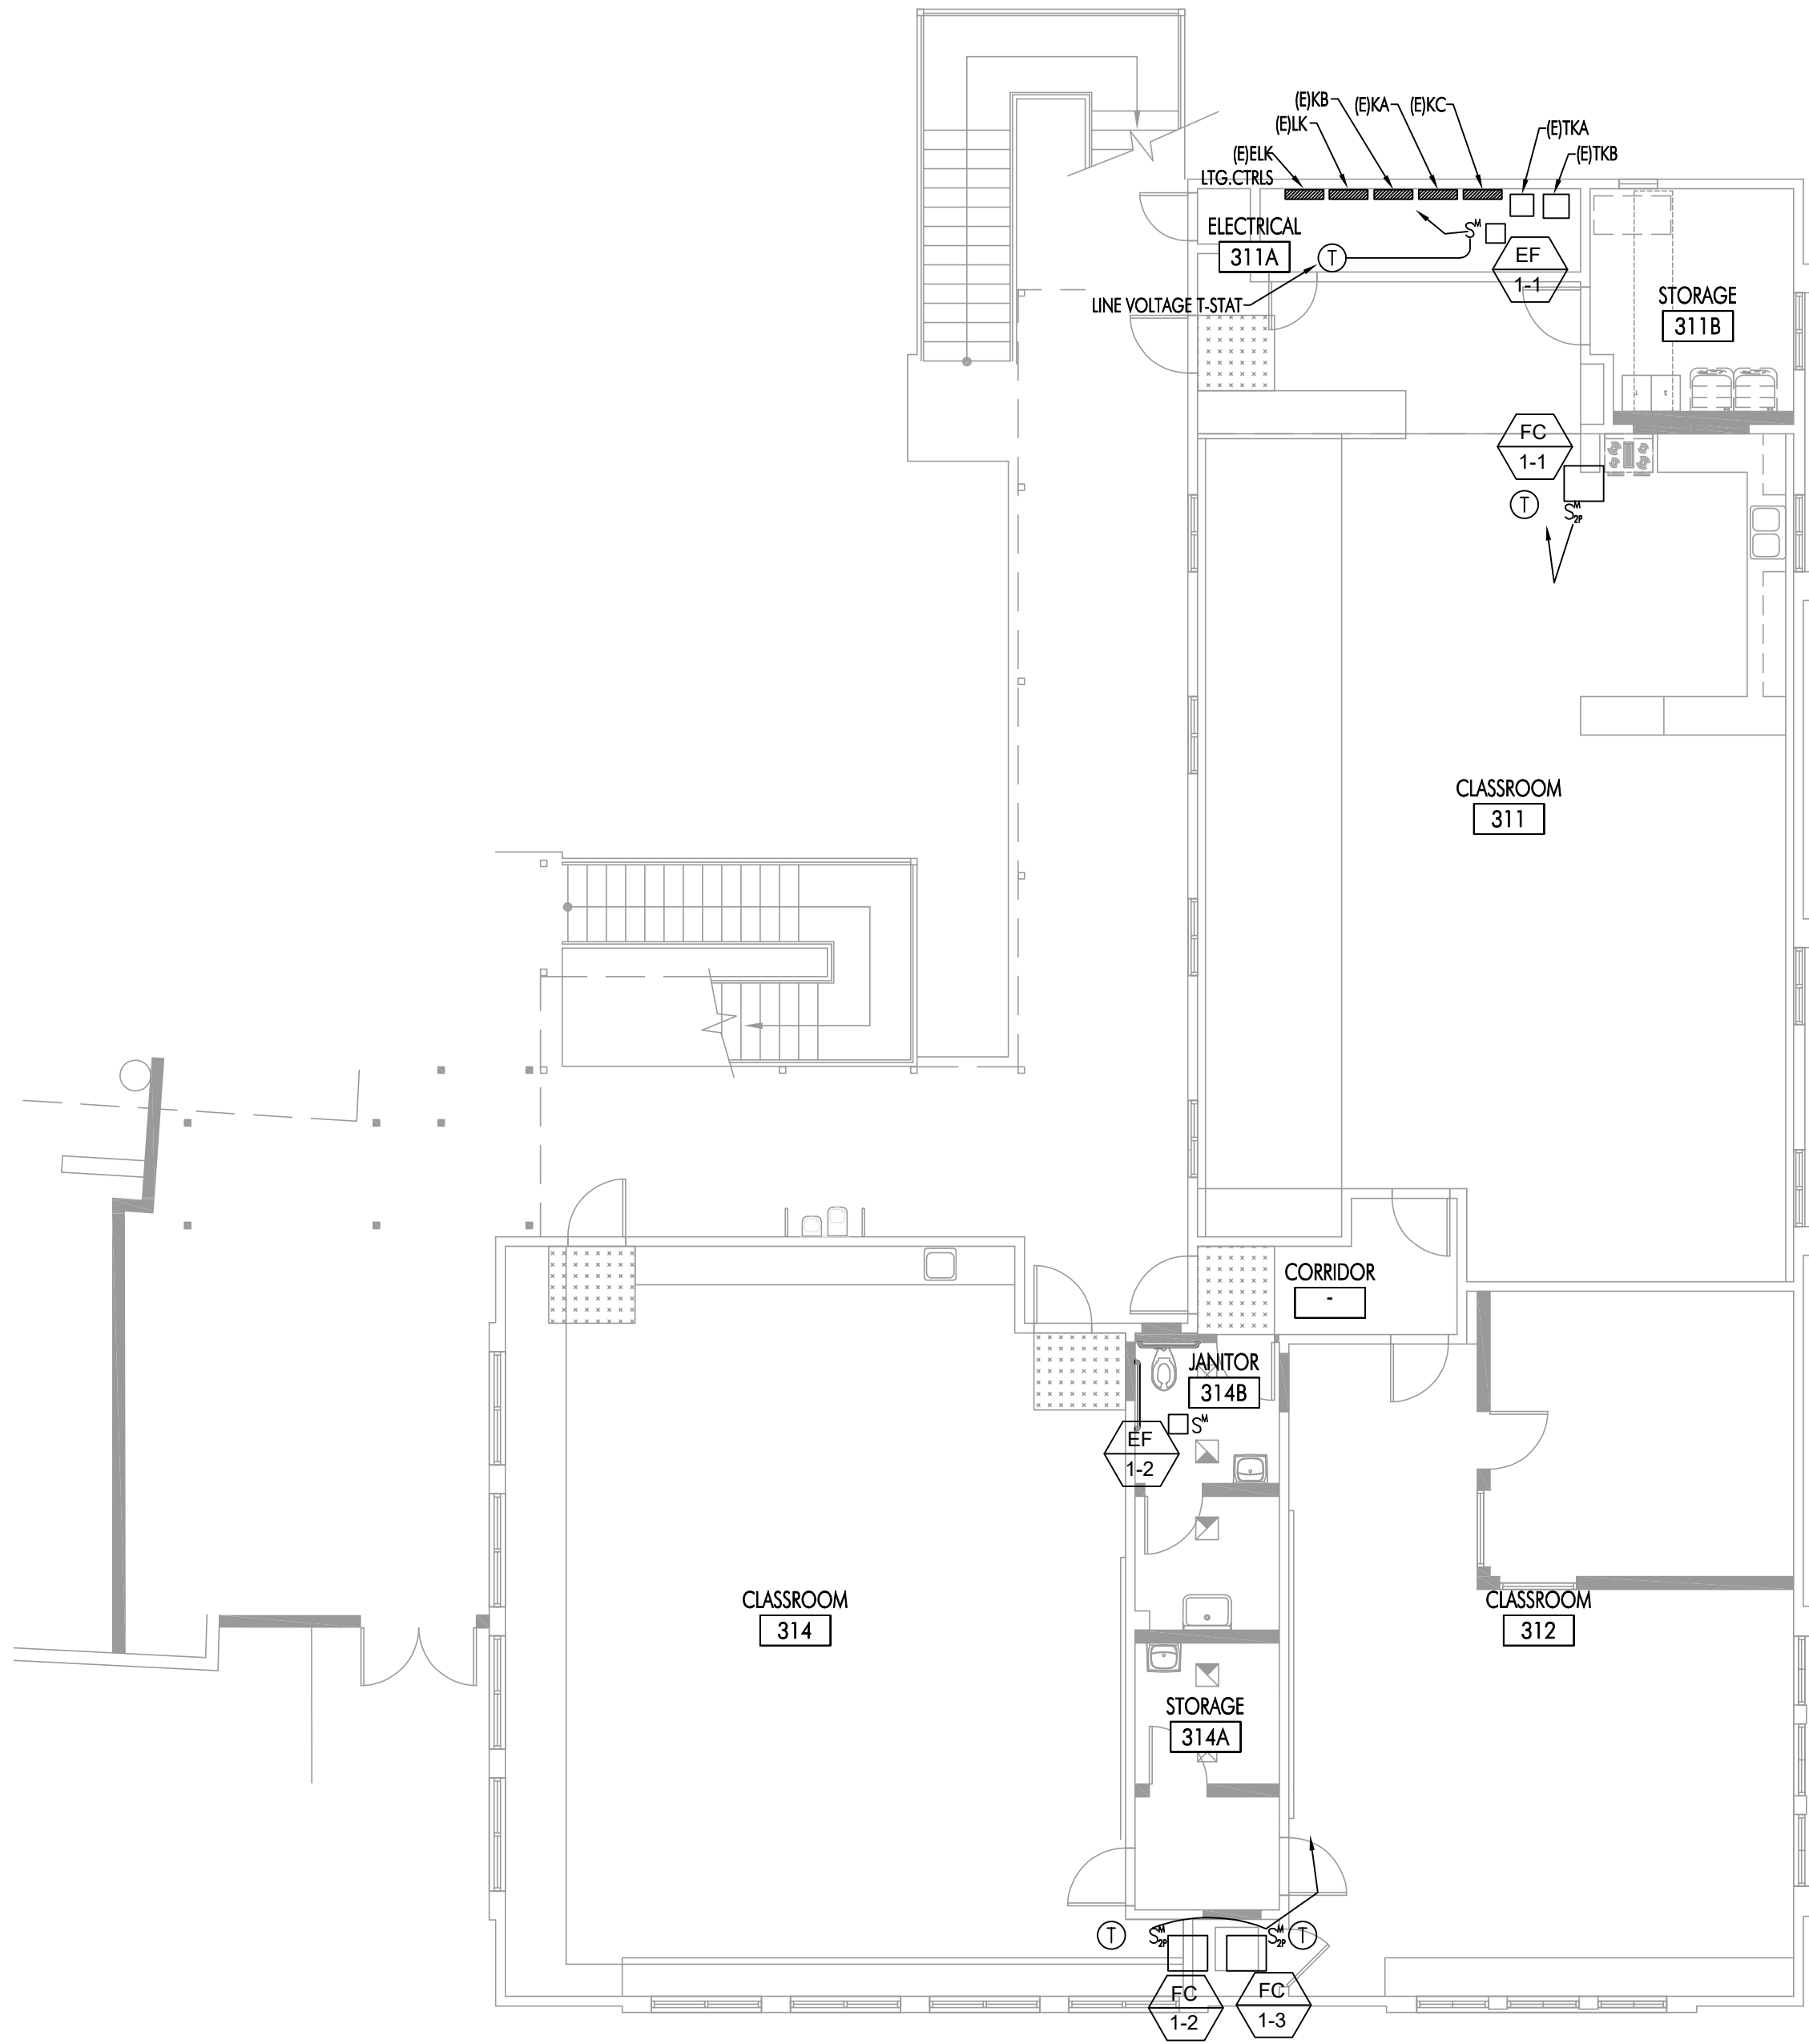
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Sheet Title
Building 'K' First Floor
Power Plan

Sheet Number


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1 FLOOR PLAN



SCALE: 1/8"=1'-0"



KEY PLAN
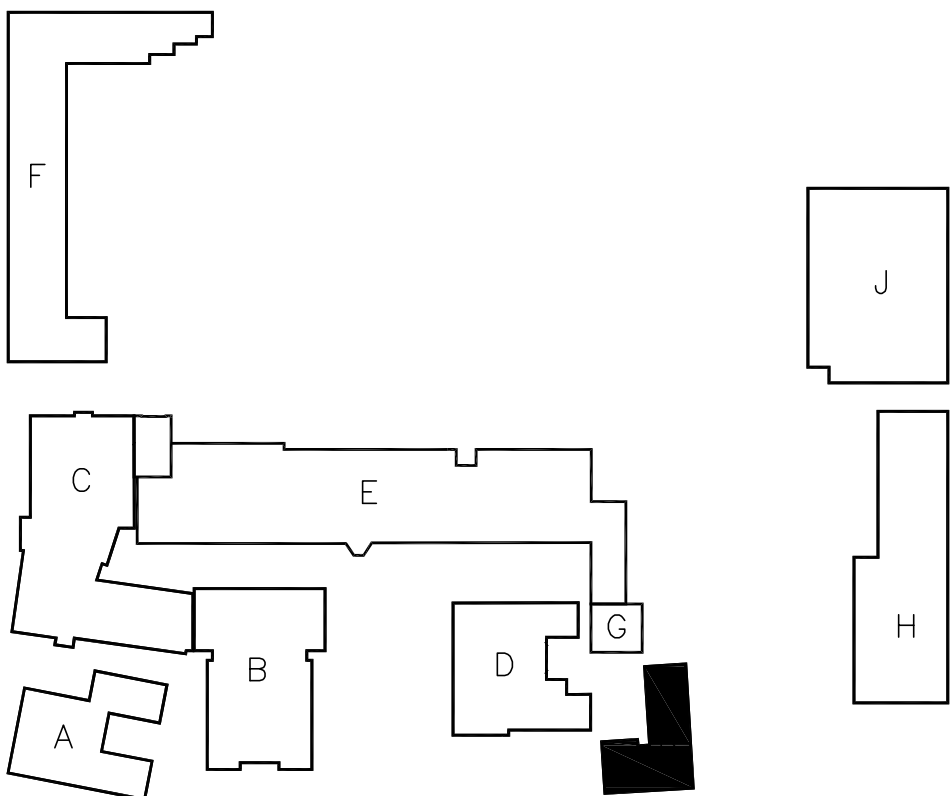
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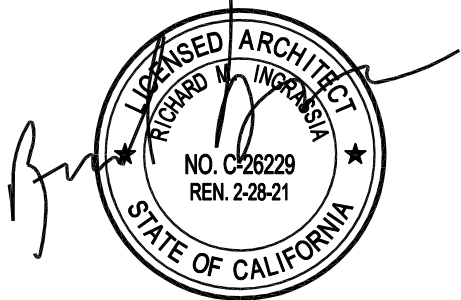
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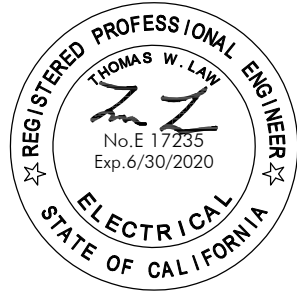
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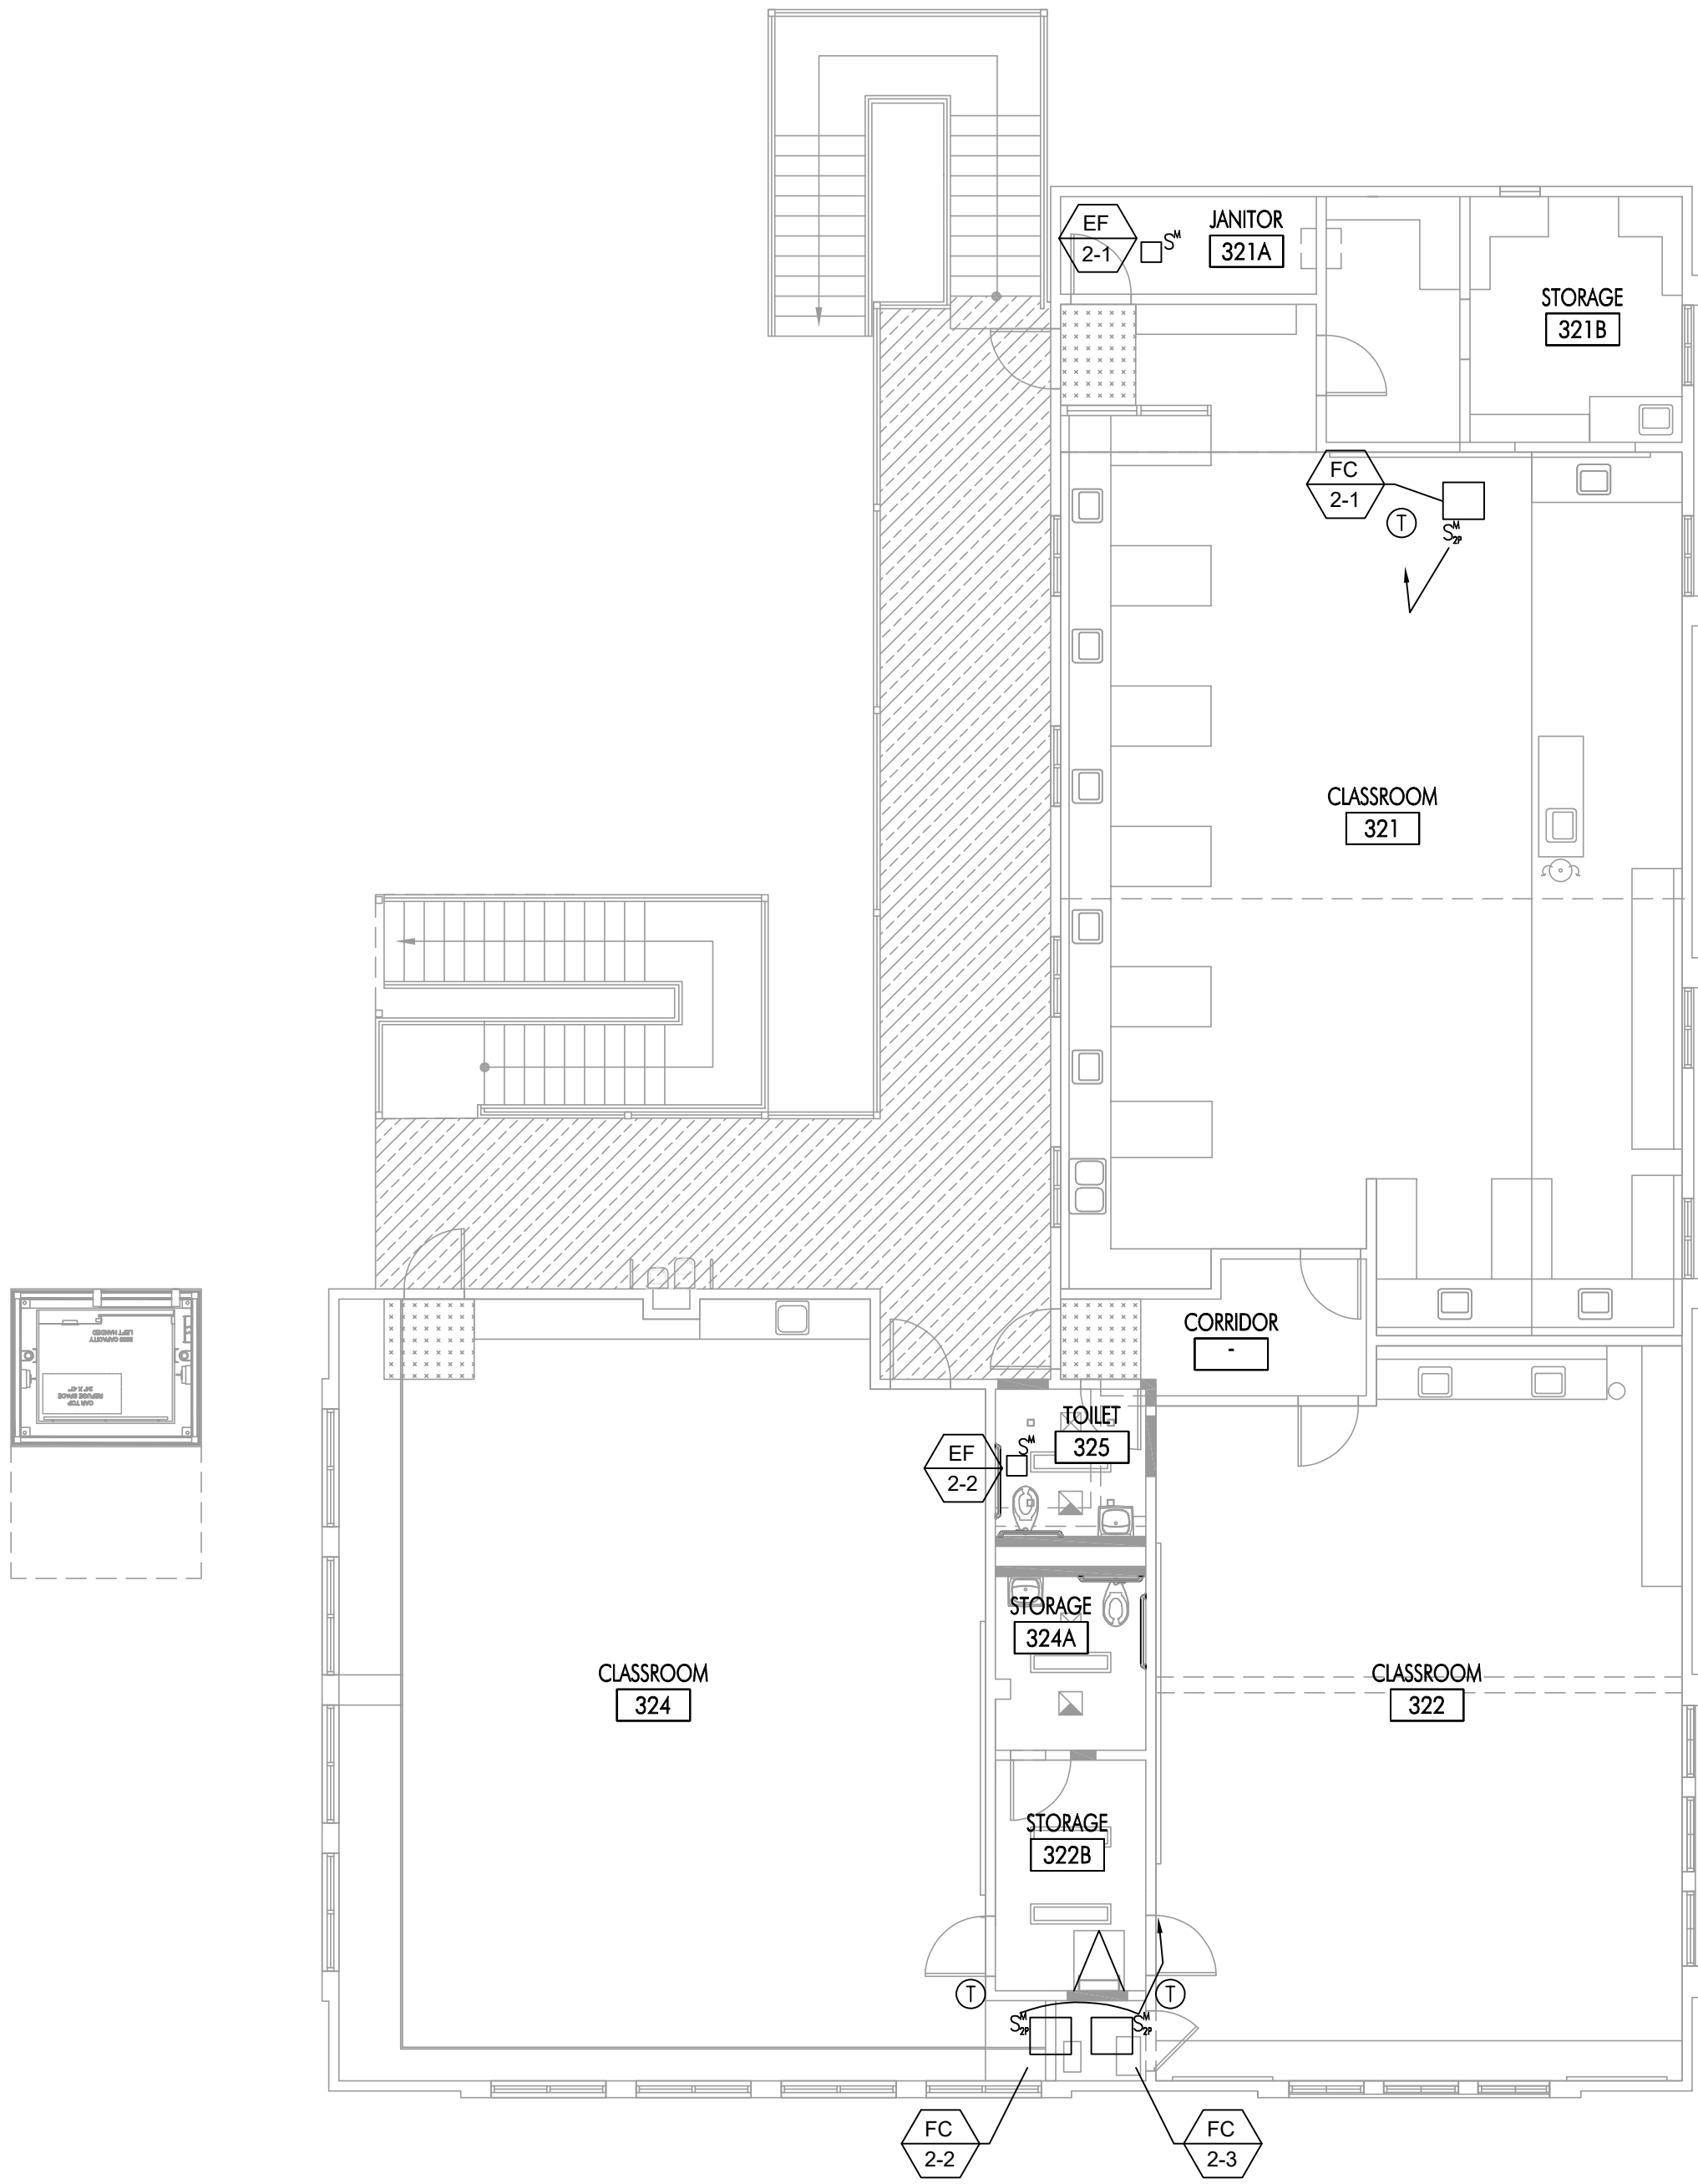
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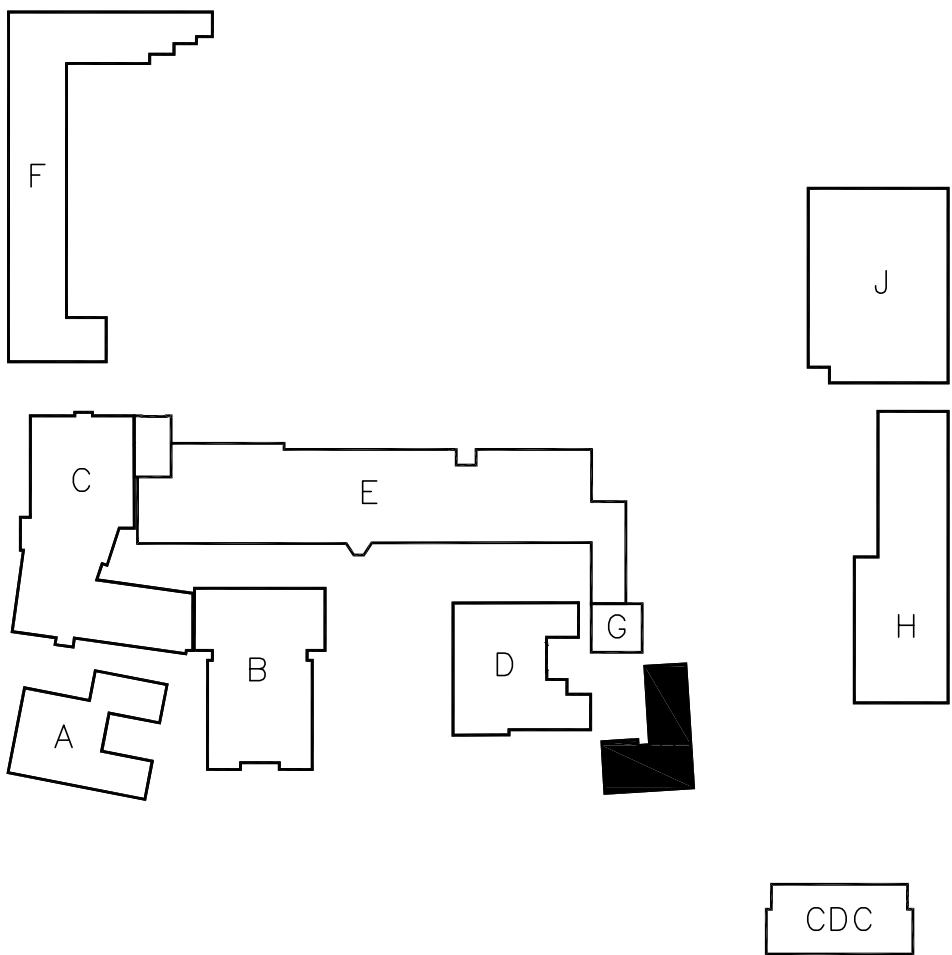
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Building 'K' Second
Floor Power Plan

Sheet Number

EK212



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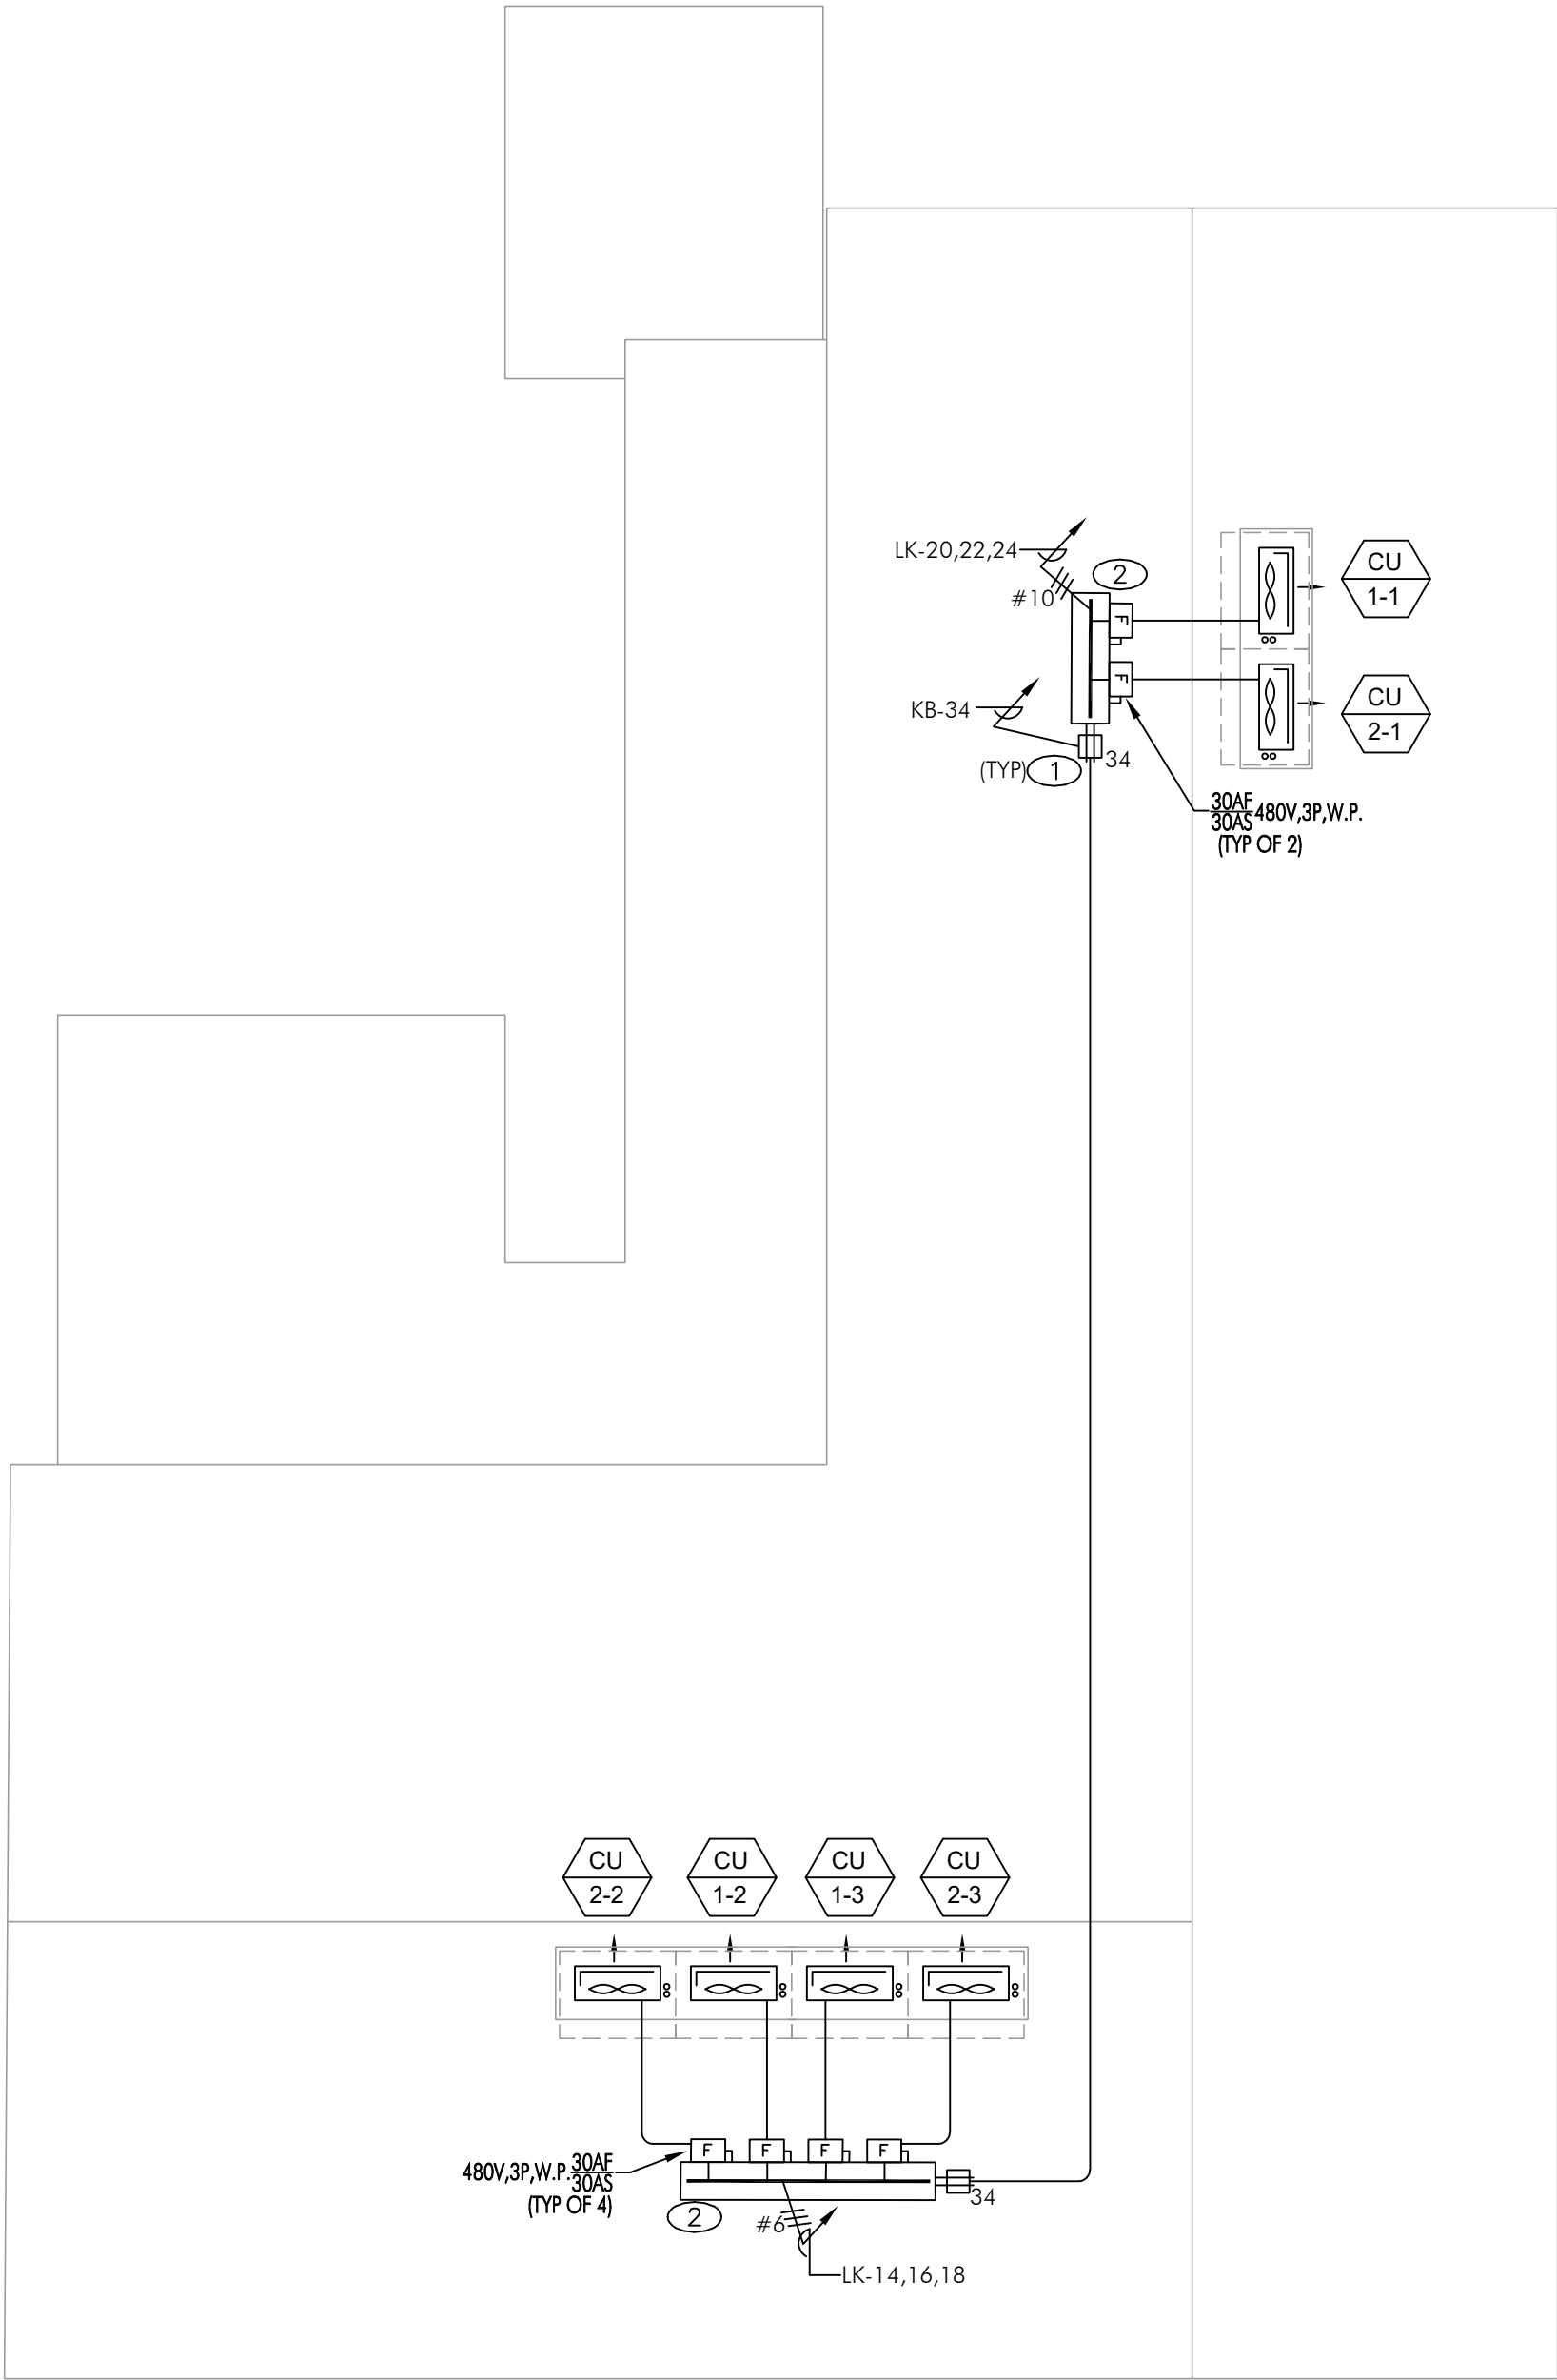


1 FLOOR PLAN

KEY PLAN


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1 FLOOR PLAN



SCALE: 1/8"=1'-0"

KEY PLAN

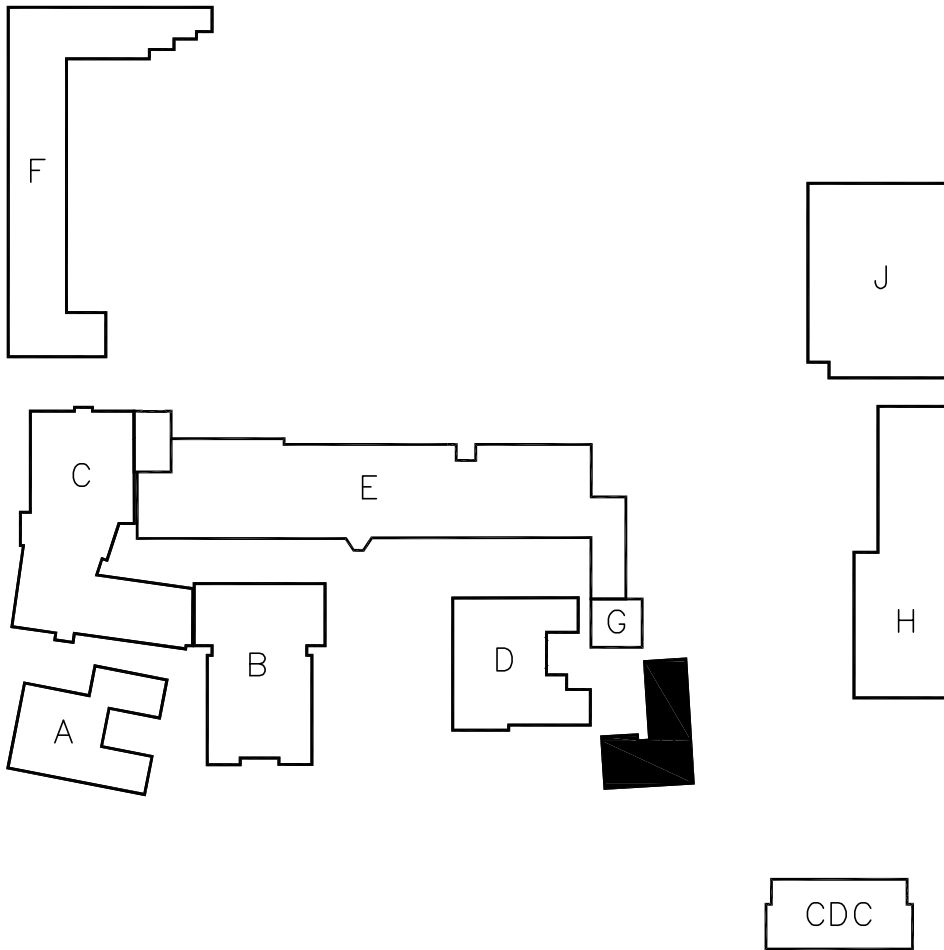

GENERAL NOTES

- ALL ROOFTOP EQUIPMENT TO BE NEMA 3R RATED.
- COORDINATE LOCATION FOR EQUIPMENT POINTS OF CONNECTION/DISCONNECT SWITCHES, MAINTAIN ALL CODE REQUIRED CLEARANCES.
- PROVIDE DURA-BLOCK (OR EQUAL) SUPPORTS FOR ALL CONDUITS RUN ON ROOF.

REFERENCE NOTES

- PROVIDE WEATHER RESISTANT, GFI PROTECTED RECEPTACLE, IN WEATHERPROOF ENCLOSURE, LISTED/IDENTIFIED AS 'EXTRA DUTY' COVER, MOUNTED ON UNISTRUT SUPPORTING WIREWAY/DISCONNECT SWITCHES
- W.P. WIREWAY 8"x8"xLENGTH AS REQUIRED(MIN.), MOUNT WIREWAY + 18" AFF WITH GALVANIZED UNISTRUT SUPPORTS. W.P. FUSIBLE DISCONNECTS MOUNTED TO UNISTRUT SUPPORT

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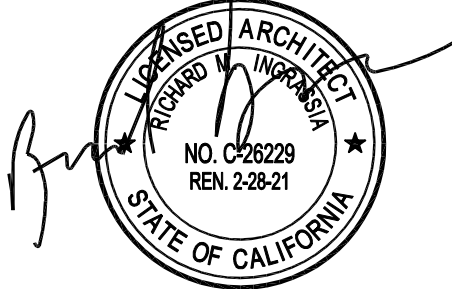
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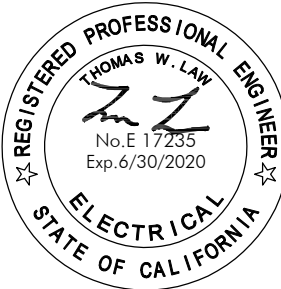
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Sheet Title
Building 'K'
Roof Power Plan

Sheet Number


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14TH STREET

WASHINGTON AVENUE

CALIFORNIA AVENUE

16TH STREET

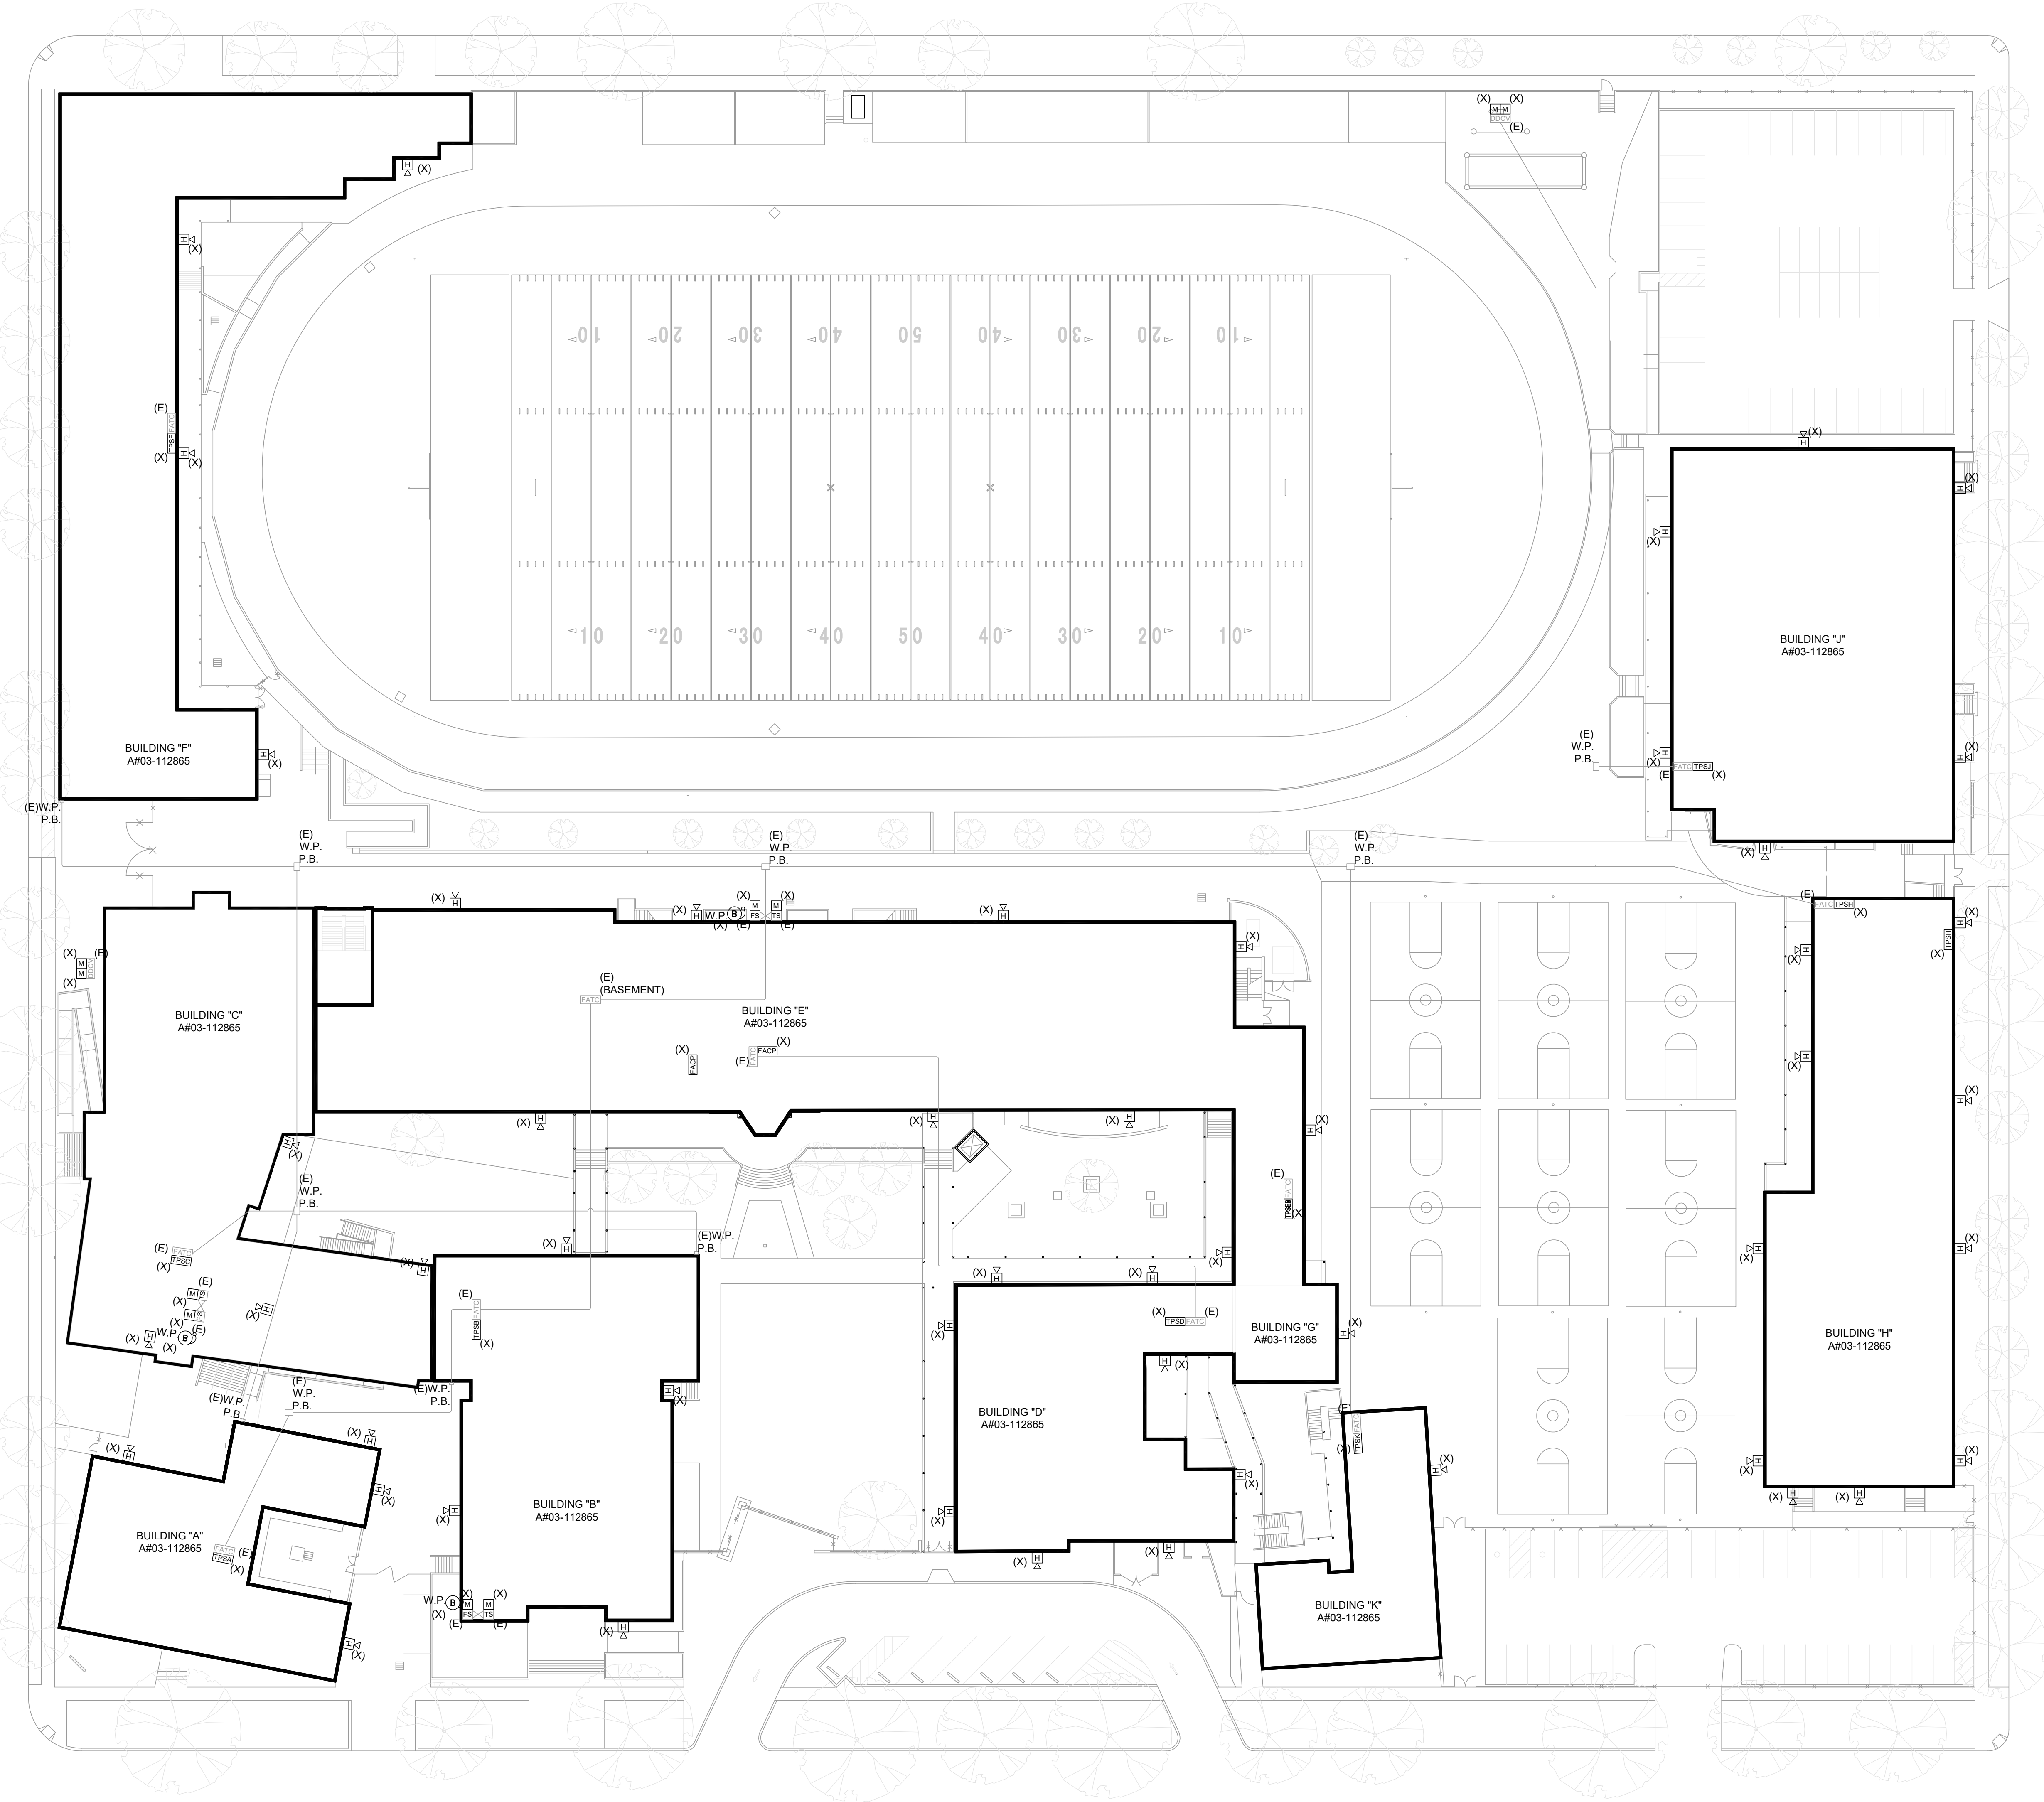

FIRE ALARM DEMOLITION SITE PLAN

SCALE
1" = 30'-0"

1

GENERAL NOTES

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REFERENCE NOTES

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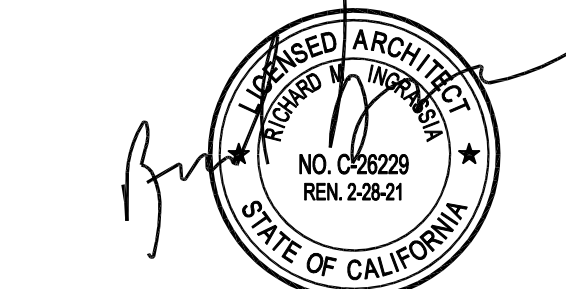
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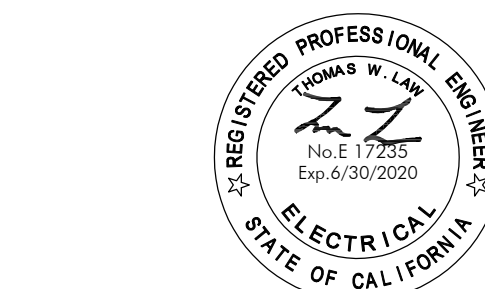
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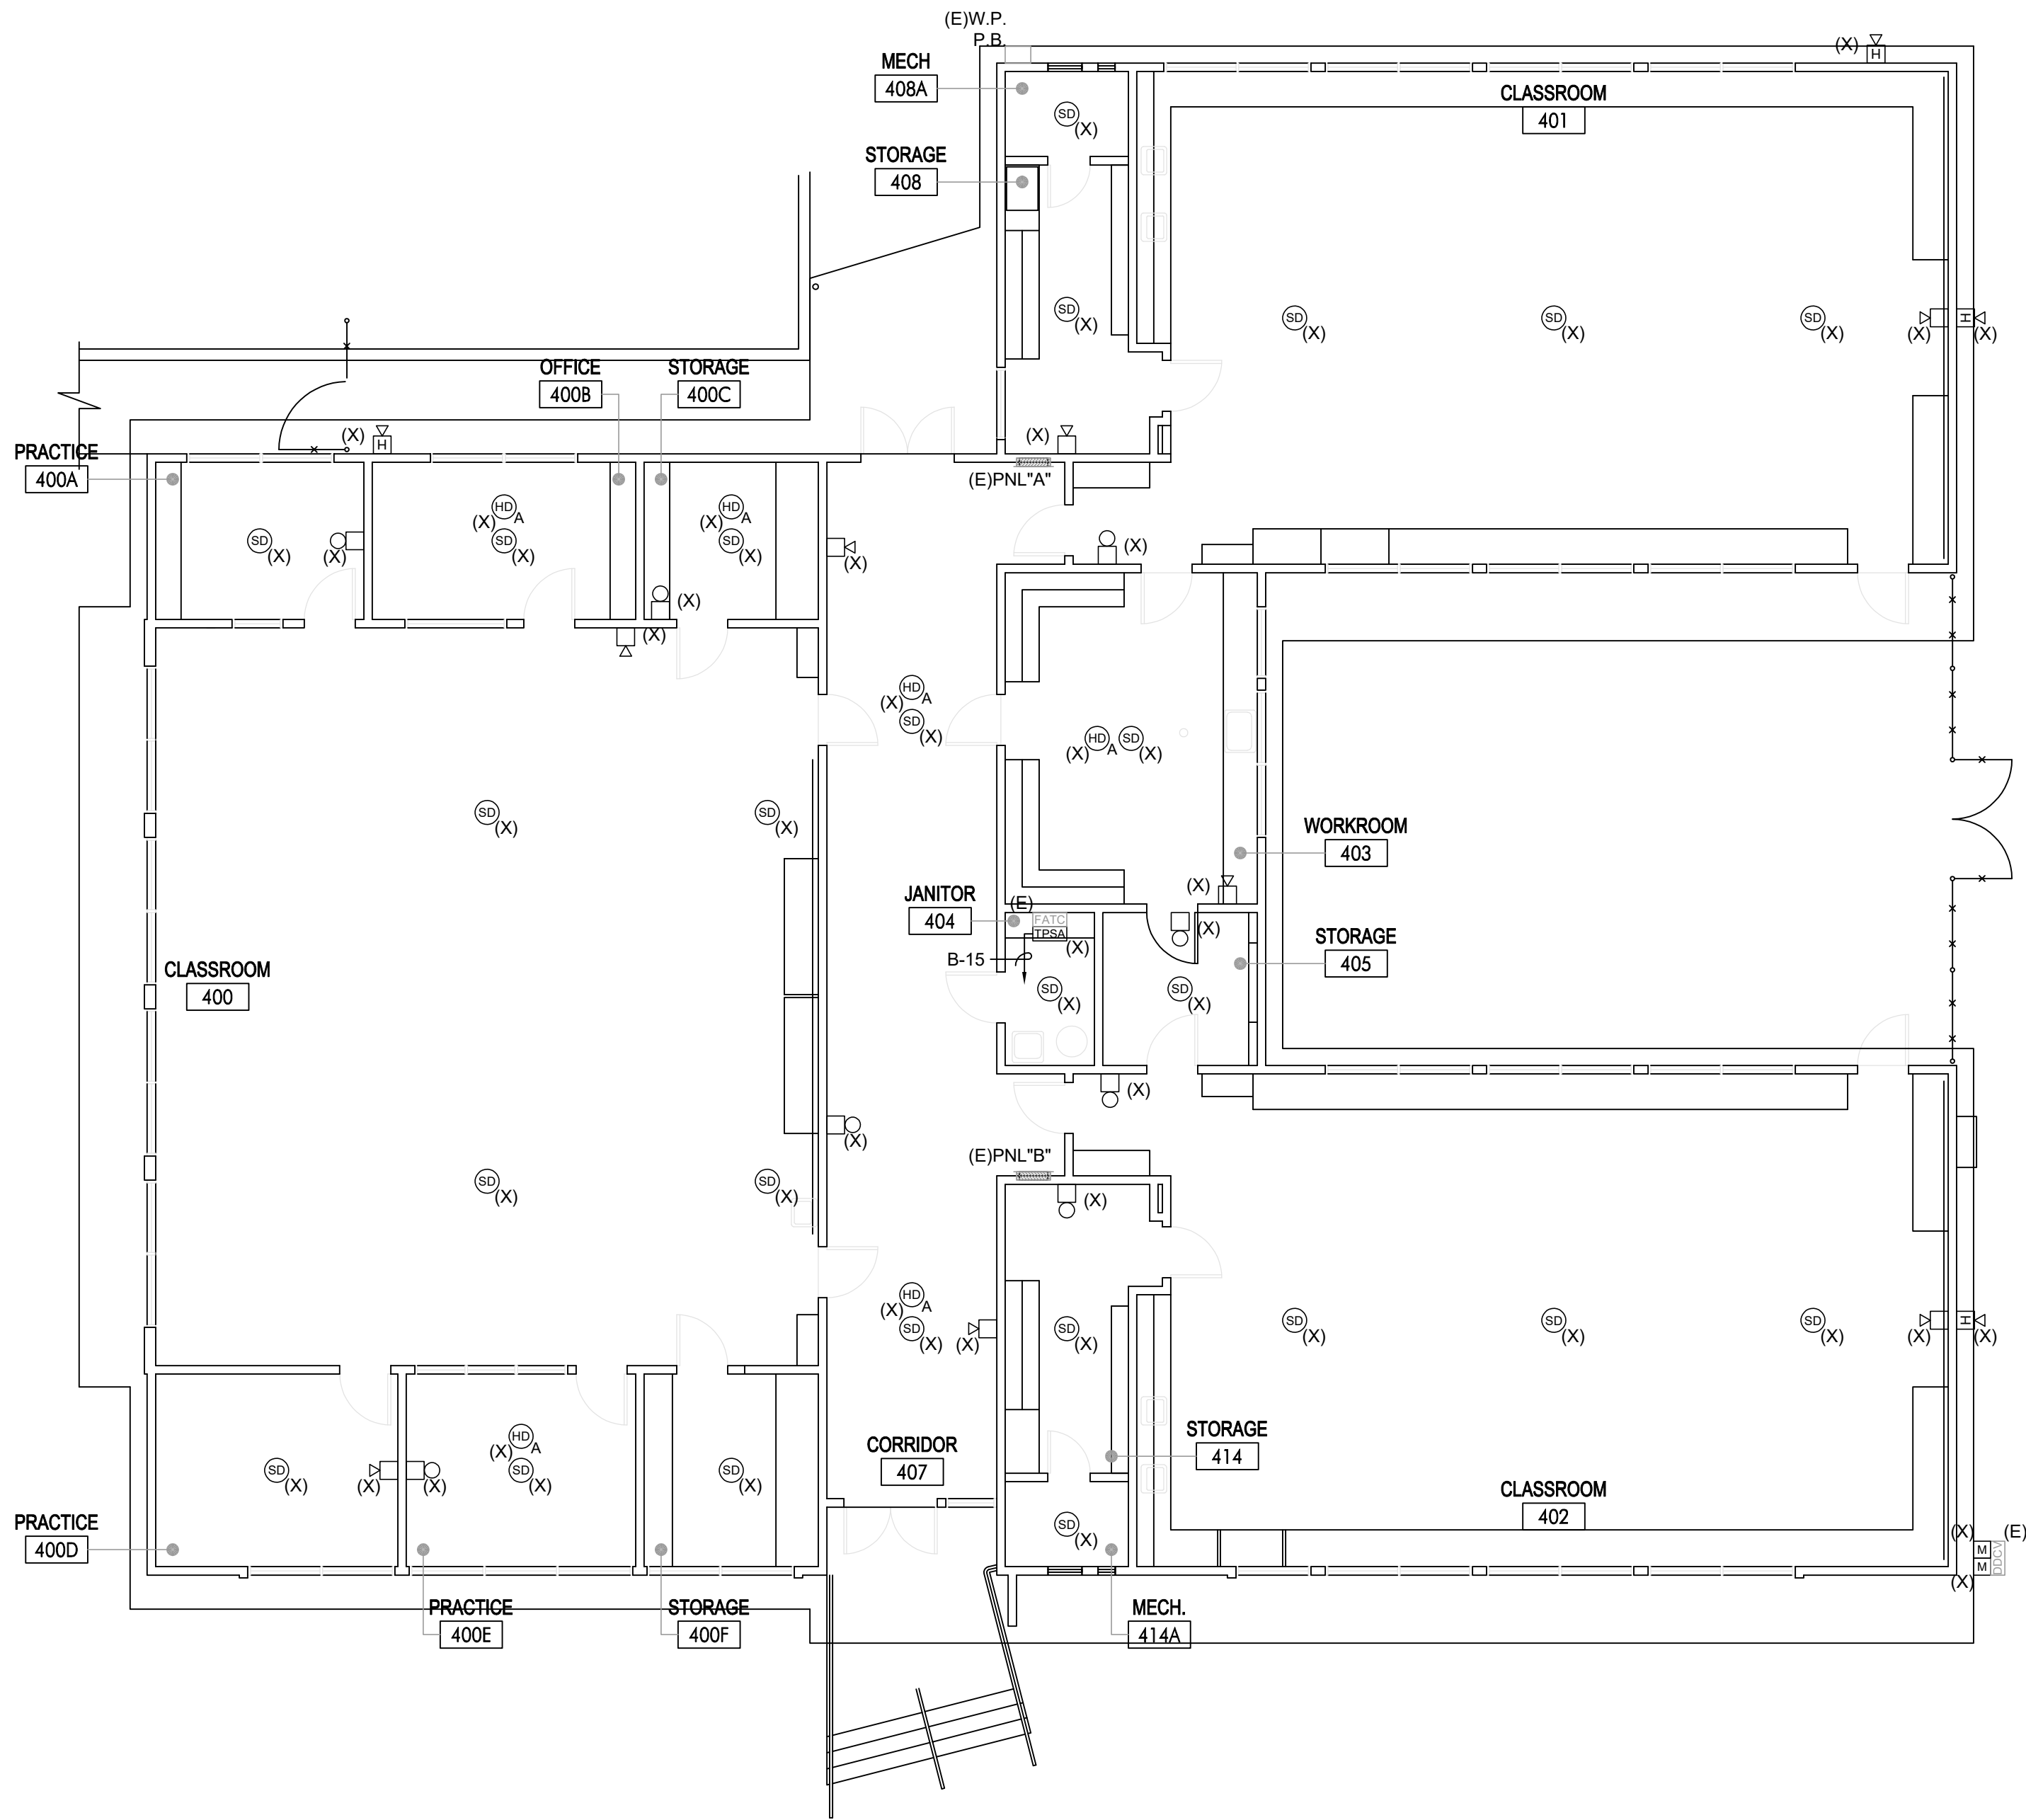


Sheet Title
Fire Alarm
Demolition
Site Plan

Sheet Number

E311

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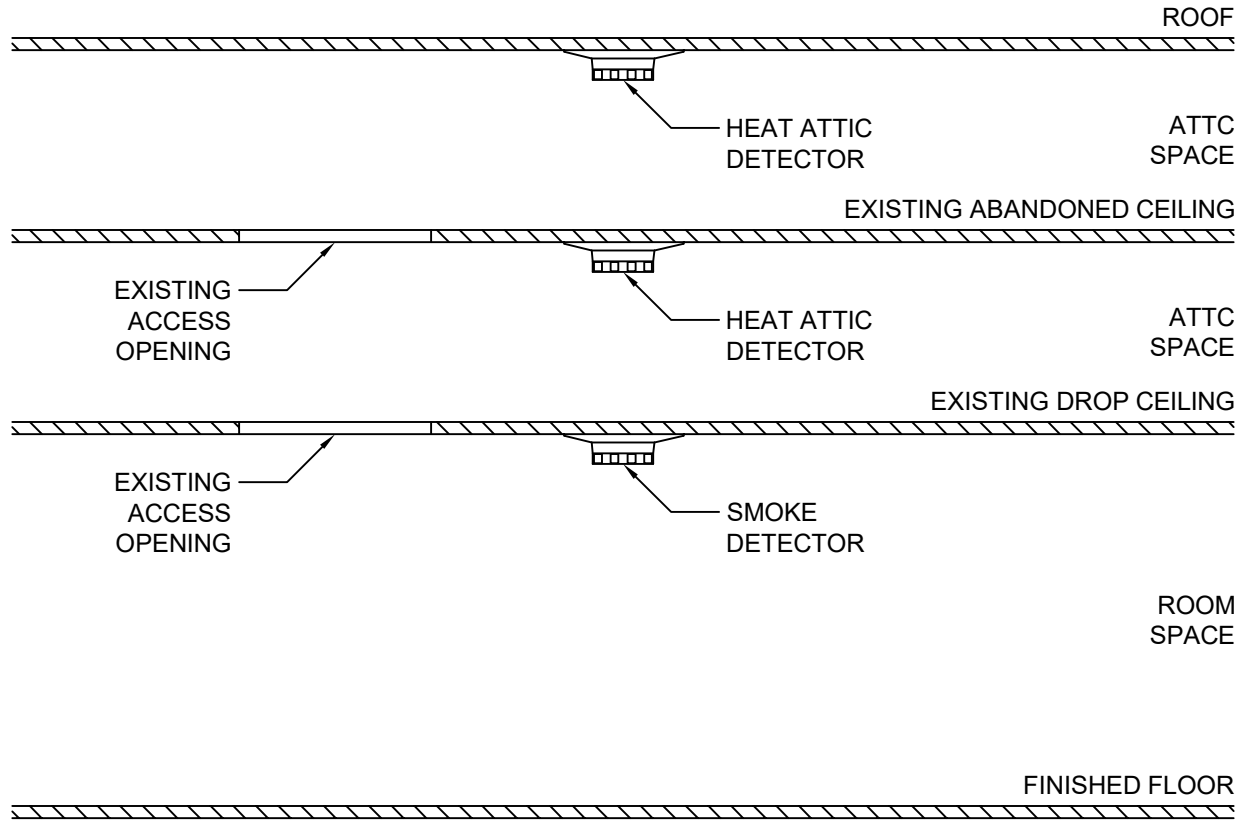
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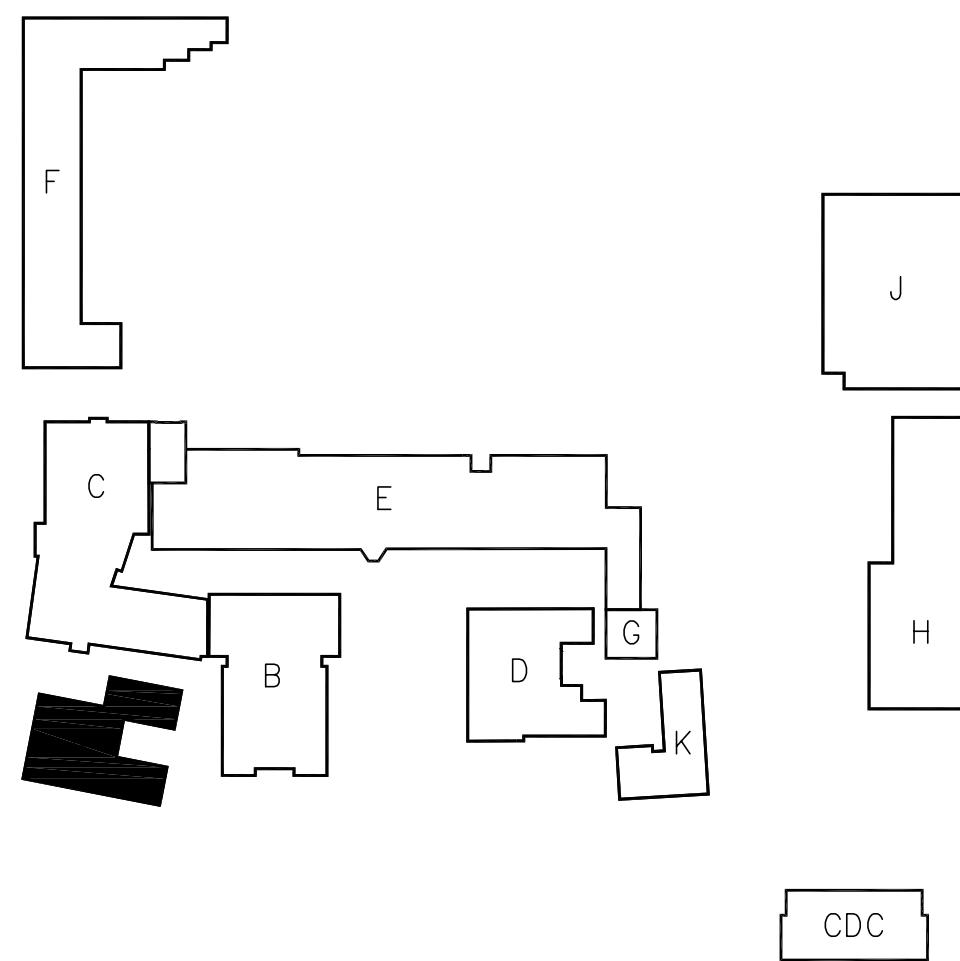
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ATTIC SPACE DETAIL



KEY PLAN



BUILDING "A" - FIRE ALARM DEMOLITION PLAN

SCALE	1
1/8" = 1'-0"	

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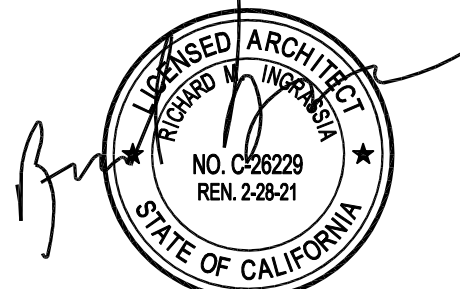
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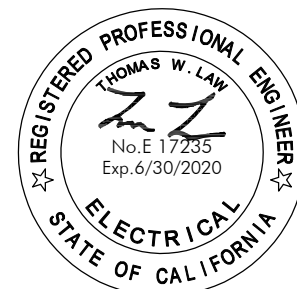
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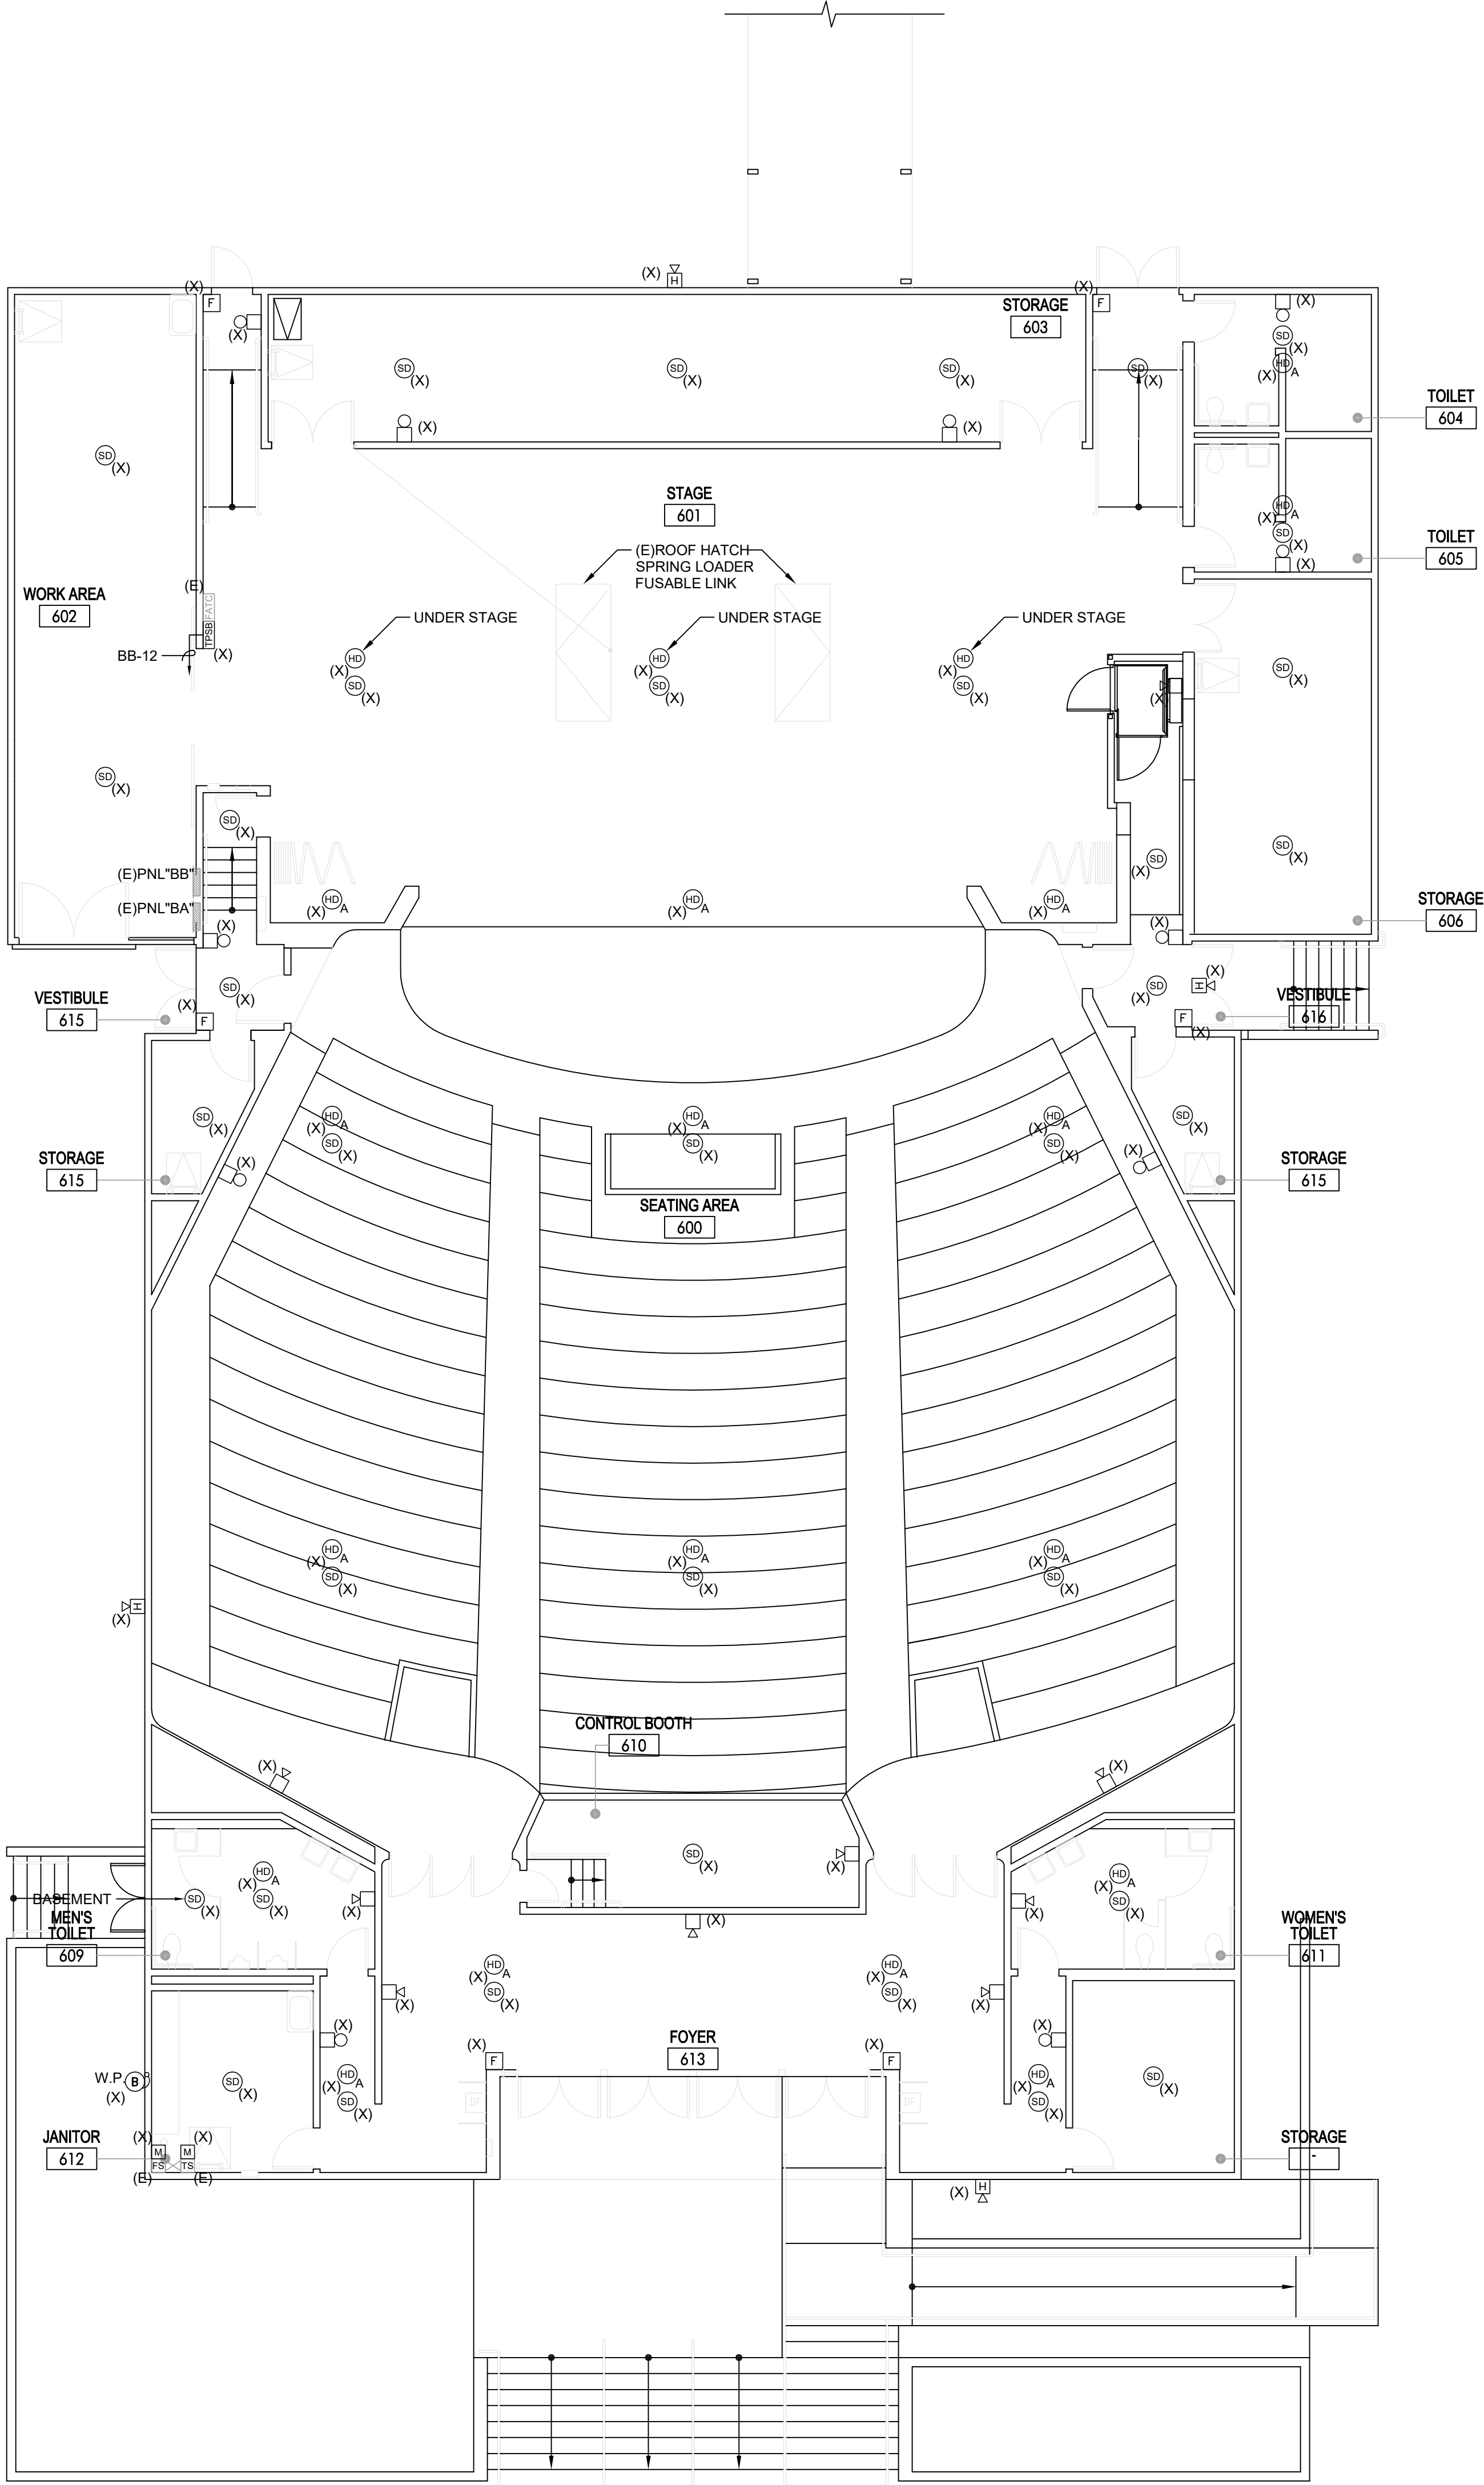


Sheet Title

Fire Alarm
Demolition
Building "A"
Floor Plan

Sheet Number

EA311



GENERAL NOTES

1.

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REFERENCE NOTES

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KEY PLAN

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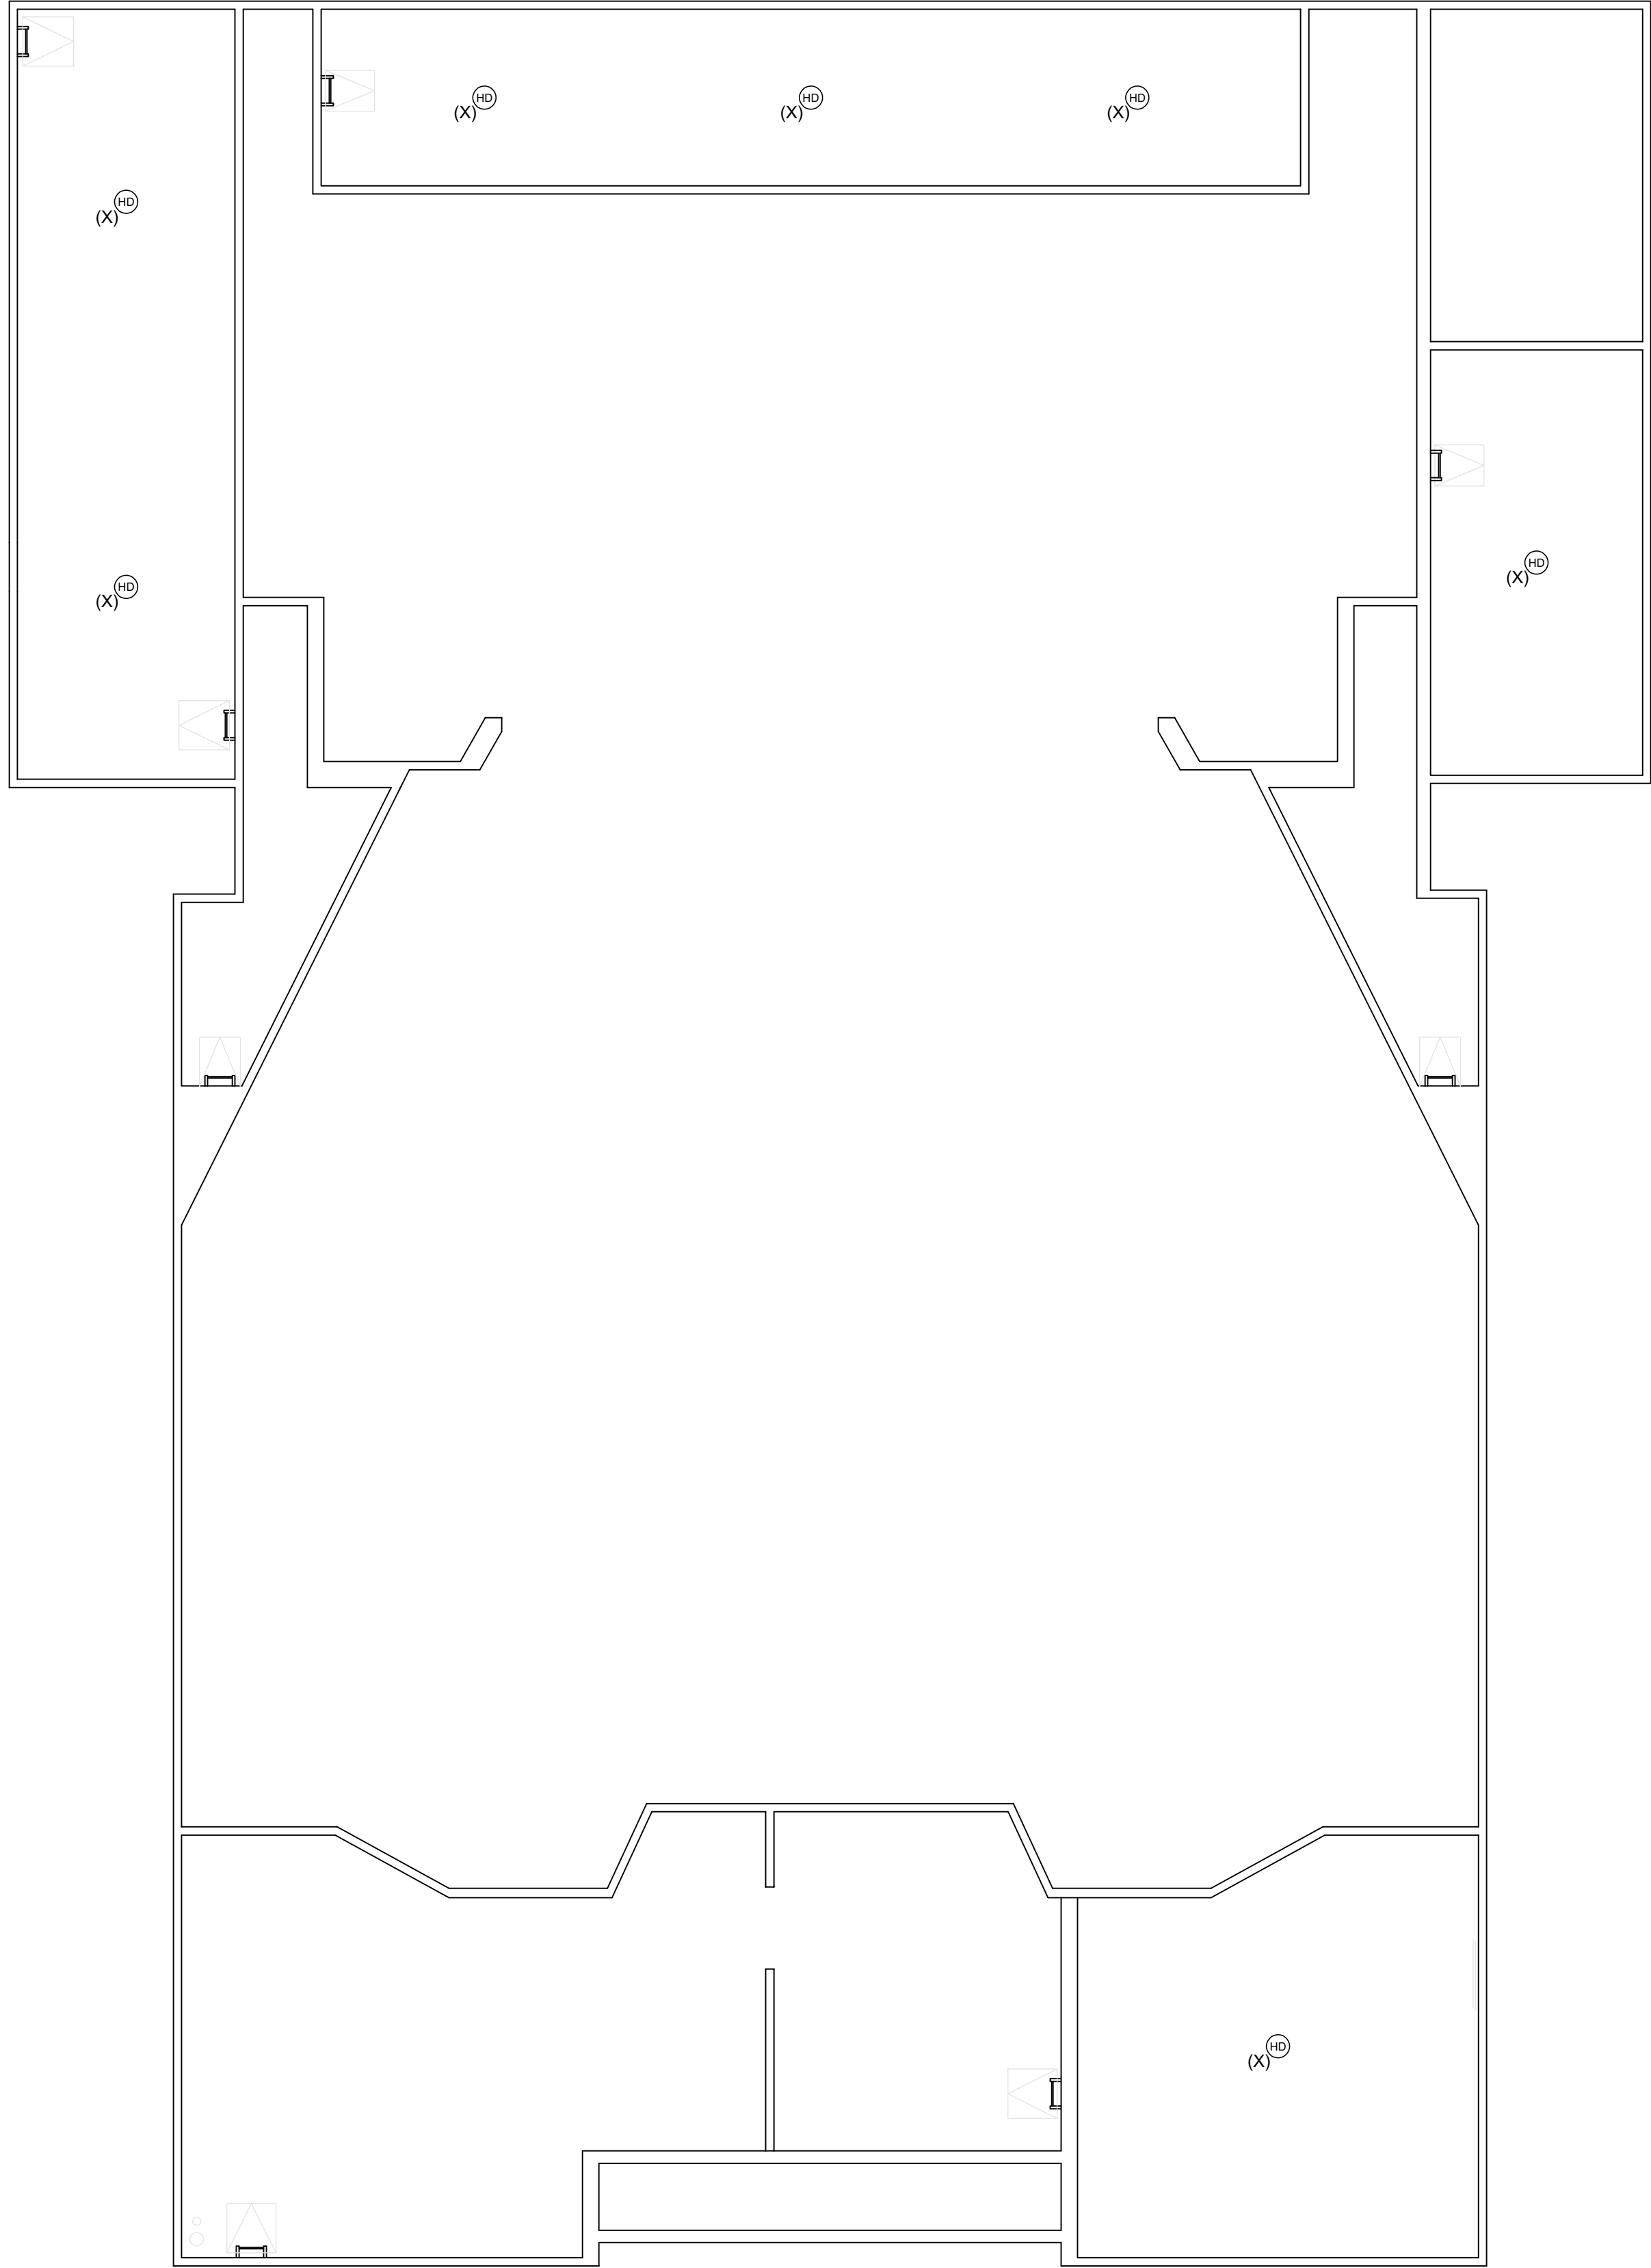
Demolition

Building "B"

Floor Plan

Sheet Number

EB311



BUILDING "B" - FIRE ALARM DEMOLITION MEZZANINE PLAN

SCALE
1/8" = 1'-0"

1



KEY PLAN

GENERAL NOTES

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REFERENCE NOTES

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Sheet Title

Fire Alarm
Demolition
Building "B"
Mezzanine Floor
Plan

Sheet Number

EB312



BUILDING "C" - FIRE ALARM DEMOLITION FIRST FLOOR PLAN

SCALE
1/8" = 1'-0"

1

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REFERENCE NOTES

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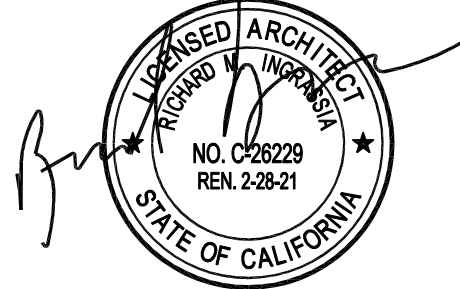
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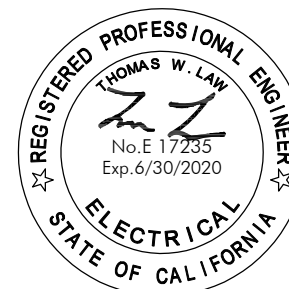
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Sheet Title

Fire Alarm
Demolition
Building "C"
First Floor Plan

Sheet Number

EC311



BUILDING "C" - FIRE ALARM DEMOLITION SECOND FLOOR PLAN

SCALE
1/8" = 1'-0"

1

GENERAL NOTES

1. ALL EXISTING FIRE ALARM SYSTEM EQUIPMENT/DEVICES SHOWN ARE FROM AVAILABLE RECORD DRAWINGS. ENGINEER ASSUMES NO RESPONSIBILITY FOR ACCURACY AND CONTRACTOR SHALL FIELD VERIFY AND PROVIDE ANY REMEDIATION TO PROVIDE FULLY OPERABLE FIRE ALARM SYSTEM.
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REFERENCE NOTES

① NOT USED

APPL. No. A 00-123456

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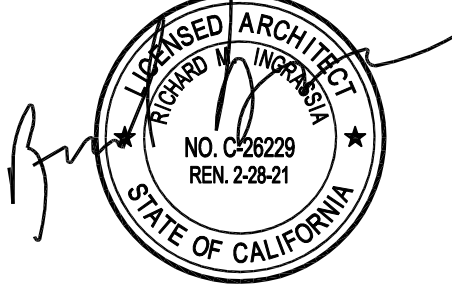
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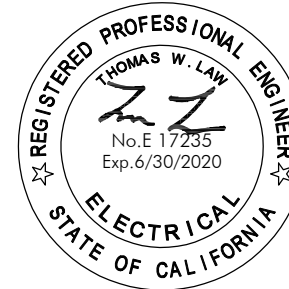
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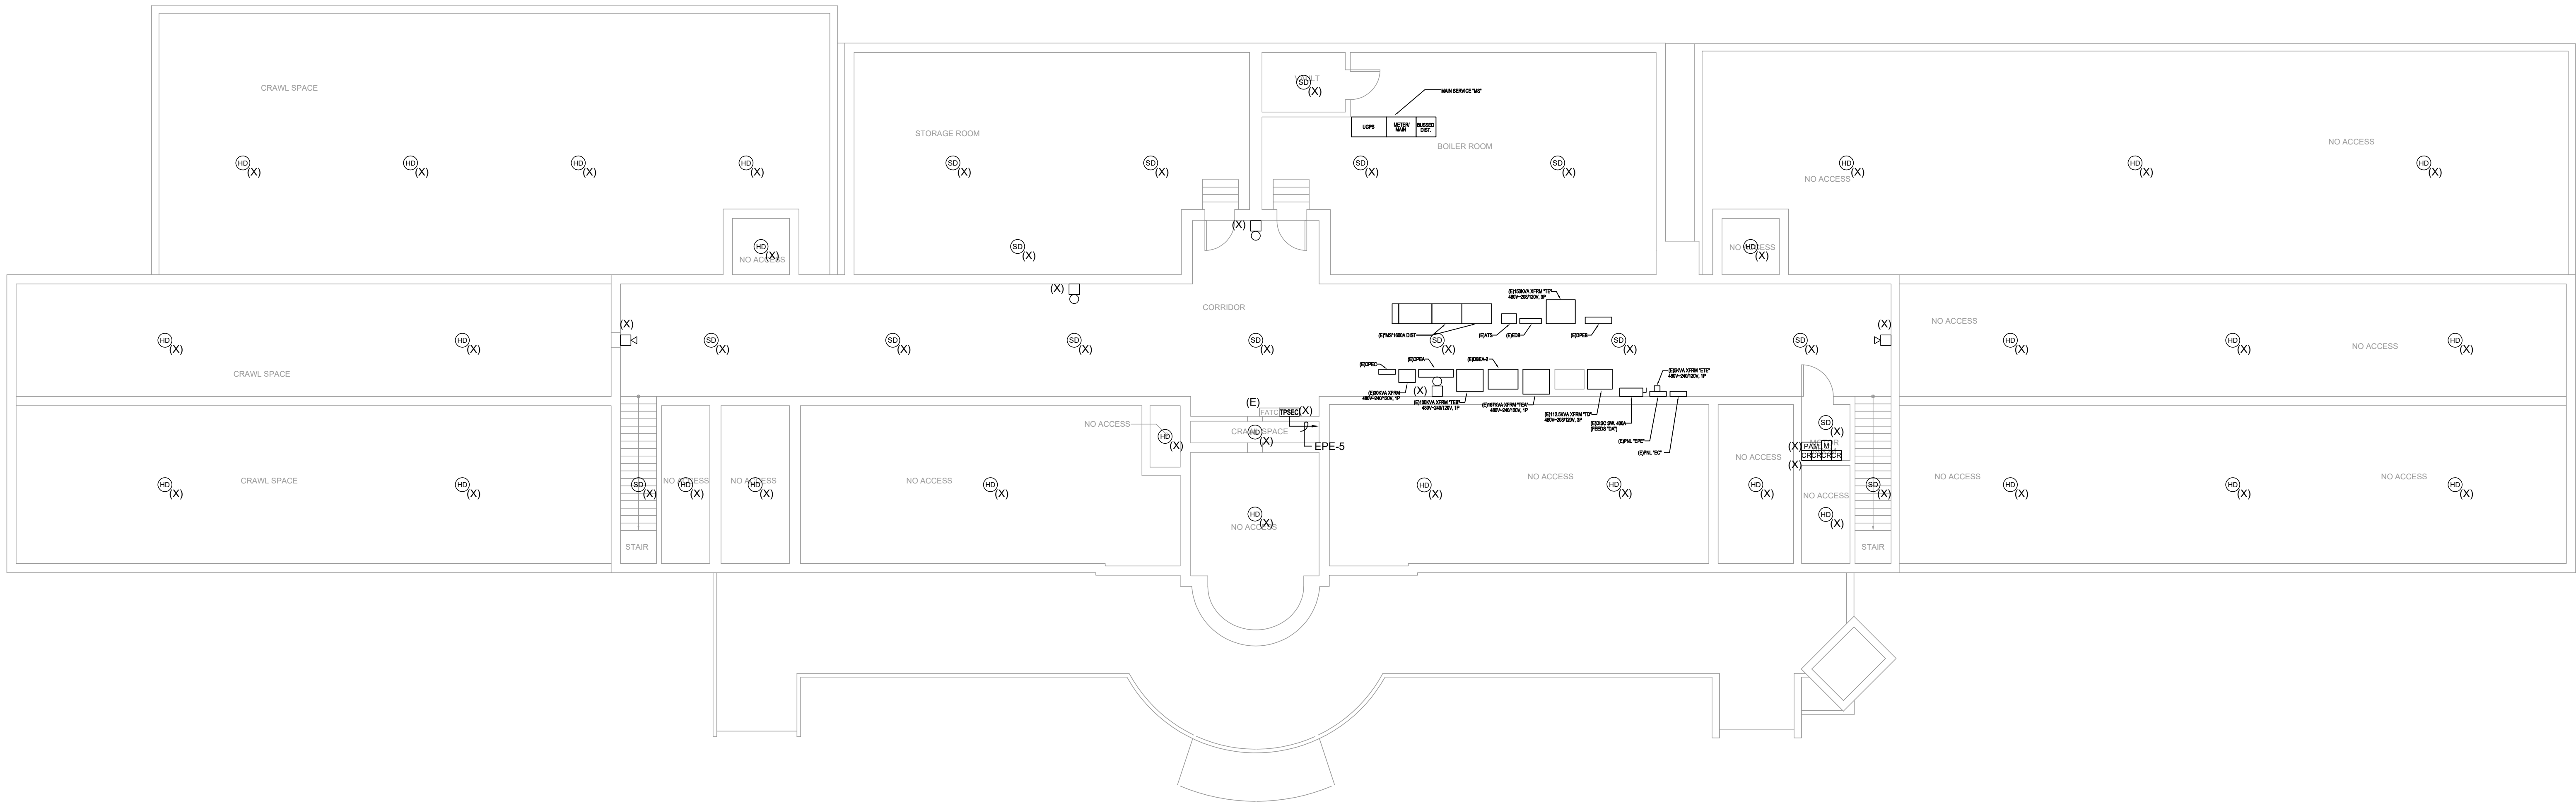
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Fire Alarm
Demolition
Building "C"
Second Floor Plan

Sheet Number

EC312

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BUILDING "E" - FIRE ALARM DEMOLITION BASEMENT FLOOR PLAN

SCALE
1/8" = 1'-0" 1


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REFERENCE NOTES

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- PROVIDE (2) DEDICATED PHONE LINES (ANALOG) TO MDF/IDF WITHIN THE BUILDING FOR REMOTE STATION MONITORING.
- PROVIDE A SIGNAGE "FIRE ALARM CONTROL PANEL INSIDE" AT THE DOOR TO FAC/FCPS. SEE DETAIL ON 8/E402. PATCH/PAINT/REPAIR TO MATCH ADJACENT SURFACES

KEY PLAN



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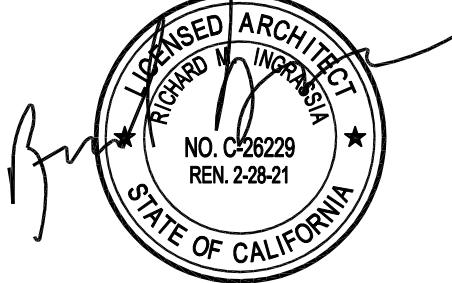
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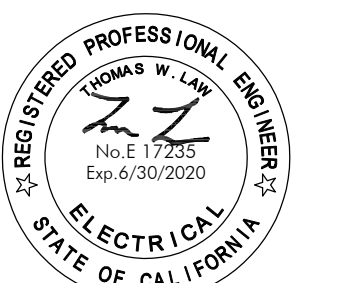
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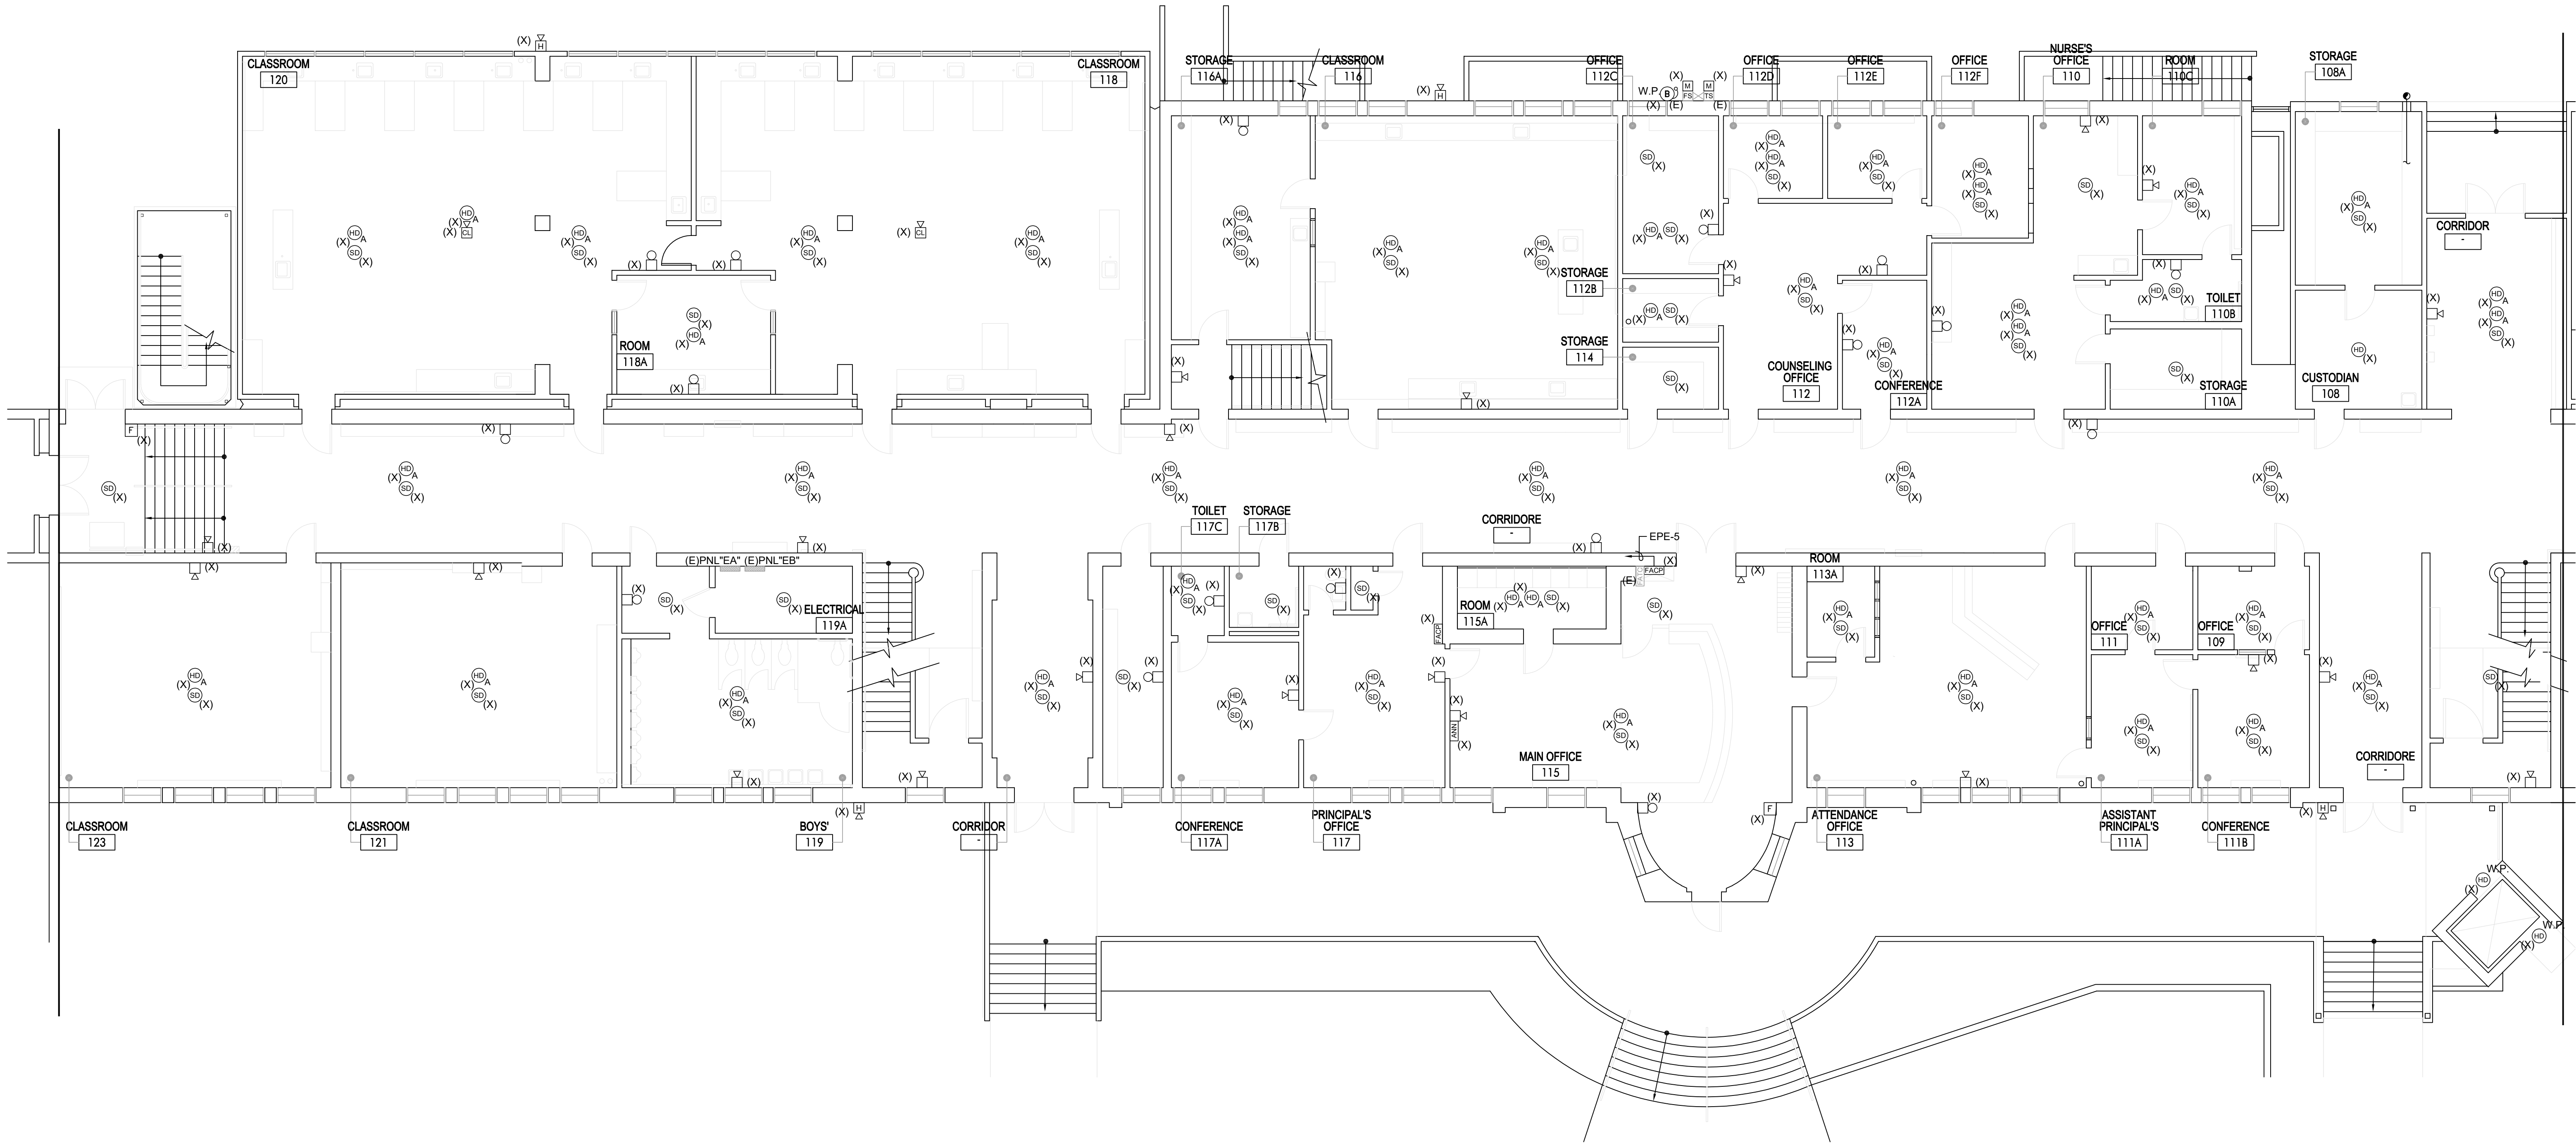
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Fire Alarm
Demolition
Building "E"
Basement Floor Plan

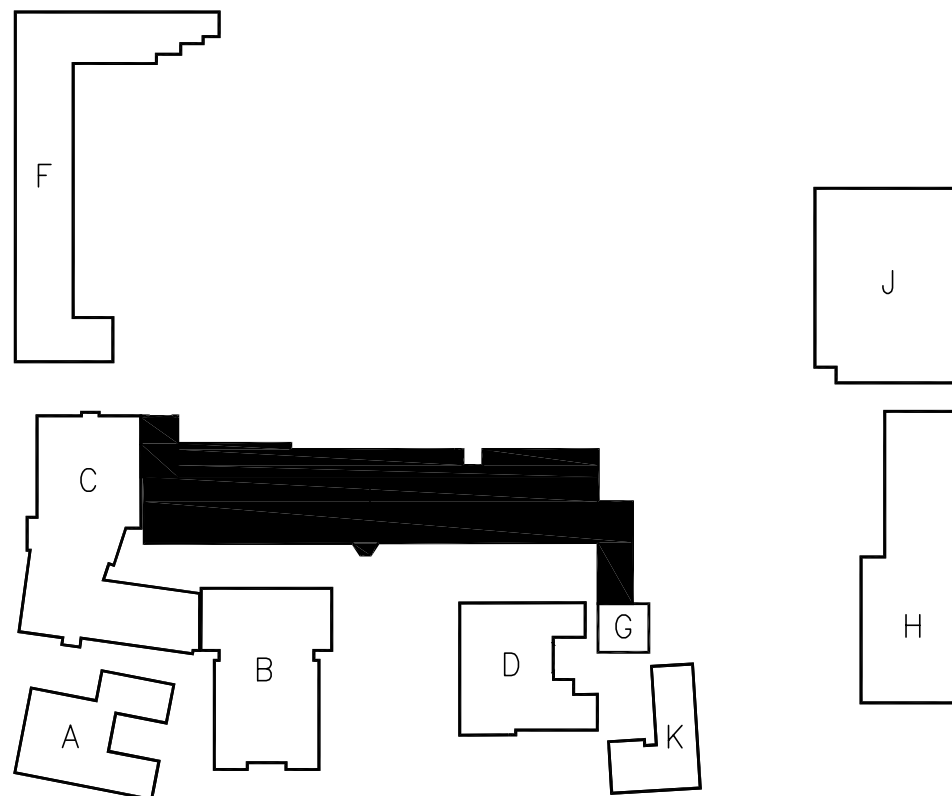Sheet Number

EE310


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BUILDING "E" - FIRE ALARM DEMOLITION FIRST FLOOR PLAN

SCALE
1/8" = 1'-0" 1

ATTIC SPACE DETAIL




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REFERENCE NOTES

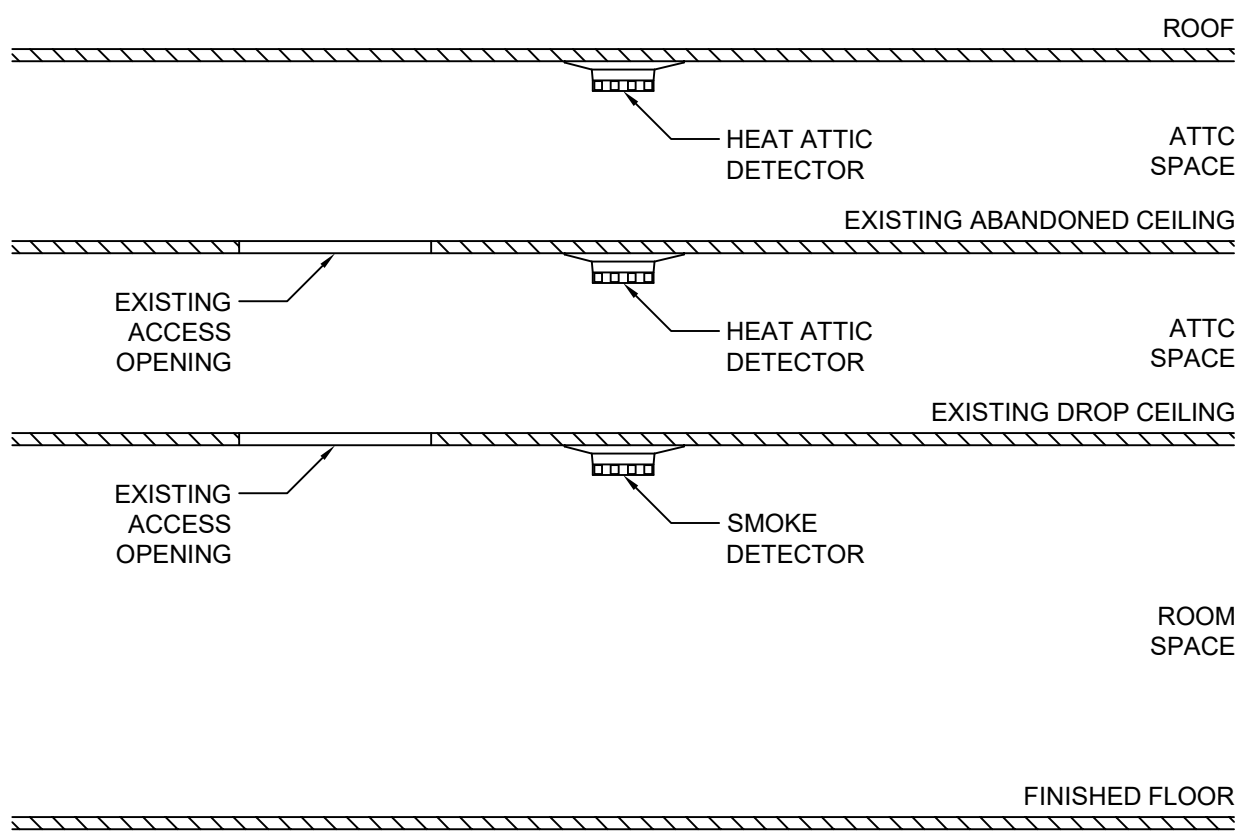① NOT USED

KEY PLAN



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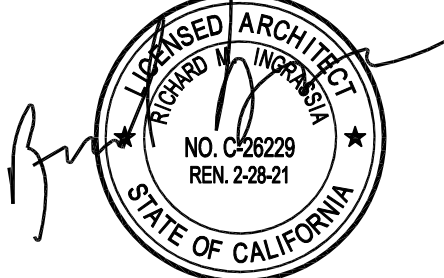
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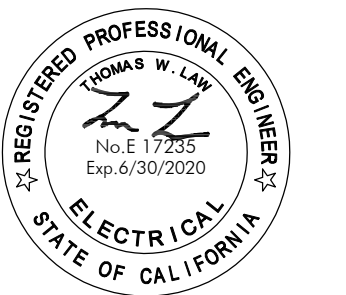
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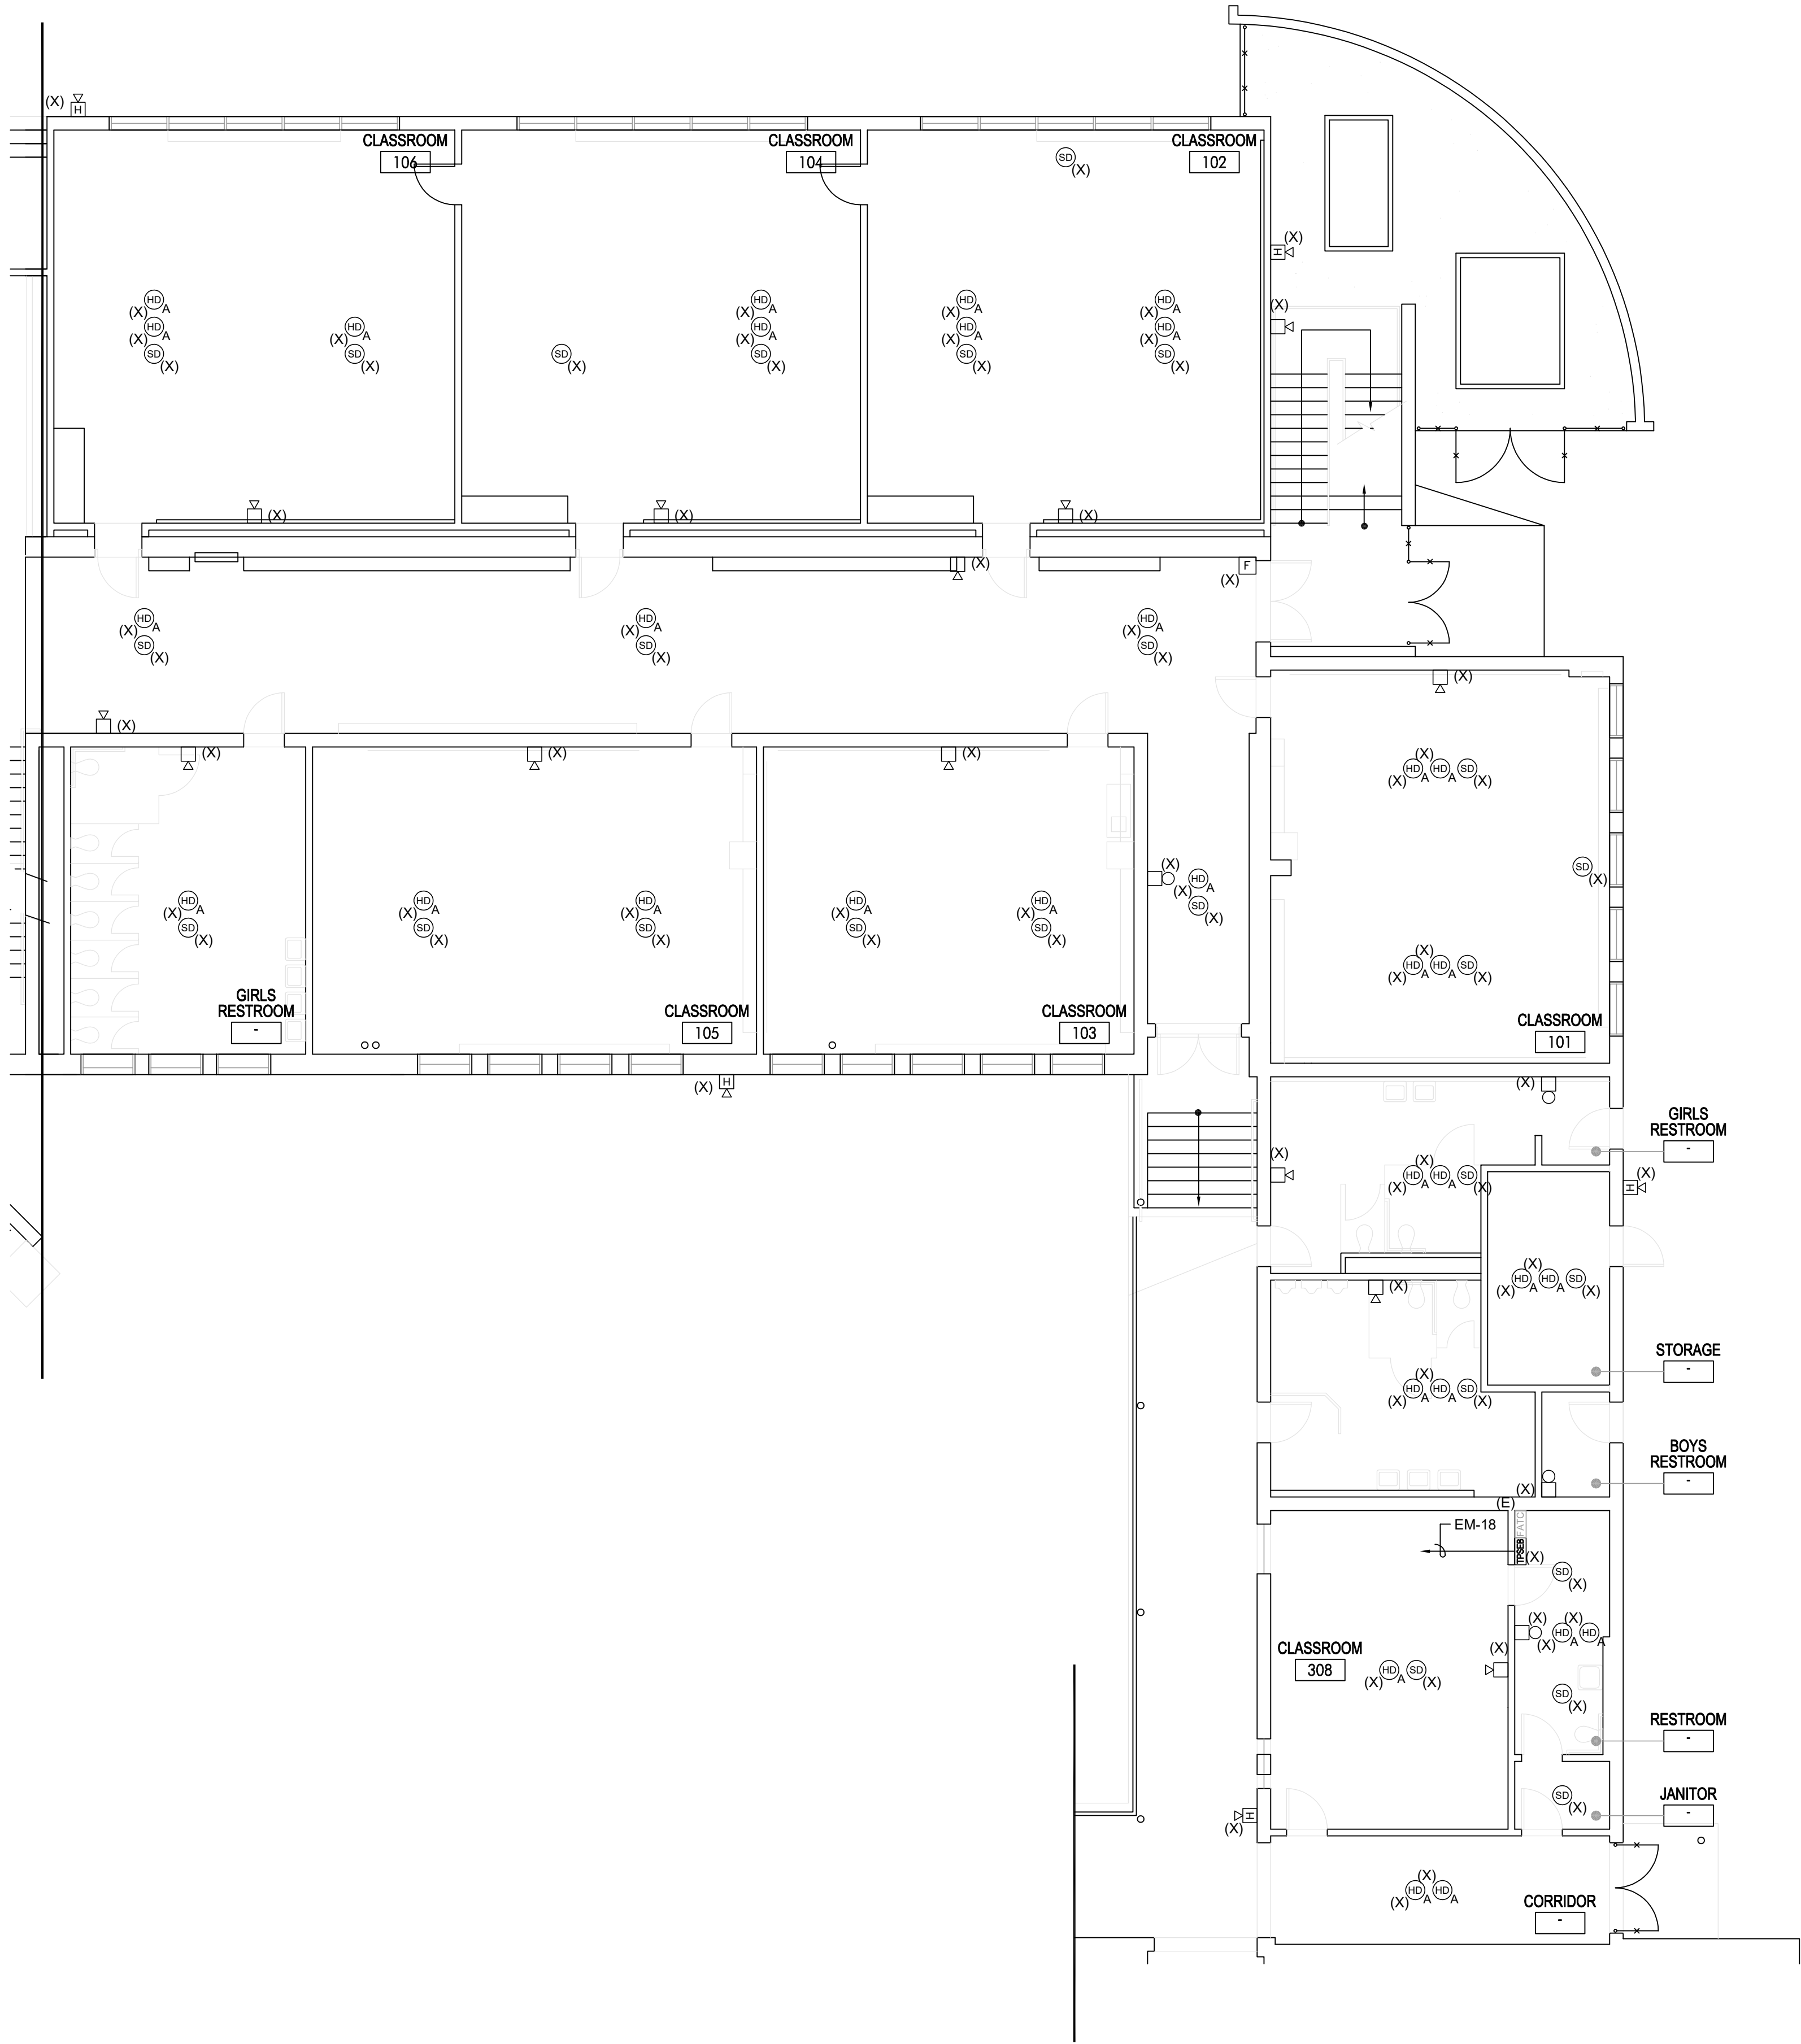


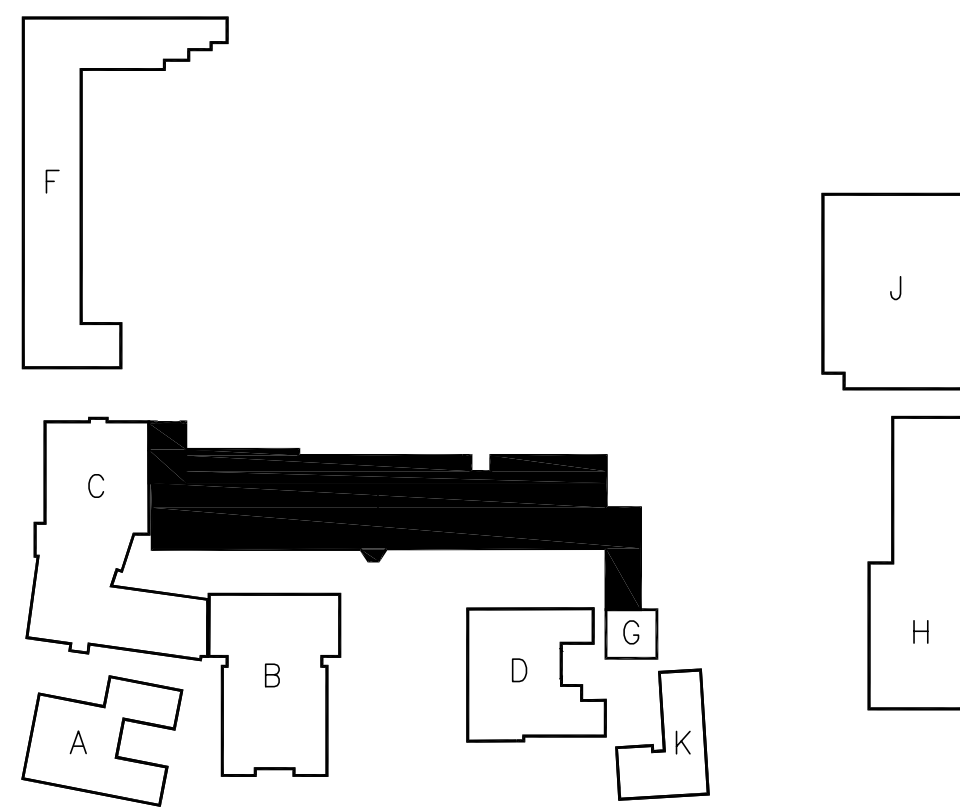Sheet Title

Fire Alarm
Demolition
Building "E"
First Floor Plan

Sheet Number

EE311A




BUILDING "E" - FIRE ALARM DEMOLITION FIRST FLOOR PLAN

SCALE
1/8" = 1'-0"

1

ATTIC SPACE DETAIL

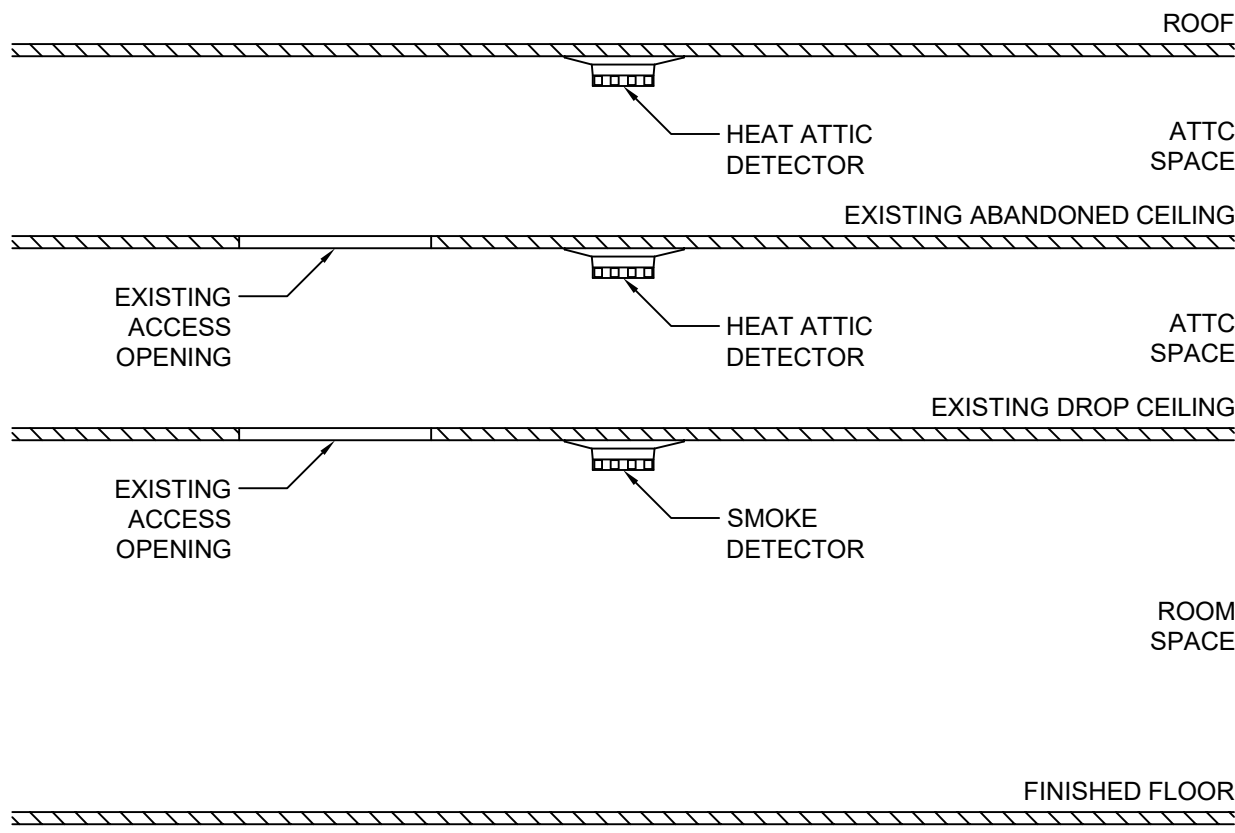


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KEY PLAN



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Architect



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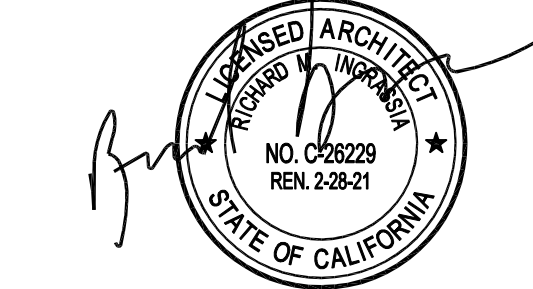
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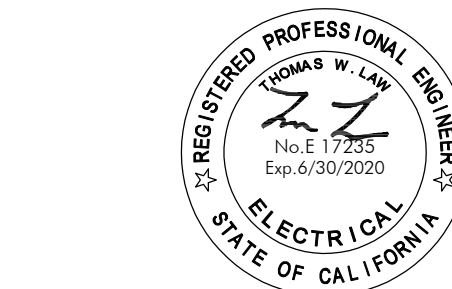
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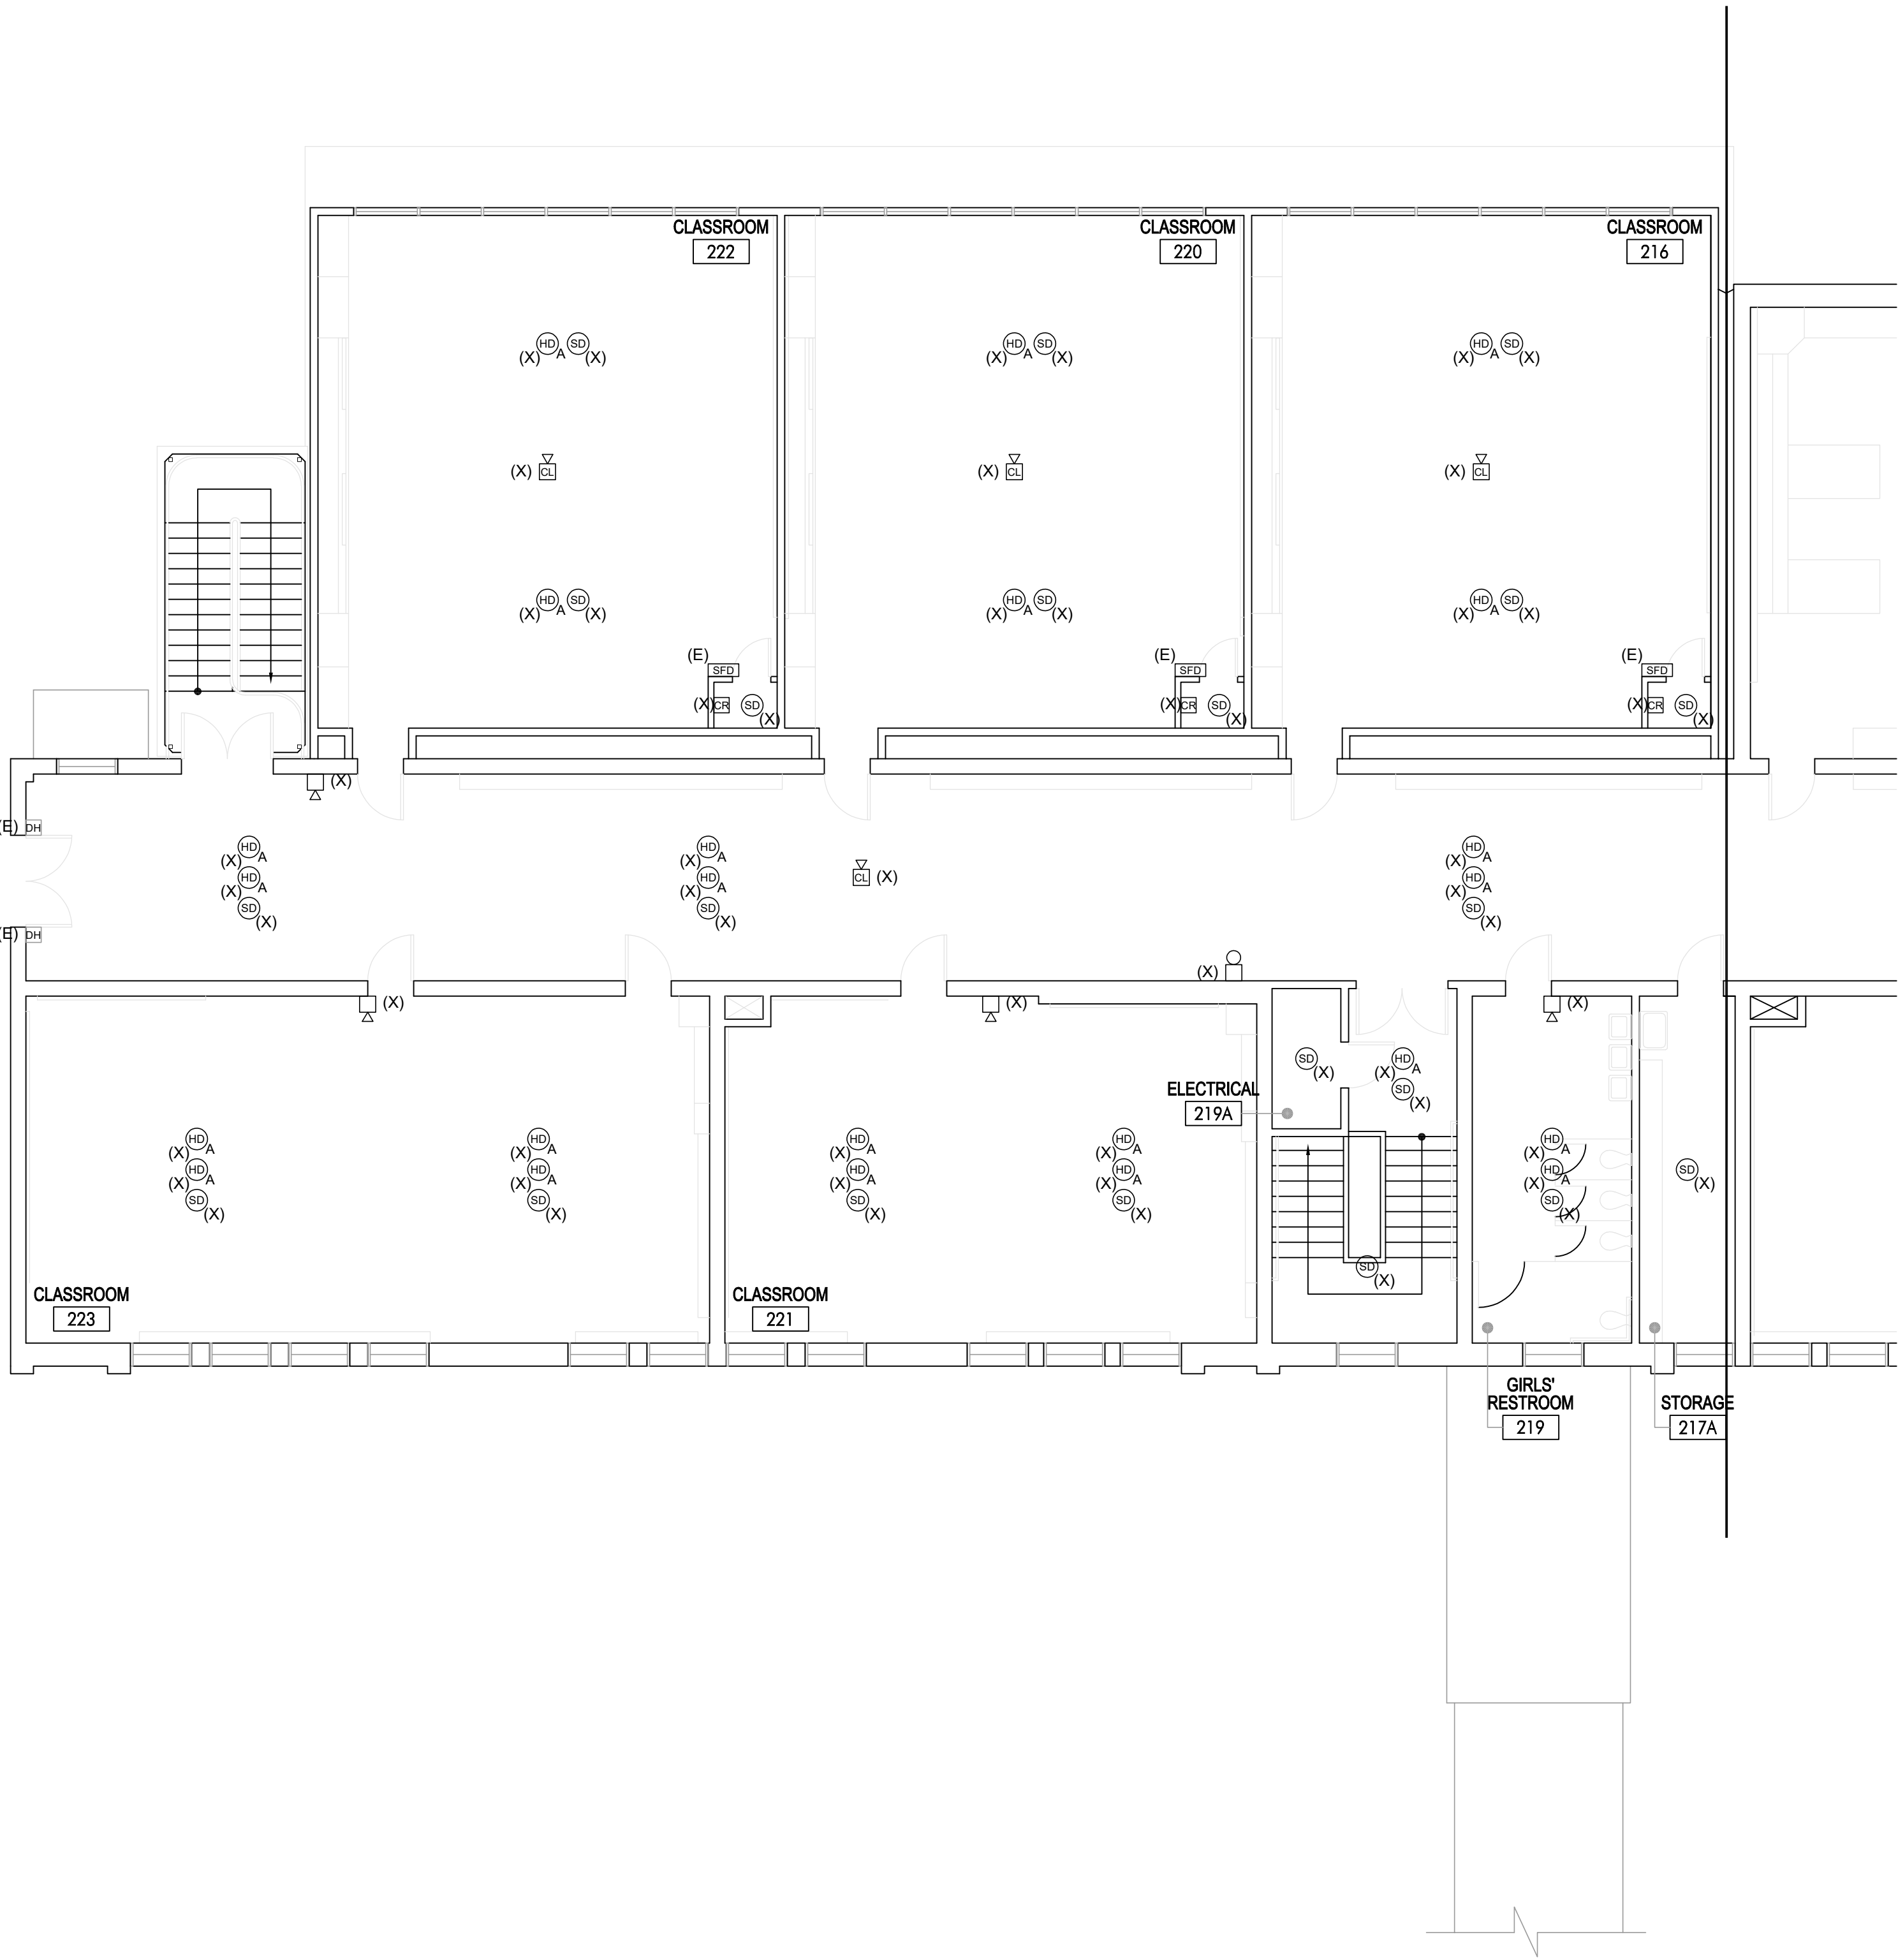
Sheet Title

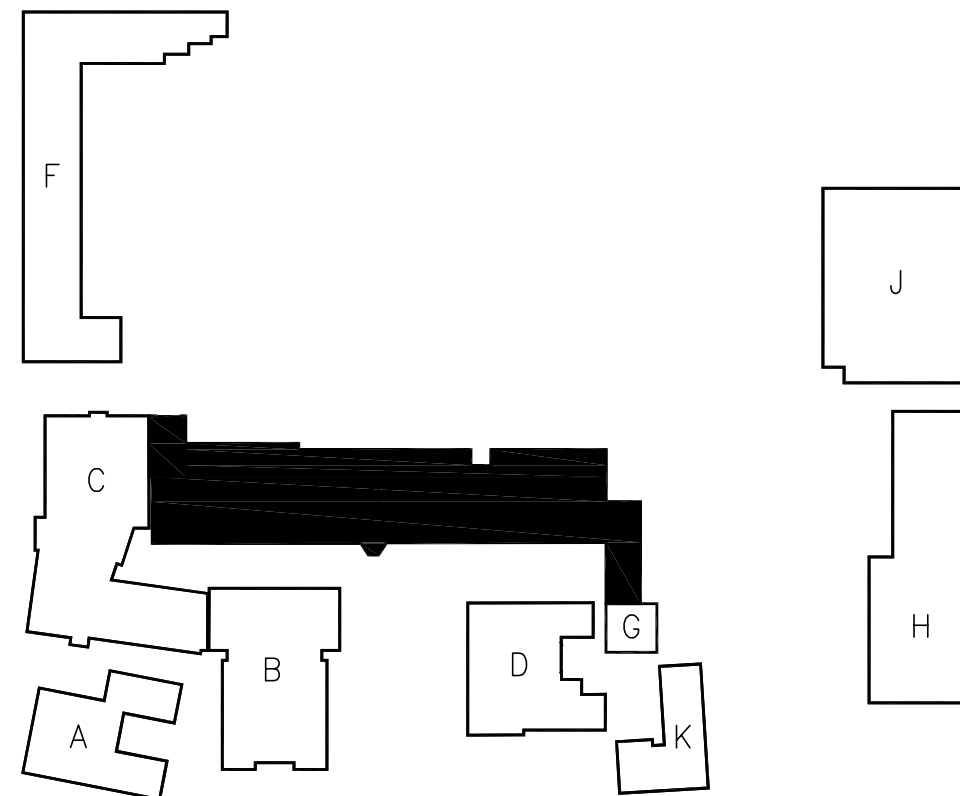Fire Alarm
Demolition
Building "E"
First Floor Plan

Sheet Number

EE311B


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BUILDING "E" - FIRE ALARM DEMOLITION SECOND FLOOR PLAN

SCALE
1/8" = 1'-0" 1

ATTIC SPACE DETAIL




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REFERENCE NOTES

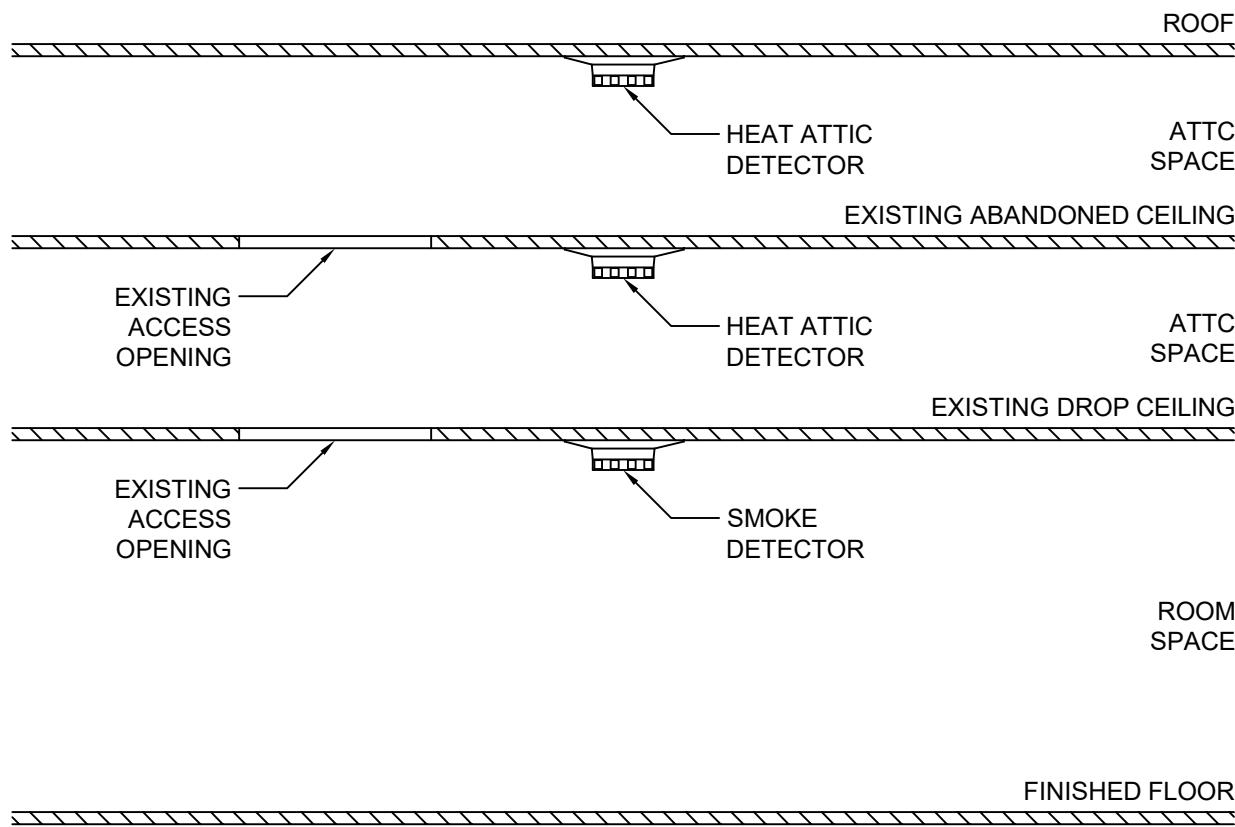① NOT USED

KEY PLAN



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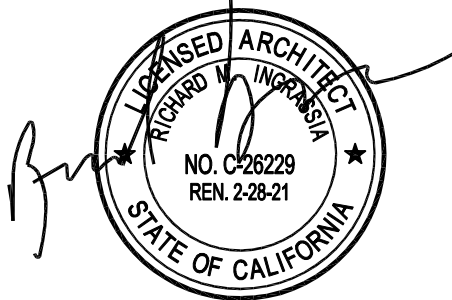
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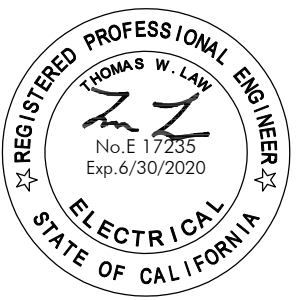
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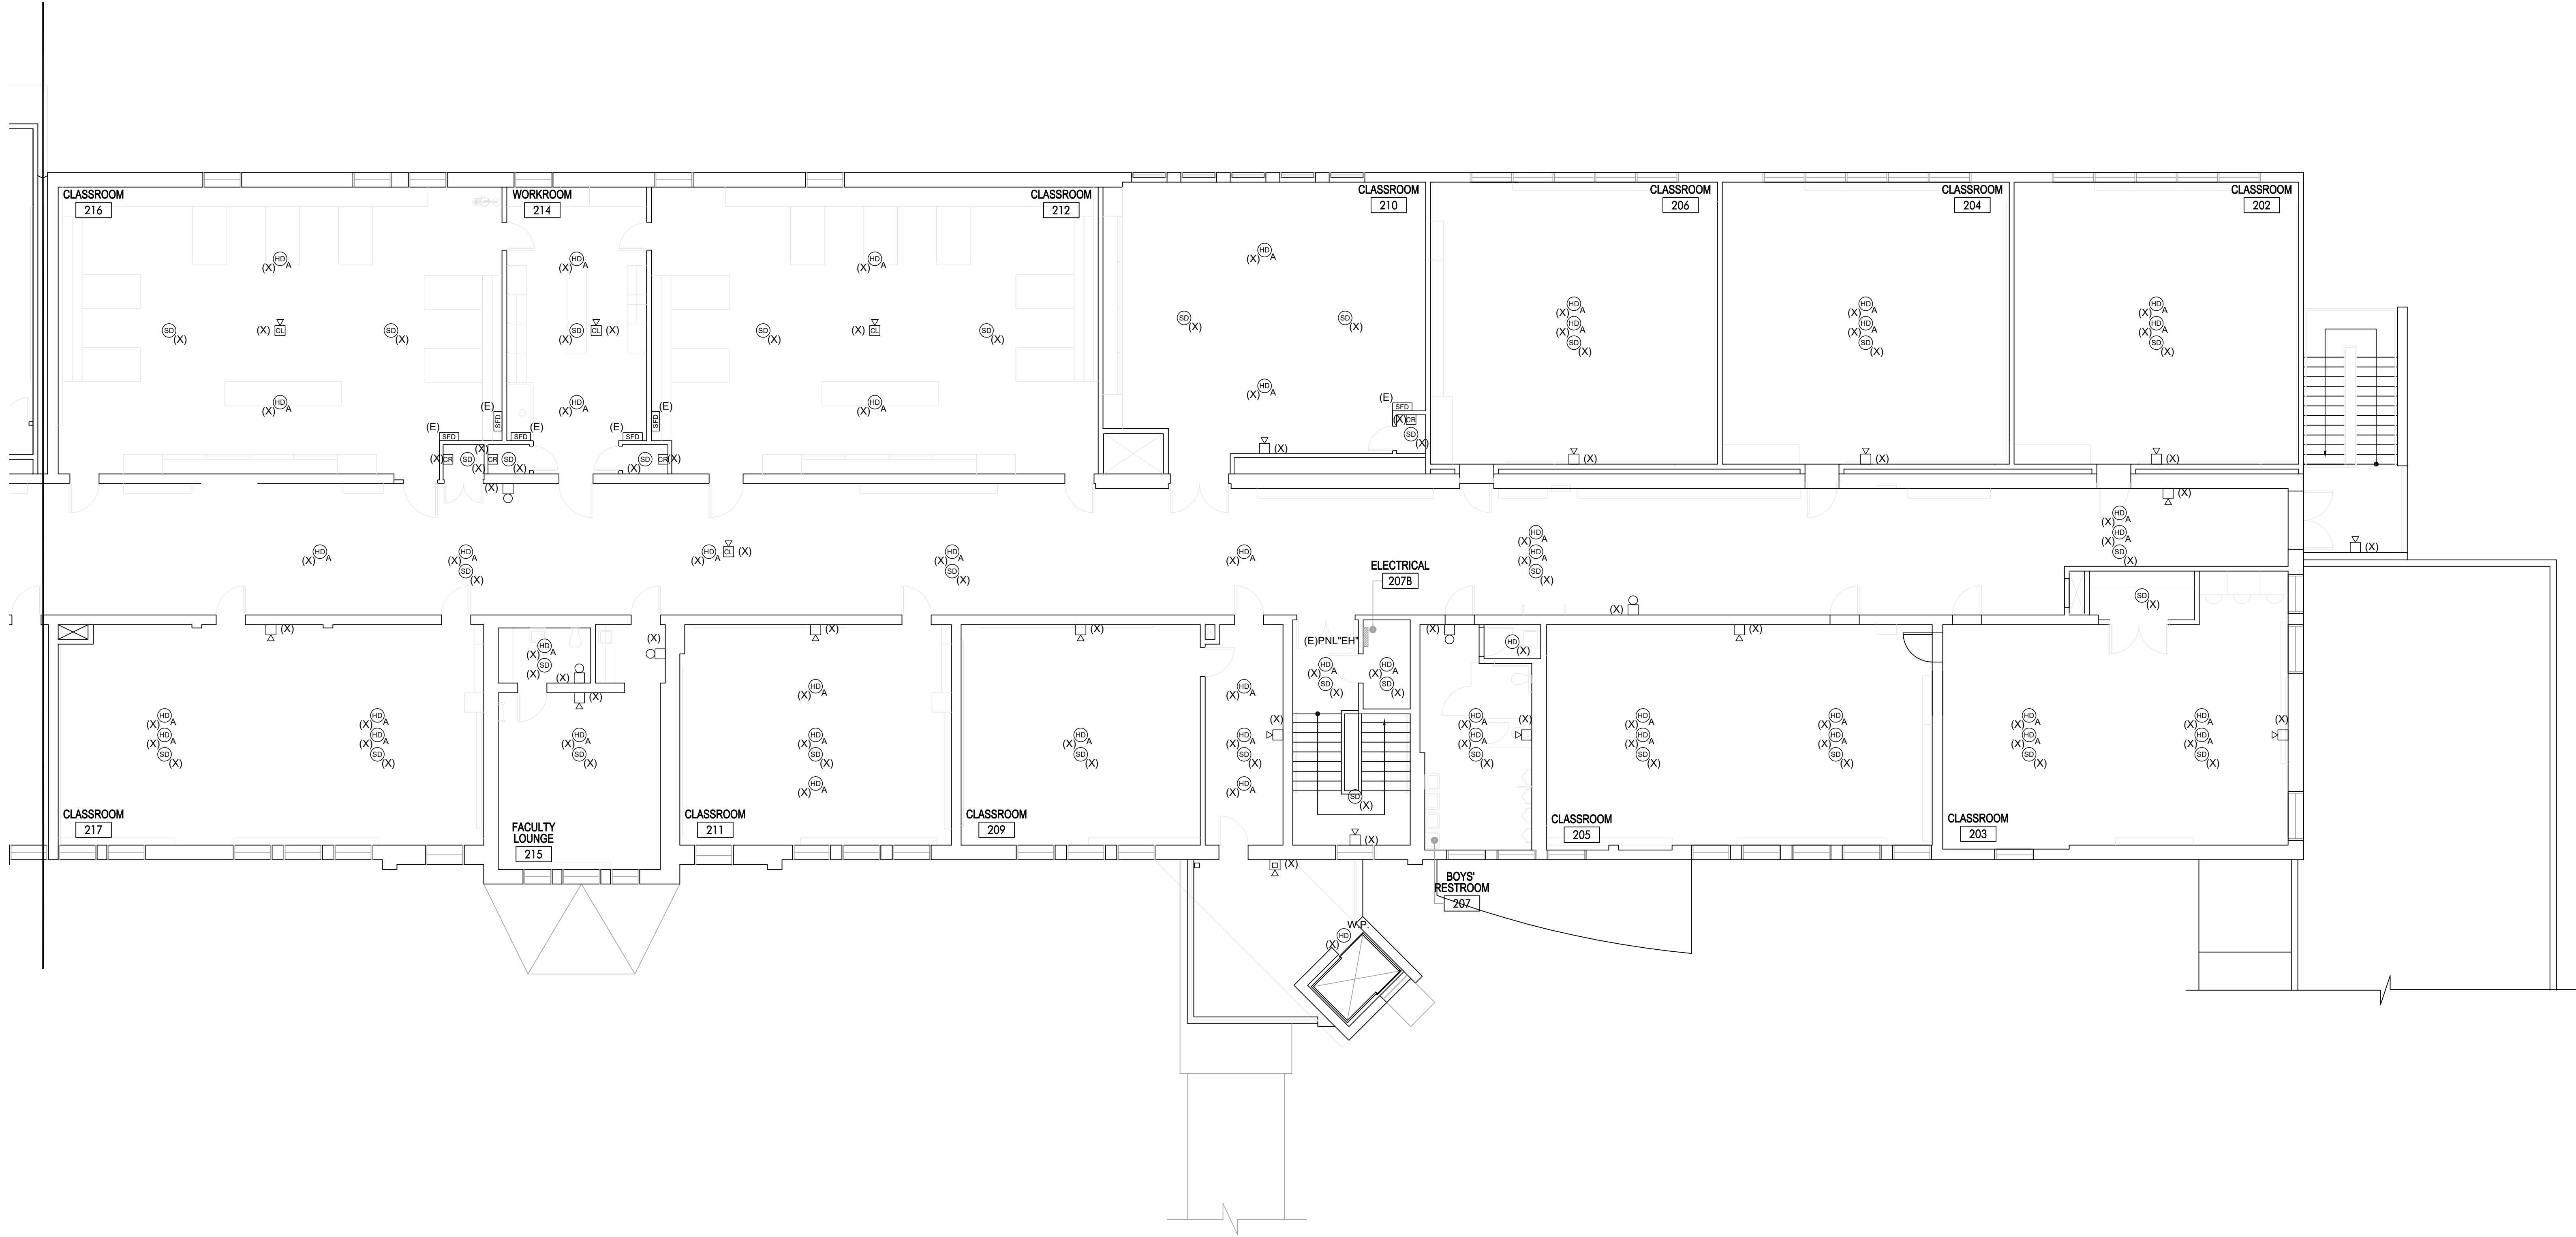
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Sheet Title
Fire Alarm
Demolition
Building "E"
Second Floor Plan

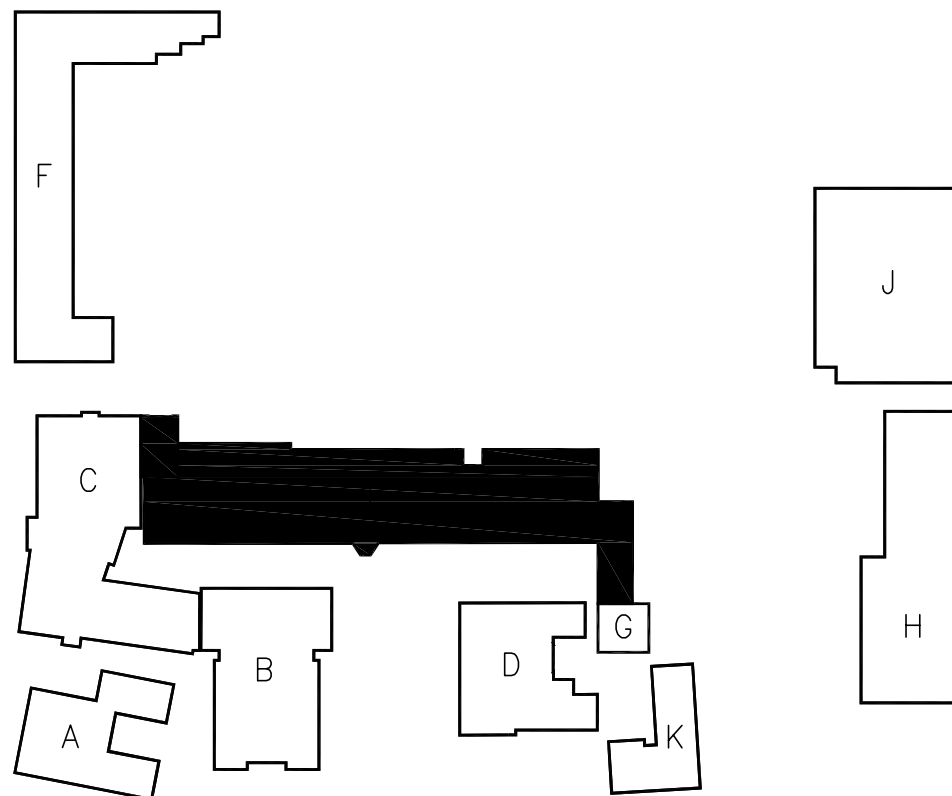Sheet Number


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BUILDING "E" - FIRE ALARM DEMOLITION SECOND FLOOR PLAN

SCALE
1/8" = 1'-0" 1

ATTIC SPACE DETAIL




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REFERENCE NOTES
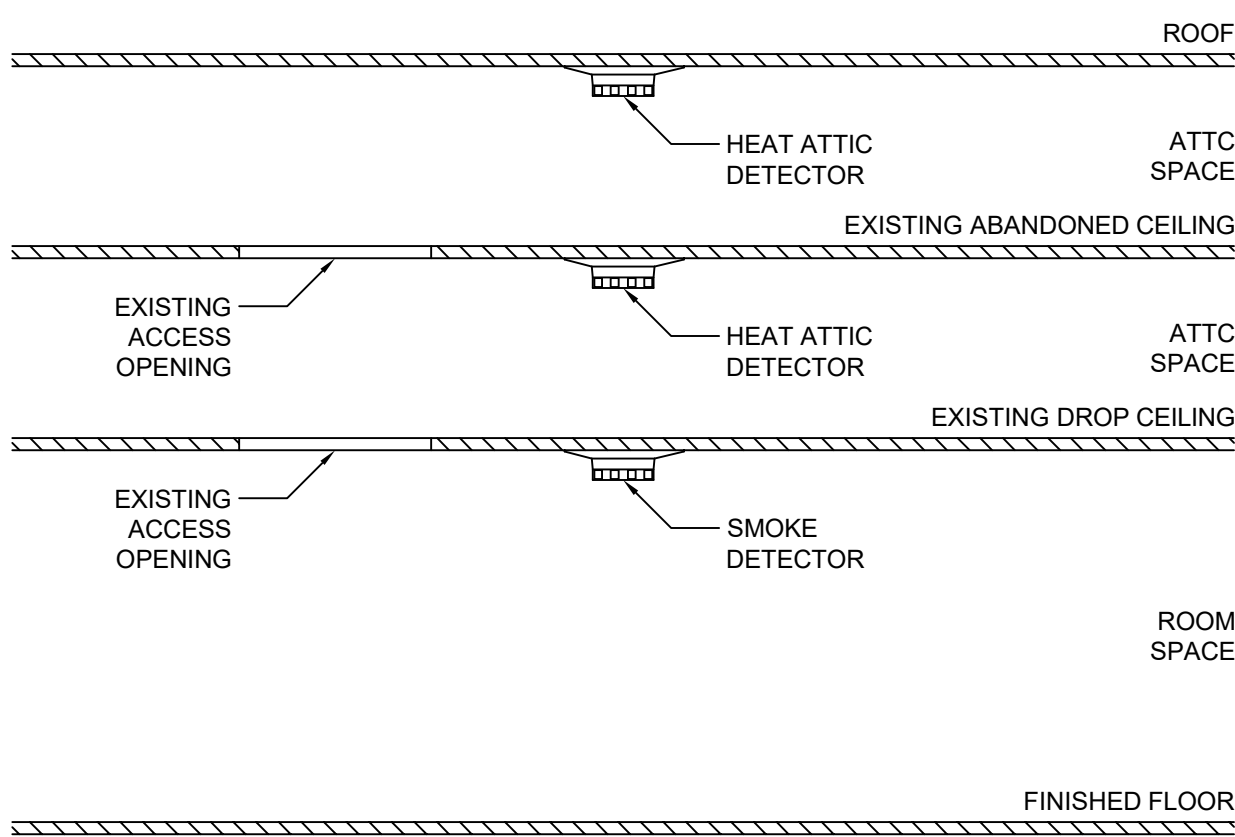
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KEY PLAN



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Architect

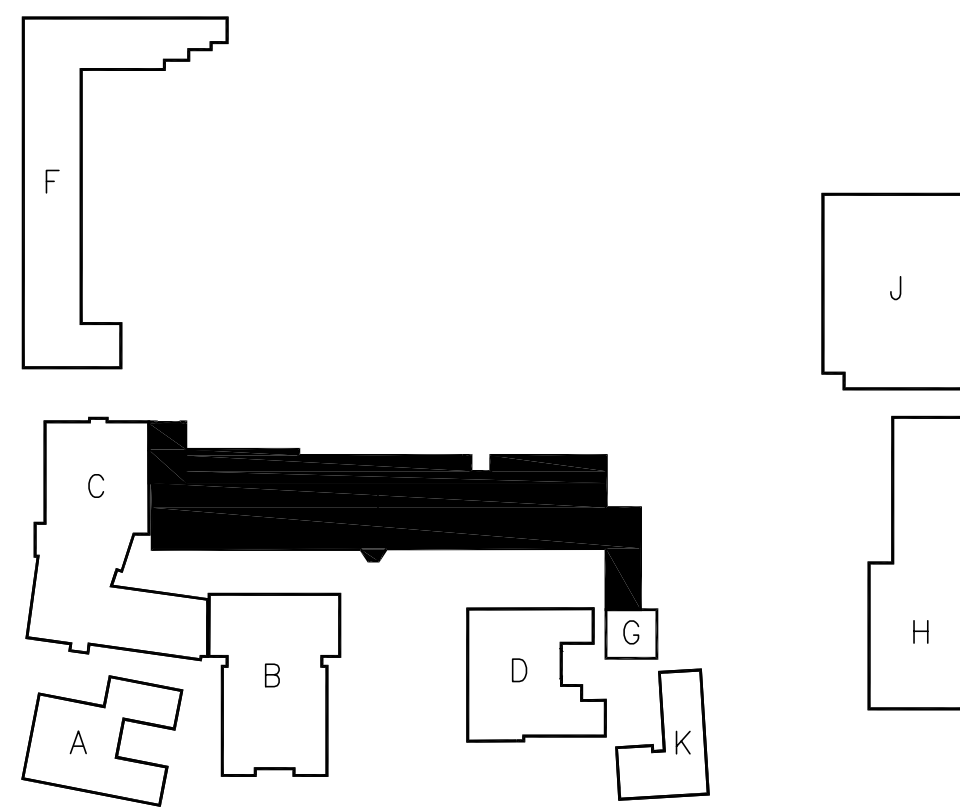

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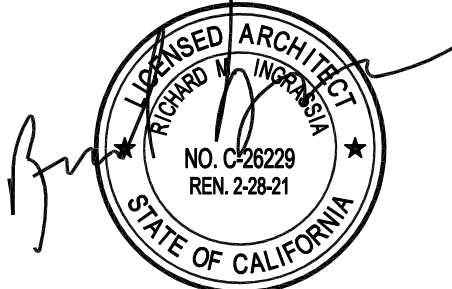
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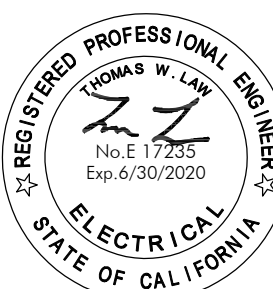
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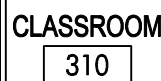


Sheet Title
Fire Alarm
Demolition
Building "E"
Second Floor Plan

Sheet Number

EE312B





ALL EXISTING FIRE ALARM SYSTEM EQUIPMENT/DEVICES SHOWN ARE FROM AVAILABLE RECORD DRAWINGS. CONTRACTOR SHALL VERIFY THE LOCATION AND FUNCTION OF EACH DEVICE AND VERIFY AND PROVIDE ANY REMEDIATION TO PROVIDE FULLY PERMISSIBLE FIRE ALARM SYSTEM. CONTRACTOR SHALL DISCONNECT AND REMOVE ALL EXISTING FIRE ALARM SYSTEM, EXISTING CONDUIT MAY BE RE-USED FOR NEW CONDUIT. CONTRACTOR SHALL PROVIDE NEW CONDUIT TO EACH DEVICE LOCATION AND CONNECT (40%), OTHERWISE PROVIDE NEW CONDUITS. CONTRACTOR AT HIS OPTION MAY REUSE EXISTING CONDUIT PROVIDED IT IS IN GOOD CONDITION AND PROVIDE NEW CONDUITS TO EXTEND TO NEW DEVICE LOCATIONS AS NECESSARY.

EXISTING FIRE ALARM SYSTEM SHALL BE MAINTAINED UNTIL NEW FIRE ALARM HAS BEEN INSTALLED. CONTRACTOR SHALL MAINTAIN ALL EXISTING FIRE ALARM SYSTEMS IN FULLY OPERATIONAL CONDITION FOR SAFETY DURING CONSTRUCTION AND DEMOLITION SHALL BE IN COMPLIANCE WITH CFC 2016, 2017, AND 2018. ALL EXISTING FIRE ALARM SYSTEMS SHALL BE MAINTAINED IN FULLY OPERATIONAL CONDITION AND APPROVED BY I.O.R., DSA, LOCAL FIRE AUTHORITY, AND DISTRICT.

① NOT USED


Diagram illustrating the installation of heat and smoke detectors in different ceiling configurations:

- Top Section:** A cross-section of a roof assembly. A **HEAT ATTIC DETECTOR** is installed in the **ATTIC SPACE** below the **ROOF**.
- Middle Section:** A cross-section showing an **EXISTING ABANDONED CEILING**. A **HEAT ATTIC DETECTOR** is installed in the **ATTIC SPACE** below the ceiling. An **EXISTING ACCESS OPENING** is shown in the ceiling.
- Bottom Section:** A cross-section showing an **EXISTING DROP CEILING**. A **SMOKE DETECTOR** is installed in the **ROOM SPACE** below the ceiling. An **EXISTING ACCESS OPENING** is shown in the ceiling.

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EG311

Plot Date: 11/26/2019 11:36:59 AM Login: Rungta's Sunilashree Last Save By: Reoner J:\Project Files 20\19\19-025 SAMMUSD Lincoln MS\Electrical Drawings\ESAMMUSD-LMS-E31X.dwg

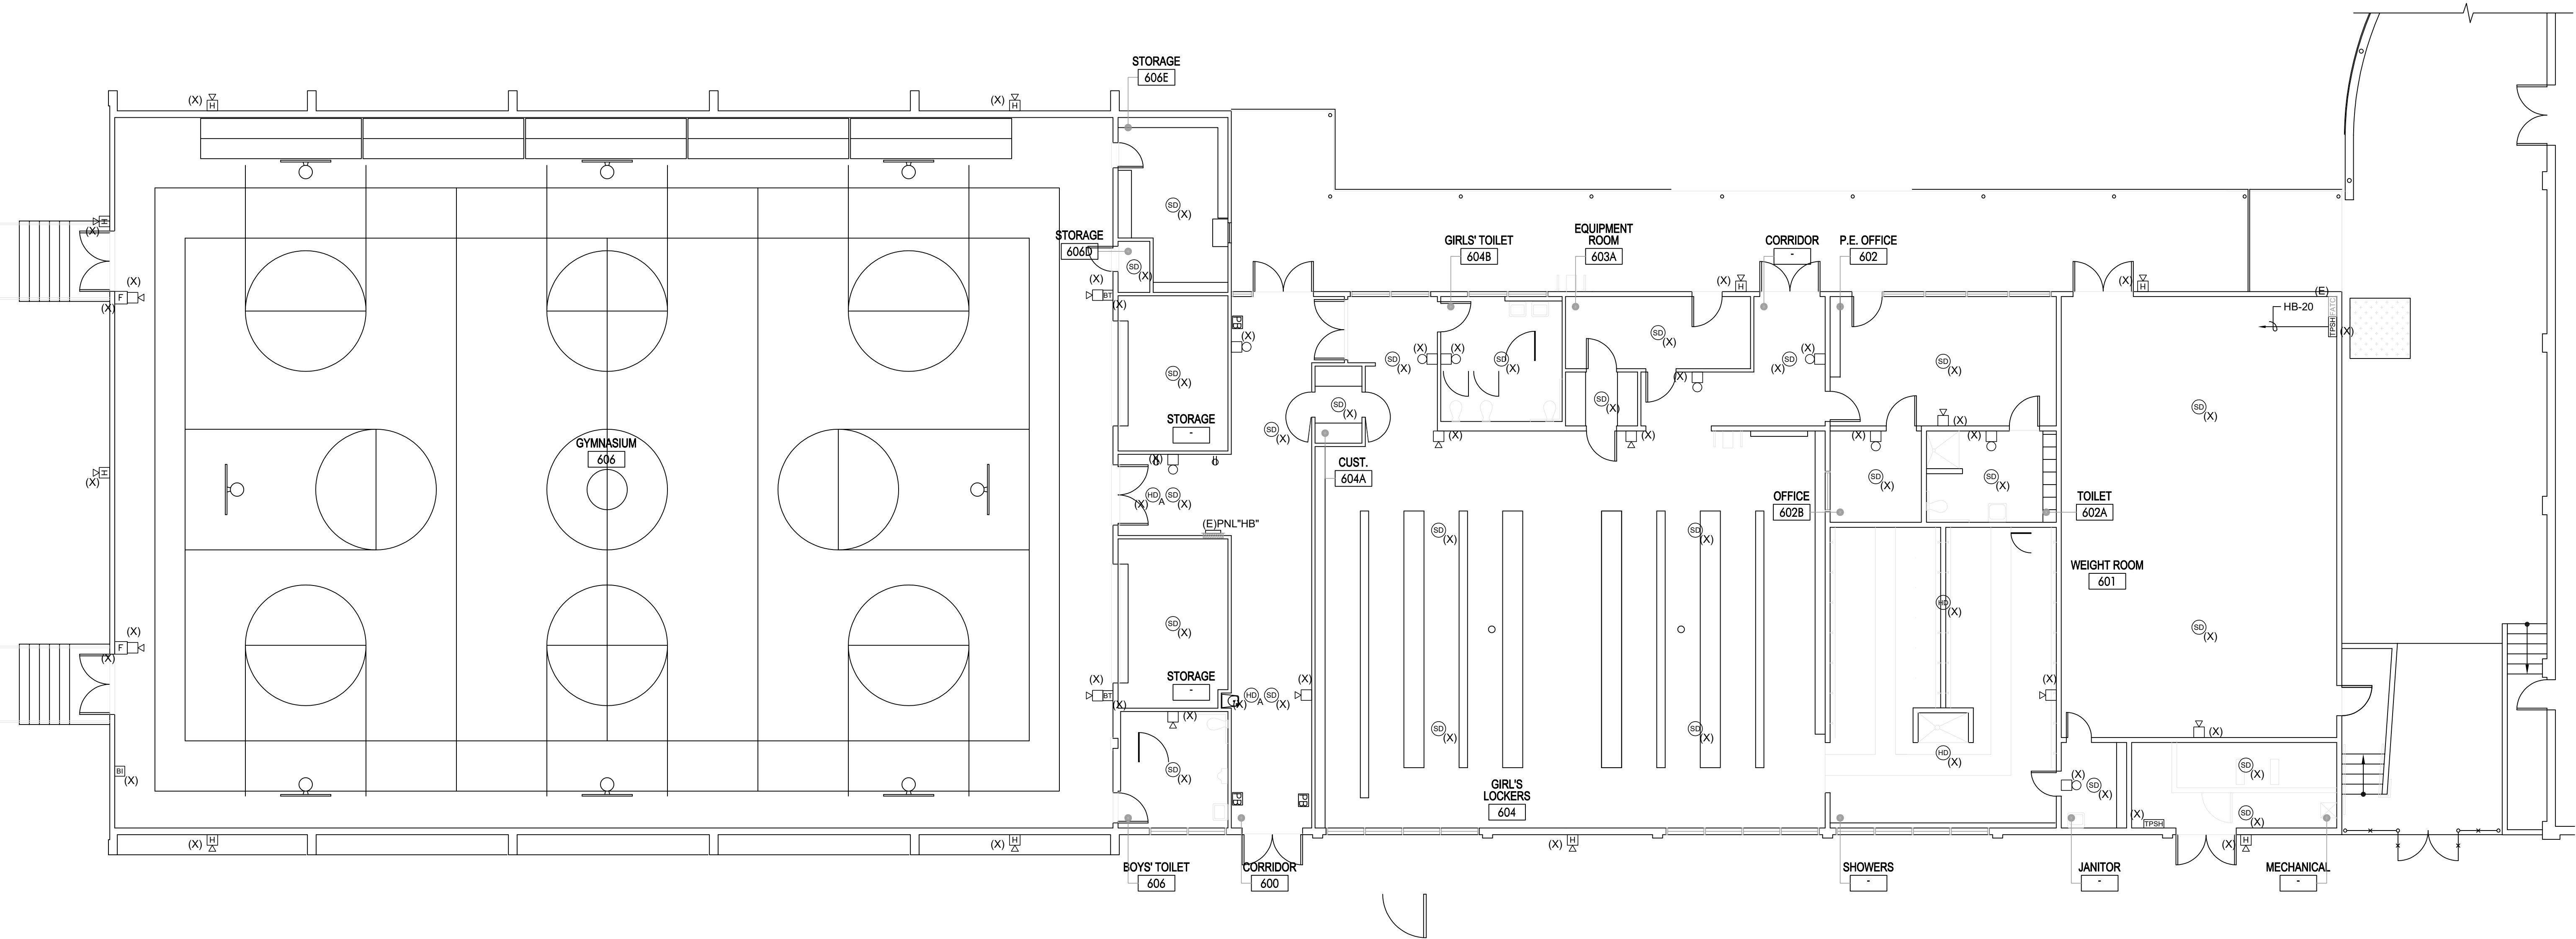

BUILDING "H" - FIRE ALARM DEMOLITION PLAN

SCALE
1/8" = 1'-0" 1


GENERAL NOTES

1. ALL EXISTING FIRE ALARM SYSTEM EQUIPMENT/DEVICES SHOWN ARE FROM AVAILABLE RECORD DRAWINGS. ENGINEER ASSUMES NO RESPONSIBILITY FOR ACCURACY AND CONTRACTOR SHALL FIELD VERIFY AND PROVIDE ANY REMEDIATION TO PROVIDE FULLY OPERABLE FIRE ALARM SYSTEM.
2. DISCONNECT AND REMOVE ALL EXISTING FIRE ALARM SYSTEM. EXISTING CONDUIT MAYBE RE-USED FOR NEW WORK, PROVIDED THEY MEET MINIMUM CONDUIT SIZE REQUIREMENTS AND WIRE FILL CAPACITY (40%). OTHERWISE PROVIDE NEW CONDUITS. CONTRACTOR AT HIS OPTION MAY REUSE EXISTING CONDUITS WITHIN THE BUILDINGS/SITE AND PROVIDE NEW CONDUITS TO EXTEND TO NEW DEVICE LOCATIONS AS NECESSARY.
3. EXISTING FIRE ALARM SYSTEM SHALL BE MAINTAINED UNTIL NEW FIRE ALARM HAS BEEN INSTALLED AND TESTED. UNLESS FIRE WATCH IS PROVIDED.
4. FIRE SAFETY DURING CONSTRUCTION AND DEMOLITION SHALL BE IN COMPLIANCE WITH CFC 2016, CHAPTER 9, 11 AND 33 & CBC 2016, CHAPTER 33. PROVIDE FIRE WATCH UNTIL THE NEW SYSTEM IS IN OPERATION AND APPROVED BY I.O.R., DSA, LOCAL FIRE AUTHORITY, AND DISTRICT.

REFERENCE NOTES

① NOT USED

KEY PLAN

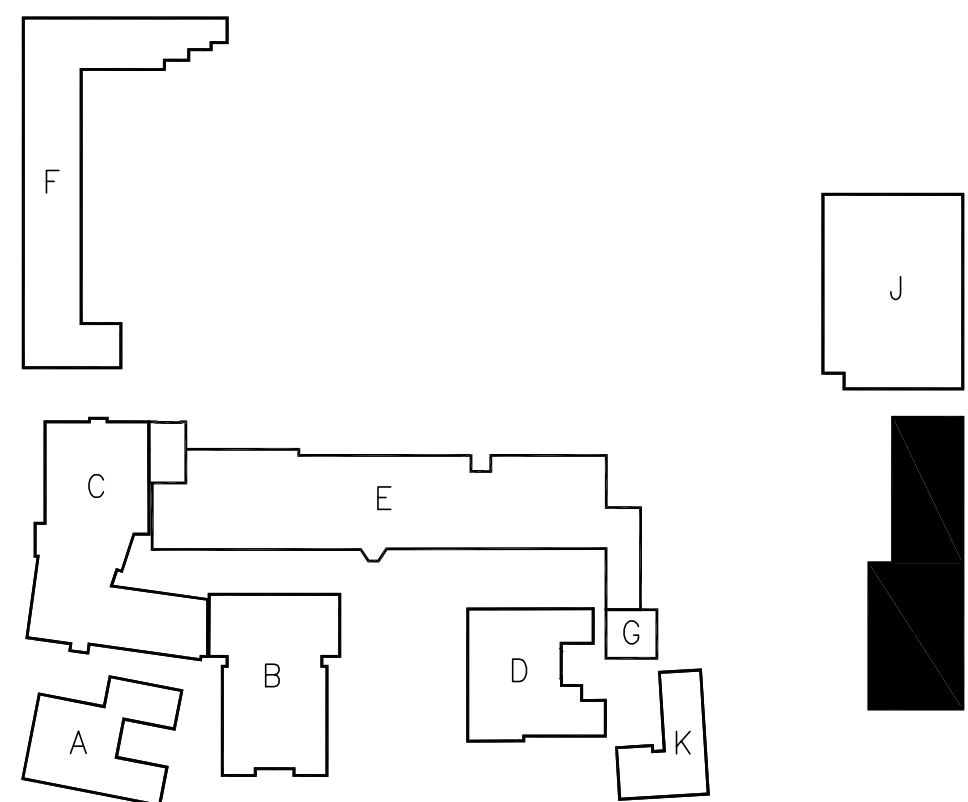

DSA Stamp

Architect



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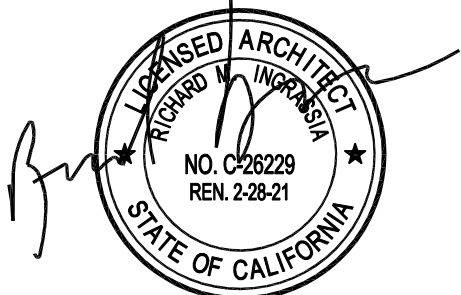
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Lincoln Middle School
1501 California Avenue
Santa Monica, California 90403


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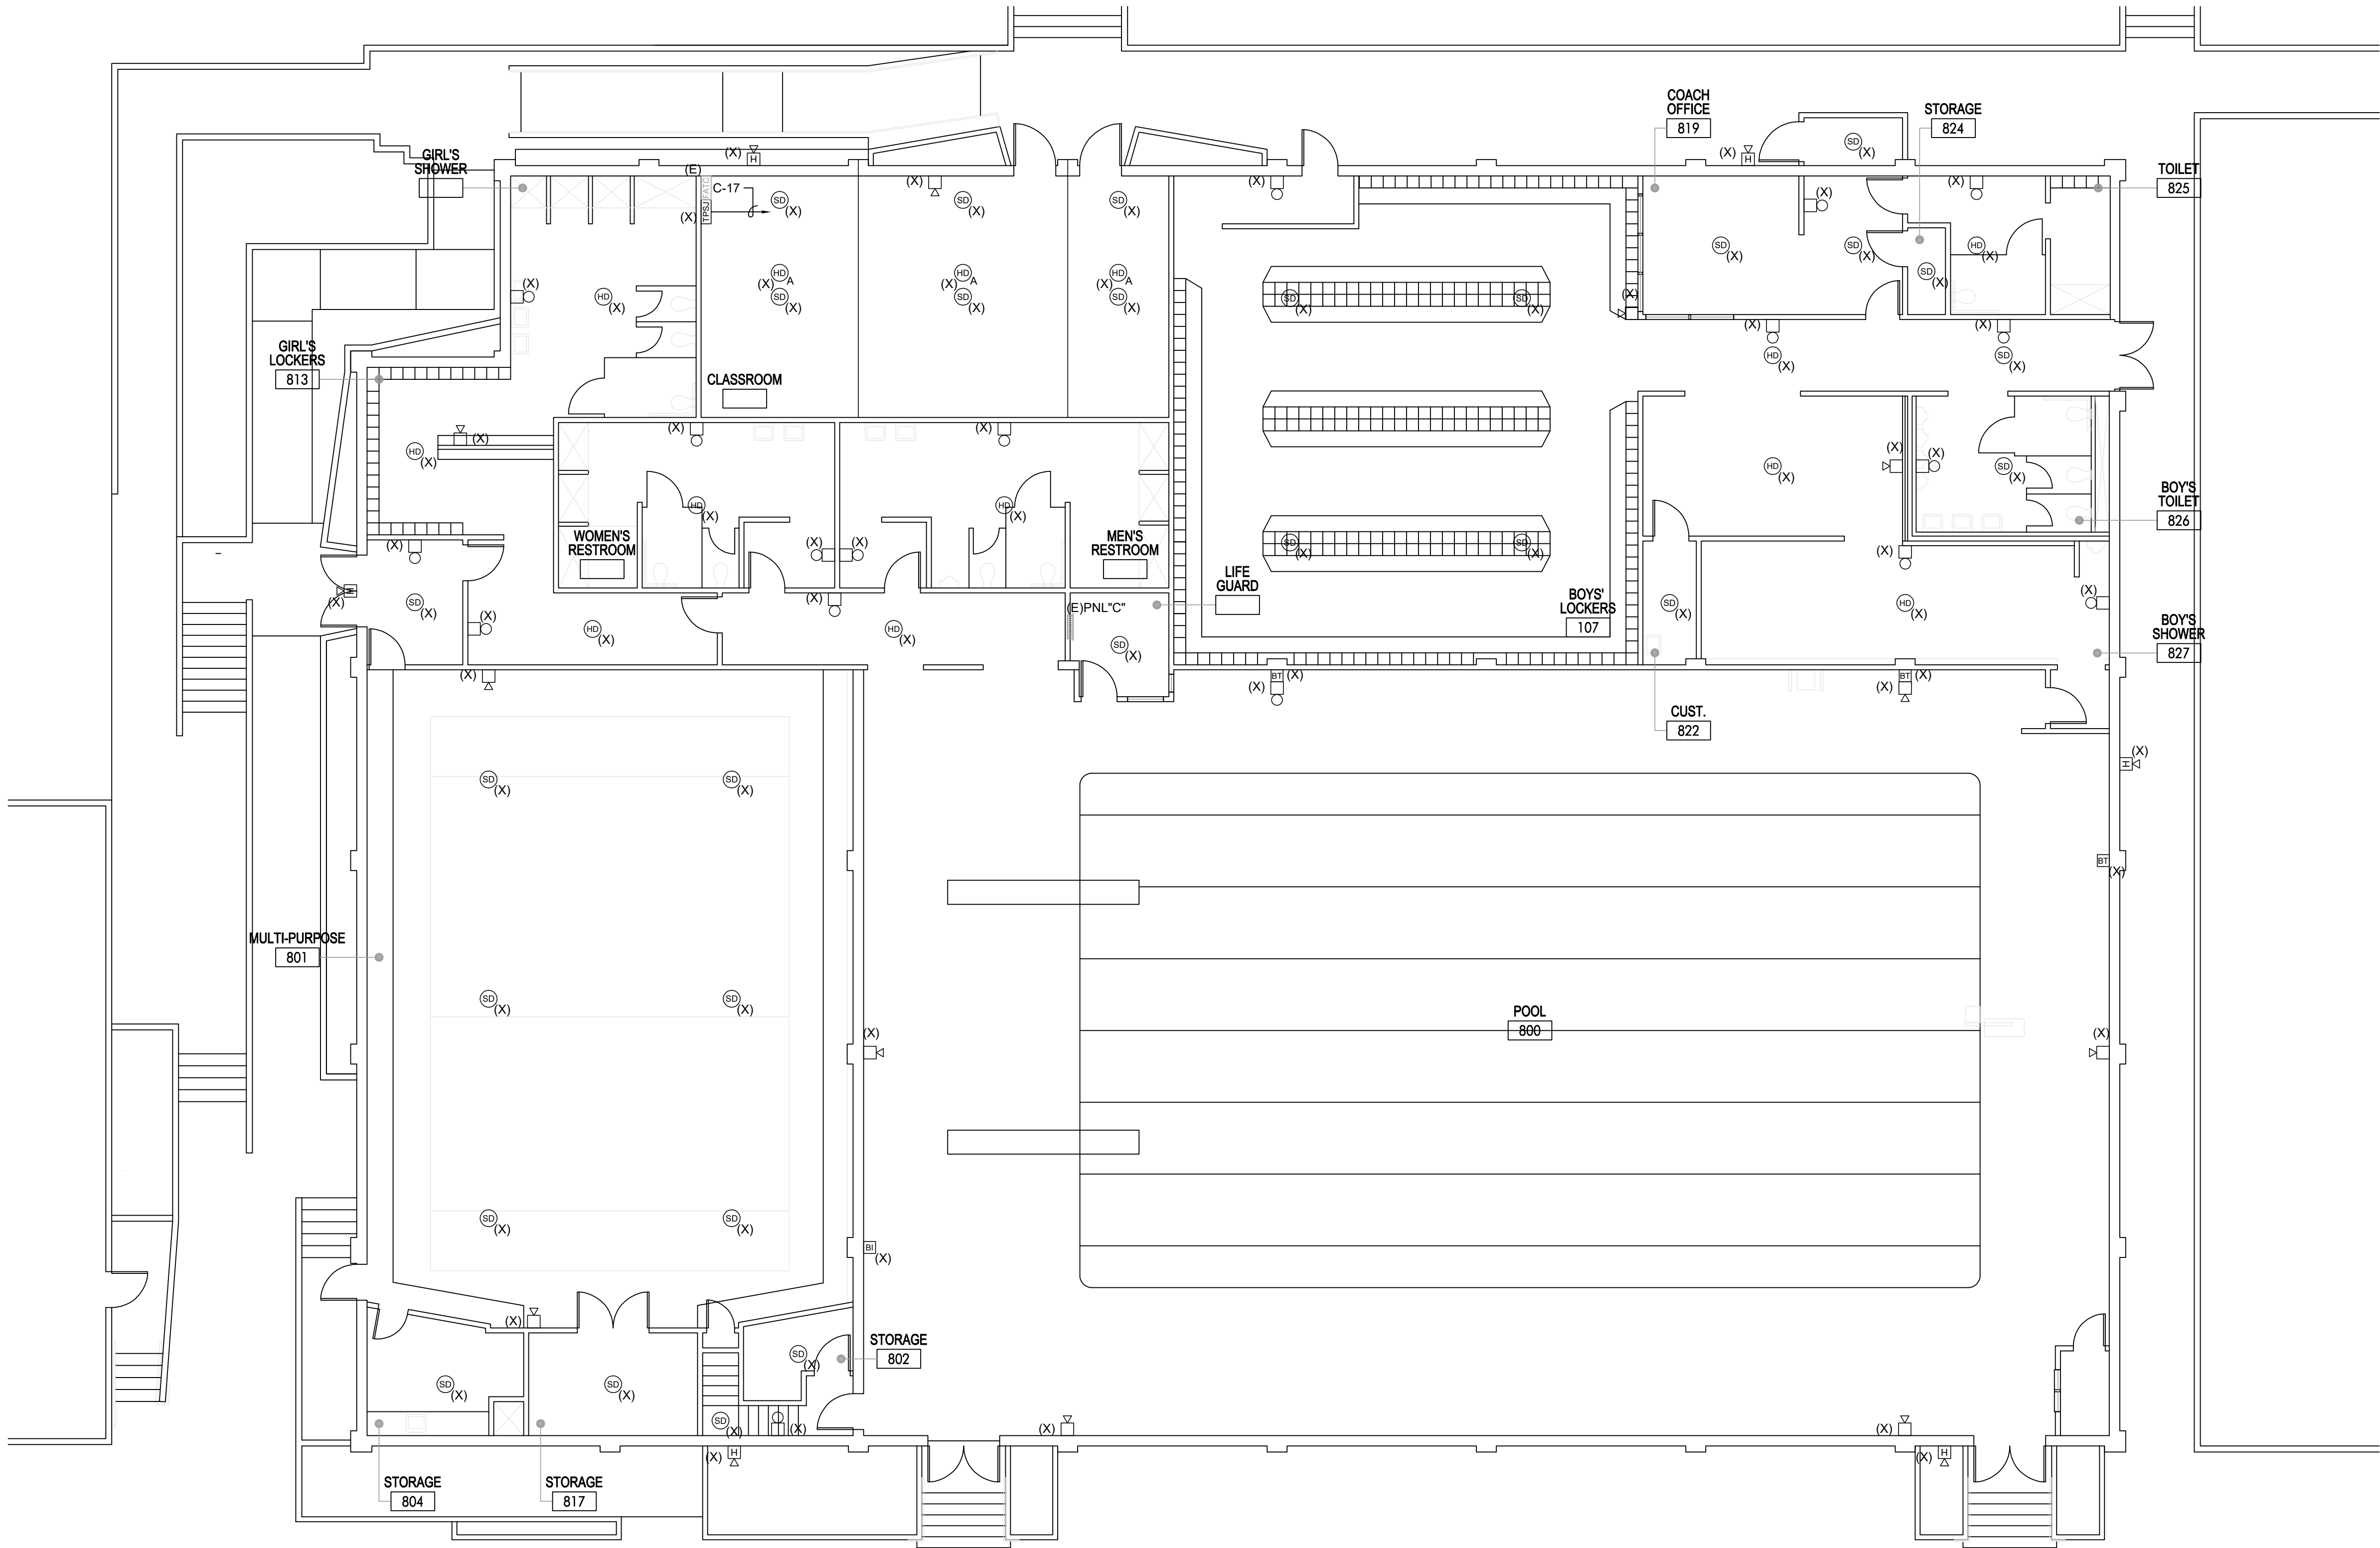
Sheet Title

Fire Alarm
Demolition
Building "H"
Floor Plan

Sheet Number

EH311


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BUILDING "J" - FIRE ALARM DEMOLITION PLAN

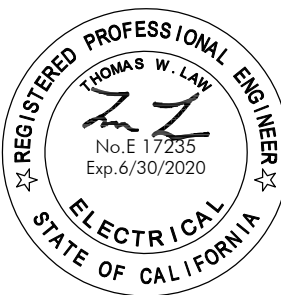SCALE
1/8" = 1'-0"

1



BUILDING "J" - FIRE ALARM DEMOLITION BASEMENT PLAN

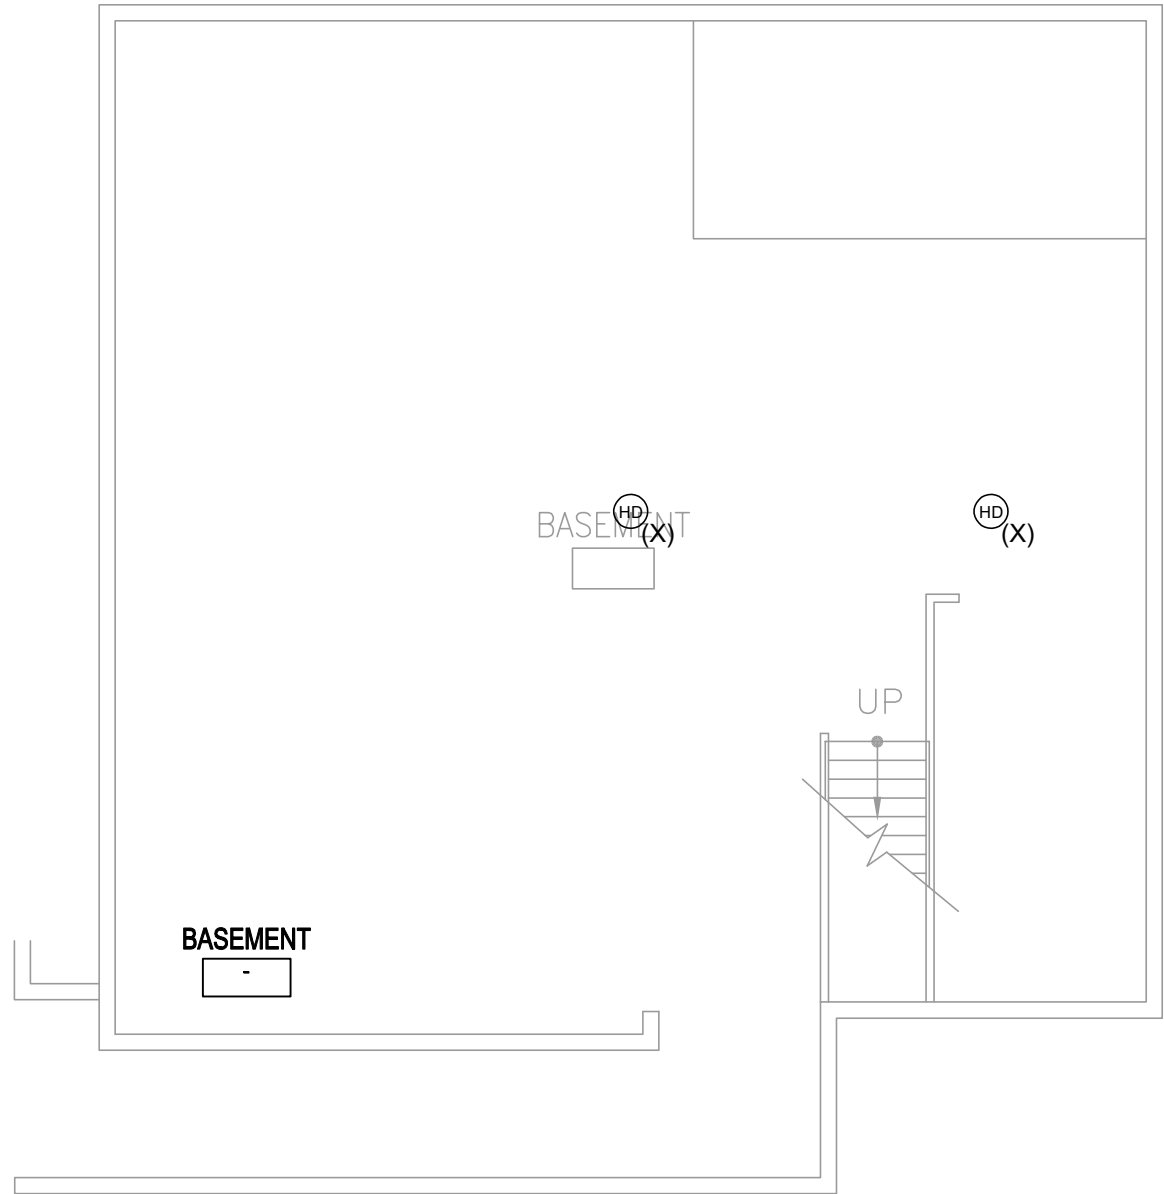SCALE
1/8" = 1'-0"

2

GENERAL NOTES

1. ALL EXISTING FIRE ALARM SYSTEM EQUIPMENT/DEVICES SHOWN ARE FROM AVAILABLE RECORD DRAWINGS. ENGINEER ASSUMES NO RESPONSIBILITY FOR ACCURACY AND CONTRACTOR SHALL FIELD VERIFY AND PROVIDE ANY REMEDIATION TO PROVIDE FULLY OPERABLE FIRE ALARM SYSTEM.
2. DISCONNECT AND REMOVE ALL EXISTING FIRE ALARM SYSTEM, EXISTING CONDUIT MAYBE RE-USED FOR NEW WORK, PROVIDED THEY MEET MINIMUM CONDUIT SIZE REQUIREMENTS AND WIRE FILL CAPACITY (40%). OTHERWISE PROVIDE NEW CONDUITS. CONTRACTOR AT HIS OPTION MAY REUSE EXISTING CONDUITS WITHIN THE BUILDING/SITE AND PROVIDE NEW CONDUITS TO EXTEND TO NEW DEVICE LOCATIONS AS NECESSARY.
3. EXISTING FIRE ALARM SYSTEM SHALL BE MAINTAINED UNTIL NEW FIRE ALARM HAS BEEN INSTALLED AND TESTED, UNLESS FIRE WATCH IS PROVIDED.
4. FIRE SAFETY DURING CONSTRUCTION AND DEMOLITION SHALL BE IN COMPLIANCE WITH CFC 2016, CHAPTER 9, 11 AND 33 & CBC 2016, CHAPTER 33. PROVIDE FIRE WATCH UNTIL THE NEW SYSTEM IS IN OPERATION AND APPROVED BY I.O.R., DSA, LOCAL FIRE AUTHORITY, AND DISTRICT.

REFERENCE NOTES

○ NOT USED

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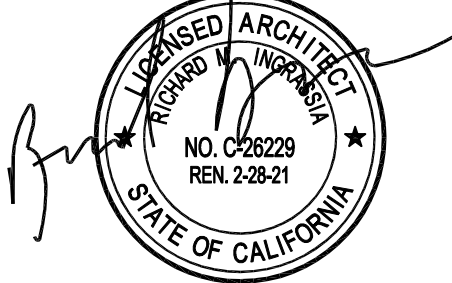
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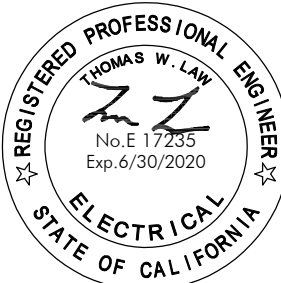
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Sheet Title

Fire Alarm
Demolition
Building "J"
Floor Plan

Sheet Number

EJ311



SCALE

$1/8" = 1'-0"$

1


1. ALL EXISTING FIRE ALARM SYSTEM EQUIPMENT/DEVICES SHOWN ARE FROM AVAILABLE RECORD DRAWINGS. ENGINEER ASSUMES NO RESPONSIBILITY FOR ACCURACY AND CONTRACTOR SHALL FIELD VERIFY ALL EQUIPMENT/DEVICES. CONTRACTOR SHALL VERIFY ALL EQUIPMENT/DEVICES ARE PROPERLY IDENTIFIED AND DISCONNECT AND REMOVE ALL EXISTING FIRE ALARM SYSTEM. EXISTING CONDUIT MAYBE RE-USED FOR NEW CONDUIT. PROVIDE NEW CONDUIT TO MEET ALL REQUIREMENTS OF NFPA 70-2017 (600.10.1.1 DISCONNECT) (60%) EXISTING PROVIDE NEW CONDUITS. CONTRACTOR AT HIS OPTION MAY RE-USE EXISTING CONDUITS WITHIN BUILDINGS/SITE AND PROVIDE NEW CONDUITS TO EXTEND TO NEW FIRE ALARM LOCATIONS AS NECESSARY.

2. EXISTING FIRE ALARM SYSTEM SHALL BE MAINTAINED UNTIL NEW FIRE ALARM HAS BEEN INSTALLED AND FULLY OPERATIONAL. CONTRACTOR SHALL MAINTAIN ALL EXISTING FIRE ALARM SYSTEMS IN FIRE SAFETY DURING CONSTRUCTION AND DEMOLITION SHALL BE IN COMPLIANCE WITH CFC 2016, SECTION 11 AND ALL APPLICABLE ORDINANCES. CONTRACTOR SHALL MAINTAIN NEW SYSTEM IN OPERATION AND APPROVED BY I.O.R., DSA, LOCAL FIRE AUTHORITY, AND DISTRICT.

① NOT USED

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Architect

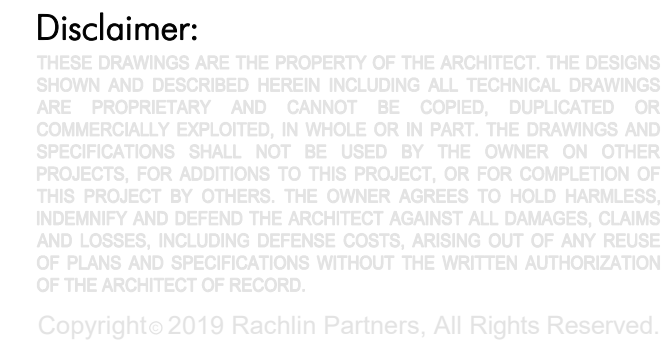


Santa Monica, California 90403

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Scale: As Shown
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Checked By: BA

A circular professional engineer seal for the State of California. The outer ring contains the text "LICENSED ARCHITECT" at the top and "STATE OF CALIFORNIA" at the bottom, separated by two stars. Inside the ring, the name "RICHARD M. INGENDA" is written in a semi-circle. Below the name, the license number "NO. C-26229" and the renewal date "REN. 2-28-21" are printed. A handwritten signature, "R. Ingenda", is written across the seal.

Sheet Number

EK311

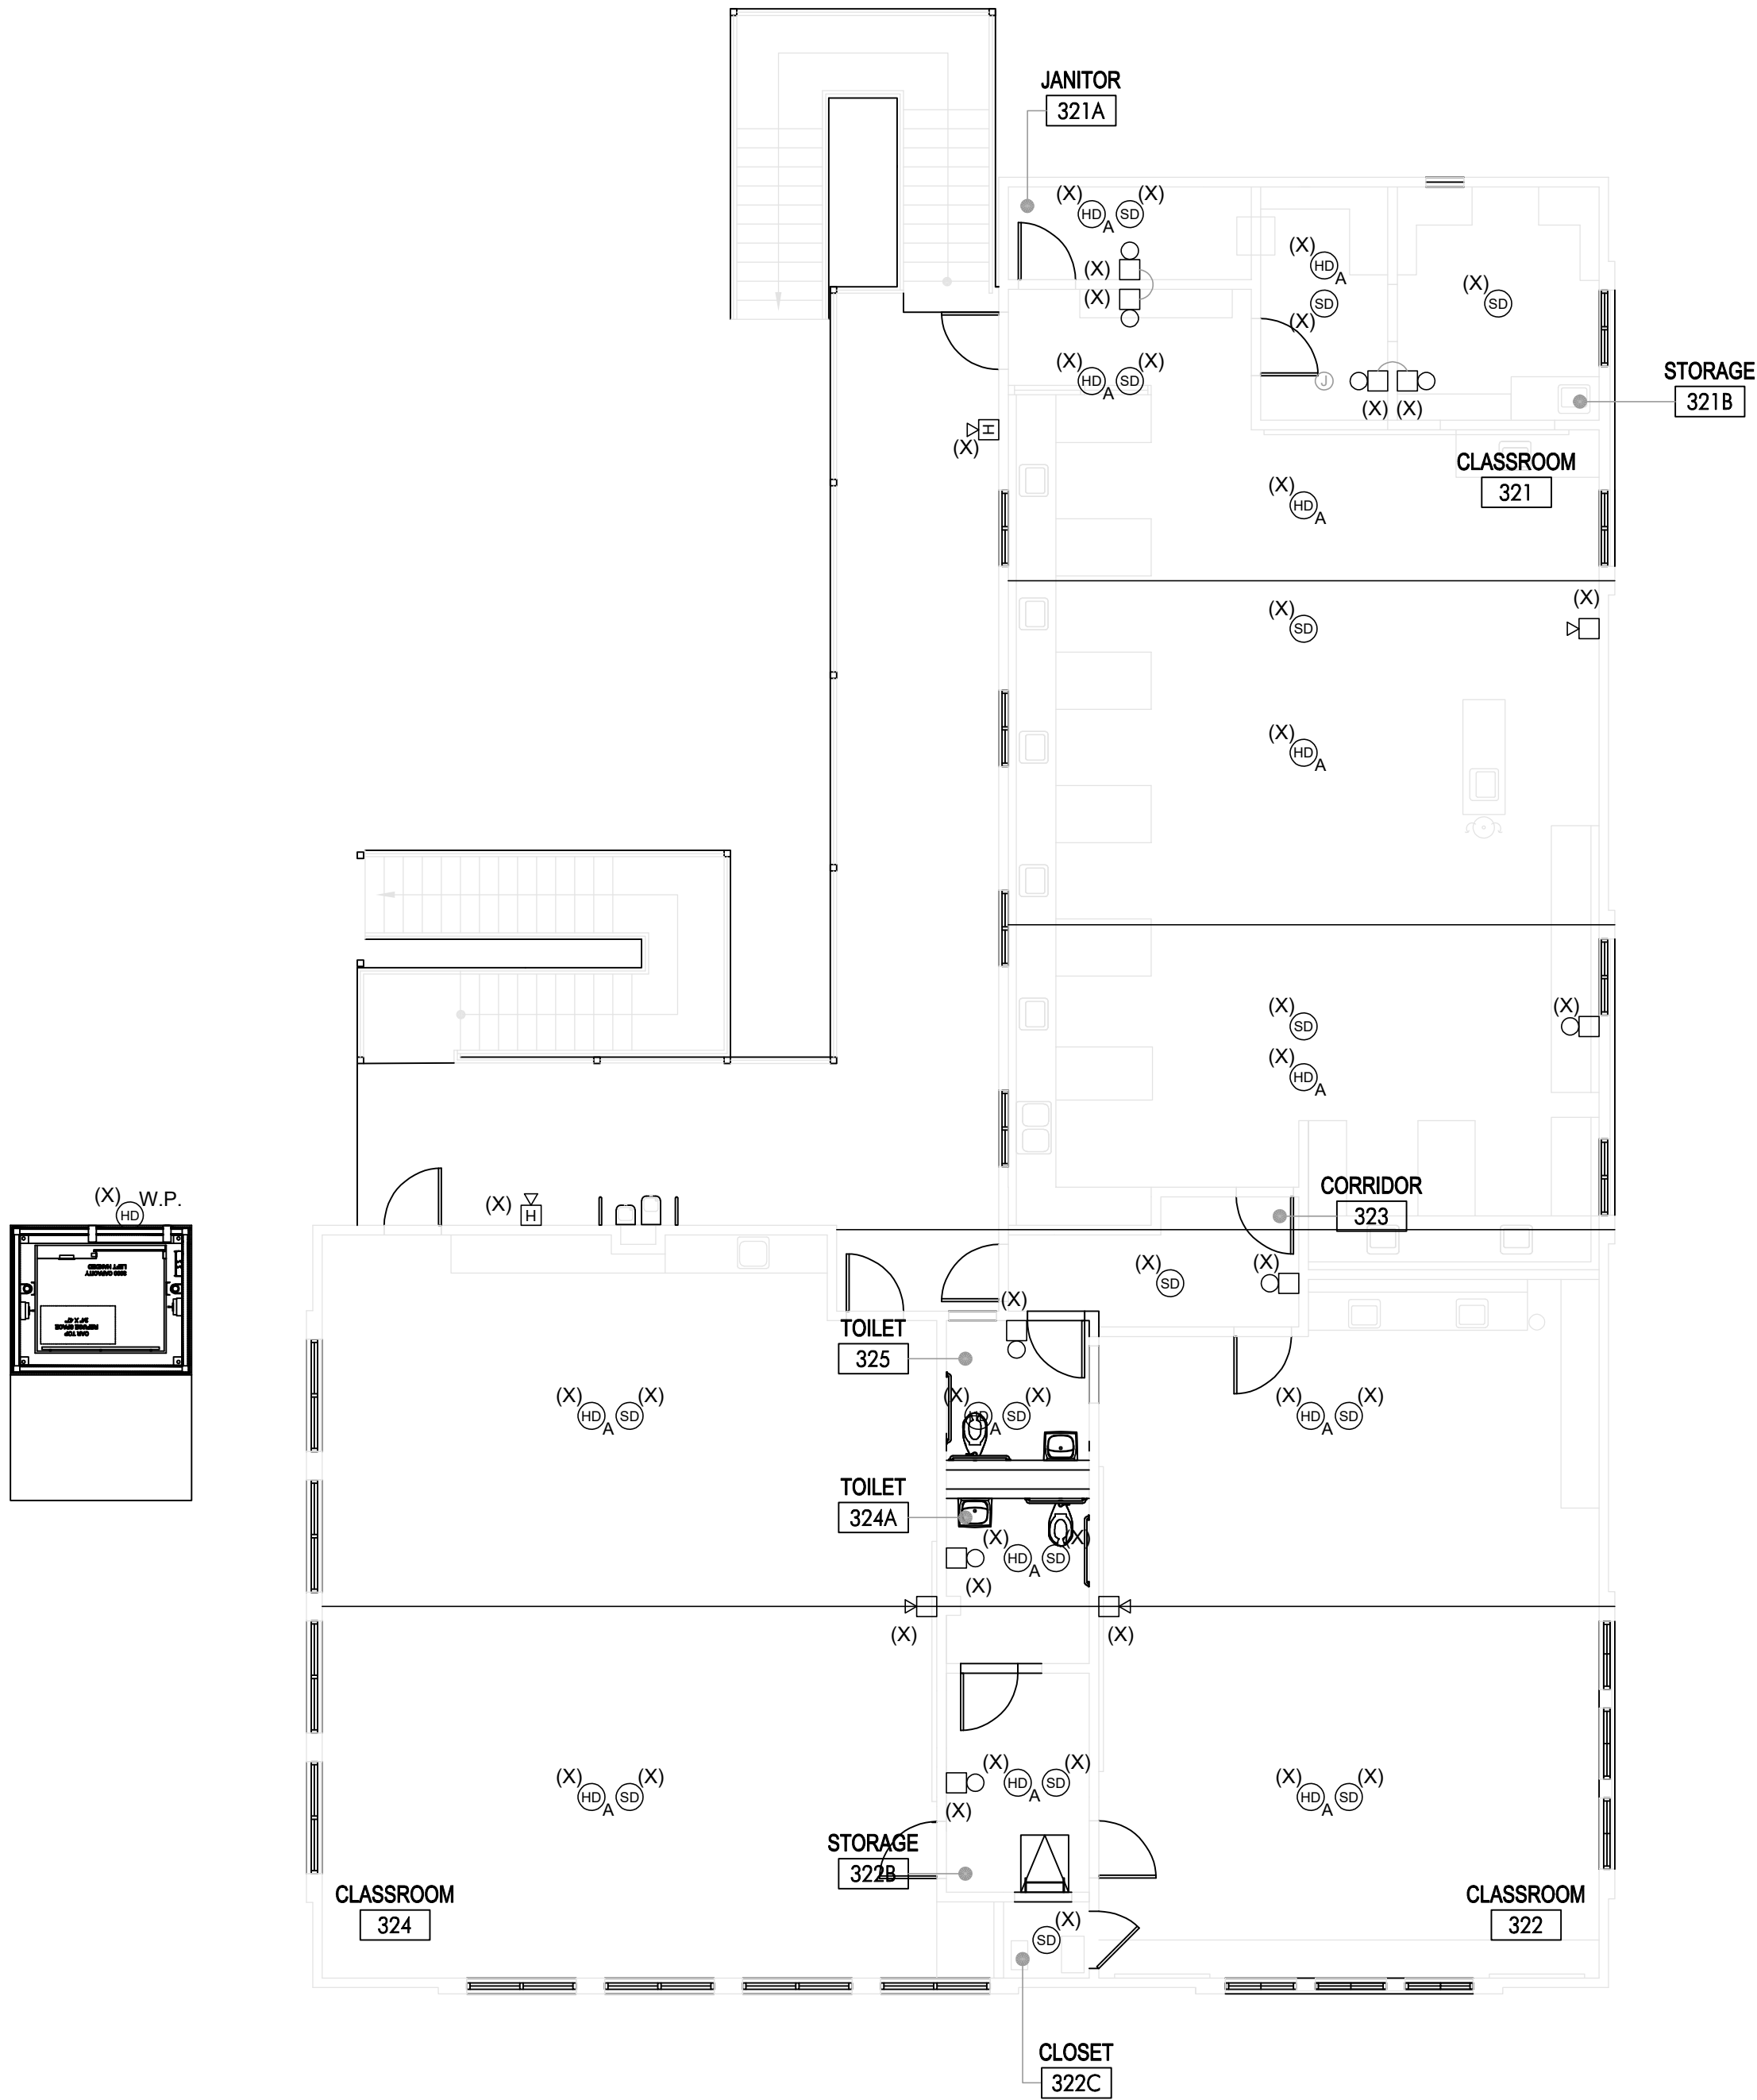

BUILDING "K" - FIRE ALARM DEMOLITION SECOND FLOOR PLAN

SCALE
1/8" = 1'-0"

1


GENERAL NOTES

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REFERENCE NOTES

① NOT USED

KEY PLAN

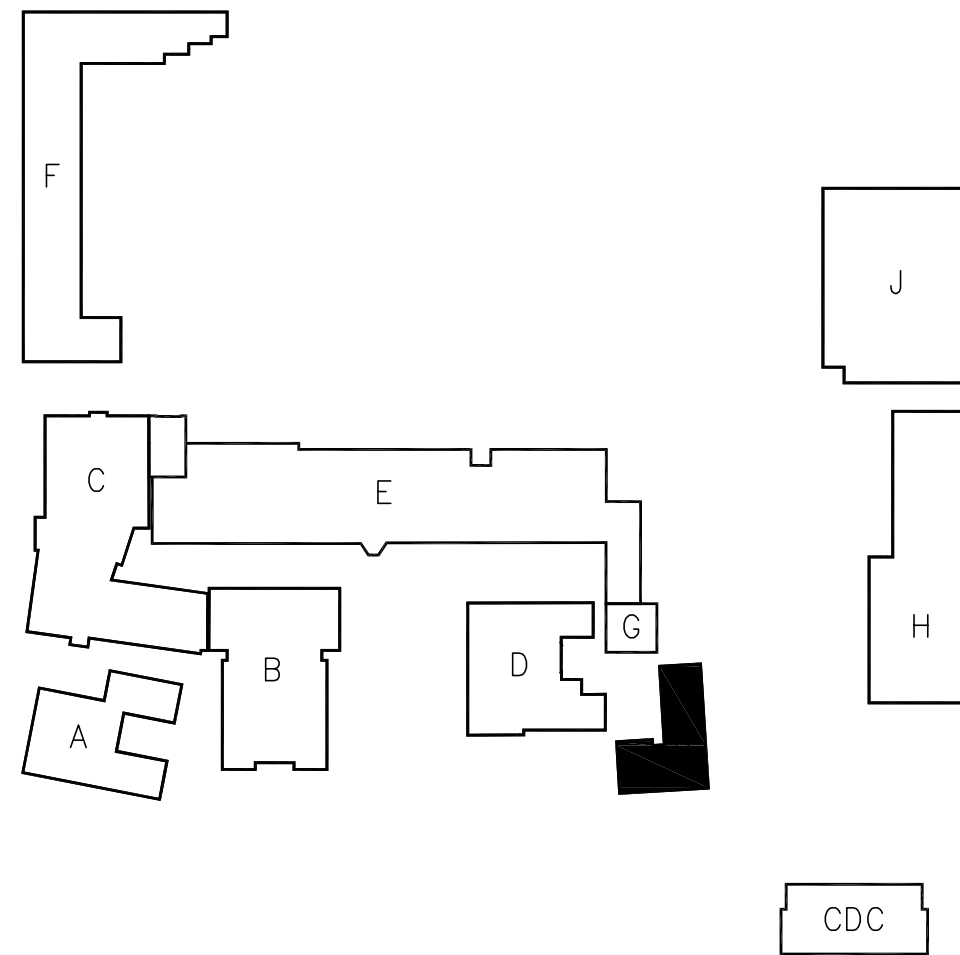

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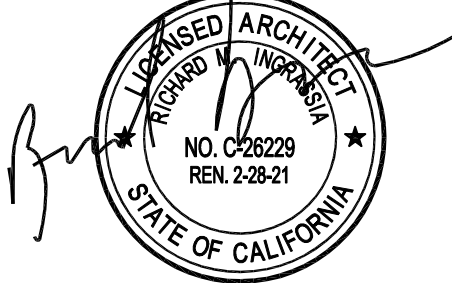
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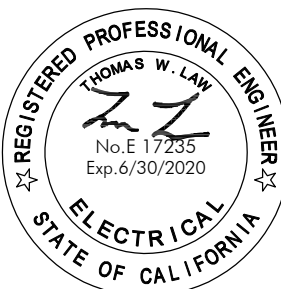
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Checked By: BA

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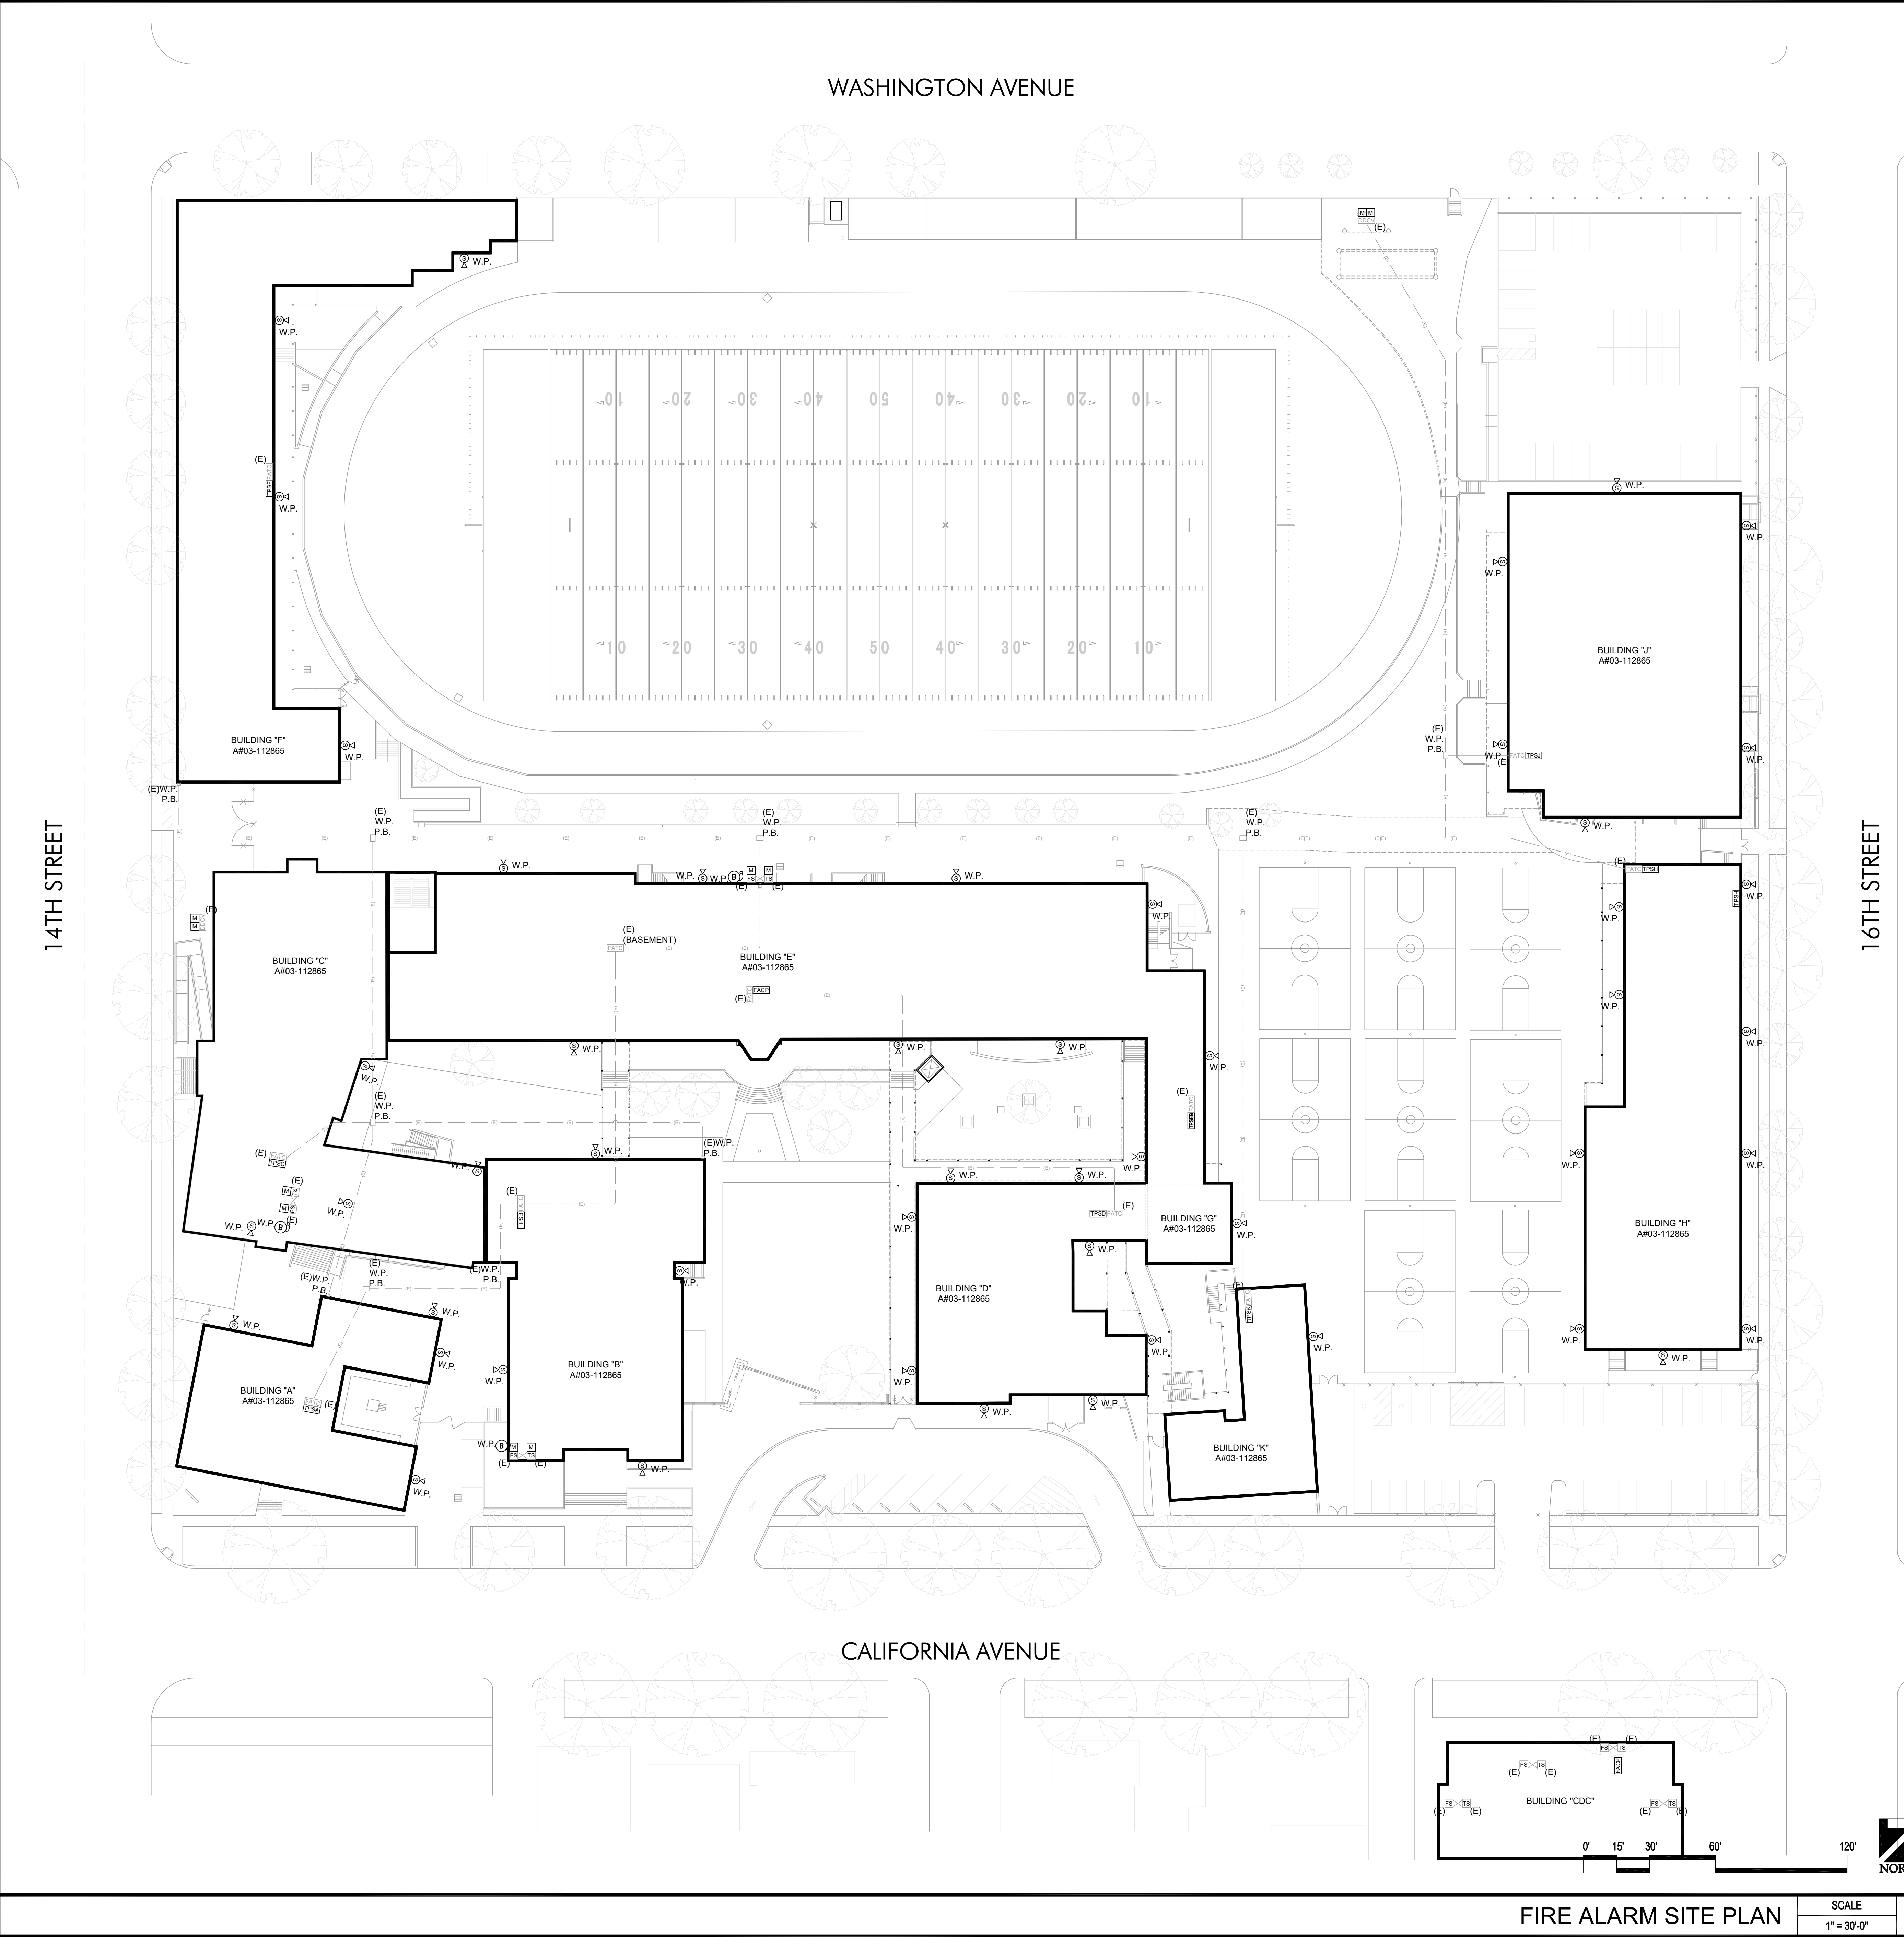


Sheet Title
Fire Alarm
Demolition
Building "K"
Second Floor Plan

Sheet Number

EK312

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GENERAL NOTES

1. ALL EXISTING FIRE ALARM SYSTEM EQUIPMENT/DEVICES SHOWN ARE FROM AVAILABLE RECORD DRAWINGS. ENGINEER ASSUMES NO RESPONSIBILITY FOR ACCURACY AND CONTRACTOR SHALL FIELD VERIFY AND PROVIDE ANY REMEDIATION TO PROVIDE FULLY OPERABLE FIRE ALARM SYSTEM.
2. EXISTING FIRE ALARM SYSTEM SHALL BE MAINTAINED UNTIL NEW FIRE ALARM HAS BEEN INSTALLED AND TESTED. UNLESS FIRE WATCH IS PROVIDED.

REFERENCE NOTES

Ⓢ NOT USED

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310.204.3441

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Checked By: BA

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REGISTERED ARCHITECT
NO. C23229
REN. 2/28/21
STATE OF CALIFORNIA

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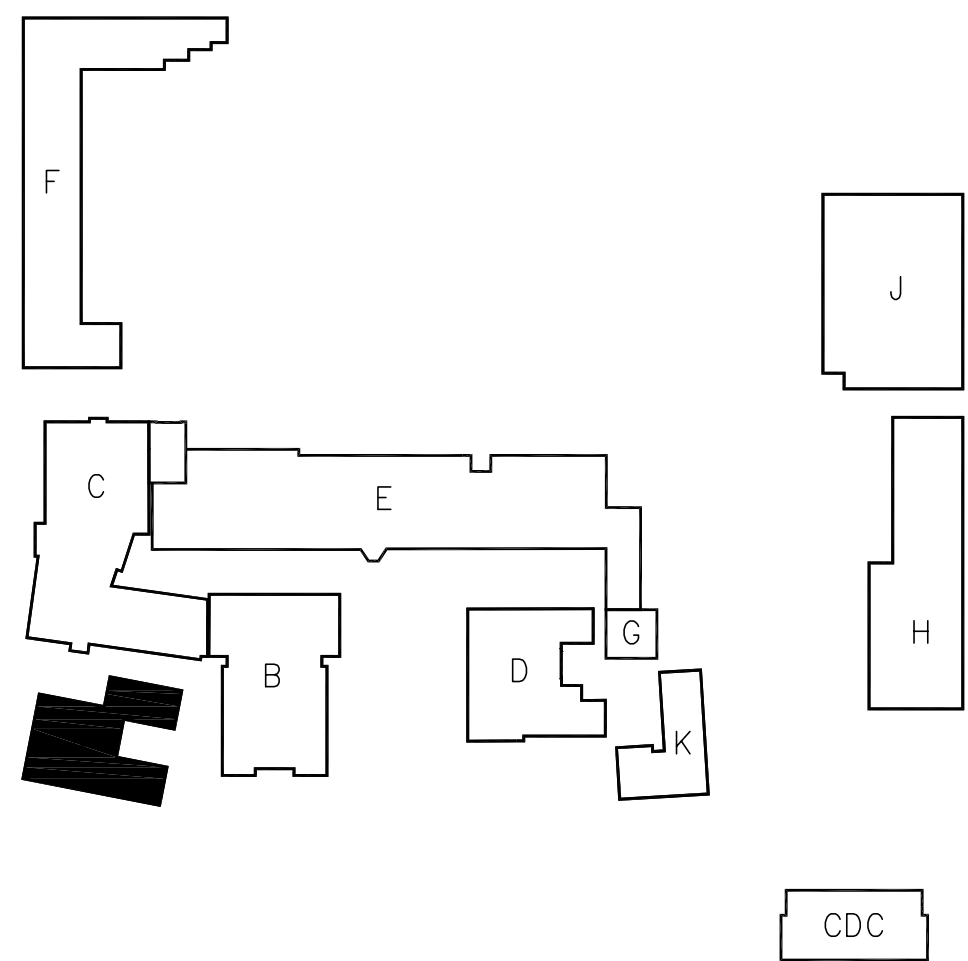
REGISTERED PROFESSIONAL ENGINEER
NO. 17173
EXP. 6/30/2020
ELECTRICAL
STATE OF CALIFORNIA

Sheet Title
Fire Alarm Site Plan

Sheet Number
E321



1



NORTH

1. EXISTING CONDUIT MAY BE RE-USED FOR WORK PROVIDED THEY MEET MINIMUM CONDUIT SIZE REQUIREMENTS AND WIRE FILL CAPACITY (40%); OTHERWISE PROVIDE NEW CONDUITS. CONTRACTOR SHALL BE RESPONSIBLE FOR OBTAINING ALL NECESSARY PERMITS, EROSION CONTROL AND PROVIDE NEW CONDUITS TO EXTEND TO NEW DEVICE LOCATIONS AS NECESSARY.

2. EXISTING FIRE ALARM SYSTEM SHALL BE MAINTAINED UNTIL NEW FIRE ALARM HAS BEEN INSTALLED.

3. EXISTING FIRE ALARM SYSTEM SHALL BE MAINTAINED UNTIL NEW FIRE ALARM HAS BEEN INSTALLED.

4. FIRE SAFETY DURING CONSTRUCTION AND DEMOLITION SHALL BE IN COMPLIANCE WITH CFC 2016, CHAPTER 9, 11 AND 33 & CBC 2016, CHAPTER 33. PROVIDE FIRE WATCH UNTIL THE NEW SYSTEM IS IN COMPLIANCE AND APPROVED BY I.O.R., DSA, LAFD, FIRE AGENCY, AND DISTRICT.

5. CONTRACTOR SHALL EXCAVATE AND RESTORE AUTOMATIC WIRE LOCATOR AND NEW UNDERGROUND UTILITIES. FIELD VERIFY AND COORDINATE PRIOR TO EXCAVATION. ANY DAMAGE TO EXISTING UNDERGROUND UTILITIES SHALL BE REPAIRED AND RESTORED TO ORIGINAL CONDITION IMMEDIATELY.

6. CONTRACTOR SHALL BE RESPONSIBLE FOR OBTAINING ALL NECESSARY PERMITS. WHENEVER IT MAY BE NECESSARY TO RUN NEW UTILITIES UNDER/OVER EXISTING UTILITIES (CROSSOVER).

7. AUTOMATIC SHUTOFF IS NOT REQUIRED WHEN ALL OCCUPIED ROOMS SERVED BY THE AIR-HANDLING UNIT ARE EVACUATED. PROVIDE ACCESS TO THE EXTERIOR AND THE TRAVEL DISTANCE DOES NOT EXCEED 150 FEET. (CMC 608 EXEMPTION#2)

- ① PROVIDE NEW 1/2x4 1/8" CIRCUIT BREAKER TO ELECTRICAL PANEL, AS INDICATED. CIRCUIT BREAKER SHALL MATCH BY TYPE/SPECIFIC RATING. PROVIDE LOCK ON DEVICE TO CIRCUIT BREAKER HANDLE. WITH MARKING "ACCESSIBLE ONLY TO AUTHORIZED PERSONNEL IDENTIFIED AS FIRE ALARM CIRCUIT". AND LOCATION OF CIRCUIT BREAKER PERMANENTLY IDENTIFIED AT FIRE ALARM CONTROL UNIT IN COMPLIANCE WITH NFPA 72, 10.6.5.2.
- ② HVAC UNIT (FIELD VERIFY EXACT LOCATION). PROVIDE AUTOMATIC SHUT OFF PER CMc 908. WITH CONTROL WIRING MODULE (4090-9002), IDNET WIRING IAM) AND 120V REMOVABLE (2008-9008, FIRE ALARM CONTROL, RELOCATED FROM THE CEILING SPACE ABOVE THE CEILING SPACE BELOW HVAC UNIT). SEE WIRING DIAGRAM ON SHEET BE401. CONNECT 120V POWER CIRCUIT TO 120V REMOVABLE MODULES. PROVIDE LOCK ON DEVICE TO CIRCUIT BREAKER HANDLE, WITH RED MARKING.
- ③ PROVIDE NEW ACCESS PANEL. SEE ARCHITECTURAL DRAWINGS




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310.204.3400

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Santa Monica, California 90403


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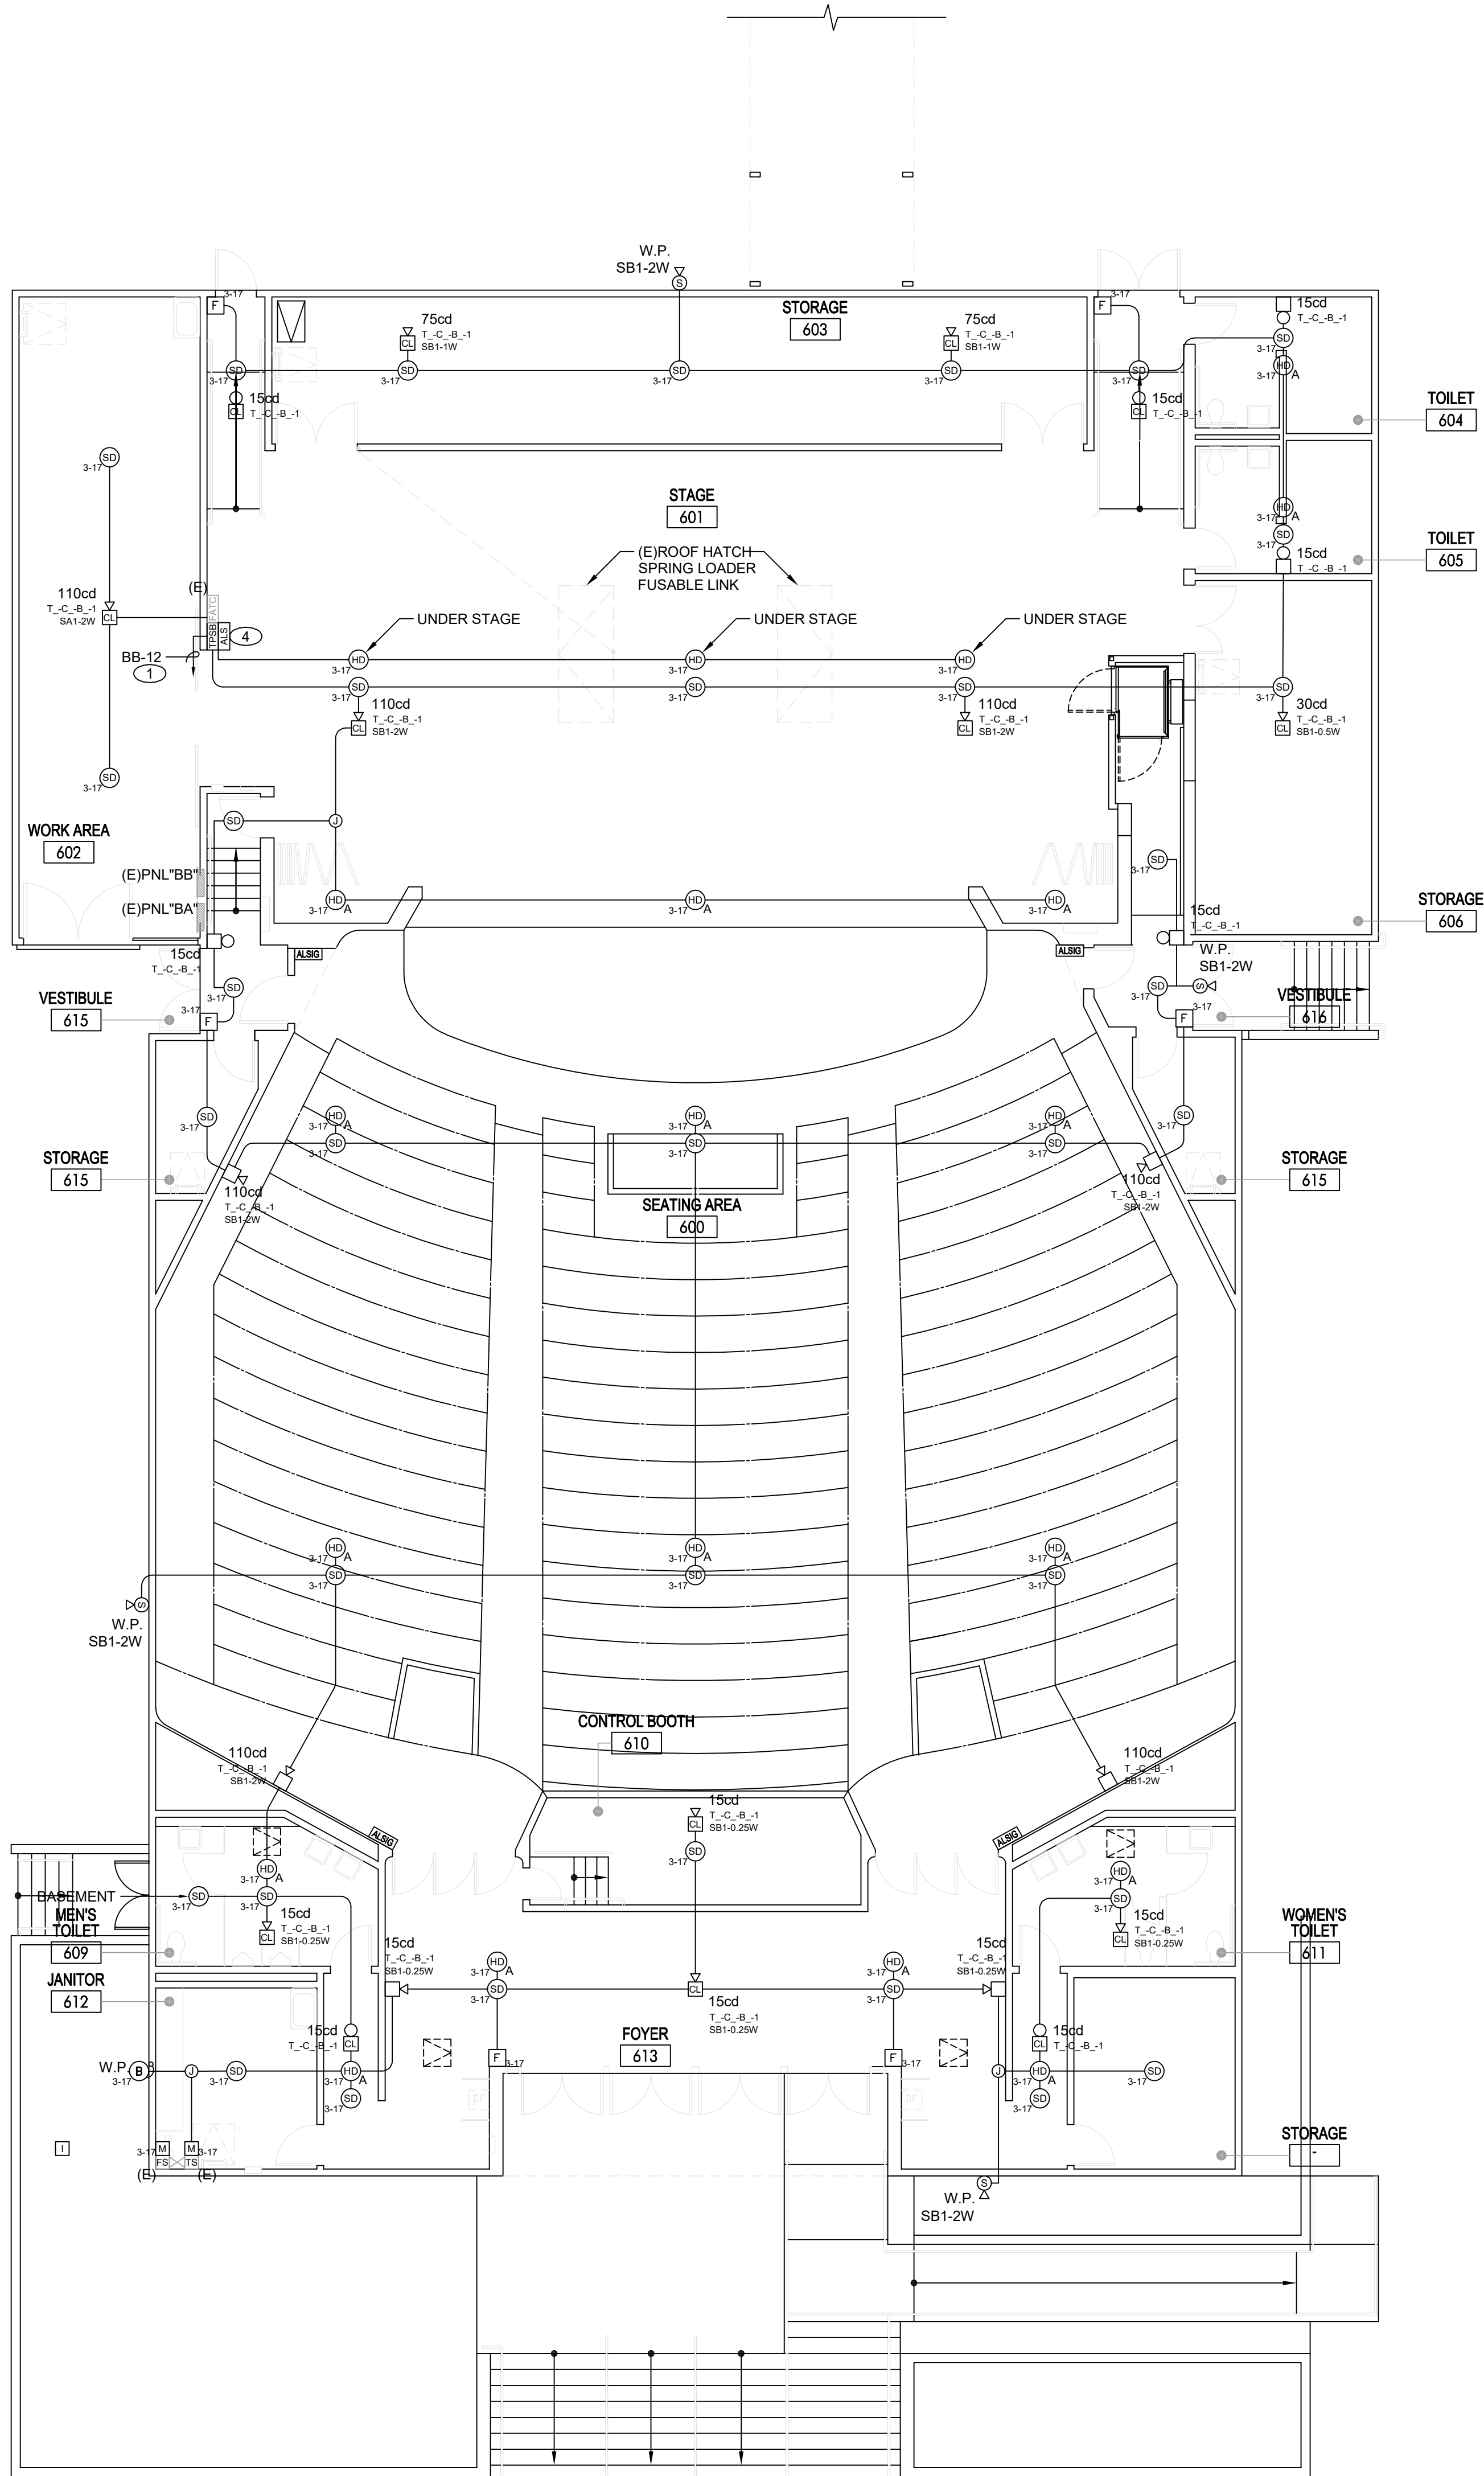
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Fire Alarm Building "A" Floor Plan

Sheet Number

EA321
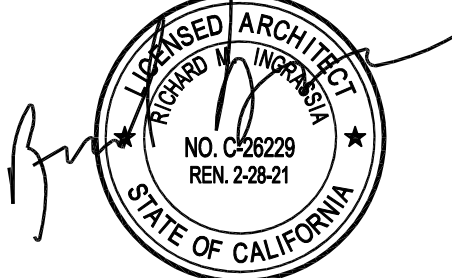
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BUILDING "B" - FIRE ALARM PLAN

SCALE
1/8" = 1'-0"

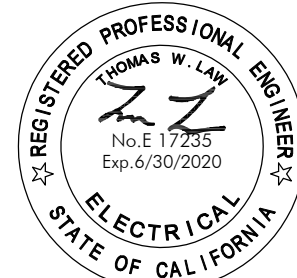1


GENERAL NOTES

- EXISTING CONDUIT MAYBE RE-USED FOR NEW WORK, PROVIDED THEY MEET MINIMUM CONDUIT SIZE REQUIREMENTS AND WIRE FILL CAPACITY (40%). OTHERWISE PROVIDE NEW CONDUITS. CONTRACTOR AT HIS OPTION MAY REUSE EXISTING CONDUITS WITHIN THE BUILDINGS/SITE AND PROVIDE NEW CONDUITS TO EXTEND TO NEW DEVICE LOCATIONS AS NECESSARY.
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- CONTRACTOR SHALL EXERCISE EXTREME CAUTION WHILE EXCAVATING FOR NEW UNDERGROUND UTILITIES. FIELD VERIFY AND COORDINATE PRIOR TO EXCAVATION. ANY DAMAGE TO EXISTING UNDERGROUND UTILITIES SHALL BE REPAIRED AND RESTORED TO ORIGINAL CONDITION IMMEDIATELY WITHOUT INTERRUPTION TO OPERATION OF FACILITIES AT NO ADDITIONAL COST TO THE OWNER. IT MAY BE NECESSARY TO RUN NEW UTILITIES UNDER/OVER EXISTING UTILITIES (CROSSOVER).
- AUTOMATIC SHUTOFF IS NOT REQUIRED WHEN ALL OCCUPIED ROOMS SERVED BY THE AIR-HANDLING EQUIPMENT HAVE DIRECT EXIT TO THE EXTERIOR AND THE TRAVEL DISTANCE DOES NOT EXCEED 100 FEET. (CMC 608 EXEMPTION#2)

REFERENCE NOTES

- PROVIDE NEW (1/20A 1P CIRCUIT BREAKER TO ELECTRICAL PANEL AS INDICATED. CIRCUIT BREAKER SHALL MATCH BY TYPE/STYLE/IC RATING. PROVIDE LOCK ON DEVICE TO CIRCUIT BREAKER HANDLE, WITH RED MARKING, ACCESSIBLE ONLY TO AUTHORIZED PERSONNEL, IDENTIFIED AS "FIRE ALARM CIRCUIT", AND LOCATION OF CIRCUIT BREAKER PERMANENTLY IDENTIFIED AT FIRE ALARM CONTROL UNIT IN COMPLIANCE WITH NFPA 72, 10.6.5.2.
- HVAC UNIT (FIELD VERIFY EXACT LOCATION). PROVIDE AUTOMATIC SHUT OFF PER CMC 608, WITH CONTROL RELAY MODULE (4090-9002, IDNET RELAY (RM) AND 120V RELAY MODULES (2089-9006, FIRE ALARM CONTROL RELAY, 1 SPDT CONTACTS RATED 10A, 120VAC) (LOCATE ABOVE ACCESSIBLE CEILING SPACE BELOW HVAC UNIT). SEE WIRING DIAGRAM ON SHEET 8/E401. CONNECT 120V POWER CIRCUIT TO 120V RELAY MODULES. PROVIDE LOCK ON DEVICE TO CIRCUIT BREAKER HANDLE, WITH RED MARKING.
- PROVIDE NEW ACCESS PANEL. SEE ARCHITECTURAL DRAWINGS.
- ASSISTIVE LISTENING SYSTEM (ALS) SEE SPECIFICATION SECTION 283101 SYSTEM. PROVIDE ASSISTIVE LISTENING SIGNAGE SEE DETAIL 7/E402. EACH MULTI-PURPOSE ROOM WITH 50 OR MORE SEATS SHALL RECEIVE A QUANTITY OF ASSISTIVE LISTENING SYSTEM RECEIVERS THAT EQUALS AT LEAST 4% OF NUMBER OF SEATS IN THE ROOM (ROUNDING UP TO NEAREST INTEGER), OR AT LEAST 2. VERIFY REQUIRED QUANTITY PER OCCUPANT LOAD OF THE ROOM. PROVIDE QUANTITY PER SPECIFICATION.

KEY PLAN

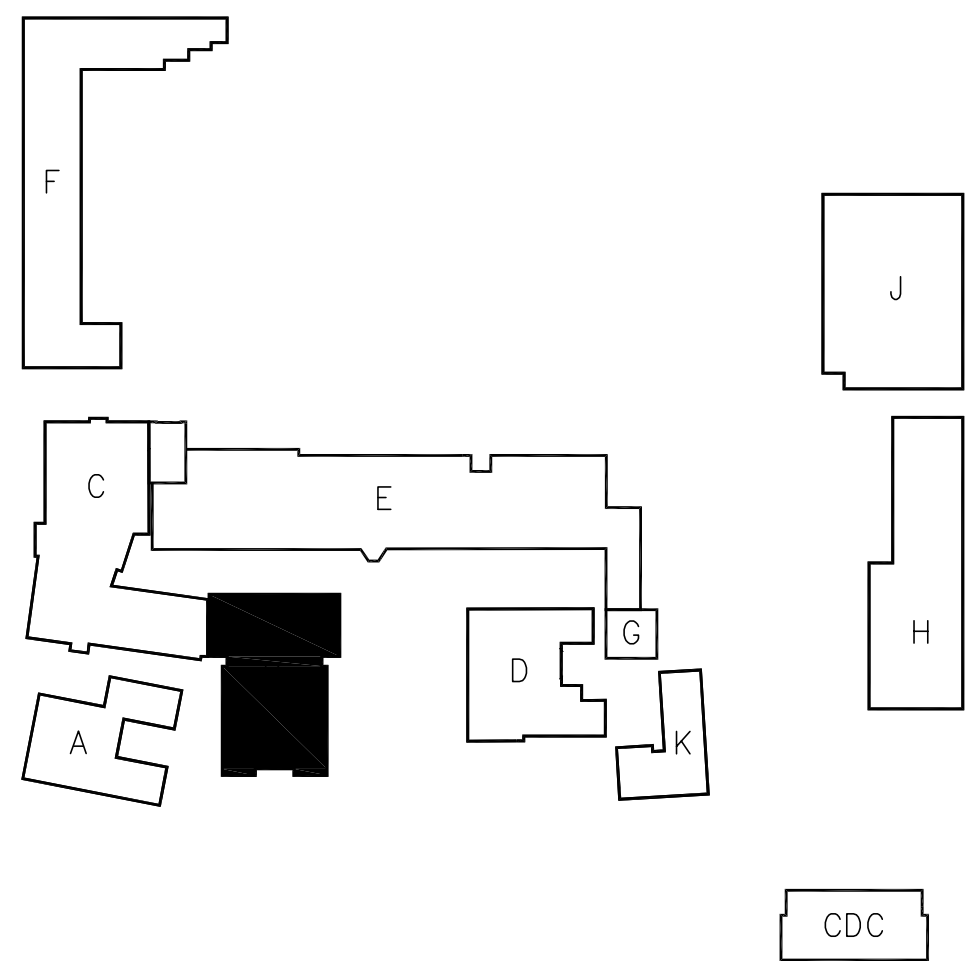

APPL. No. A 00-123456

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Architect



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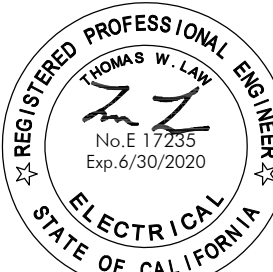
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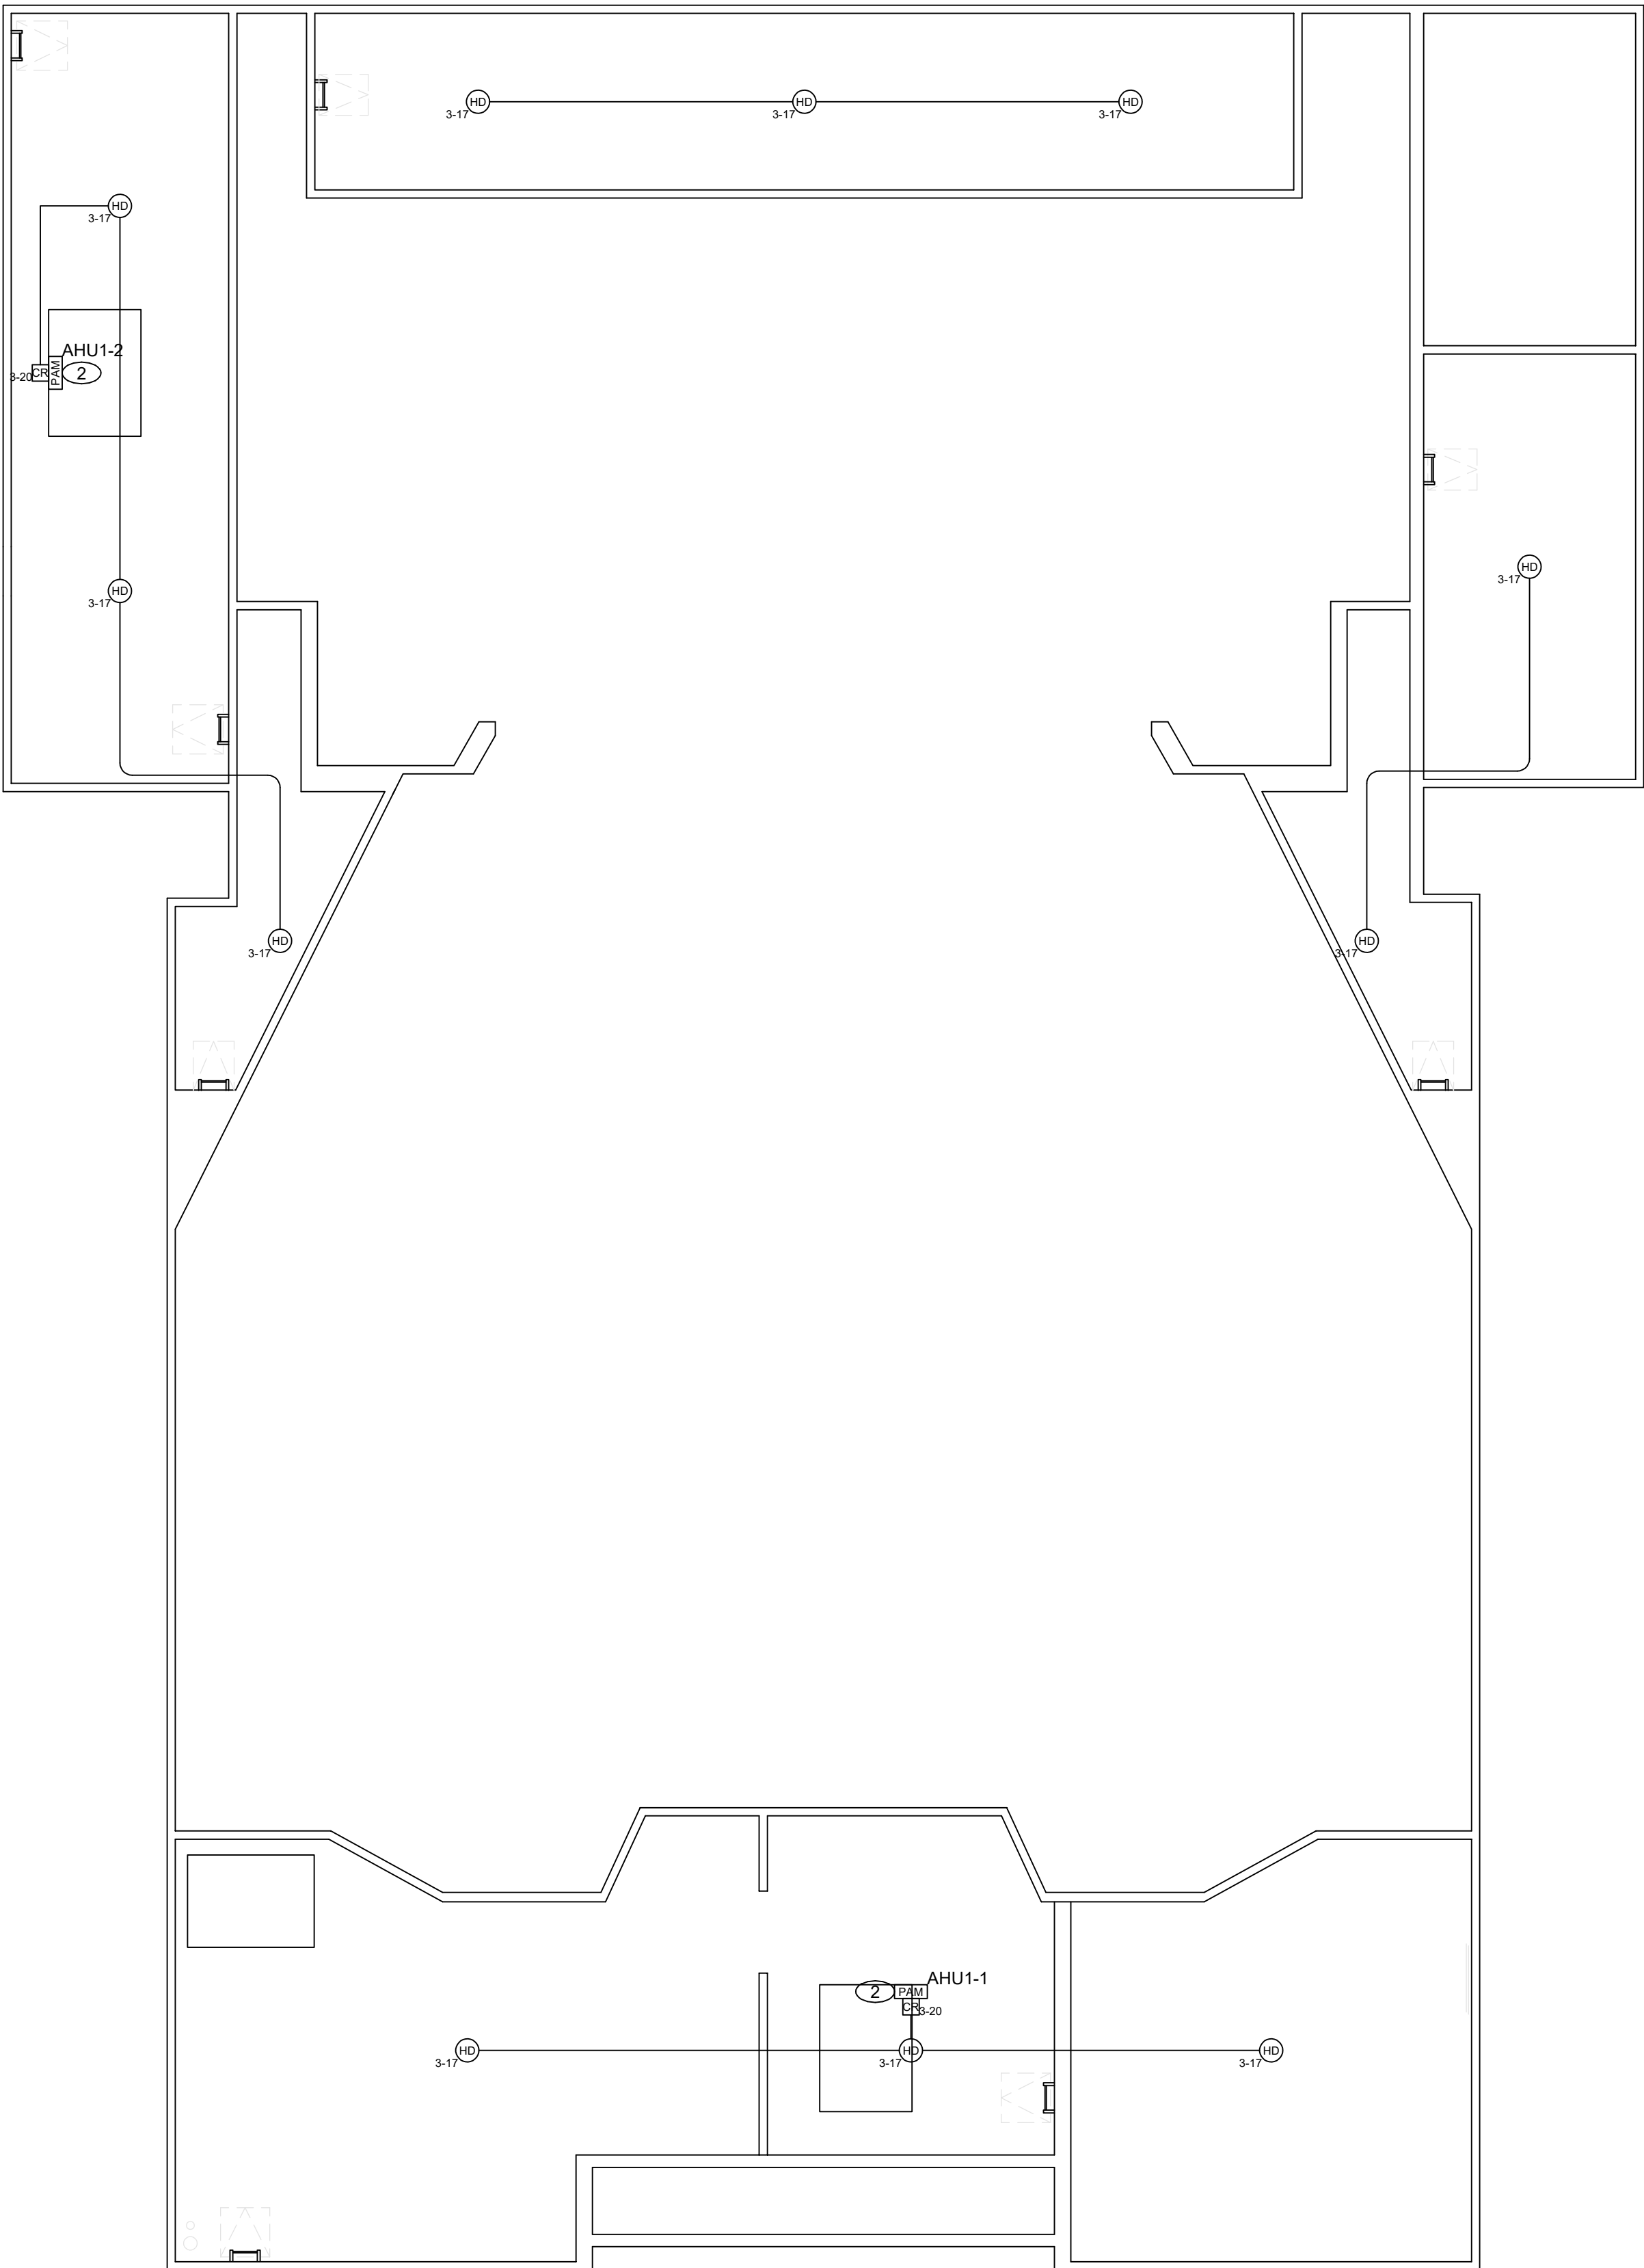


Sheet Title

Fire Alarm
Building "B"
Floor Plan

Sheet Number

EB321




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- PROVIDE NEW ACCESS PANEL. SEE ARCHITECTURAL DRAWINGS



BUILDING "B" - FIRE ALARM MEZZANINE PLAN

SCALE
1/8" = 1'-0"

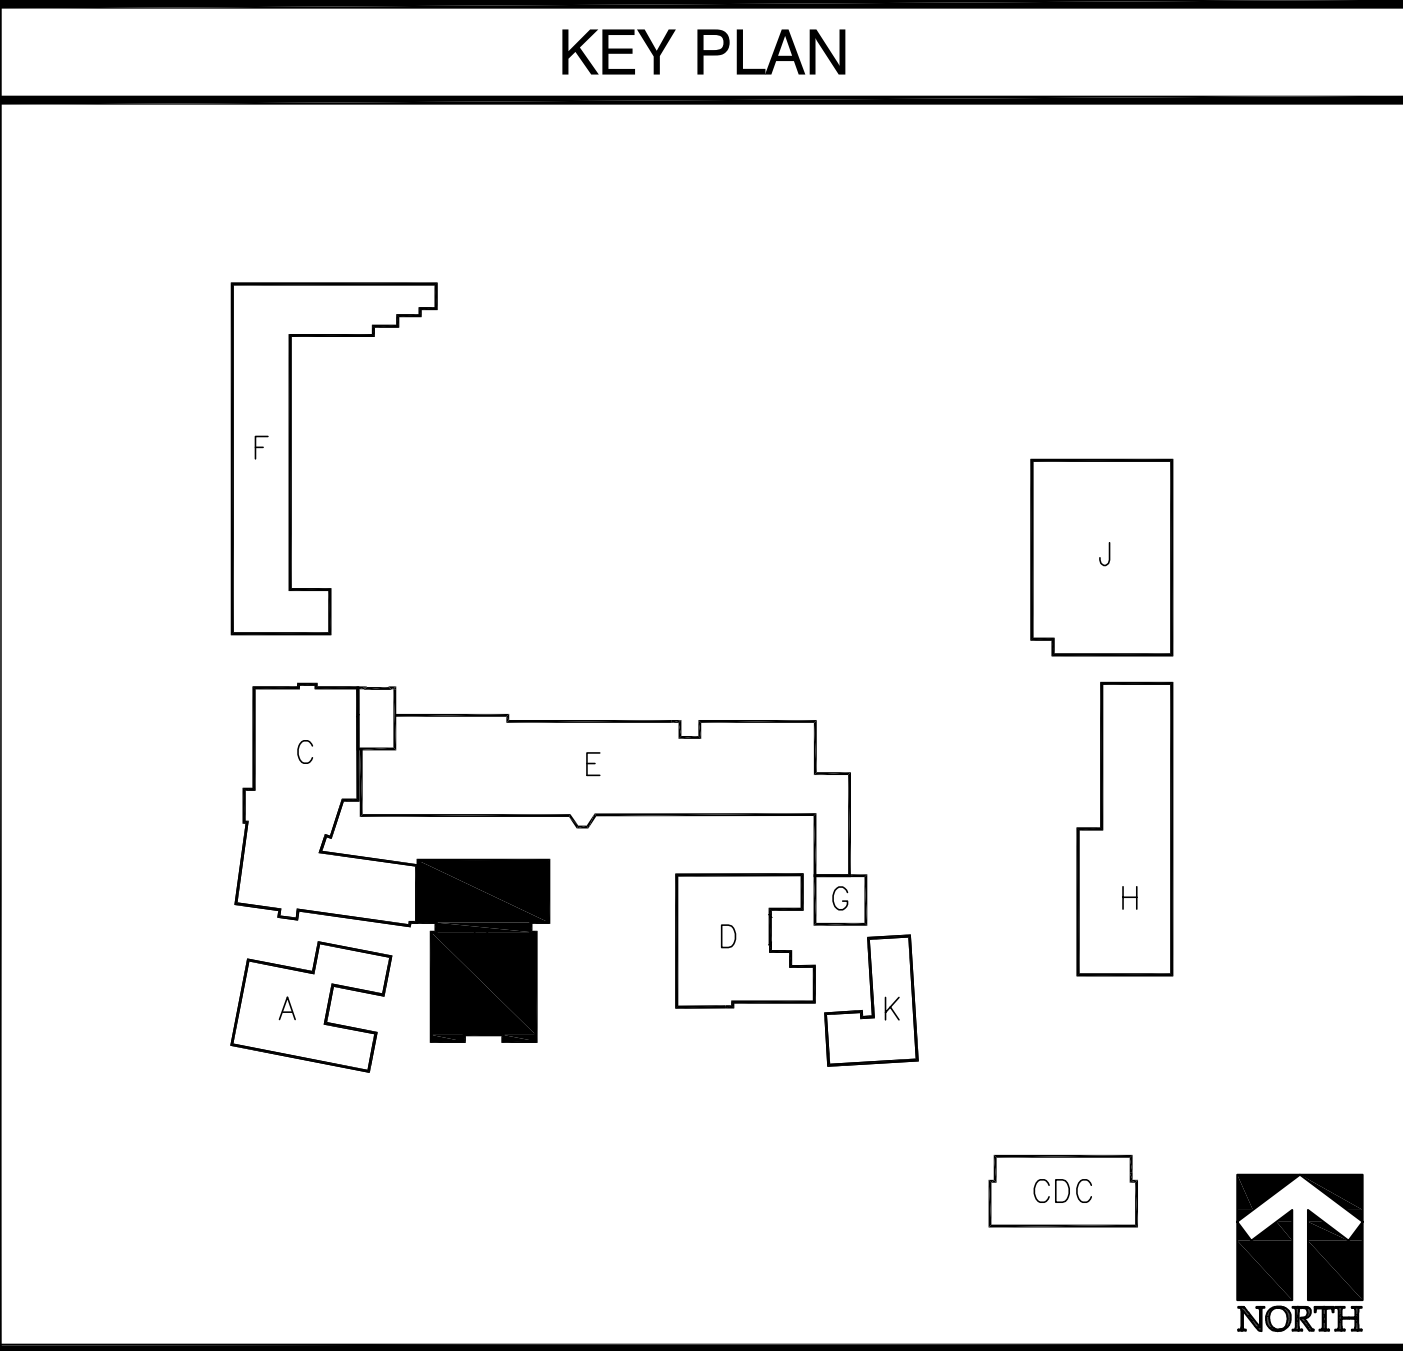1

APPL. No. A 00-123456

DSA Stamp

Architect



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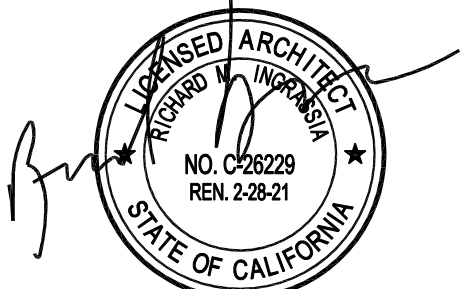
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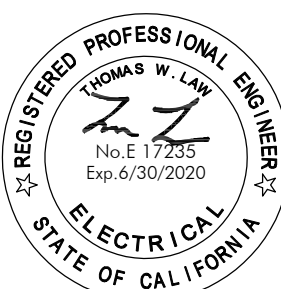
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Date:
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Drawn By: RS, TL
Checked By: BA

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Sheet Title
Fire Alarm Building "B" Mezzanine Floor Plan

Sheet Number

EB322



BUILDING "C" - FIRE ALARM FIRST FLOOR PLAN

SCALE
1/8" = 1'-0"

1


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- PROVIDE NEW ACCESS PANEL. SEE ARCHITECTURAL DRAWINGS.
- CONNECT CONTROL RELAY MODULE (A4090-9002, IDNET RELAY IAM) AND 120V RELAY MODULES (A2088-9008, FIRE ALARM CONTROL RELAY, 1 SPDT CONTACTS RATED 10A, 120VAC) TO EXISTING FIRE SMOKE DAMPER CIRCUIT SERVED BY EACH 120 VOLT CIRCUIT SERVING FIRE SMOKE DAMPERS. SEE WIRING DIAGRAM ON SHEET 9/E401. CONNECT 120V POWER CIRCUIT TO 120V RELAY MODULES AS INDICATED. PROVIDE LOCK ON DEVICE TO CIRCUIT BREAKER HANDLE, WITH RED MARKING.
- PROVIDE CONTROL RELAY MODULE (A4090-9002, IDNET RELAY IAM) FOR PRIMARY RECALL. PROVIDE CONTROL RELAY MODULE (A4090-9002, IDNET RELAY IAM) FOR ALTERNATE RECALL. PROVIDE CONTROL RELAY MODULE (A4090-9002, IDNET RELAY IAM) FOR SHUNT TRIP. PROVIDE CONTROL RELAY MODULE (A4090-9002, IDNET RELAY IAM) FOR ELEVATOR WARNING. PROVIDE 120V RELAY MODULES (A2088-9008, FIRE ALARM CONTROL RELAY, 1 SPDT CONTACTS RATED 10A, 120VAC) FOR MONITORING SHUNT TRIP BREAKER POWER. PROVIDE LOCK ON DEVICE TO CIRCUIT BREAKER HANDLE, WITH RED MARKING. PROVIDE SINGLE INPUT MODULE (A4090-9001, IDNET SUPERVISED IAM) FOR MONITOR SHUNT TRIP RELAY.

KEY PLAN



APPL. No. A 00-123456

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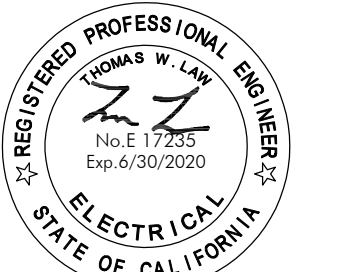
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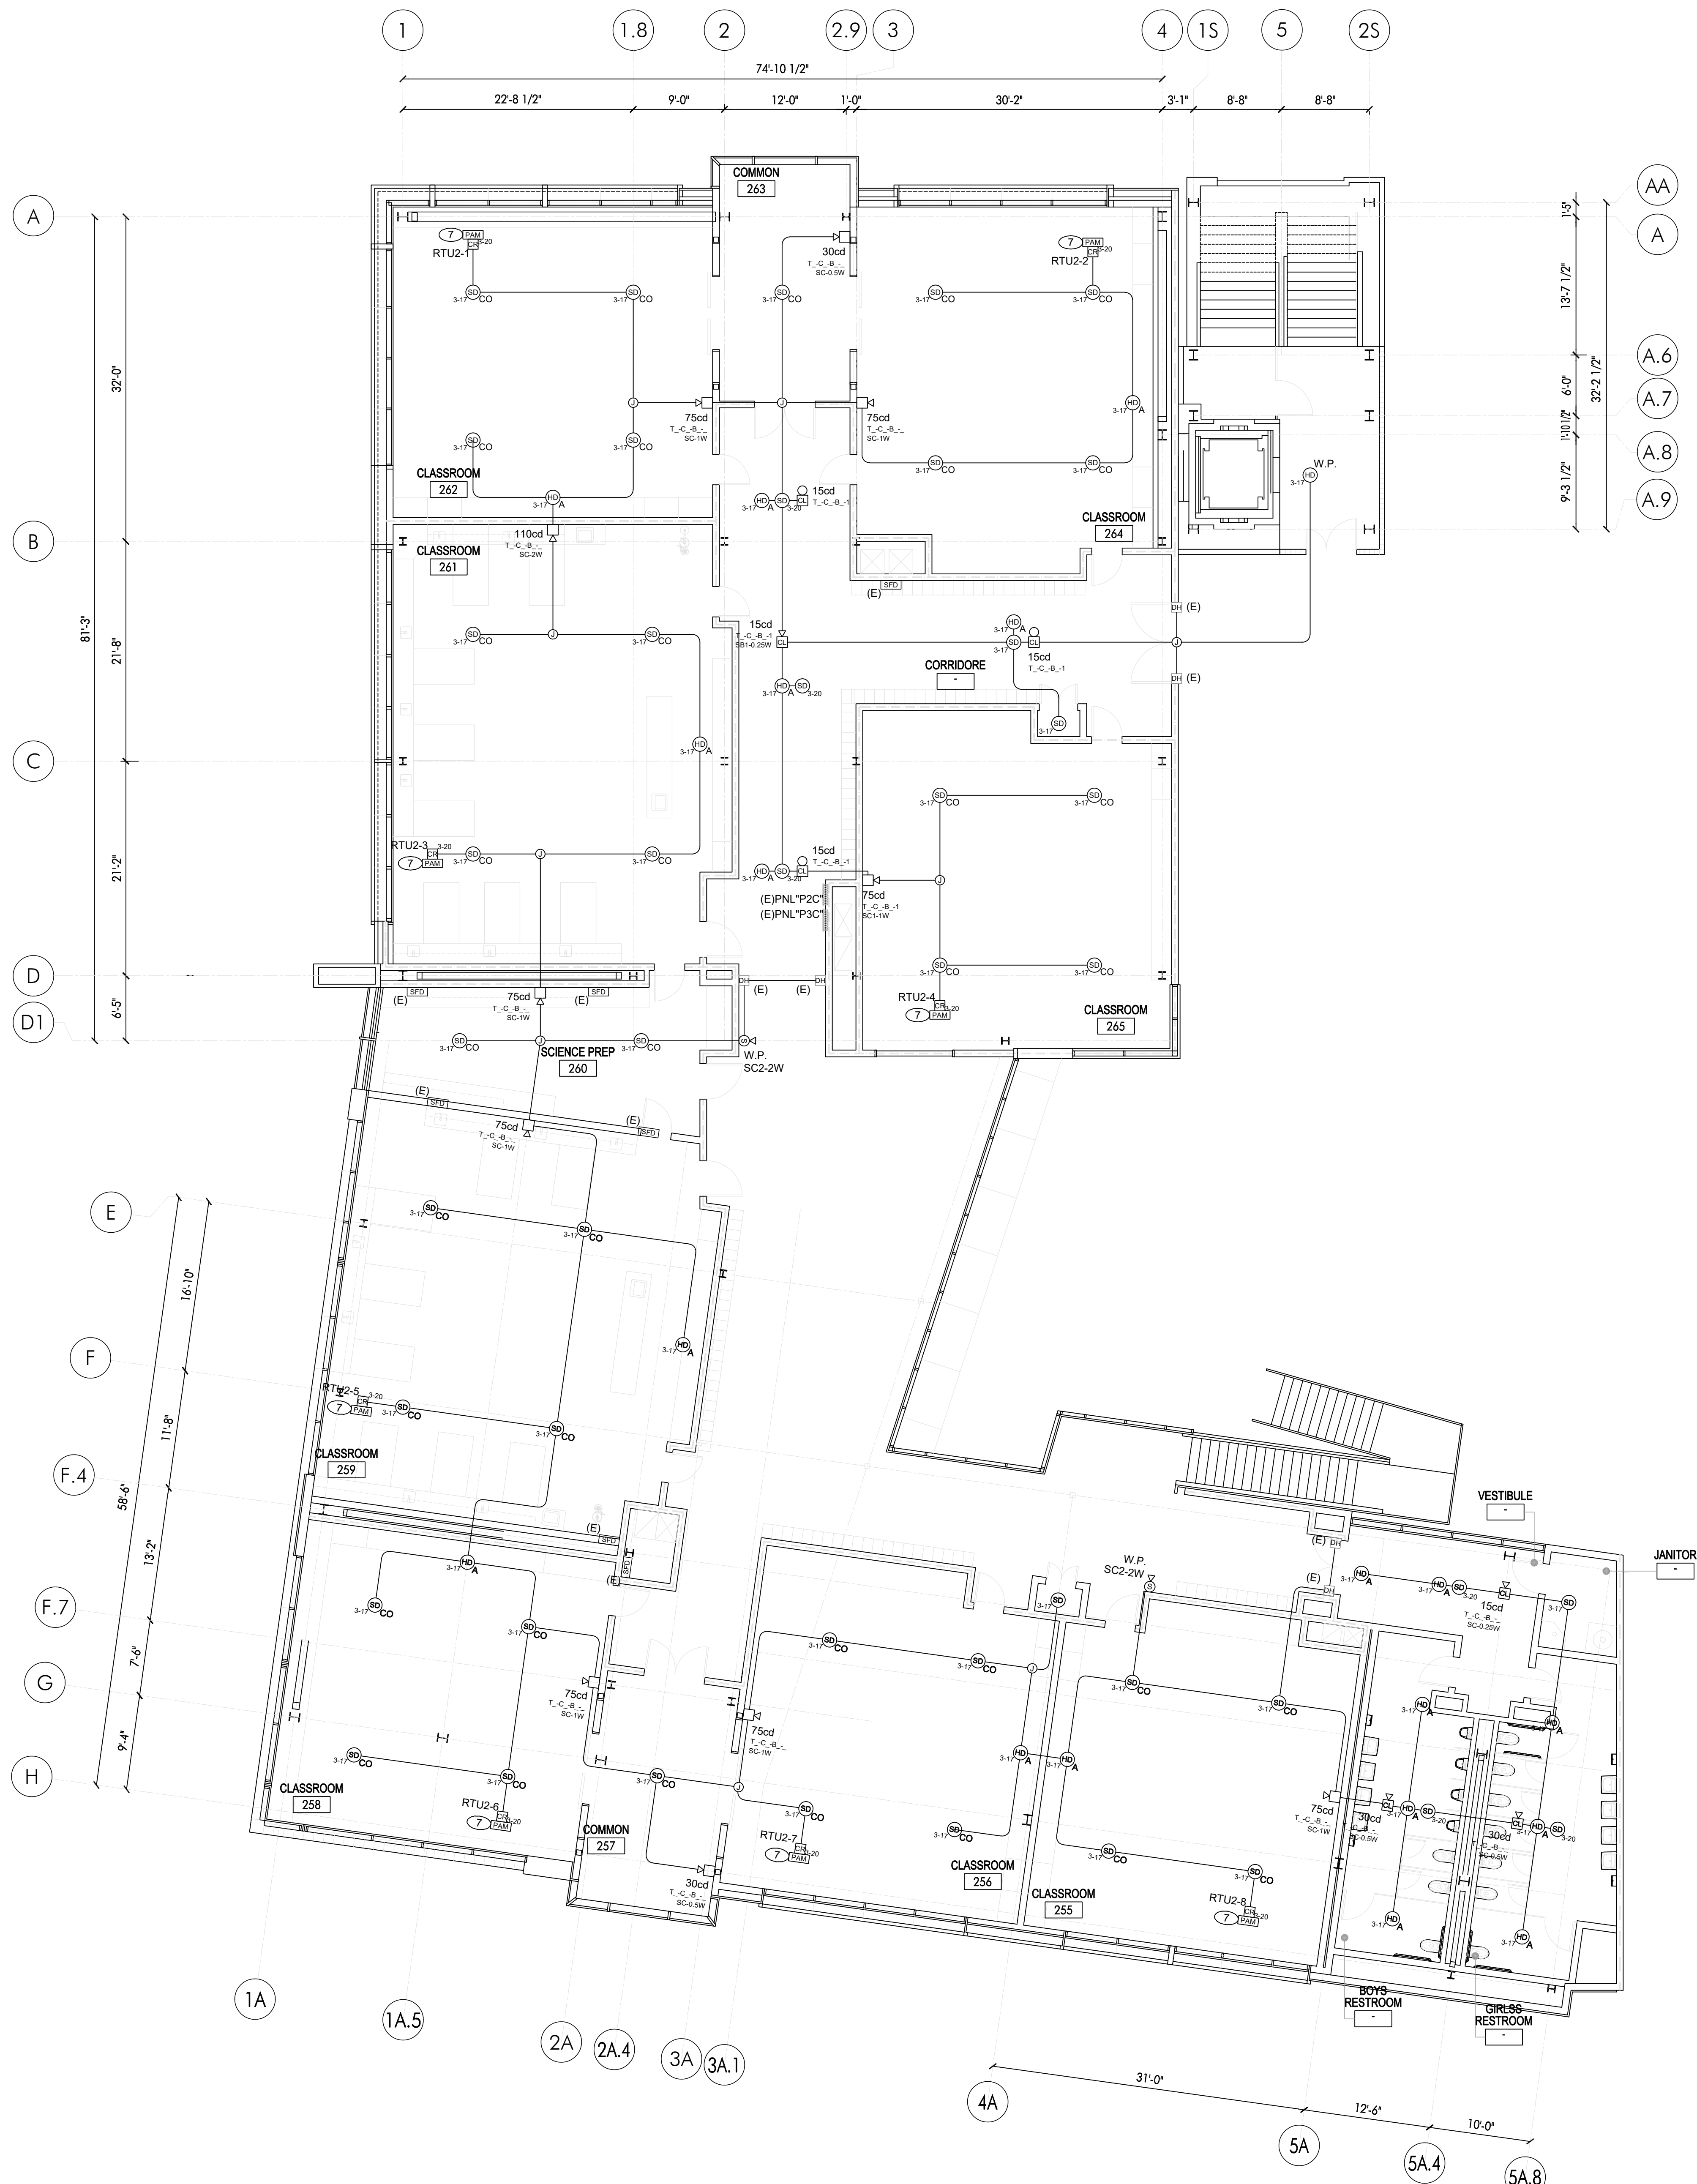


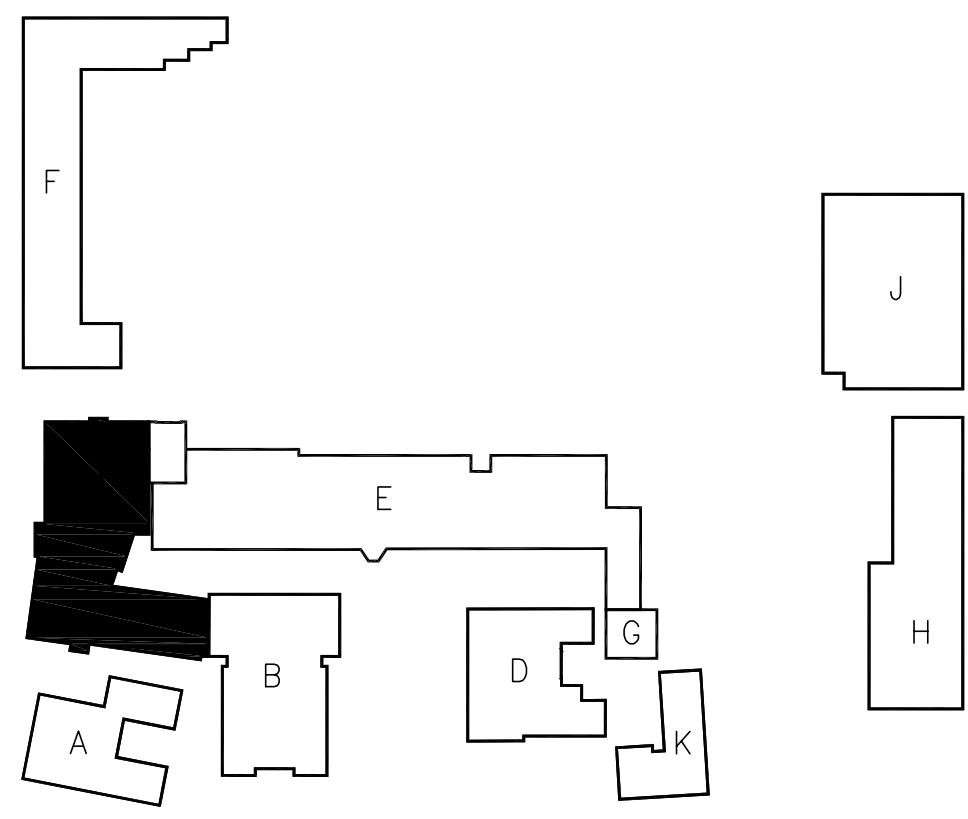Sheet Title

Fire Alarm
Building "C"
First Floor Plan

Sheet Number

EC321




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- EXISTING COOKING KITCHEN (TYPE I HOOD), CONNECT HEAT DETECTOR WITH SINGLE INPUT MODULE (4090-9001, IDNET SUPERVISED IAM) FOR MONITORING UL300 COMPLAINT FIRE SUPPRESSION SYSTEM. PROVIDE CONNECTION FROM ANSUL SYSTEM FOR FIRE ALARM SYSTEM MONITORING. PROVIDE CLASS K PORTABLE FIRE EXTINGUISHER OF A MINIMUM 1.5-GALLON CAPACITY FOR COMMERCIAL COOKING EQUIPMENT. FIELD VERIFY LOCATION WITHIN 30 FEET FROM COOKING SURFACE.
- PROVIDE (2) DEDICATED PHONE LINES (ANALOG) TO MDF/IDF WITHIN THE BUILDING FOR REMOTE STATION MONITORING.
- PROVIDE A SIGNAGE "FIRE ALARM CONTROL PANEL INSIDE" AT THE DOOR TO FACP/FCPS. SEE DETAIL ON 6/E402. PATCH/PAINT/REPAIR TO MATCH ADJACENT SURFACES.
- ASSISTIVE LISTENING SYSTEM (ALS) SEE SPECIFICATION SECTION 283101 SYSTEM. PROVIDE ASSISTIVE LISTENING SIGNAGE SEE DETAIL 7/E402. EACH MULTI-PURPOSE ROOM WITH 50 OR MORE SEATS SHALL RECEIVE A QUANTITY OF ASSISTIVE LISTENING SYSTEM RECEIVERS THAT EQUALS AT LEAST 4% OF NUMBER OF SEATS IN THE ROOM (ROUNDING UP TO NEAREST INTEGER), OR AT LEAST 2. VERIFY REQUIRED QUANTITY PER OCCUPANT LOAD OF THE ROOM. PROVIDE QUANTITY PER SPECIFICATION.

KEY PLAN



BUILDING "C" - FIRE ALARM SECOND FLOOR PLAN

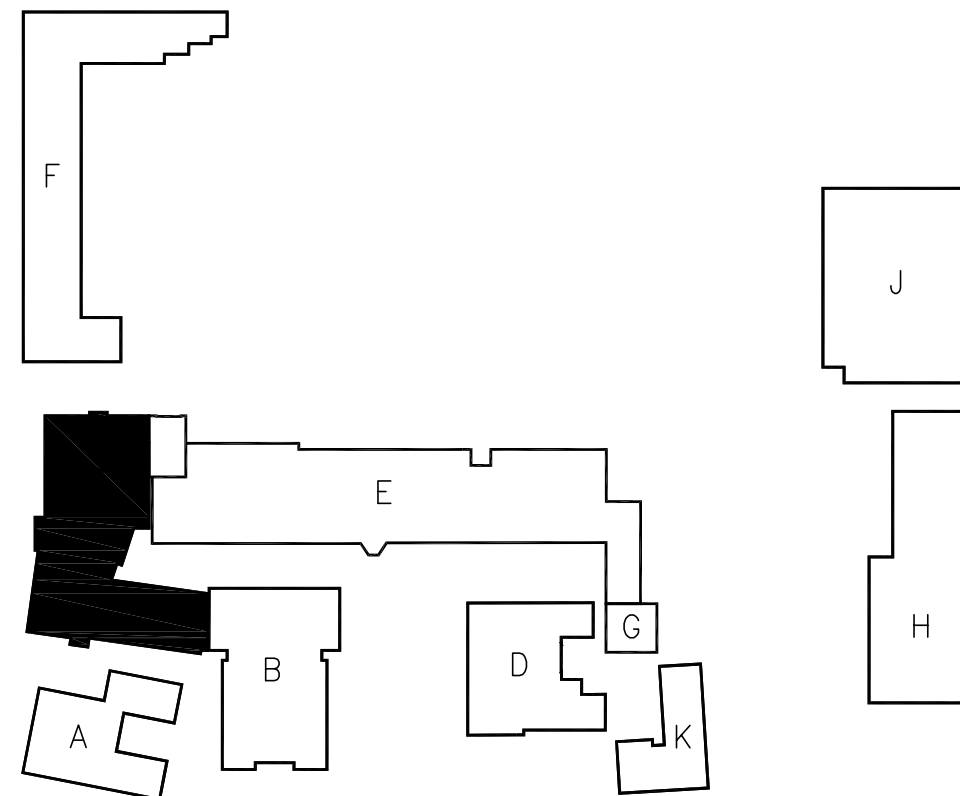

SCALE
1/8" = 1'-0"

1

DSA Stamp

Architect



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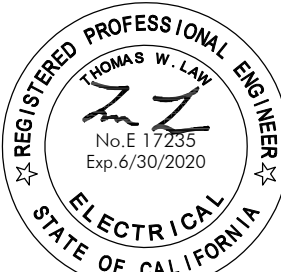
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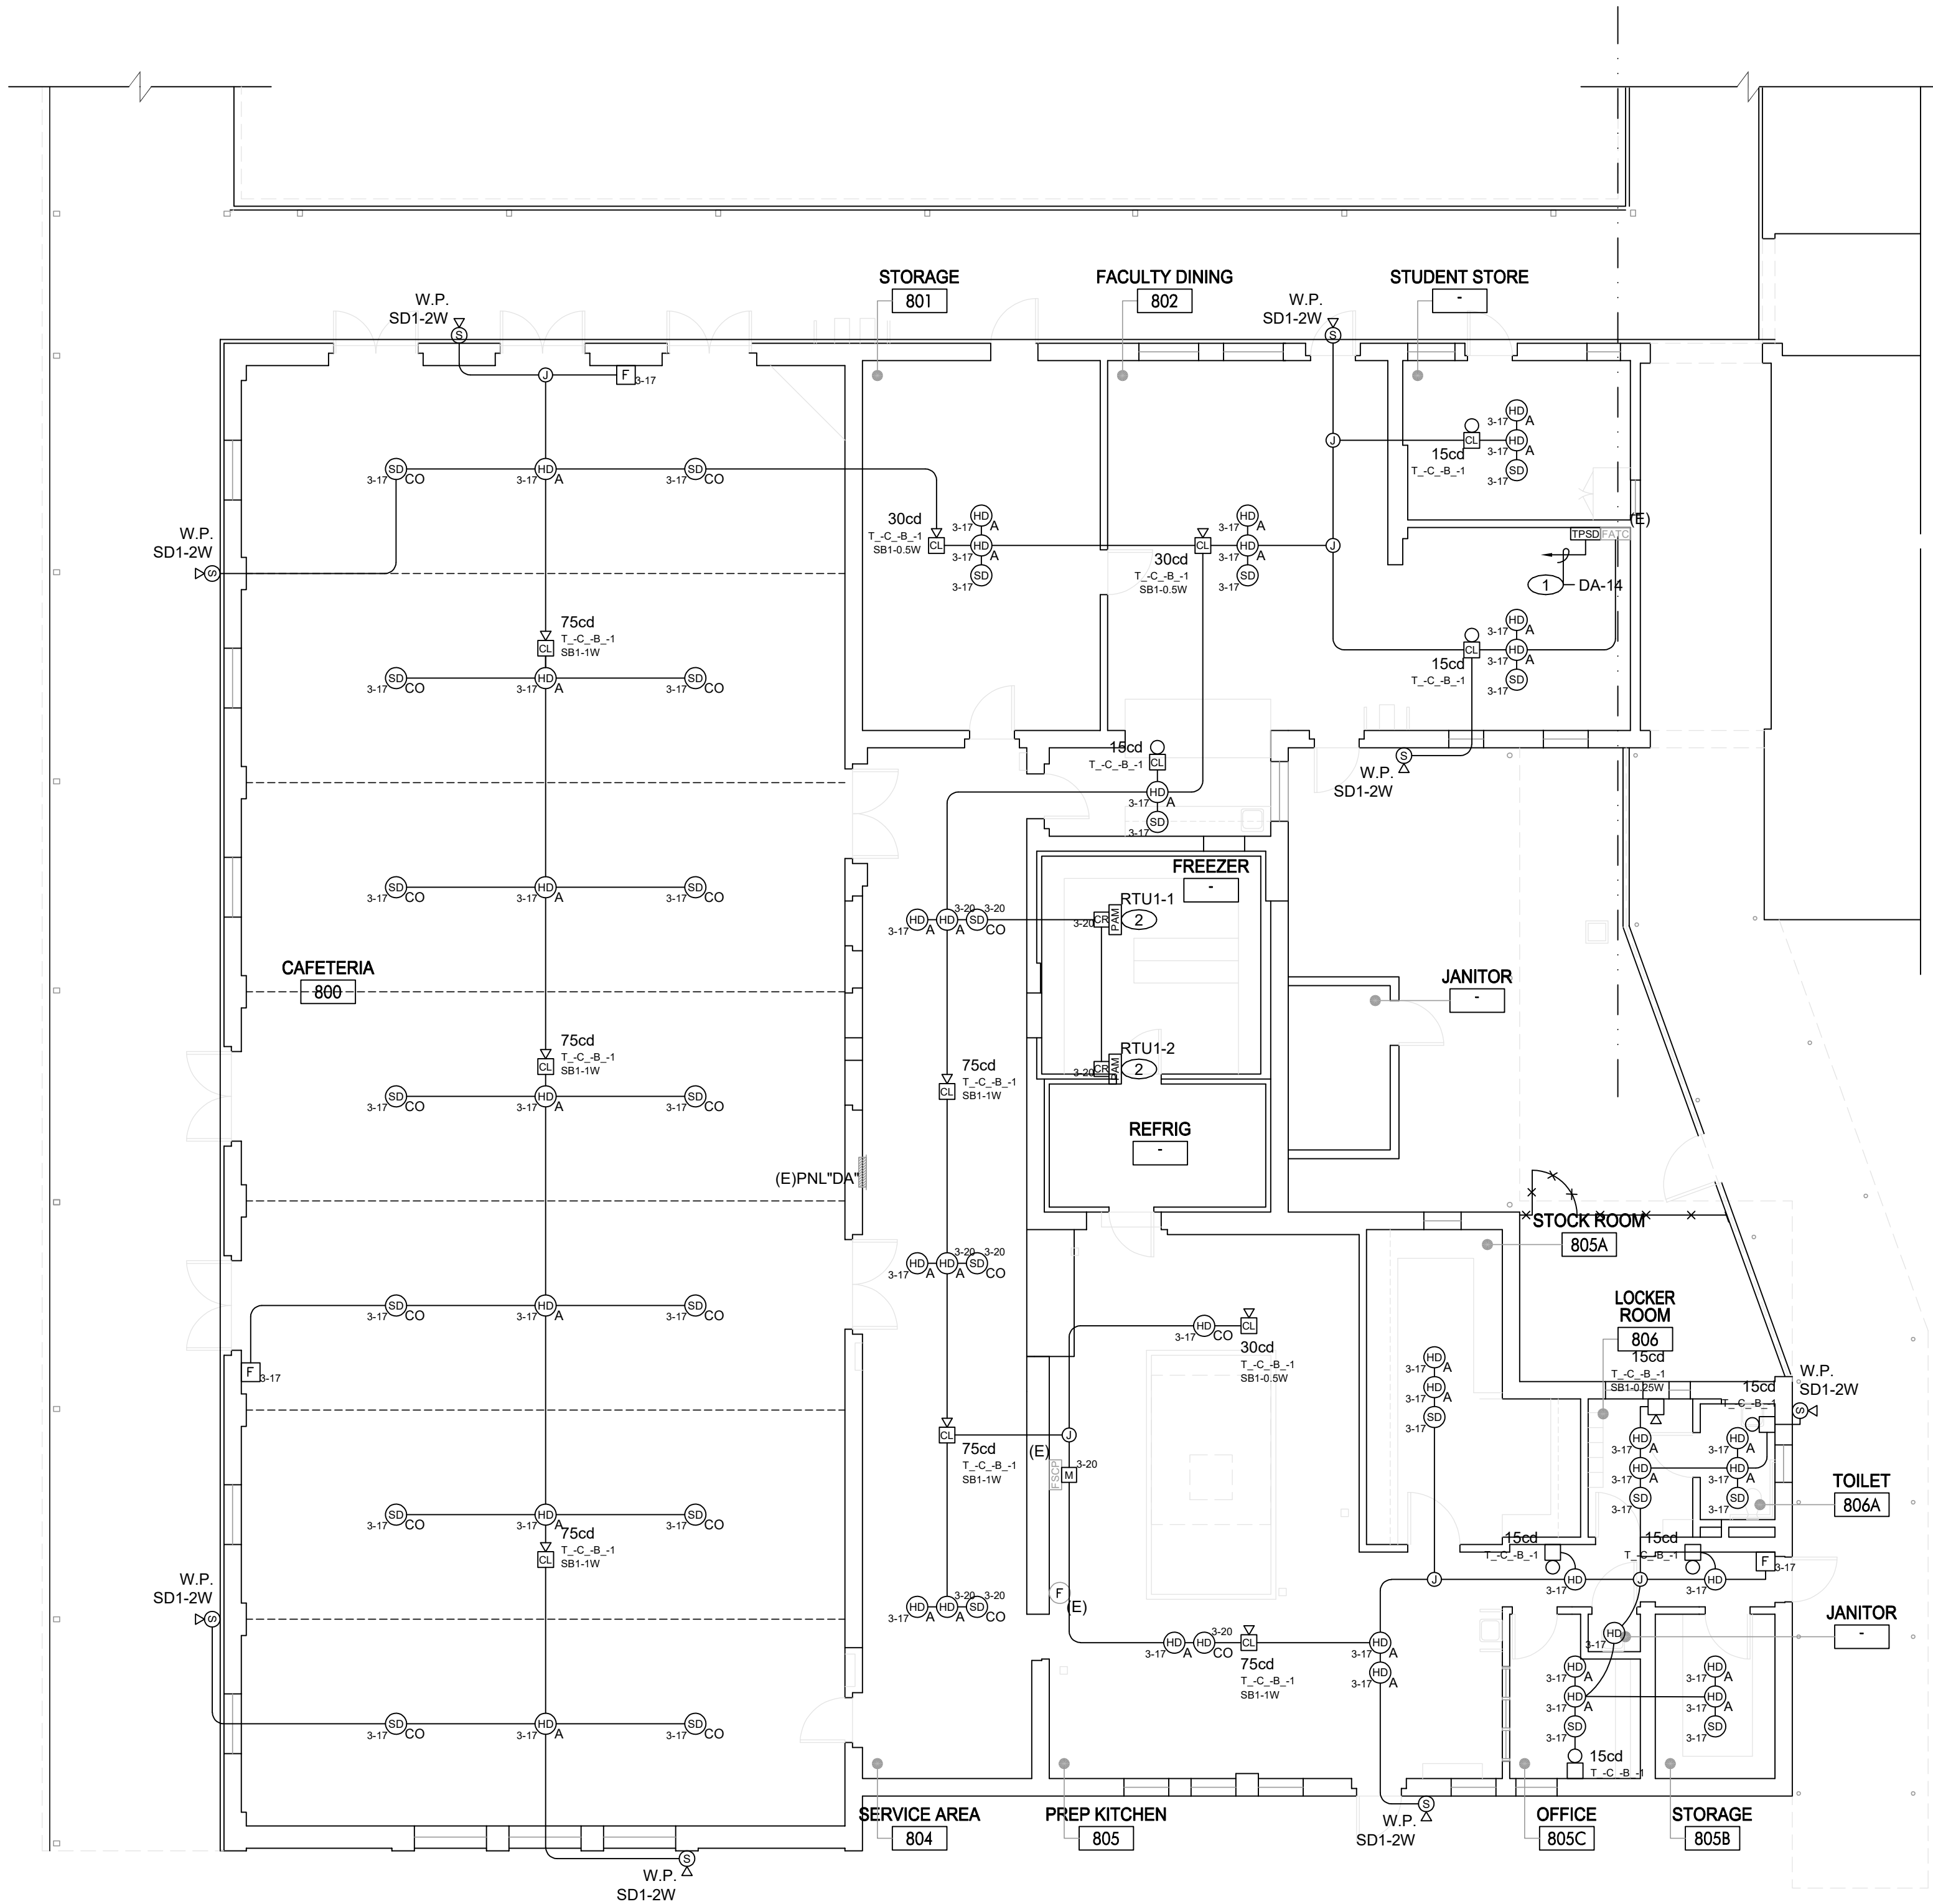


Sheet Title
Fire Alarm
Building "C"
Second Floor Plan

Sheet Number

EC322





BUILDING "D" - FIRE ALARM PLAN

SCALE	1
1/8" = 1'-0"	


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KEY PLAN



DSA Stamp

Architect

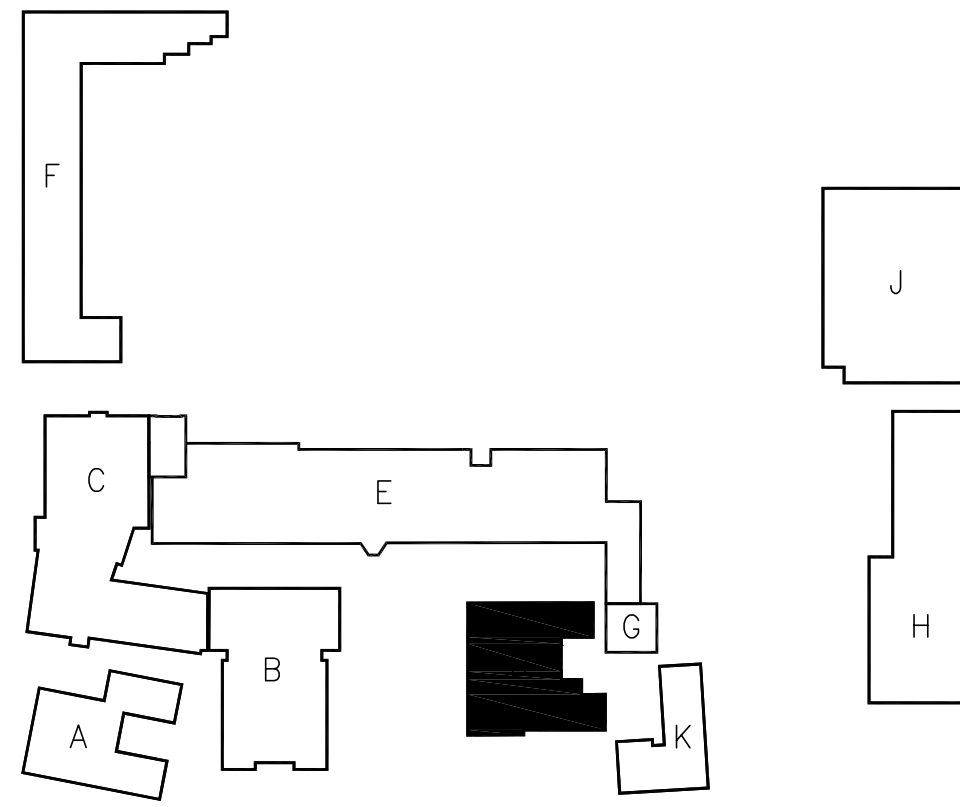

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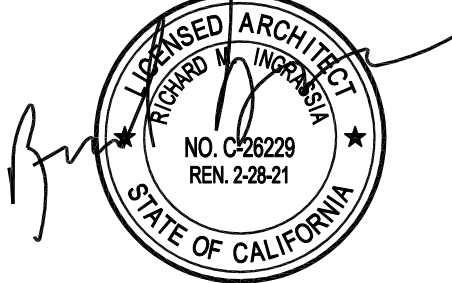
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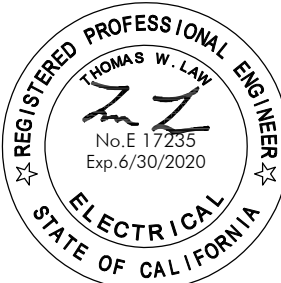
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Date:
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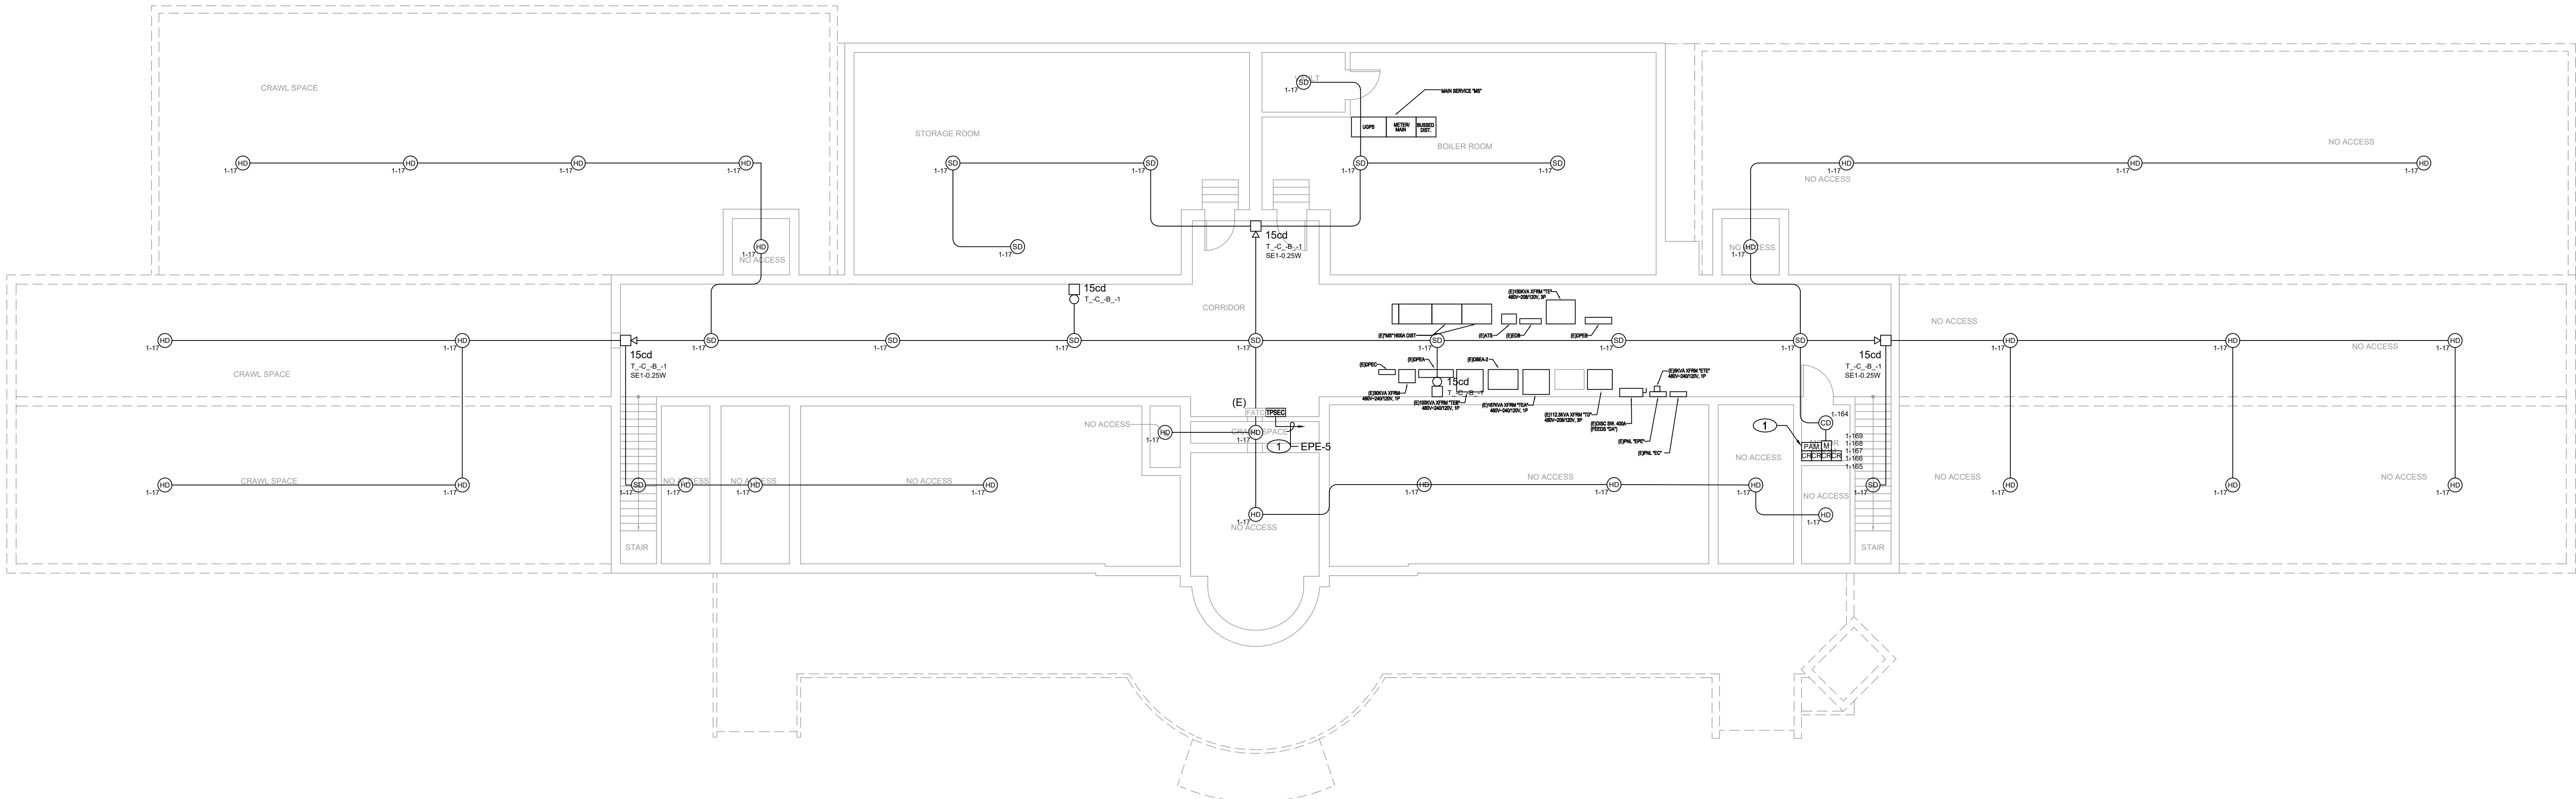
Fire Alarm
Building "D"
Floor Plan

Sheet Number

ED321

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BUILDING "E"



BUILDING "E" - FIRE ALARM BASEMENT FLOOR PLAN			
			SCALE 1/8" = 1'-0"
			1
GENERAL NOTES	REFERENCE NOTES	KEY PLAN	
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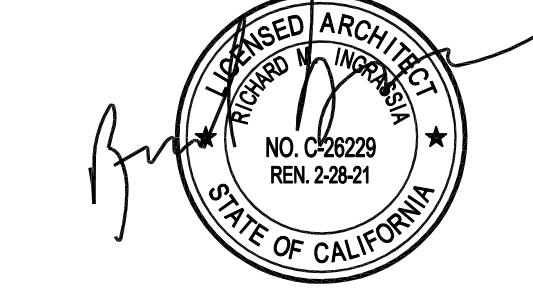
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1501 California Avenue
Santa Monica, California 90403


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Sheet Title
Fire Alarm
Building "E"
Basement Floor Plan

Sheet Number

EE320

Lincoln Middle School
1501 California Avenue

EE321A

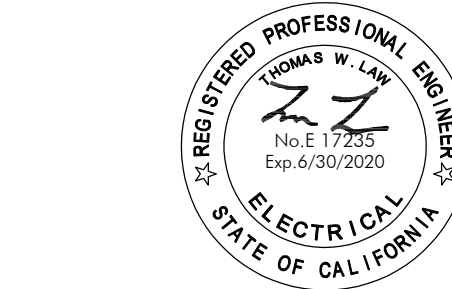

SCALE
1/8" = 1'-0"


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KEY PLAN

-

CDC



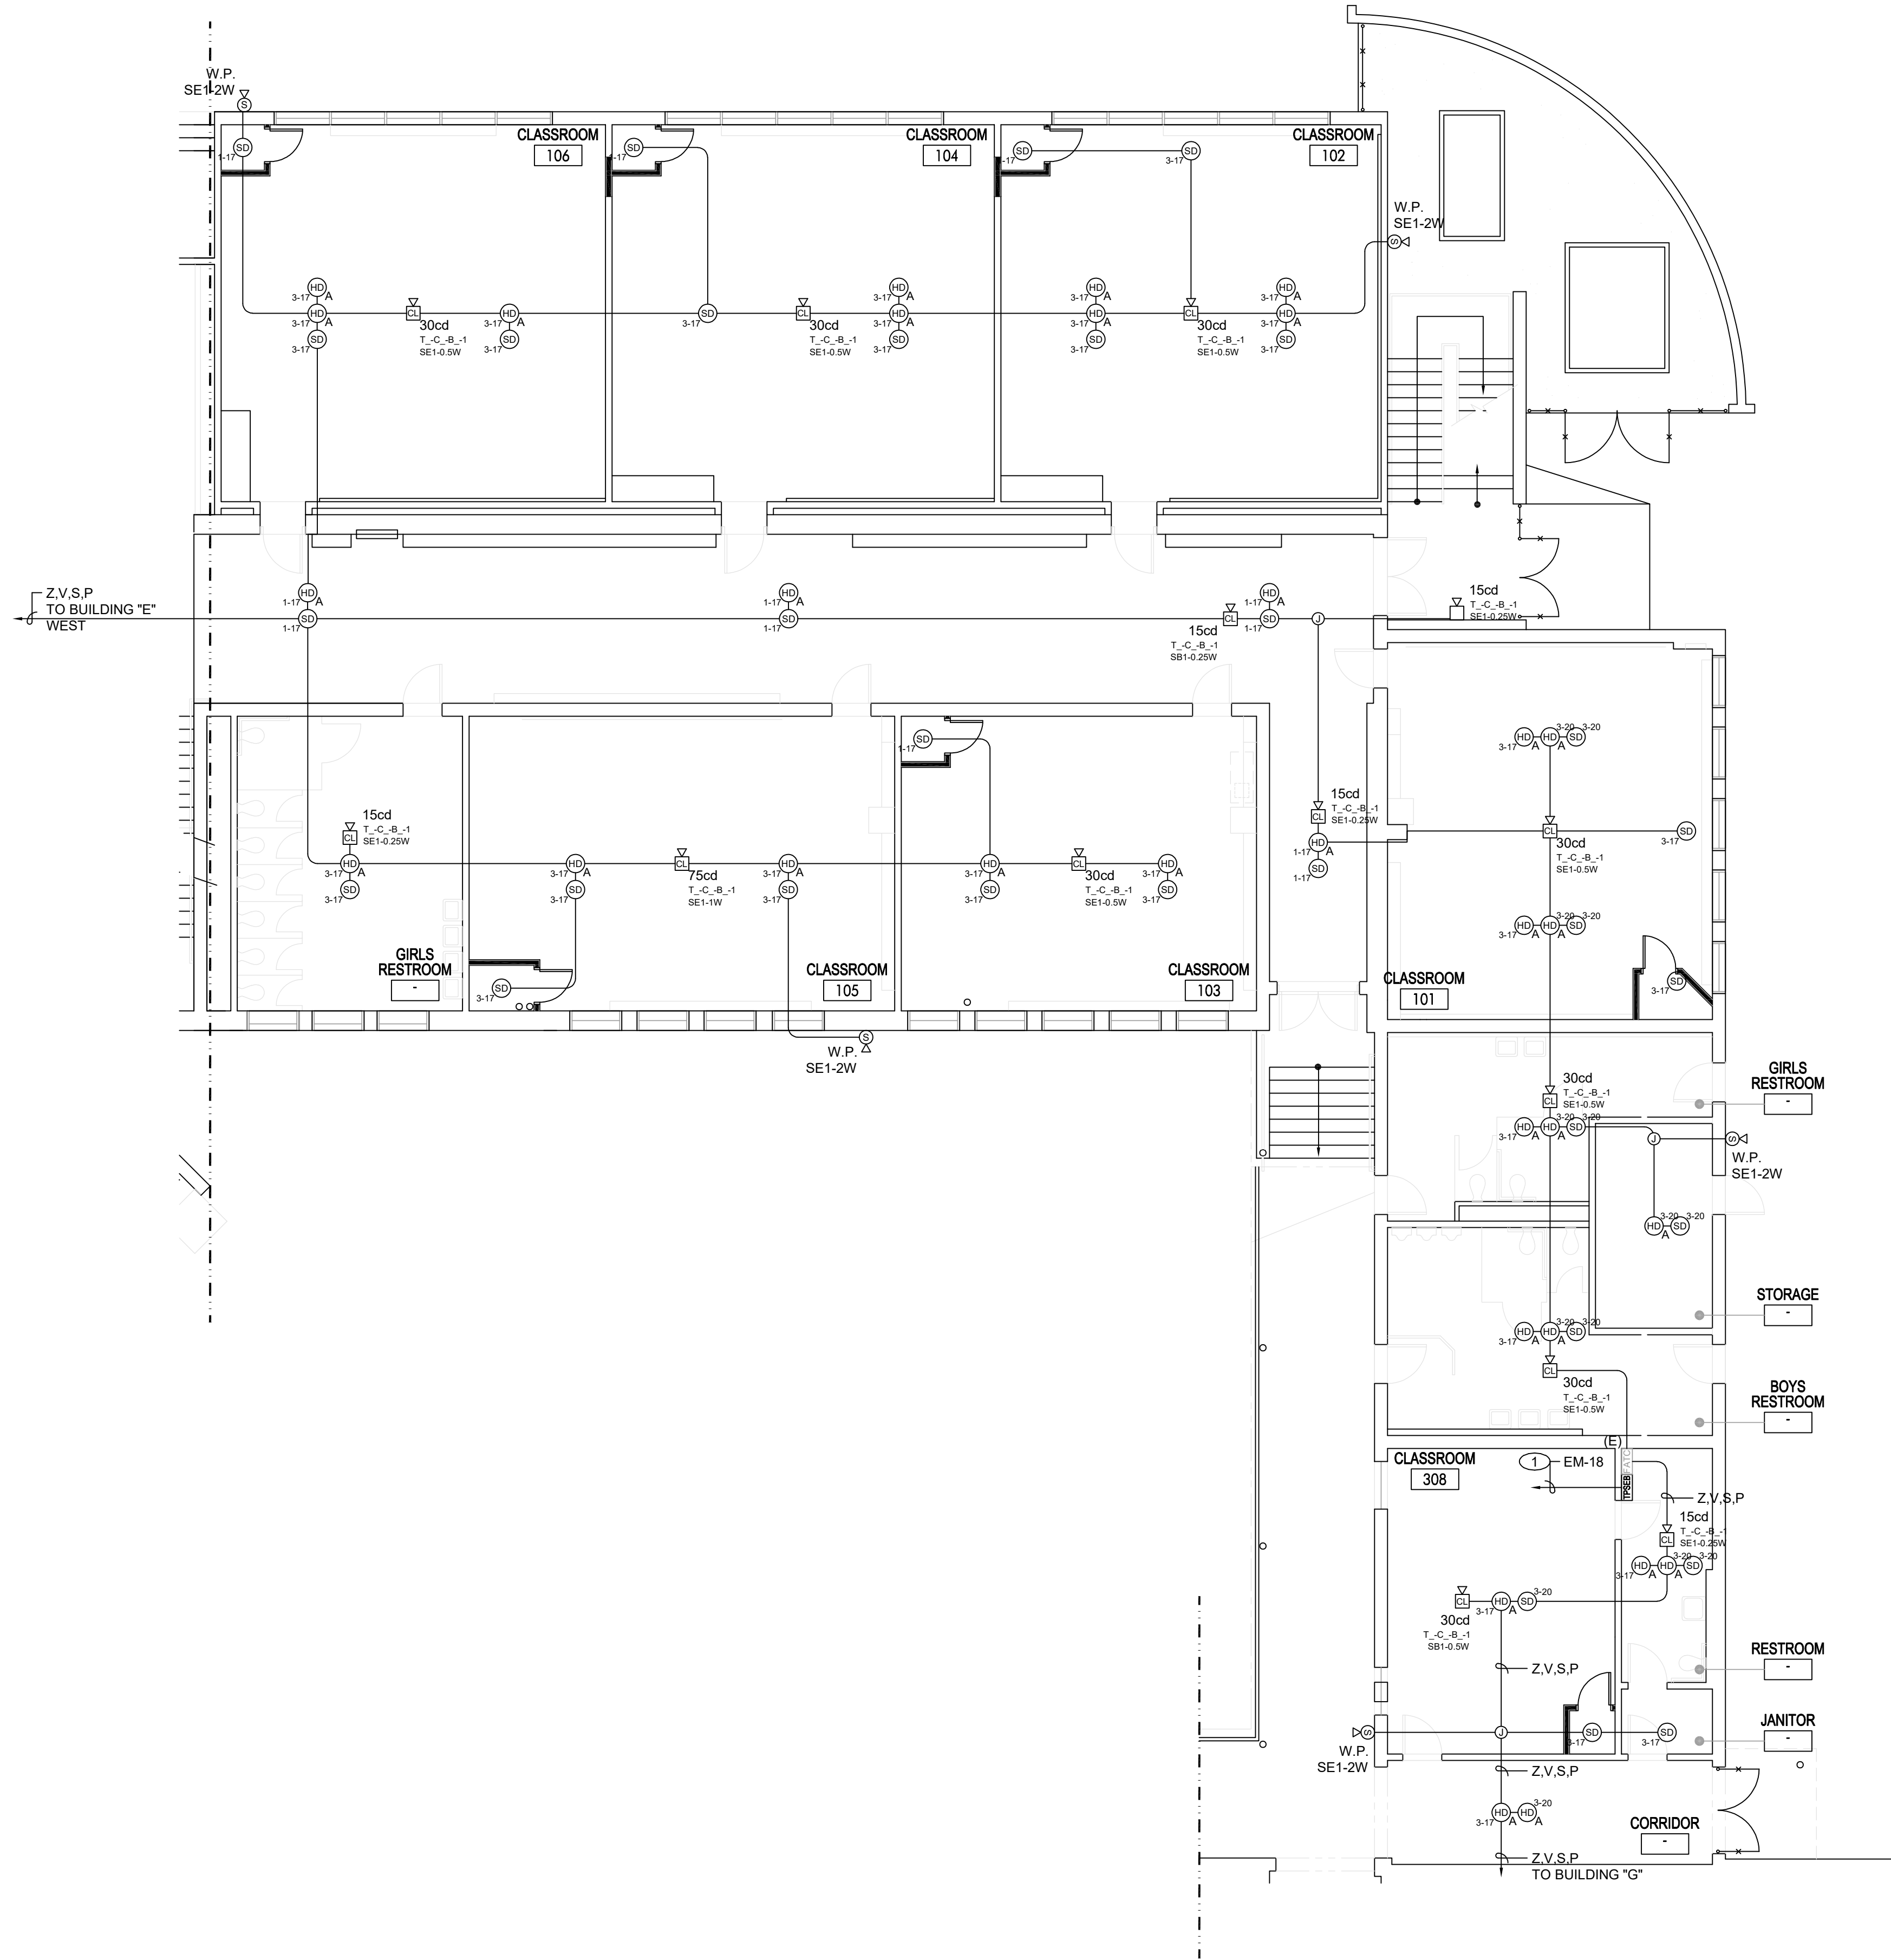

BUILDING "E" - FIRE ALARM FIRST FLOOR PLAN

SCALE
1/8" = 1'-0"

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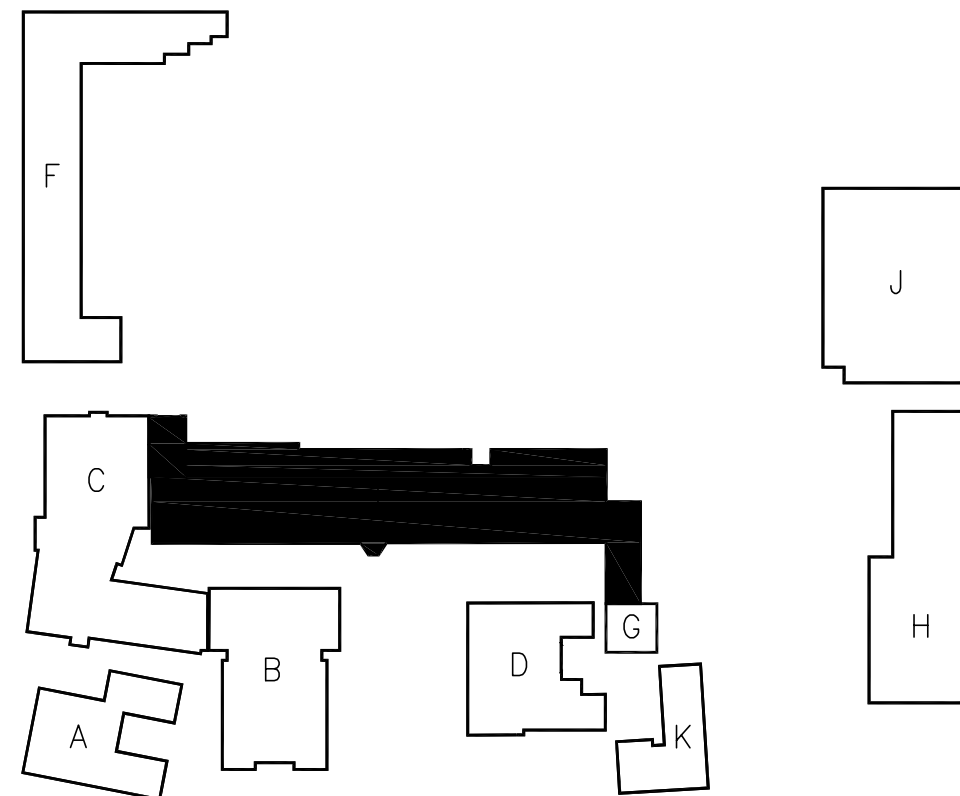
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REFERENCE NOTES

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- PROVIDE NEW ACCESS PANEL. SEE ARCHITECTURAL DRAWINGS
- EXISTING COOKING KITCHEN (TYPE 1 HOOD). CONNECT HEAT DETECTOR WITH SINGLE INPUT MODULE (4090-9001, IDNET SUPERVISED IAM) FOR MONITORING UL300 COMPLAINT FIRE SUPPRESSION SYSTEM. PROVIDE CONNECTION FROM ANSUL SYSTEM FOR FIRE ALARM SYSTEM MONITORING. PROVIDE CLASS K PORTABLE FIRE EXTINGUISHER OF A MINIMUM 1.5-GALLON CAPACITY FOR COMMERCIAL COOKING EQUIPMENT. FIELD VERIFY LOCATION WITHIN 30 FEET FROM COOKING SURFACE.
- PROVIDE (2) DEDICATED PHONE LINES (ANALOG) TO MDF/IDF WITHIN THE BUILDING FOR REMOTE STATION MONITORING.
- PROVIDE A SIGNAGE "FIRE ALARM CONTROL PANEL INSIDE" AT THE DOOR TO FAC/FOPS. SEE DETAIL ON 8/E402. PATCH/PAINT/REPAIR TO MATCH ADJACENT SURFACES

KEY PLAN



DSA Stamp

Architect



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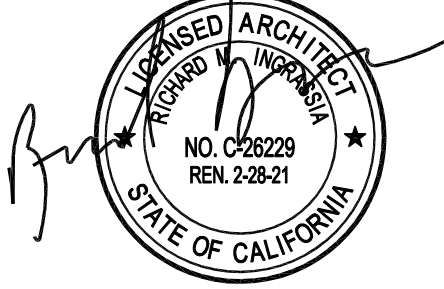
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Lincoln Middle School
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Santa Monica, California 90403


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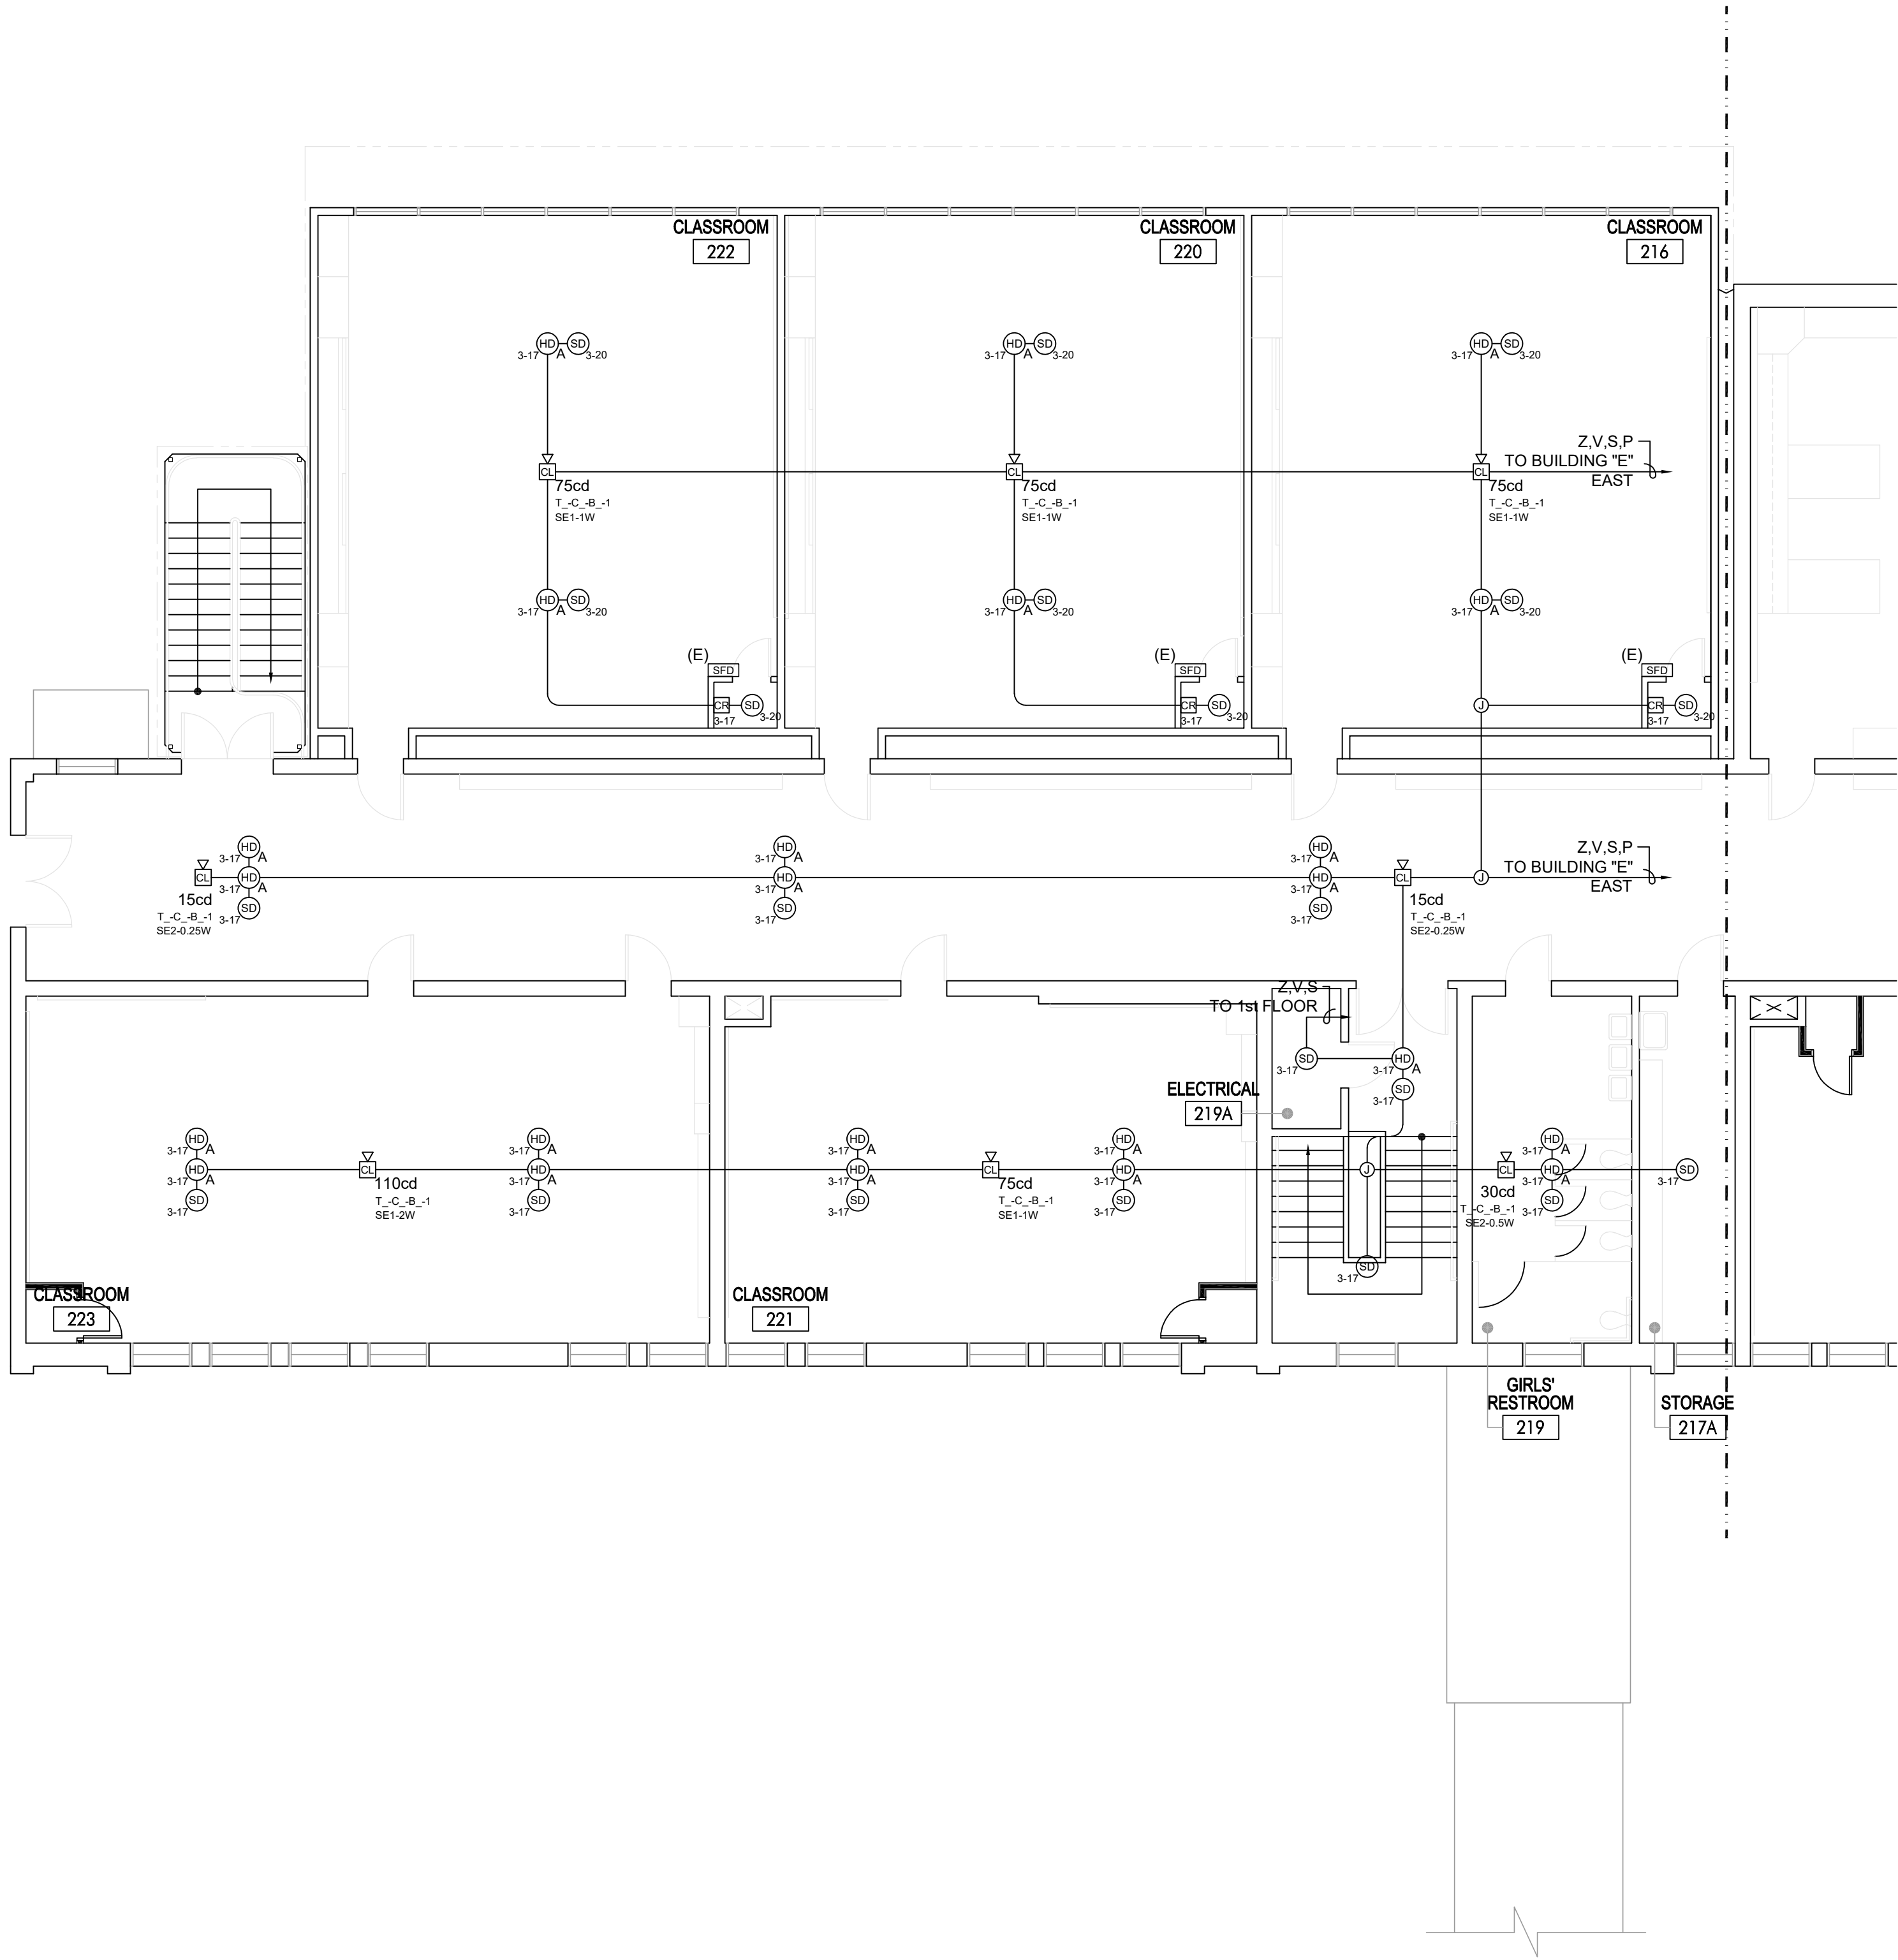


Sheet Title

Fire Alarm
Building "E"
First Floor Plan

Sheet Number

EE321B

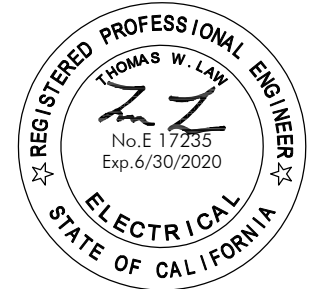

BUILDING "E" - FIRE ALARM SECOND FLOOR PLAN

SCALE
1/8" = 1'-0"

1


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KEY PLAN



DSA Stamp

Architect

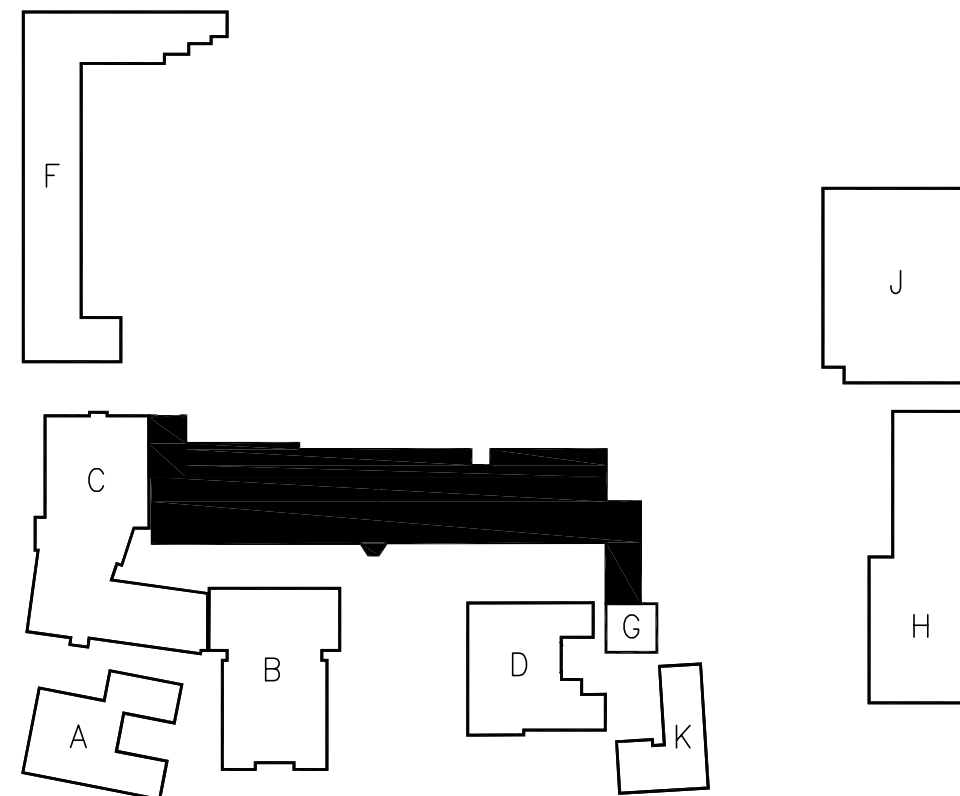

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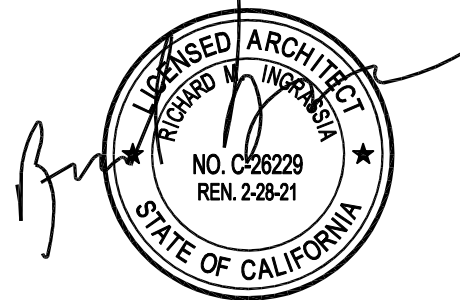
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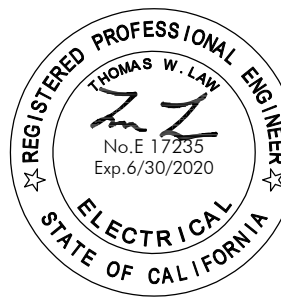
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Sheet Title
Fire Alarm
Building "E"
Second Floor Plan

Sheet Number

EE322A

DSA Stamp

Architect



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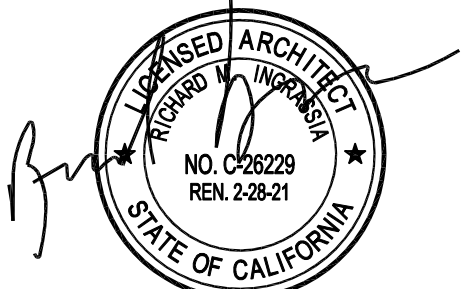
Lincoln Middle School HVAC Replacement Project

Lincoln Middle School
1501 California Avenue
Santa Monica, California 90403


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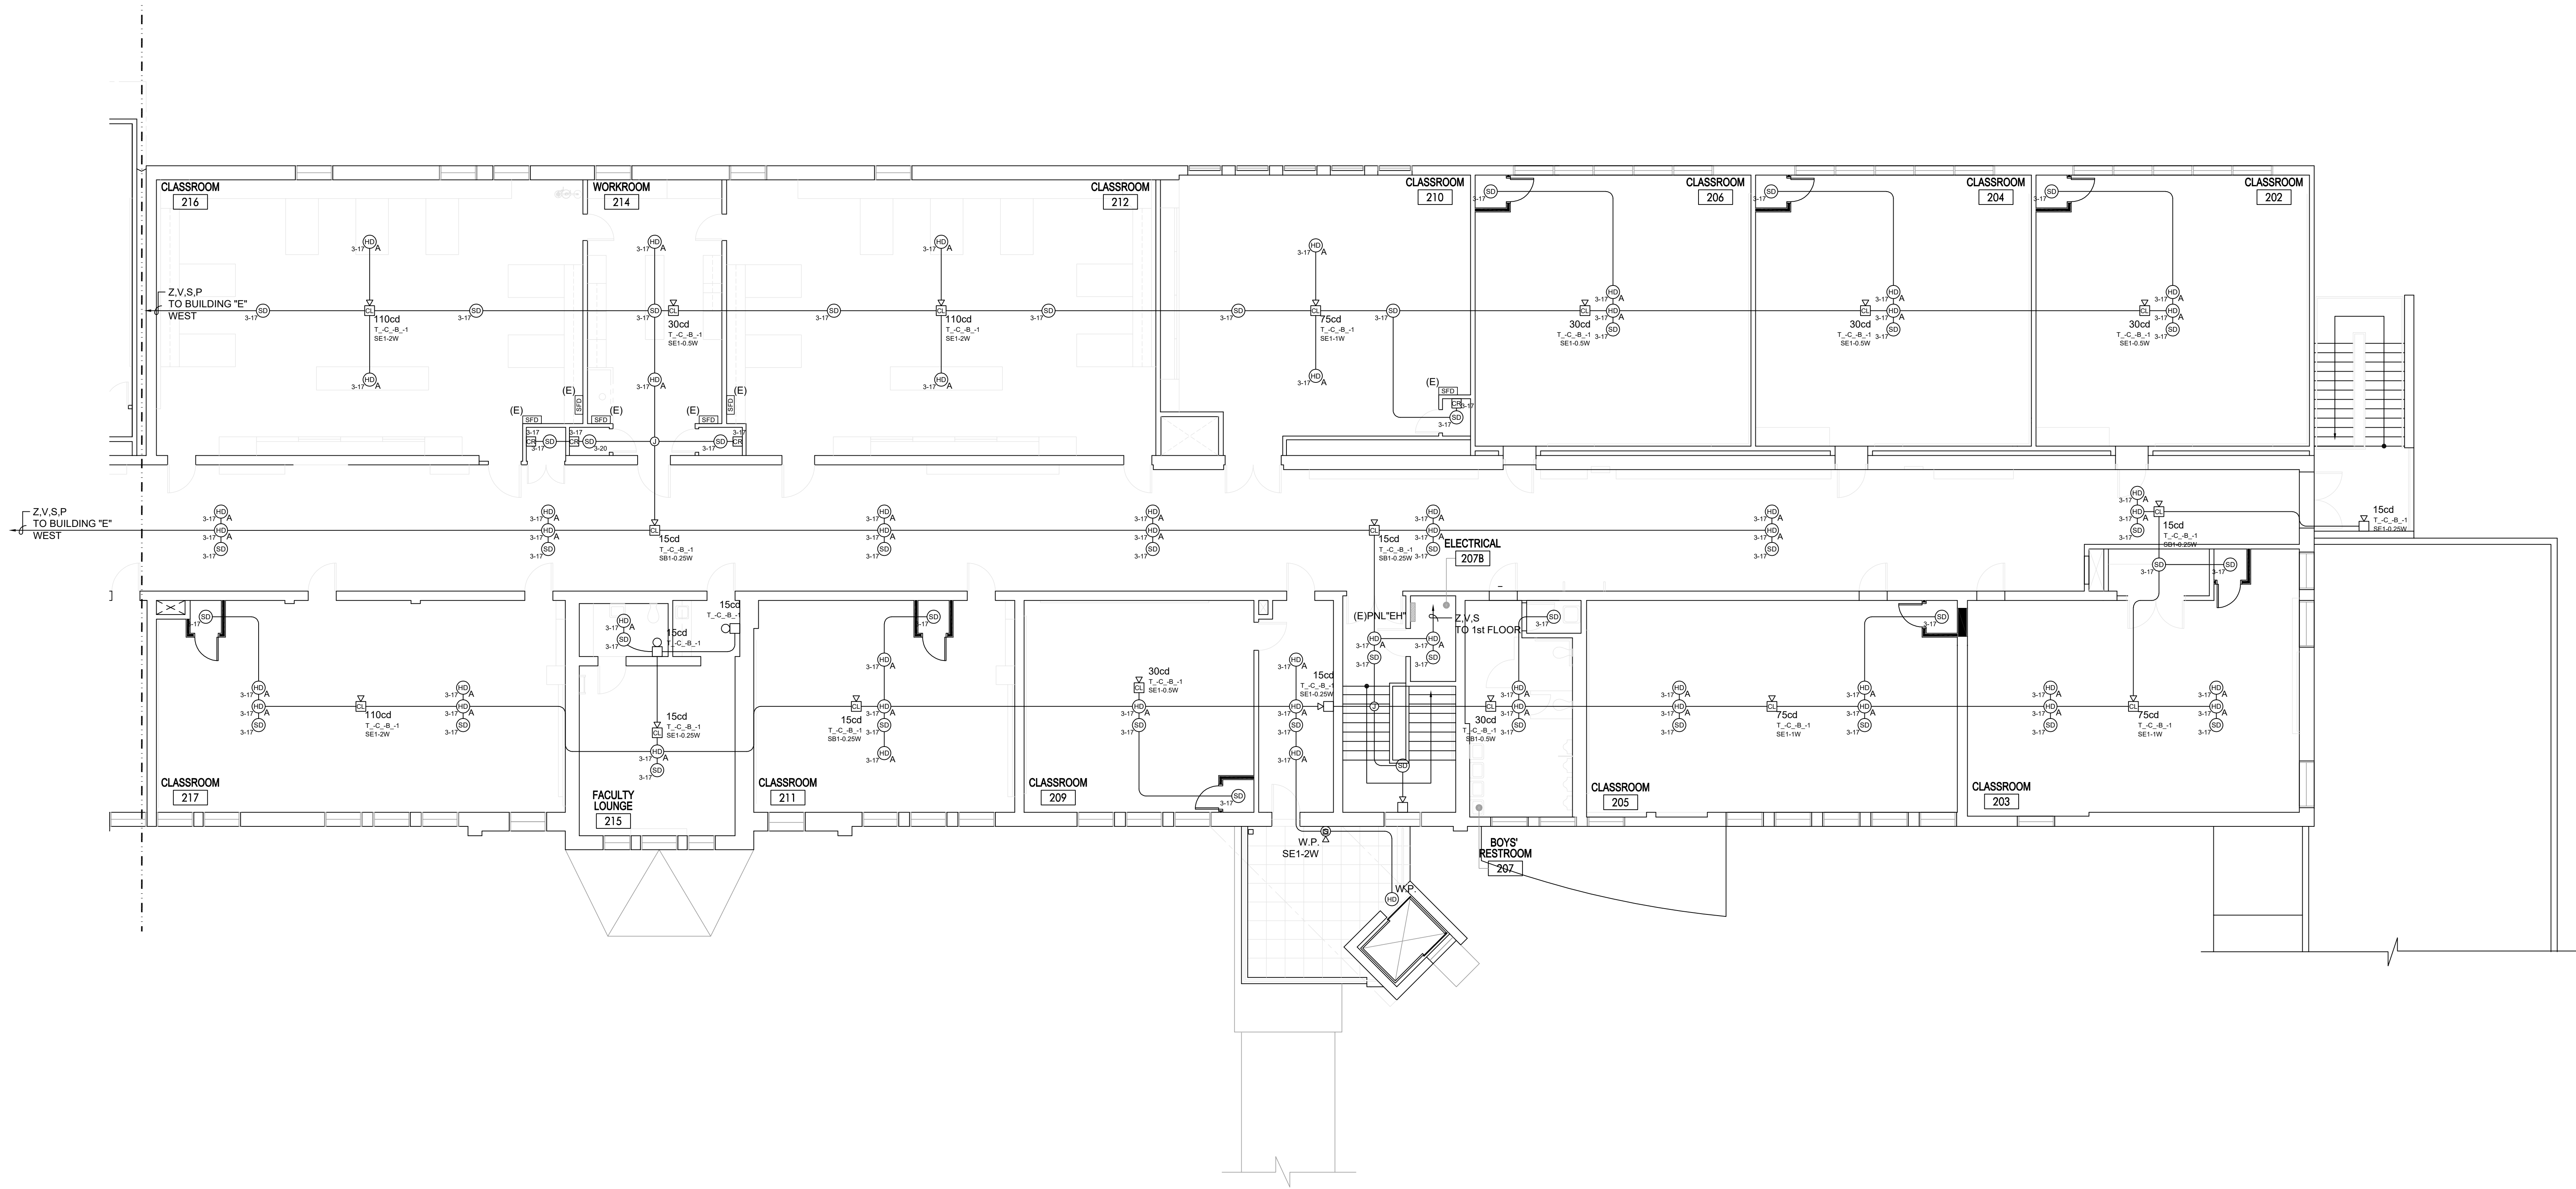
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Sheet Title
Fire Alarm
Building "E"
Second Floor Plan

Sheet Number

EE322B



BUILDING "E" - FIRE ALARM SECOND FLOOR PLAN

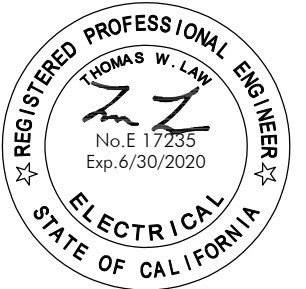SCALE
1/8" = 1'-0" 1


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KEY PLAN




Lincoln Middle School HVAC Replacement Project

Lincoln Middle School
1501 California Avenue
Santa Monica, California 90403


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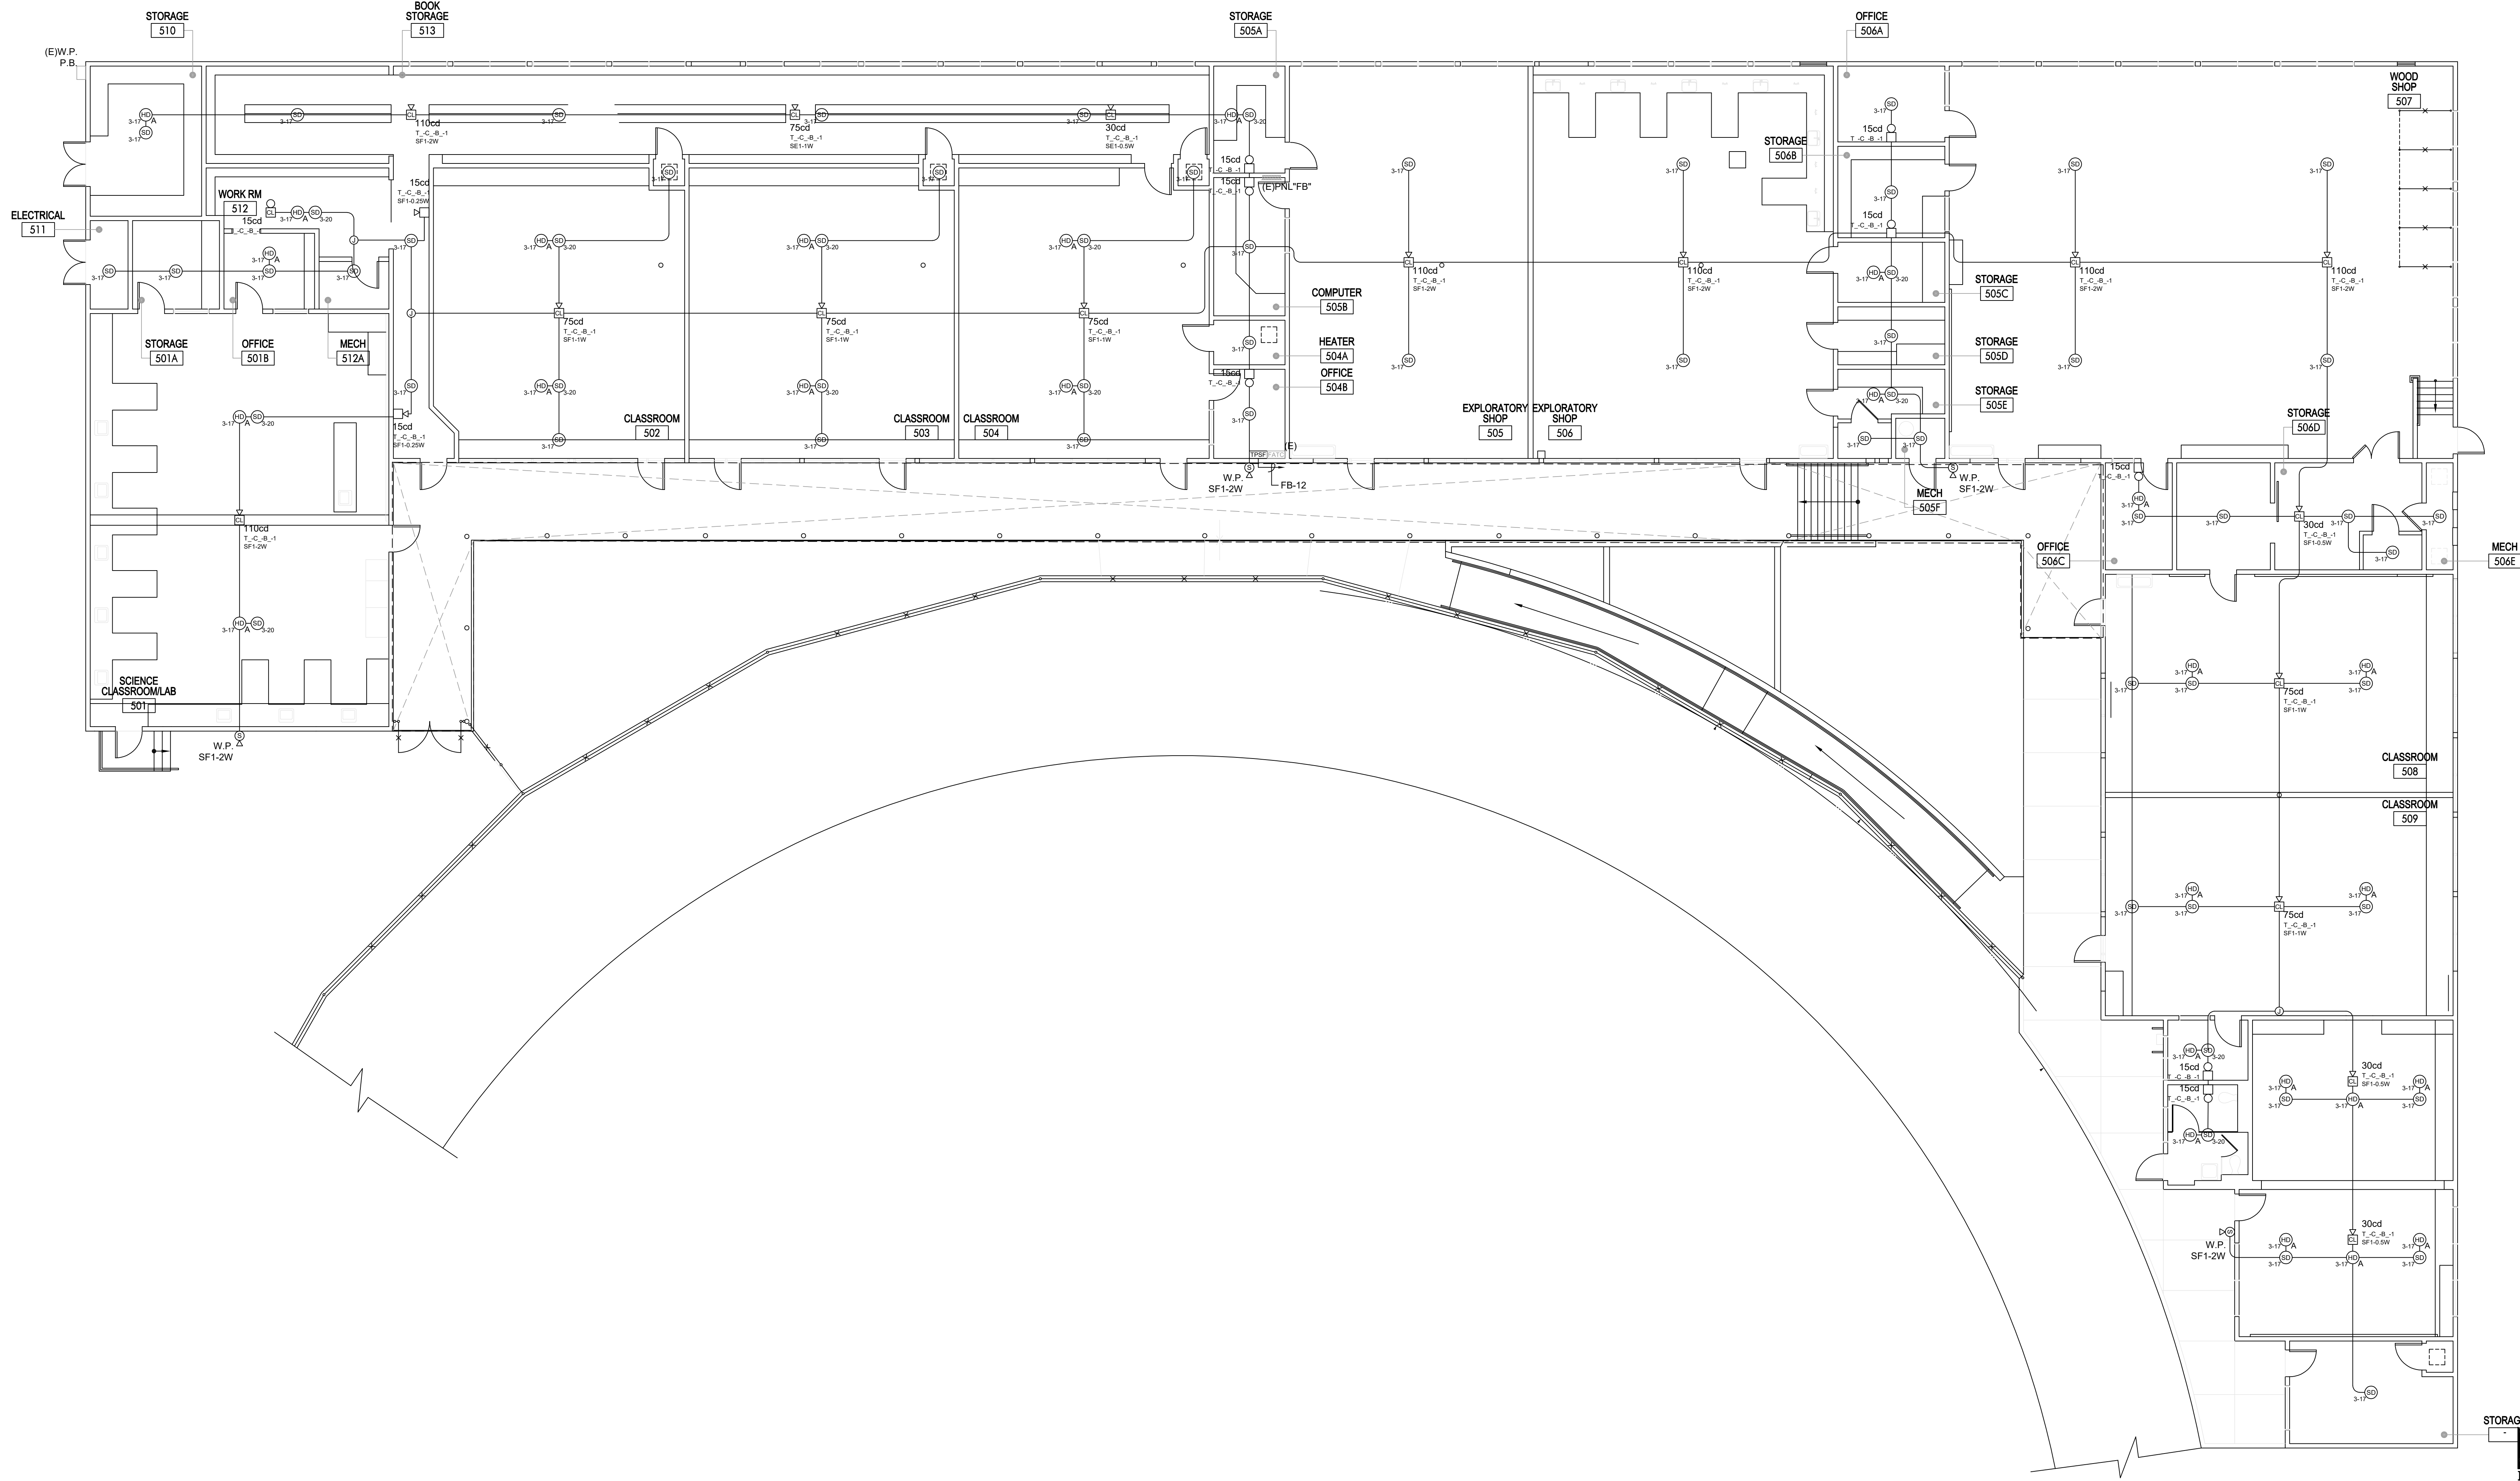


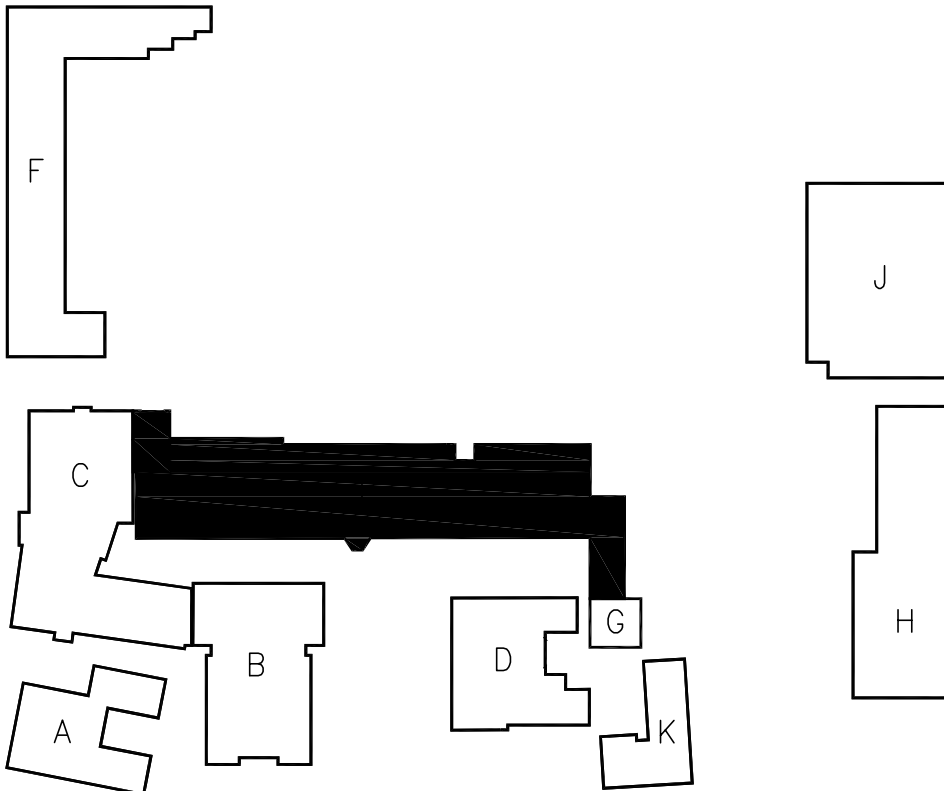Sheet Title

Fire Alarm Building "F" Floor Plan

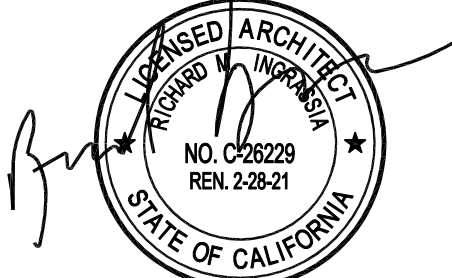Sheet Number

EF321

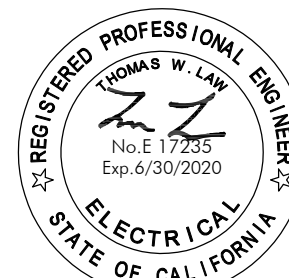

BUILDING "F" - FIRE ALARM PLAN

SCALE	1
1/8" = 1'-0"	


GENERAL NOTES


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KEY PLAN






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BUILDING "G" - FIRE ALARM PLAN

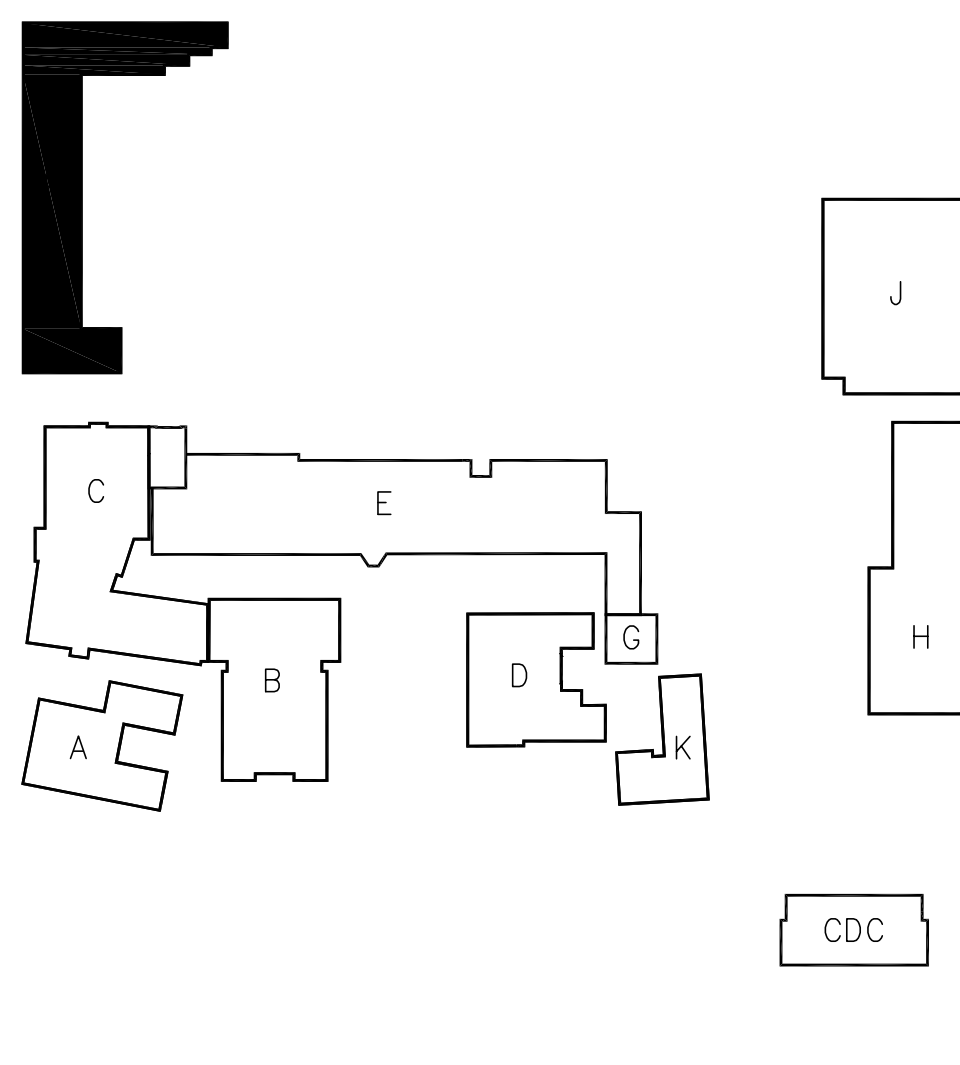SCALE
1/8" = 1'-0"

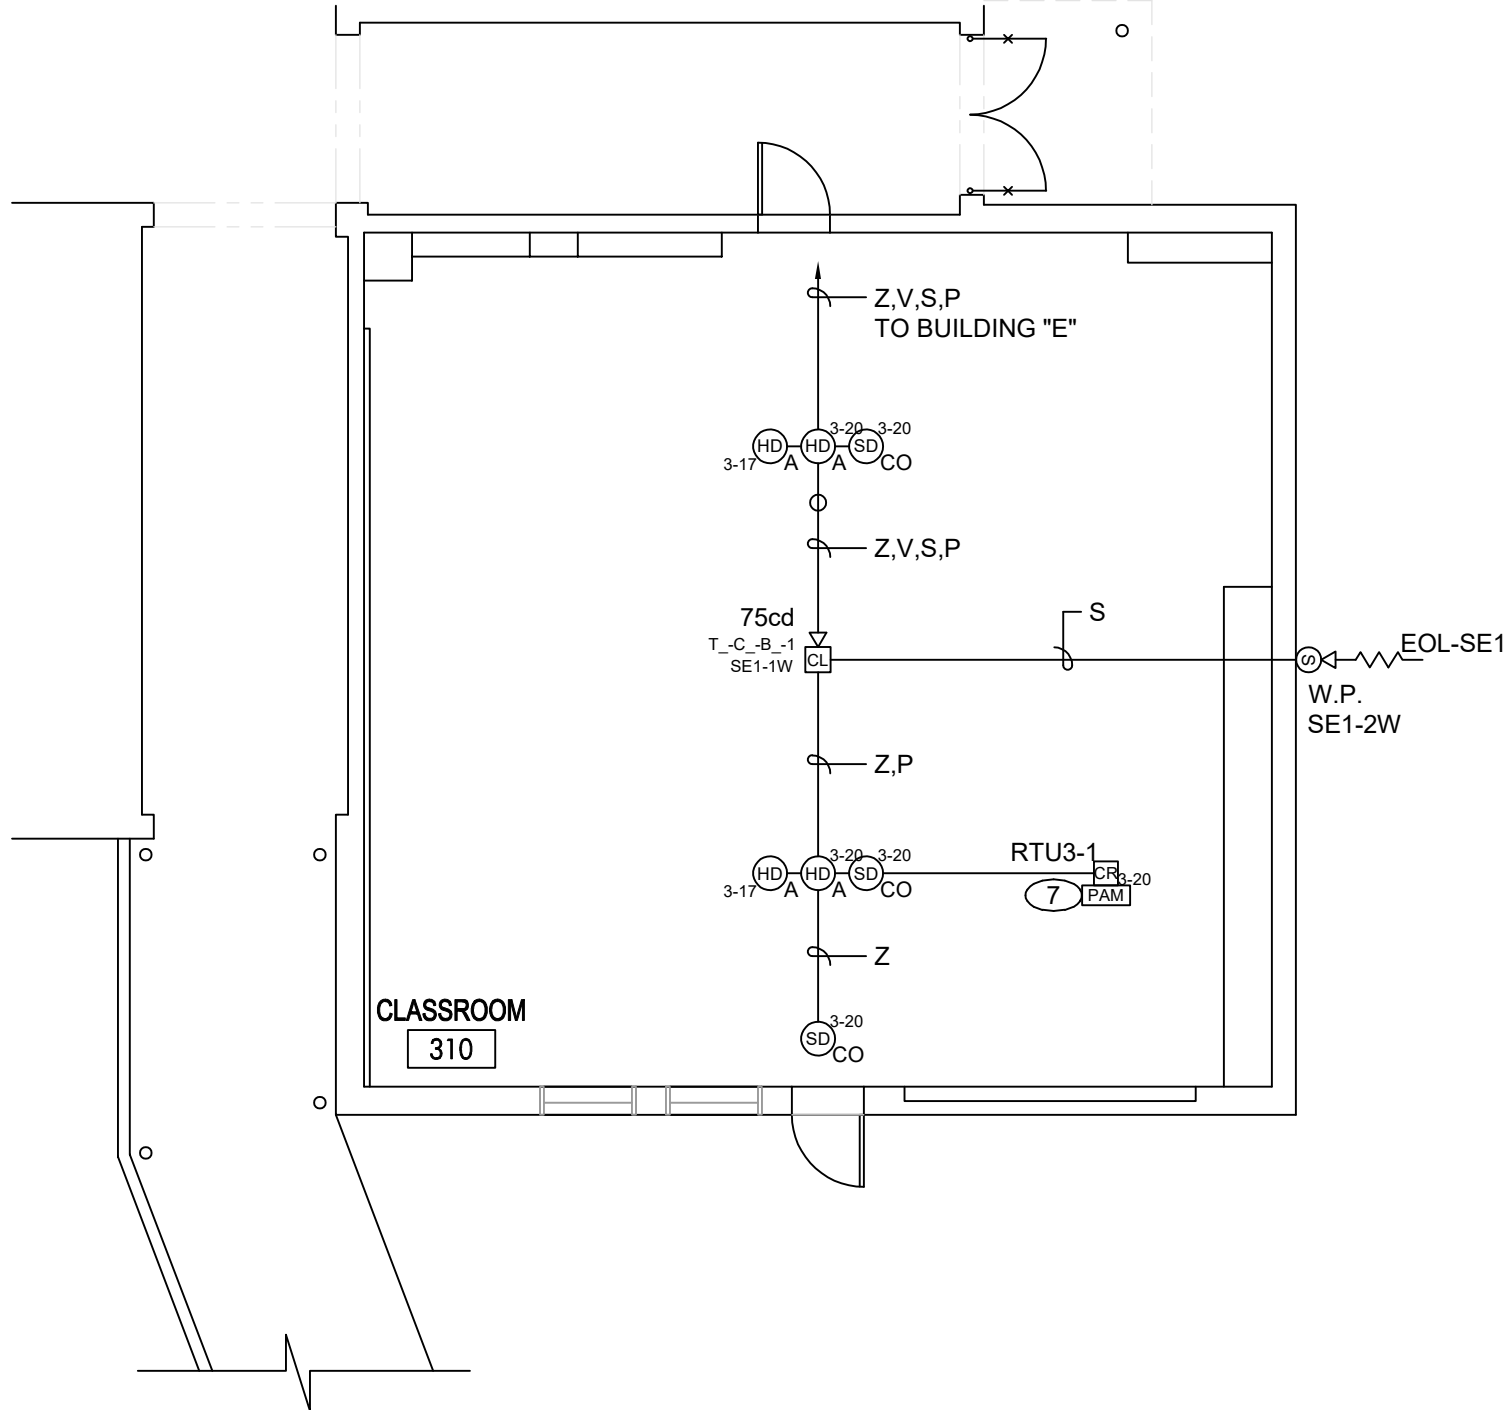1

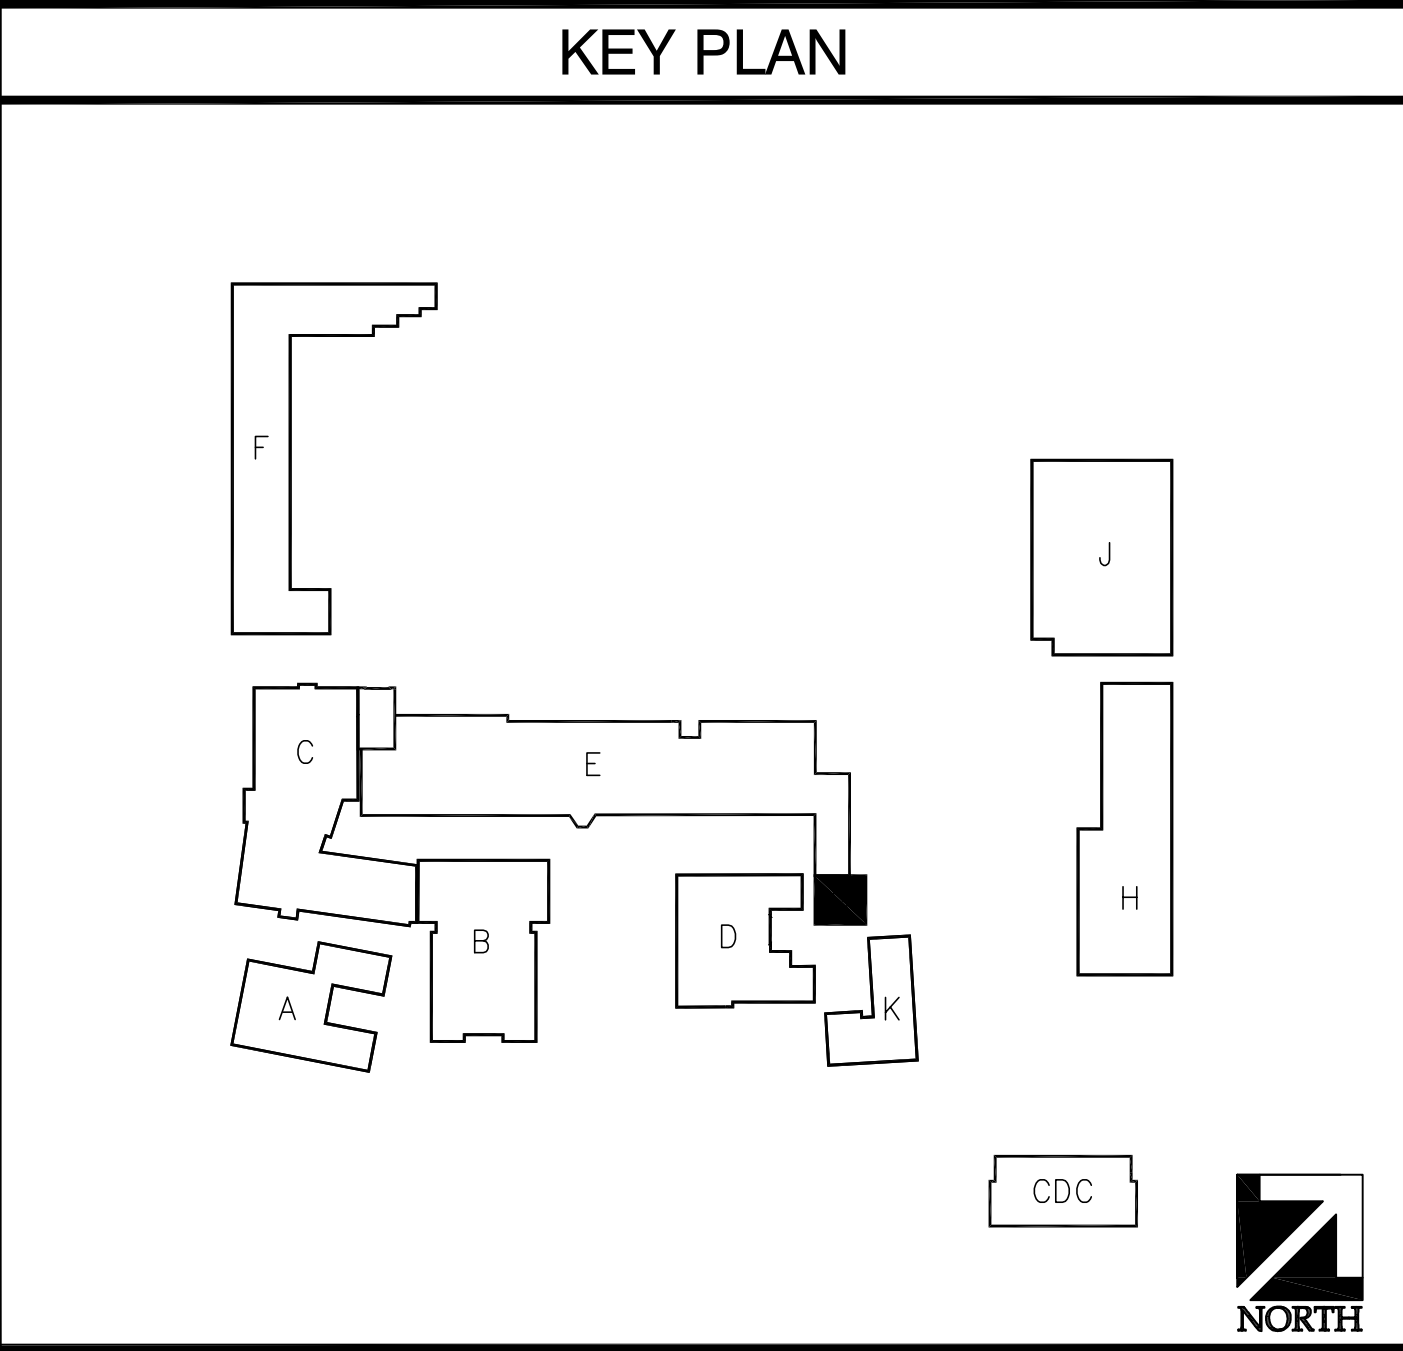

APPL. No. A 00-123456

DSA Stamp

Architect



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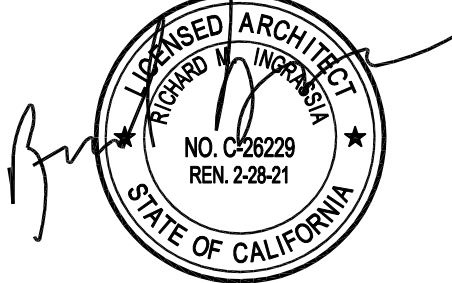
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Santa Monica, California 90403


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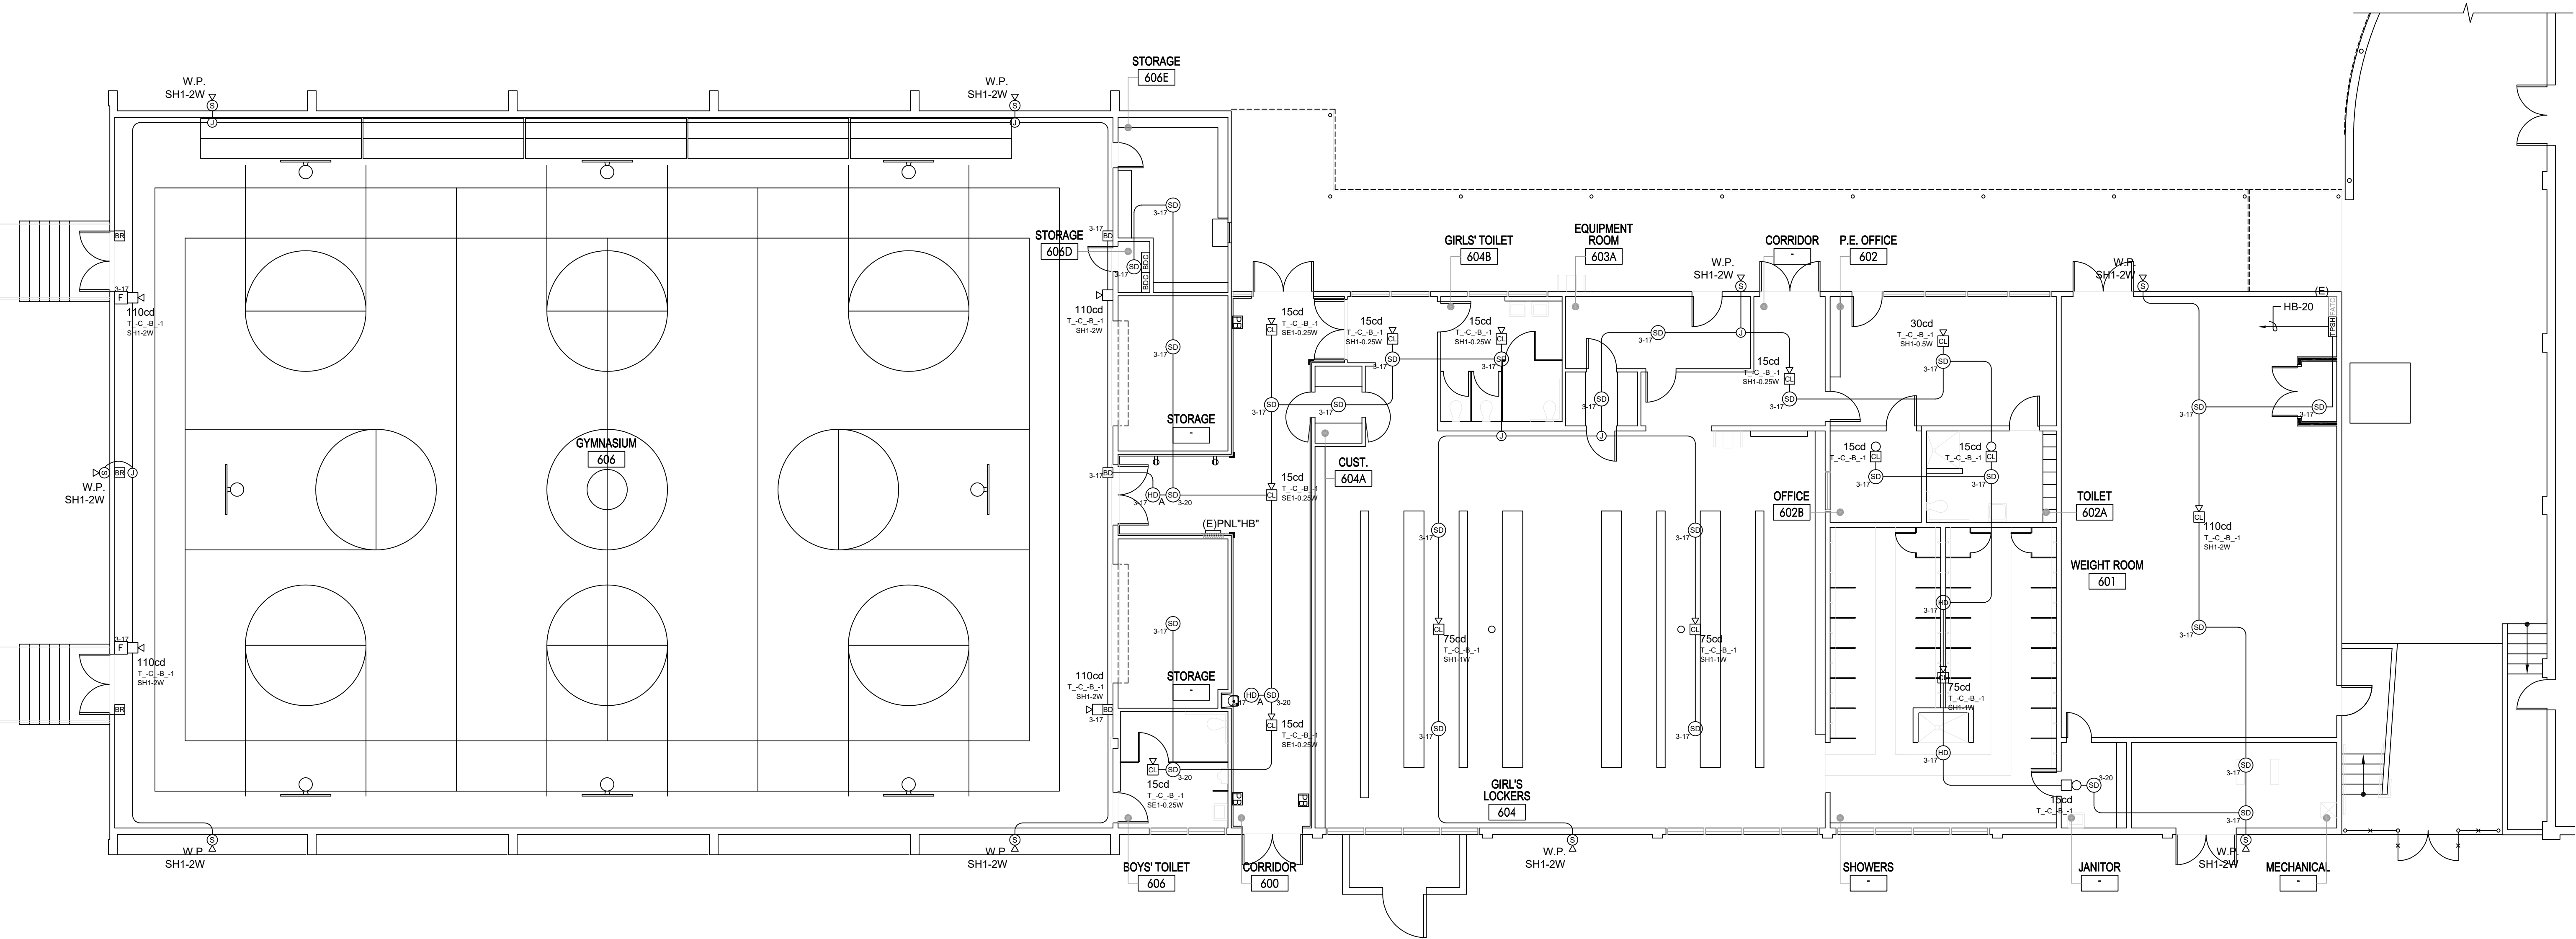
Sheet Title

Fire Alarm
Building "G"
Floor Plan

Sheet Number

EG321

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BUILDING "H" - FIRE ALARM PLAN

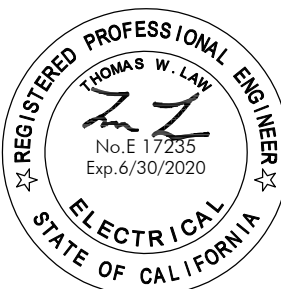SCALE
1/8" = 1'-0"

1

GENERAL NOTES

- EXISTING CONDUIT MAYBE RE-USED FOR NEW WORK, PROVIDED THEY MEET MINIMUM CONDUIT SIZE REQUIREMENTS AND WIRE FILL CAPACITY (40%). OTHERWISE PROVIDE NEW CONDUITS. CONTRACTOR AT HIS OPTION MAY REUSE EXISTING CONDUITS WITHIN THE BUILDINGS/SITE AND PROVIDE NEW CONDUITS TO EXTEND TO NEW DEVICE LOCATIONS AS NECESSARY.
- EXISTING FIRE ALARM SYSTEM SHALL BE MAINTAINED UNTIL NEW FIRE ALARM HAS BEEN INSTALLED AND TESTED. UNLESS FIRE WATCH IS PROVIDED.
- FIRE SAFETY DURING CONSTRUCTION AND DEMOLITION SHALL BE IN COMPLIANCE WITH CFC 2016, CHAPTER 9, 11 AND 33 & CBC 2016, CHAPTER 33. PROVIDE FIRE WATCH UNTIL THE NEW SYSTEM IS IN OPERATION AND APPROVED BY I.O.R., DSA, LOCAL FIRE AUTHORITY, AND DISTRICT.
- CONTRACTOR SHALL EXERCISE EXTREME CAUTION WHILE EXCAVATING FOR NEW UNDERGROUND UTILITIES. FIELD VERIFY AND COORDINATE PRIOR TO EXCAVATION. ANY DAMAGE TO EXISTING UNDERGROUND UTILITIES SHALL BE REPAIRED AND RESTORED TO ORIGINAL CONDITION IMMEDIATELY WITHOUT INTERRUPTION TO OPERATION OF FACILITIES AT NO ADDITIONAL COST TO THE OWNER. IT MAY BE NECESSARY TO RUN NEW UTILITIES UNDER EXISTING UTILITIES (CROSSOVER).
- AUTOMATIC SHUTOFF IS NOT REQUIRED WHEN ALL OCCUPIED ROOMS SERVED BY THE AIR-HANDLING EQUIPMENT HAVE DIRECT EXIT TO THE EXTERIOR AND THE TRAVEL DISTANCE DOES NOT EXCEED 100 FEET. (CMC 608 EXEMPTION#2)

REFERENCE NOTES

- PROVIDE NEW (1)20A 1P CIRCUIT BREAKER TO ELECTRICAL PANEL, AS INDICATED. CIRCUIT BREAKER SHALL MATCH BY TYPE/STYLE/AMP RATING. PROVIDE LOCK ON DEVICE TO CIRCUIT BREAKER HANDLE, WITH RED MARKING. ACCESSIBLE ONLY TO AUTHORIZED PERSONNEL. IDENTIFIED AS "FIRE ALARM CIRCUIT", AND LOCATION OF CIRCUIT BREAKER PERMANENTLY IDENTIFIED AT FIRE ALARM CONTROL UNIT IN COMPLIANCE WITH NFPA 72, 10.6.5.2.
- HVAC UNIT (FIELD VERIFY EXACT LOCATION). PROVIDE AUTOMATIC SHUT OFF PER CMC 608. WITH CONTROL RELAY MODULE (4090-9002, IDNET RELAY IAM) AND 120V RELAY MODULES (2088-9008, FIRE ALARM CONTROL RELAY, 1 SPDT CONTACTS RATED 10A, 120VAC) (LOCATE ABOVE ACCESSIBLE CEILING SPACE BELOW HVAC UNIT). SEE WIRING DIAGRAM ON SHEET 8/E401. CONNECT 120V POWER CIRCUIT TO 120V RELAY MODULES. PROVIDE LOCK ON DEVICE TO CIRCUIT BREAKER HANDLE, WITH RED MARKING.
- PROVIDE NEW ACCESS PANEL. SEE ARCHITECTURAL DRAWINGS

KEY PLAN



DSA Stamp

Architect



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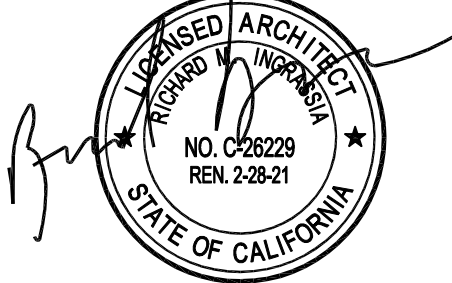
Lincoln Middle School HVAC Replacement Project

Lincoln Middle School
1501 California Avenue
Santa Monica, California 90403


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Drawn By: RS, TL
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Consultants




Sheet Title

Fire Alarm
Building "H"
Floor Plan

Sheet Number

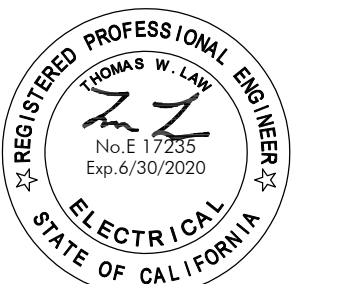EH321

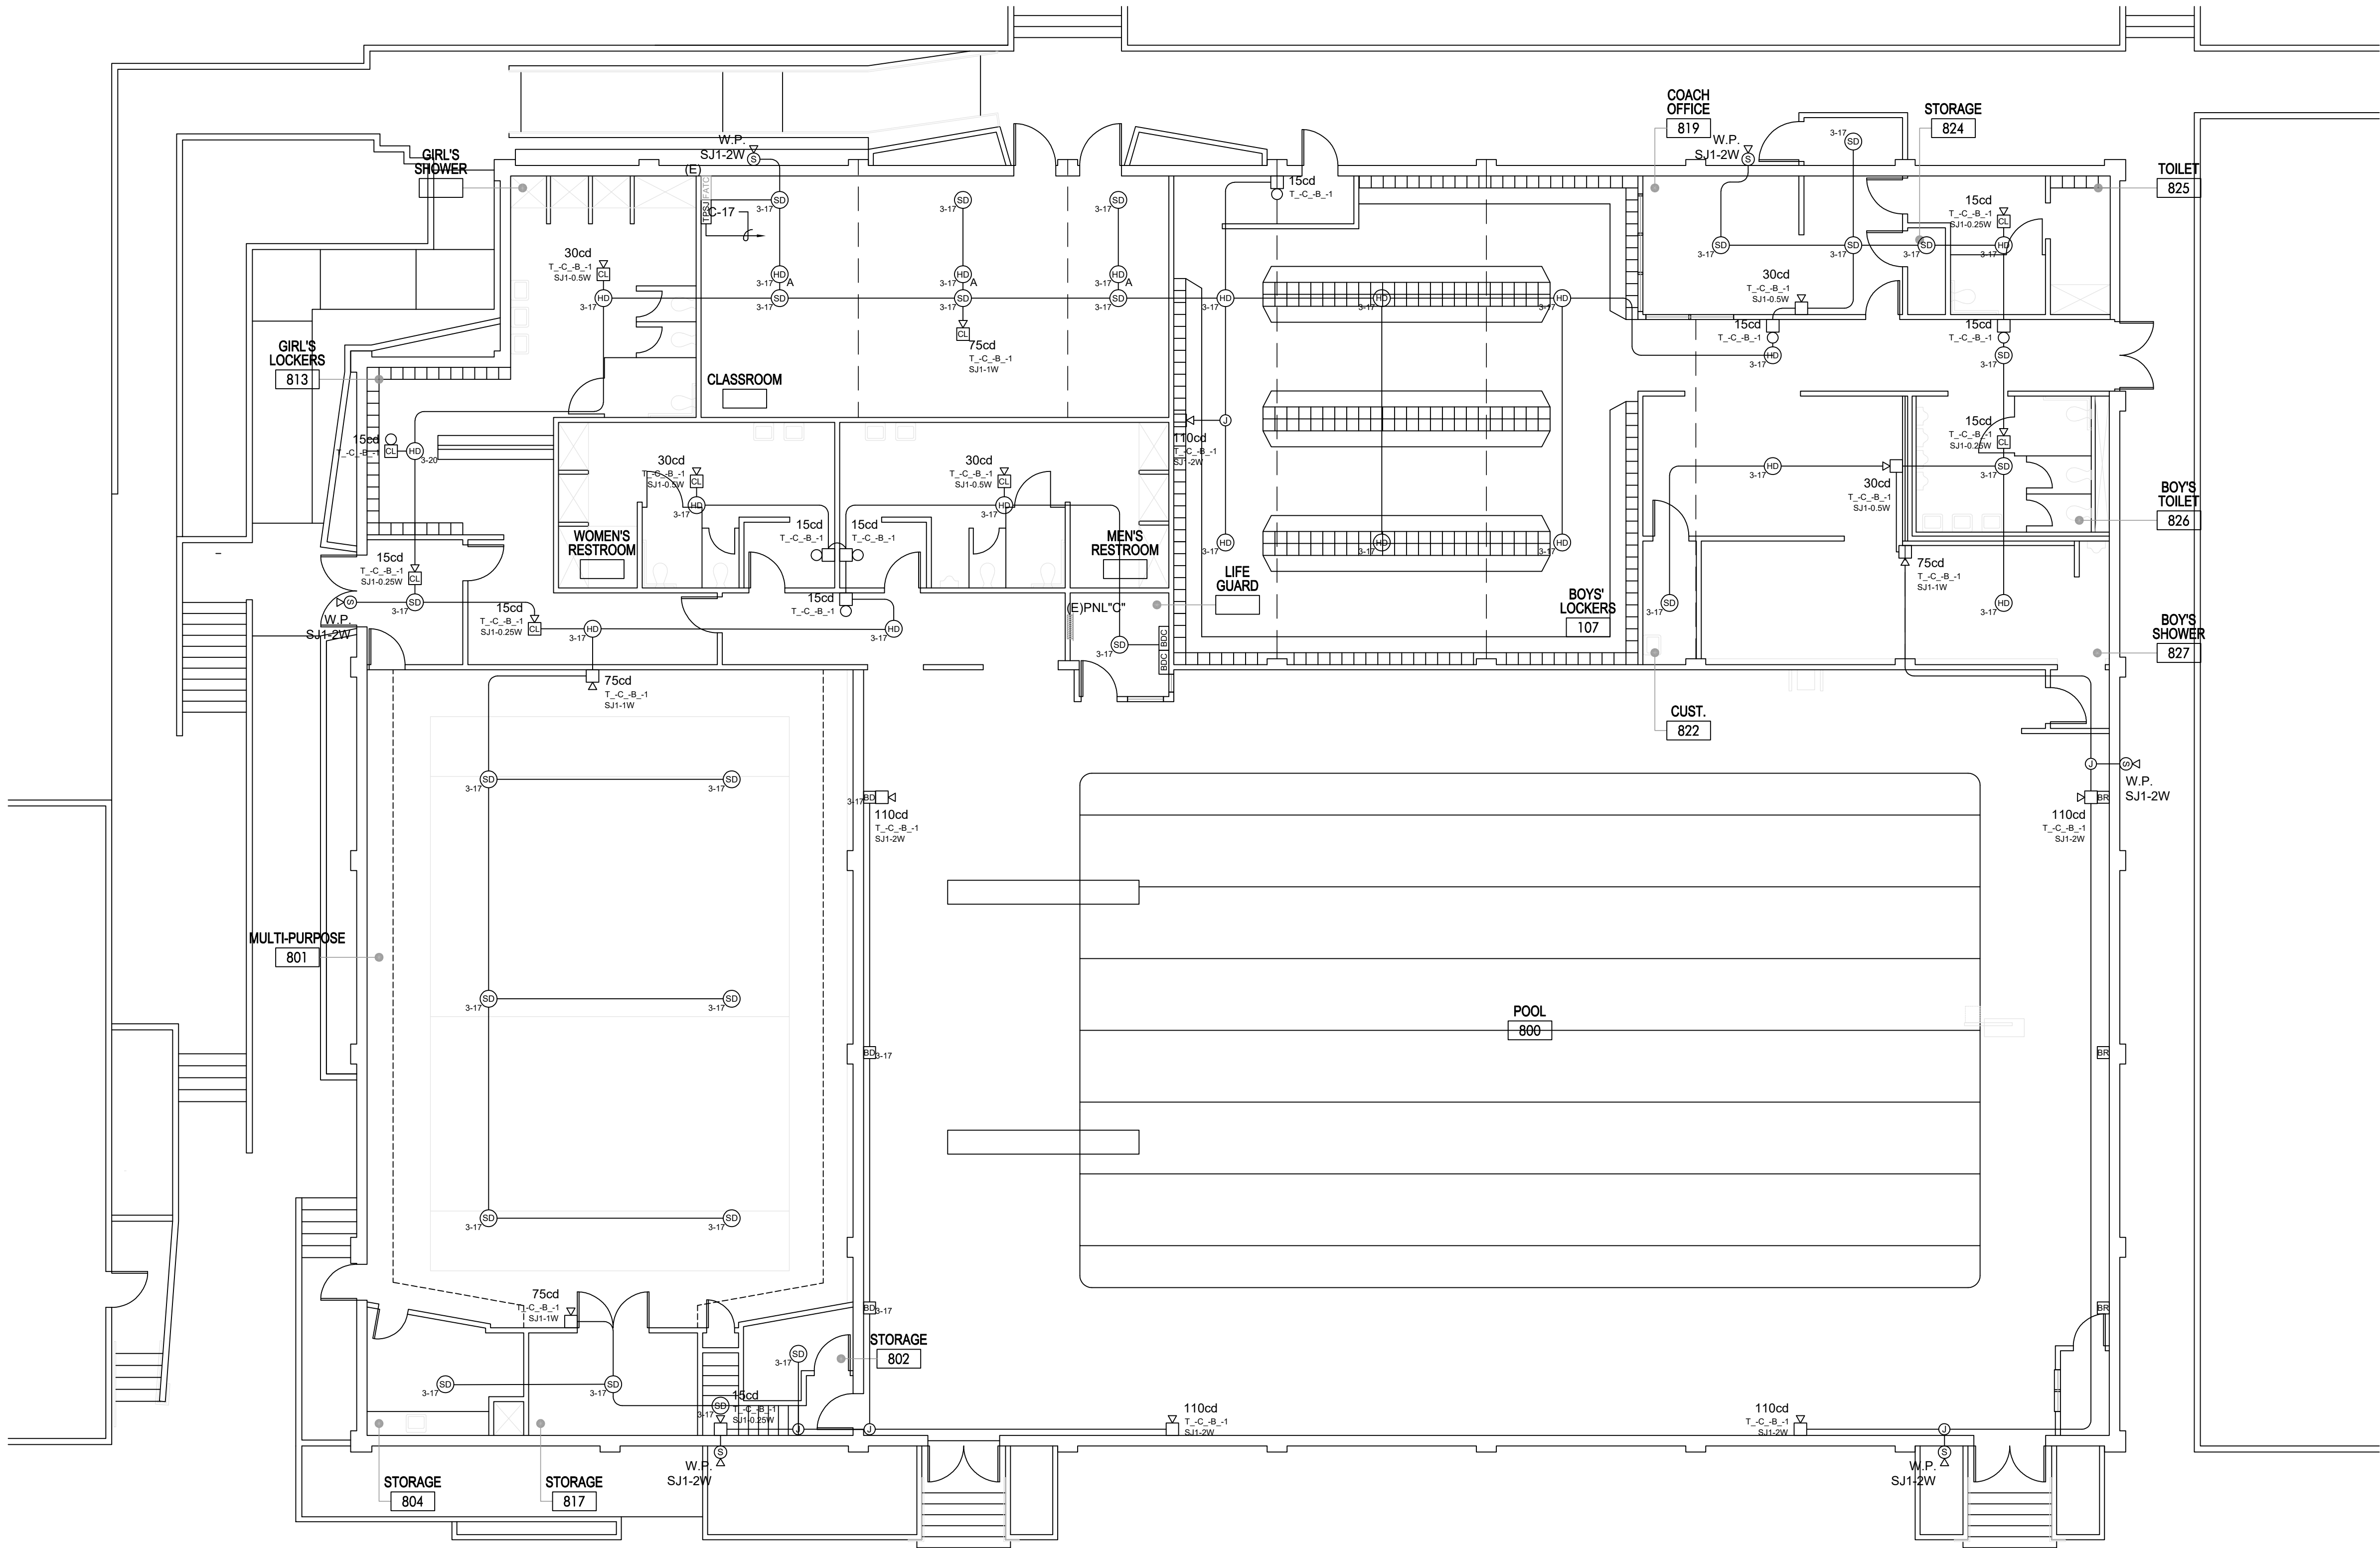


GENERAL NOTES

1. EXISTING CONDUIT MAYBE RE-USED FOR NEW WORK, PROVIDED THEY MEET MINIMUM CONDUIT SIZE REQUIREMENTS AND WIRE FILL CAPACITY (40%). OTHERWISE PROVIDE NEW CONDUITS. CONTRACTOR AT HIS OPTION MAY REUSE EXISTING CONDUITS WITHIN THE BUILDINGS/SITE AND PROVIDE NEW CONDUITS TO EXTEND TO NEW DEVICE LOCATIONS AS NECESSARY.
2. EXISTING FIRE ALARM SYSTEM SHALL BE MAINTAINED UNTIL NEW FIRE ALARM HAS BEEN INSTALLED AND TESTED. UNLESS FIRE WATCH IS PROVIDED.
3. FIRE SAFETY DURING CONSTRUCTION AND DEMOLITION SHALL BE IN COMPLIANCE WITH CFC 2016, CHAPTER 9, 11 AND 33 & CBC 2016, CHAPTER 33. PROVIDE FIRE WATCH UNTIL THE NEW SYSTEM IS IN OPERATION AND APPROVED BY I.O.R., DSA, LOCAL FIRE AUTHORITY, AND DISTRICT.
4. CONTRACTOR SHALL EXERCISE EXTREME CAUTION WHILE EXCAVATING FOR NEW UNDERGROUND UTILITIES. FIELD VERIFY AND COORDINATE PRIOR TO EXCAVATION. ANY DAMAGE TO EXISTING UNDERGROUND UTILITIES SHALL BE REPAIRED AND RESTORED TO ORIGINAL CONDITION IMMEDIATELY WITHOUT INTERRUPTION TO OPERATION OF FACILITIES AT NO ADDITIONAL COST TO THE OWNER. IT MAY BE NECESSARY TO RUN NEW UTILITIES UNDER/OVER EXISTING UTILITIES (CROSSOVER).
5. AUTOMATIC SHUTOFF IS NOT REQUIRED WHEN ALL OCCUPIED ROOMS SERVED BY THE AIR-HANDLING EQUIPMENT HAVE DIRECT EXIT TO THE EXTERIOR AND THE TRAVEL DISTANCE DOES NOT EXCEED 100 FEET. (CMC 608 EXEMPTION#2)

REFERENCE NOTES

- ① PROVIDE NEW (120A 1P CIRCUIT BREAKER TO ELECTRICAL PANEL AS INDICATED. CIRCUIT BREAKER SHALL MATCH BY TYPE/STYLE/AMP RATING. PROVIDE LOCK ON DEVICE TO CIRCUIT BREAKER HANDLE, WITH RED MARKING, ACCESSIBLE ONLY TO AUTHORIZED PERSONNEL, IDENTIFIED AS "FIRE ALARM CIRCUIT", AND LOCATION OF CIRCUIT BREAKER PERMANENTLY IDENTIFIED AT FIRE ALARM CONTROL UNIT IN COMPLIANCE WITH NFPA 72, 10.6.5.2.
- ② HVAC UNIT (FIELD VERIFY EXACT LOCATION). PROVIDE AUTOMATIC SHUT OFF PER CMC 608, WITH CONTROL RELAY MODULE (4090-9002, 120V RELAY 10A) AND 120V RELAY MODULES (2089-9006, FIRE ALARM CONTROL RELAY, 1 SPDT CONTACTS RATED 10A, 120VAC) (LOCATE ABOVE ACCESSIBLE CEILING SPACE BELOW HVAC UNIT). SEE WIRING DIAGRAM ON SHEET 8/E401. CONNECT 120V POWER CIRCUIT TO 120V RELAY MODULES. PROVIDE LOCK ON DEVICE TO CIRCUIT BREAKER HANDLE, WITH RED MARKING.
- ③ PROVIDE NEW ACCESS PANEL. SEE ARCHITECTURAL DRAWINGS

KEY PLAN

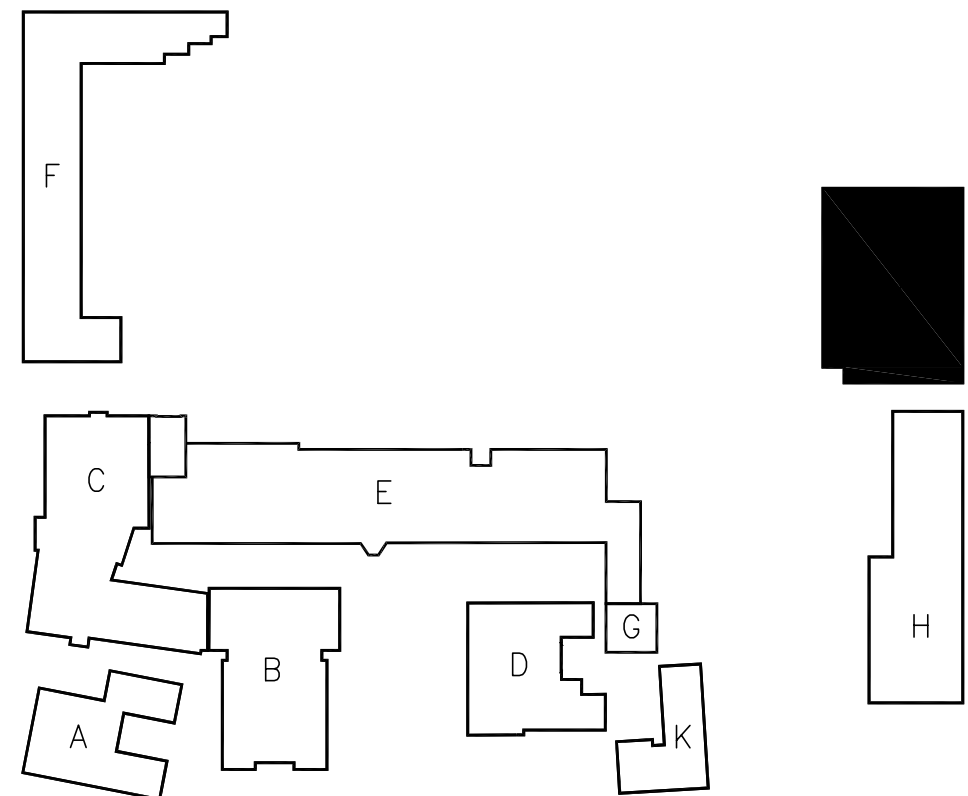

BUILDING "J" - FIRE ALARM PLAN

SCALE
1/8" = 1'-0"

1

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Architect



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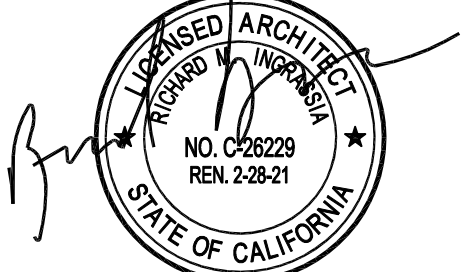
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1501 California Avenue
Santa Monica, California 90403


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11.26.19 50% CD

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Checked By: BA

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Consultants



Sheet Title

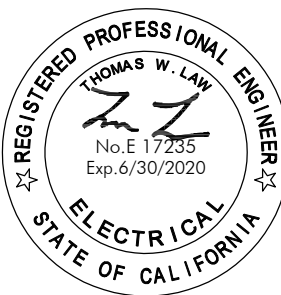Fire Alarm
Building "J"
Floor Plan

Sheet Number

EJ321



SCALE

SCALE

1

APPL. No. A 00-123456


- DSA Stamp

Architect



1. PROVIDE NEW (1/2)IN 1/4" CIRCULAR BREAKER TO ELECTRICAL PANEL. AS INDICATED, CIRCULAR BREAKER SHALL MATCH BY TYPE/SPECIFIC RATING. PROVIDE LOCK ON DEVICE TO CIRCULAR BREAKER HANDLE. WITH WIRING TERMINALS, ACCESSIBLE ONLY TO AUTHORIZED PERSONNEL, IDENTIFIED AS "FIRE ALARM CIRCUIT", AND LOCATION OF CIRCULAR BREAKER PERMANENTLY IDENTIFIED AT FIRE ALARM CONTROL UNIT IN COMPLIANCE WITH NFPA 72, 10.6.5.2.
2. HVAC UNIT (FIELD VERIFY EXACT LOCATION). PROVIDE AUTOMATIC SHUT OFF PER CMSC 088, WITH CONTROL RYRLE MODULE (4090-0002), IDINET RYRLE (IAM) AND 120V RYRLE MODULES (2008-0008). FIRE ALARM CONTROL RYRLE SHALL BE LOCATED IN THE CEILING SPACE ABOVE THE CEILING SPACE BELOW HVAC UNIT. SEE WIRING DIAGRAM ON SHEET BE401. CONNECT 120V POWER CIRCUIT TO 120V RYRLE MODULES. PROVIDE LOCK ON DEVICE TO CIRCULAR BREAKER HANDLE, WITH RED MARKING.
3. PROVIDE NEW ACCESS PANEL. SEE ARCHITECTURAL DRAWINGS.

Consultants

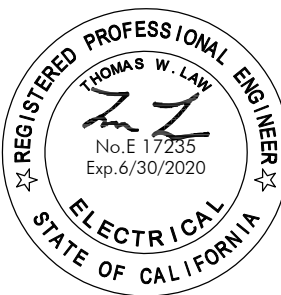


Sheet Title

Fire Alarm
Building "K"
First Floor Plan

Sheet Number

EK321

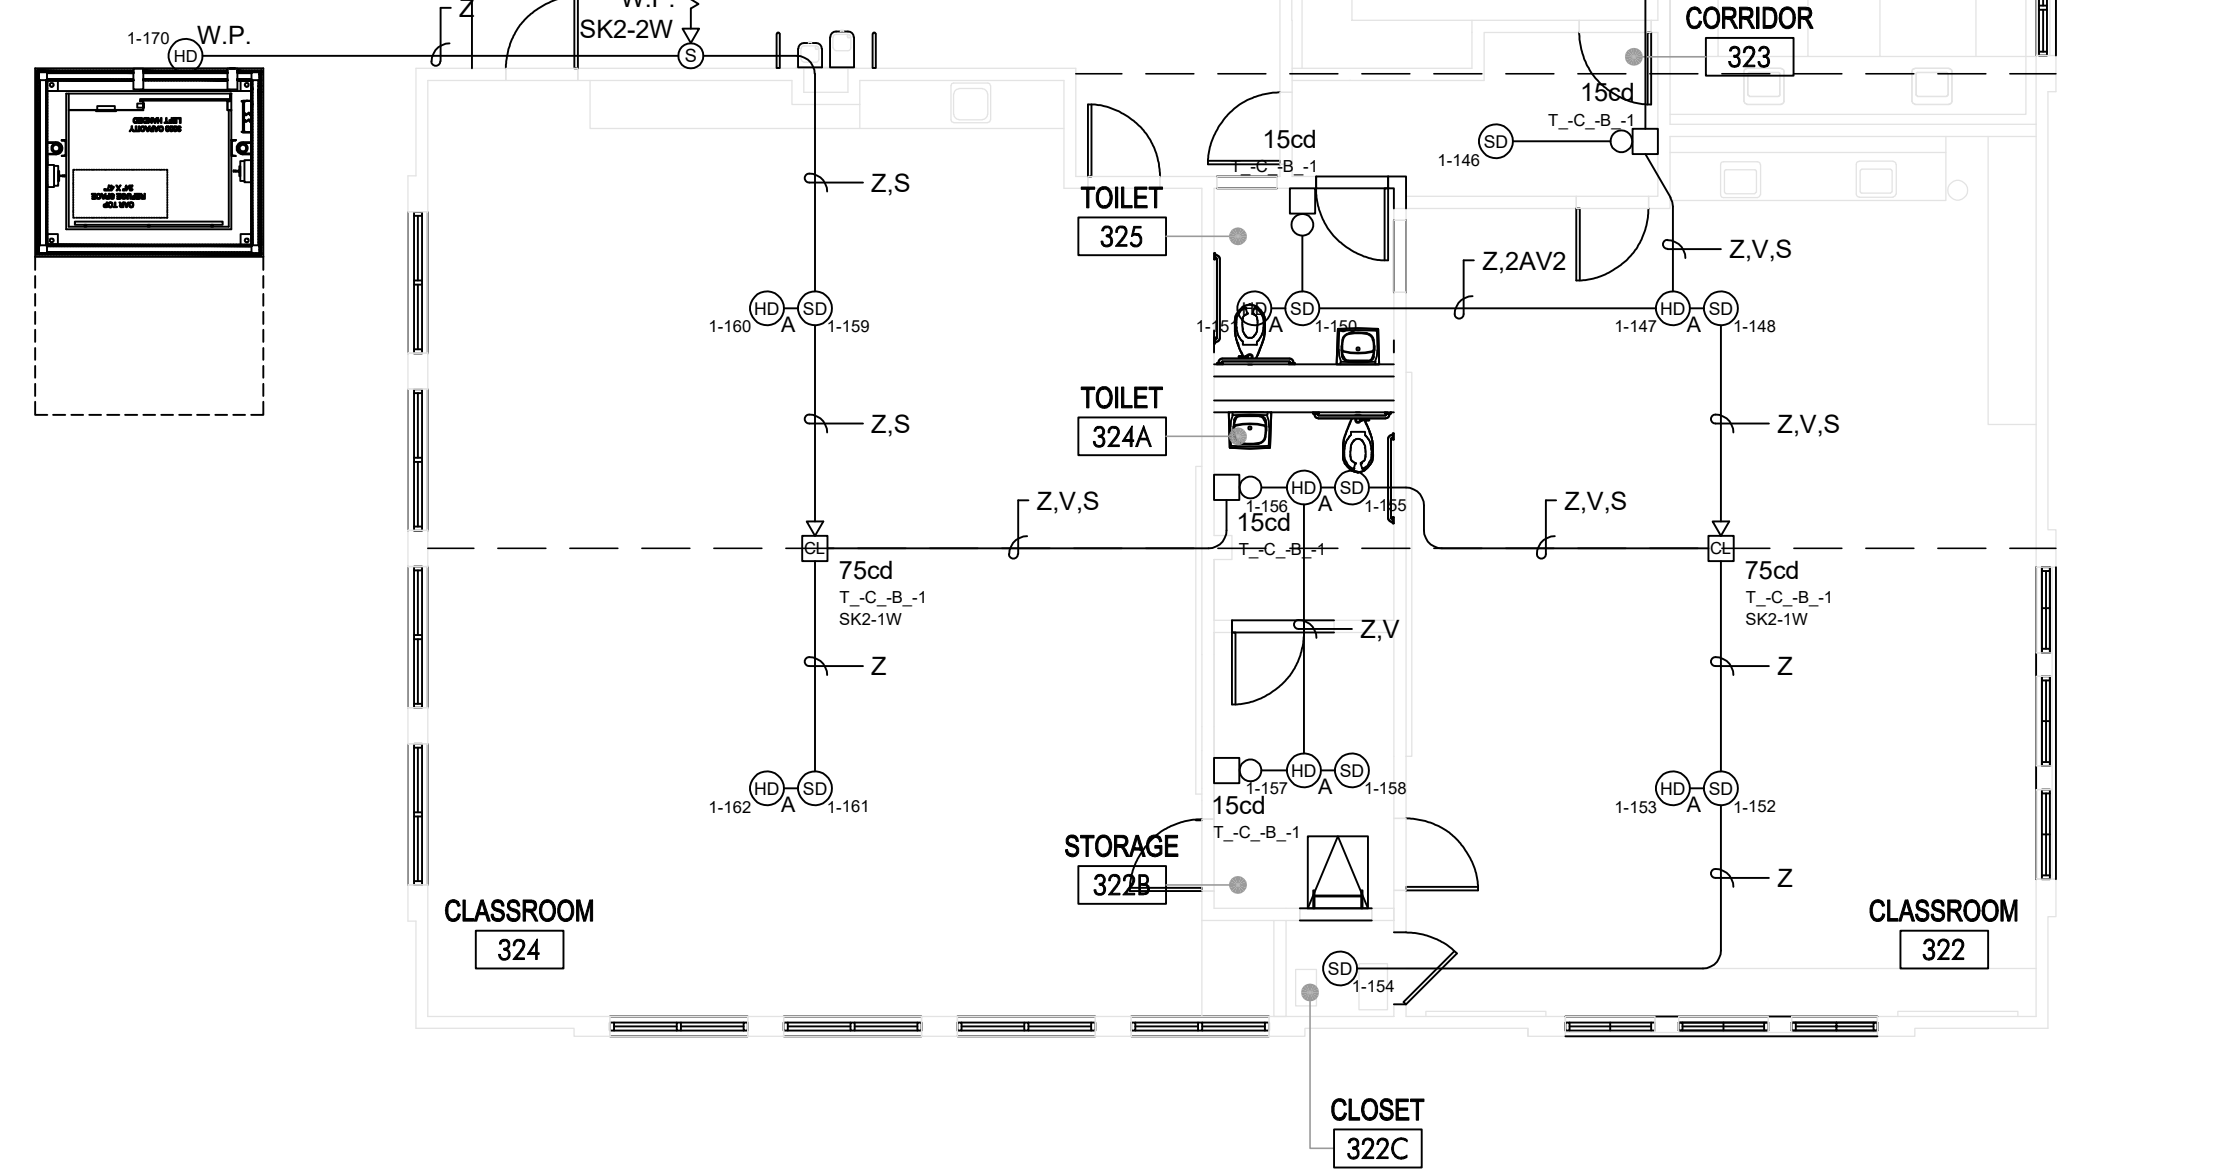


GENERAL NOTES

1. EXISTING CONDUIT MAYBE RE-USE FOR NEW POWER, PROVIDED THEY MEET MINIMUM CONDUIT SIZE REQUIREMENTS AND WIRE FILL CAPACITY (40%), OTHERWISE PROVIDE NEW CONDUITS, CONTRACTOR SHALL BE RESPONSIBLE FOR OBTAINING ALL NECESSARY PERMITS, RELOCATE, UPGRADE AND PROVIDE NEW CONDUITS TO EXTEND TO NEW DEVICE LOCATIONS AS NECESSARY.
2. EXISTING FIRE ALARM SYSTEM SHALL BE MAINTAINED UNTIL NEW FIRE ALARM HAS BEEN INSTALLED.
3. EXISTING FIRE ALARM PANEL SHALL BE MAINTAINED UNTIL NEW FIRE ALARM PANEL IS INSTALLED.
4. FIRE SAFETY DURING CONSTRUCTION AND DEMOLITION SHALL BE IN COMPLIANCE WITH CFC 216, CHAPTER 9, 11 AND 33 AND CBC 2016, CHAPTER 33. PROVIDE FIRE WATCH UNTIL THE NEW SYSTEM IS IN PLACE.
5. CONTRACTOR SHALL EXERCISE EXTREME CAUTION WHILE EXCAVATING FOR NEW UNDERGROUND UTILITIES. FIELD VERIFY AND COORDINATE PRIOR TO EXCAVATION ANY DAMAGE TO EXISTING UTILITIES. CONTRACTOR SHALL BE RESPONSIBLE FOR REPAIRING ANY DAMAGE TO EXISTING UTILITIES WITHOUT INTERRUPTION TO OPERATION OF FACILITIES AT NO ADDITIONAL COST TO THE OWNER. IT MAY BE NECESSARY TO RUN NEW UTILITIES UNDER/OVER EXISTING UTILITIES (CROSSOVER).
6. AUTOMATIC SHUTOFF IS NOT REQUIRED WHEN ALL OCCUPIED ROOMS SERVED BY THE AIR-HANDLING EQUIPMENT HAVE BEEN SHUT DOWN TO THE EXTERIOR AND THE TRAVEL DISTANCE DOES NOT EXCEED 100 FEET. (CMC 608 EXEMPTION#2)

REFERENCE NOTES

- ① PROVIDE NEW (1/2IN) 1\"/>

KEY PLAN

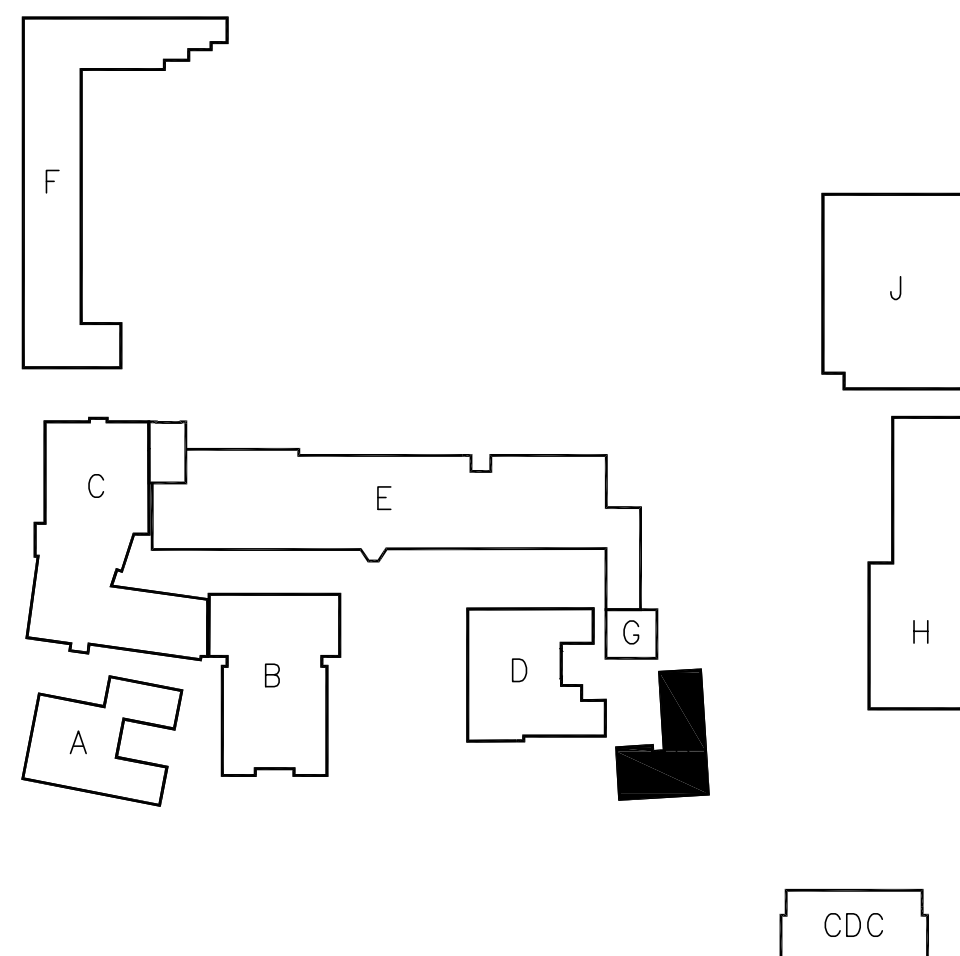

BUILDING "K" - FIRE ALARM SECOND FLOOR PLAN

SCALE	1
1/8" = 1'-0"	

SCALE	1
1/8" = 1'-0"	

1

APPL. No. A 00-123456

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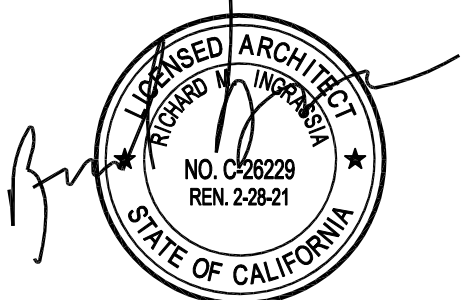
1501 California Avenue

Santa Monica, California 90403


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Sheet Title

Fire Alarm Building "K"


Second Floor Plan

Sheet Number

EK322
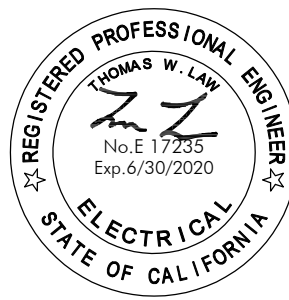
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GENERAL NOTES

1. EXISTING CONDUIT MAY BE RE-USED FOR NEW WORK, PROVIDED THEY MEET MINIMUM CONDUIT SIZE REQUIREMENTS AND WIRE FILL CAPACITY (40%). OTHERWISE PROVIDE NEW CONDUITS. CONTRACTOR SHALL PROVIDE NEW CONDUITS TO BE INSTALLED IN THE MIDDLE OF THE ROW. PROVIDE NEW CONDUITS TO EXTEND TO NEW DEVICE LOCATIONS AS NECESSARY.
2. EXISTING FIRE ALARM SYSTEM SHALL BE MAINTAINED UNTIL NEW FIRE ALARM HAS BEEN INSTALLED.
3. EXISTING FIRE ALARM SYSTEM SHALL BE MAINTAINED UNTIL NEW FIRE ALARM HAS BEEN INSTALLED.
4. FIRE SAFETY DURING CONSTRUCTION AND DEMOLITION SHALL BE IN COMPLIANCE WITH CFC 2016, CHAPTER 9, 11 AND 38 & CBC 2016, CHAPTER 33. PROVIDE FIRE WATCH UNTIL THE NEW SYSTEM IS IN OPERATION AND APPROVED BY O.R. OR DSA. LOCAL FIRE AUTHORITY OF DISTRICT.
5. CONTRACTOR SHALL EXERCISE EXTREME CAUTION WHILE EXCAVATING FOR NEW UNDERGROUND UTILITIES. FIELD VERIFY AND COORDINATE PRIOR TO EXCAVATION ANY DAMAGE TO EXISTING UTILITIES AND UTILITIES SHALL BE PROTECTED AND MAINTAINED. CONTRACTOR SHALL MAINTAIN WITHOUT INTERRUPTION TO OPERATION OF FACILITIES AT NO ADDITIONAL COST TO THE OWNER. IT MAY BE NECESSARY TO RUN NEW UTILITIES UNDEROVER EXISTING UTILITIES (CROSSOVER).
6. ALL MATERIALS SHUTTLED TO AND FROM THE PROJECT SHALL BE LOADED AND UNLOADED. THE AIR-HANDLING EQUIPMENT HAVE DIRECT EXIT TO THE EXTERIOR AND THE TRAVEL DISTANCE DOES NOT EXCEED 100 FEET. (CMC 608 EXEMPTION#2)

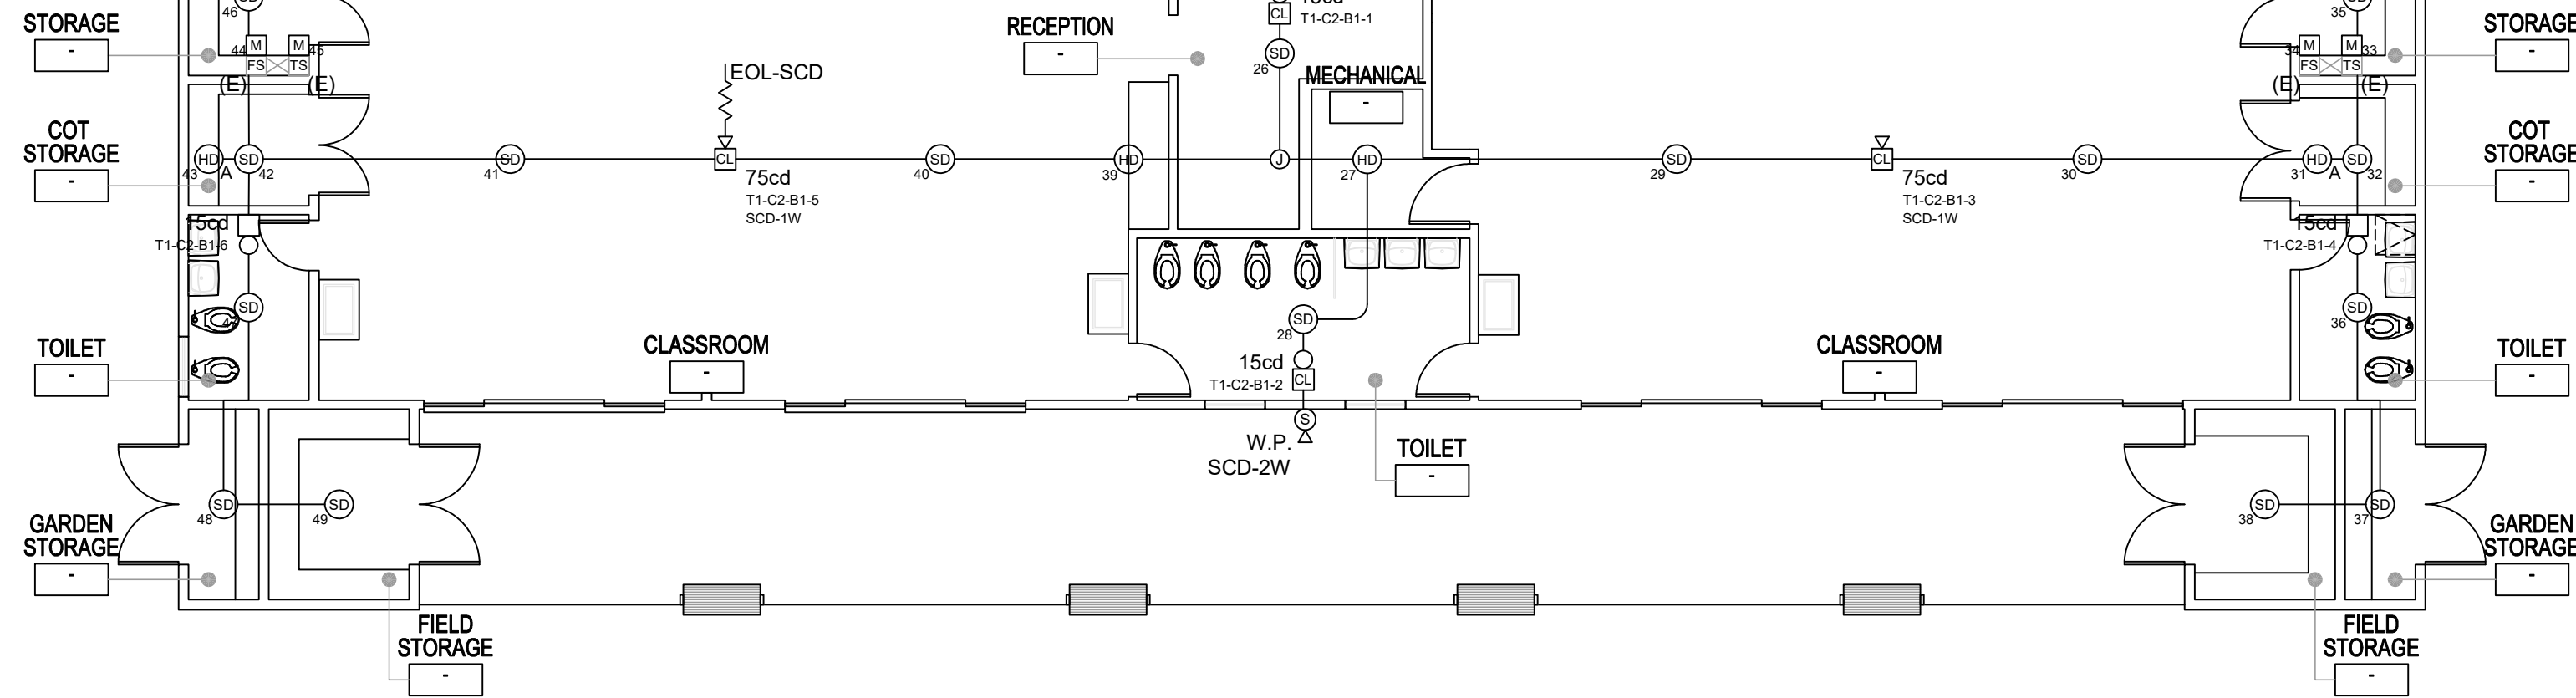REFERENCE NOTES

- ① PROVIDE NEW (1/20A IP) CIRCUIT BREAKER TO ELECTRICAL PANEL, AS INDICATED. CIRCUIT BREAKER SHALL MATCH BY TYPE/CIRCUIT RATING. PROVIDE LOCK ON DEVICE TO CIRCUIT BREAKER HANDLE. PROVIDE MARKINGS, WHERE POSSIBLE, ONLY TO AUTHORIZED PERSONNEL. IDENTIFIED AS FIRE ALARM CIRCUIT, AND LOCATION OF CIRCUIT BREAKER PERMANENTLY IDENTIFIED AT FIRE ALARM CONTROL UNIT IN COMPLIANCE WITH NFPA 72, 10.6.5.2.
- ② PROVIDE (2) DEDICATED PHONE LINES (ANALOG) TO MDF/IDF WITHIN THE BUILDING FOR REMOTE STATION MONITORING.
- ③ PROVIDE A SIGNAGE ("FIRE ALARM CONTROL PANEL INSIDE") AT THE DOOR TO FAC/PCPS. SEE DETAIL ON 6E-402. PATCH/PANEL/REPAIR TO MATCH ADJACENT SURFACES.

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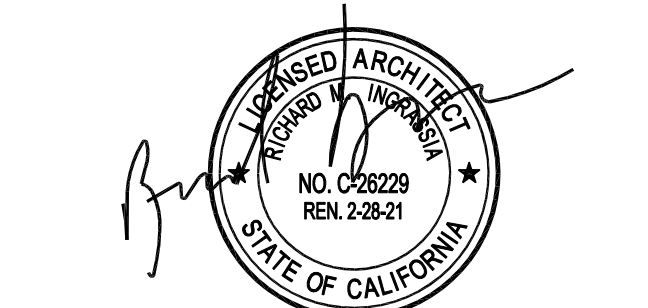
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Santa Monica, California 90403


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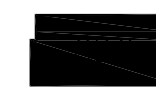
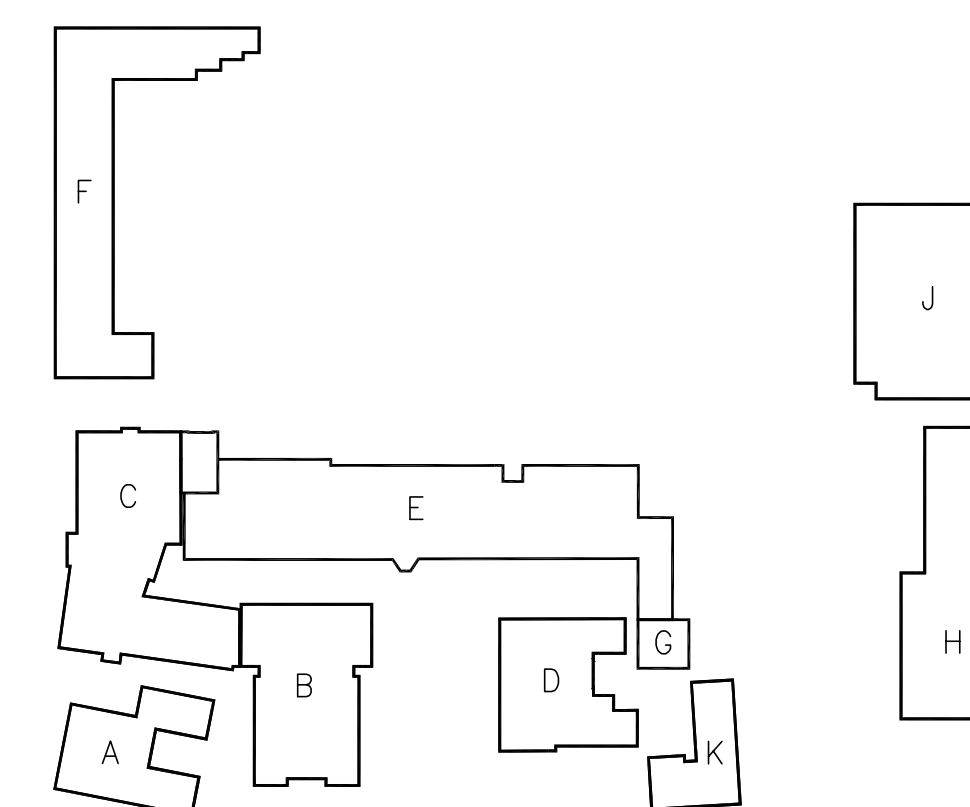
Sheet Title

Fire Alarm
Child Development
Center (CDC)
Floor Plan

Sheet Number

ECDC321

KEY PLAN

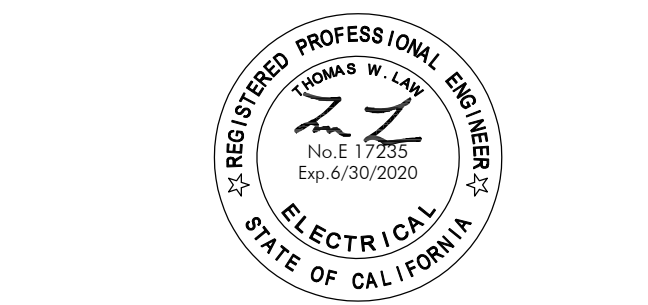



Child Development Center (CDC) - FIRE ALARM PLAN

SCALE
1/8" = 1'-0"

1

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- INSTRUCTIONS**
1. REMOVE ELECTRONIC CARD CAGE (IF PRESENT) AND STORE IT IN A SAFE DRY AREA.
 2. NO KNOCKOUTS PROVIDED. CUT CONDUIT/SERVICE ENTRANCE OPENINGS. REFER TO FIG. 1 FOR PROPER LOCATIONS. CONDUIT PROTRUSION INTO BOX 1/2" MAX.
 3. MOUNT BOX TO WALL. BOX MUST BE LEVEL AND PLUMB. FOR SURFACE MOUNT, USE EAR DROP AND CLEARANCE HOLES. ON BACK SURFACE, FOR SEMI-FLUSH MOUNT, USE WALL STUD GUIDES FOR MAXIMUM ALLOWABLE BOX DEPTH TO PROVIDE OPEN DOOR CLEARANCE. USE KNOCKOUTS ON SIDE WALL. SCREW OR NAIL BOX TO WALL STUDS.
 4. MINIMUM DISTANCE BETWEEN ANY TWO BOXES IS 3 1/4" (6" MAXIMUM).
 5. IF PRESENT, USE WIRE MANAGEMENT BRACKETS ON BOX SIDES TO SECURE WIRE RUNS.
 6. NEMA RATING: NEMA 1 - GENERAL PURPOSE.
 7. DO NOT LOCATE POWER-LIMITED WIRING IN THE SHADED AREAS OF THE BACKBOX. THIS AREA IS RESERVED FOR NON-POWER LIMITED CIRCUITRY SUCH AS AC POWER, BATTERIES AND CITY CONNECTION. REFER TO AUTOCALL BACKBOX INSTALLATION DOCUMENT 579-117AC FOR DETAILED INSTRUCTIONS.

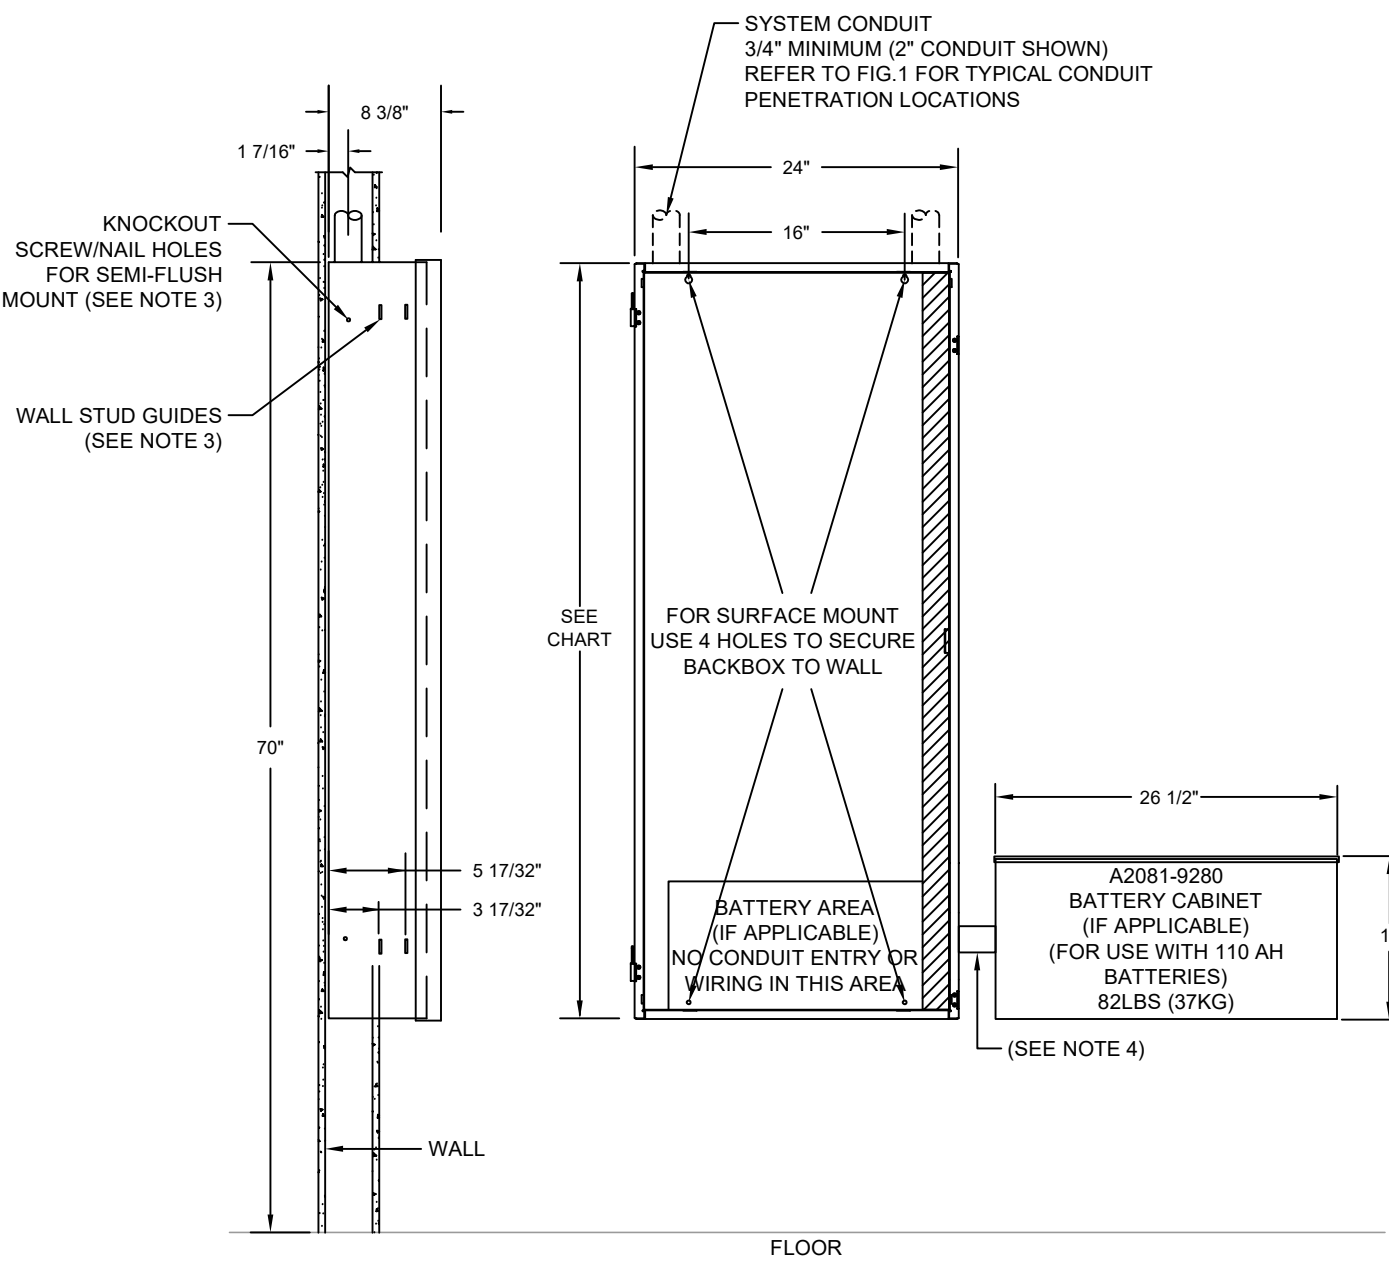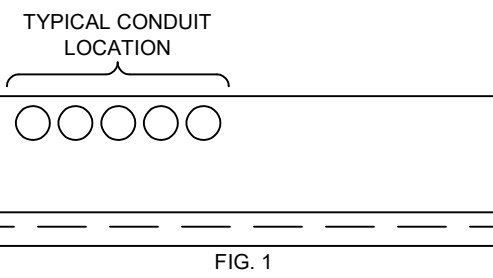

BACKBOX AND DOOR OPTIONS

PID NUMBER	BOX HEIGHT	BOX LENGTH	BOX DEPTH
A2081-9280	12"	26 1/2"	12"
A4081-9306	13 1/2"	27 7/8"	14 5/8"
A4081-9308	13 1/2"	27 7/8"	14 5/8"


BACKBOX AND DOOR OPTIONS

PKG. SIZE	BOX W/ GLASS DOOR	BOX W/ SOLID DOOR	BOX ONLY	GLASS DOOR	SOLID DOOR	BOX HEIGHT
1 BAY RED	A2975-9441	A2975-9447	A2975-9407	A100-2124	A100-2134	22"
2 BAY RED	A2975-9442	A2975-9448	A2975-9408	A100-2125	A100-2135	40"
3 BAY RED	A2975-9443	A2975-9449	A2975-9409	A100-2126	A100-2136	56"

FIRE ALARM CONTROL PANEL BACKBOX INSTALLATION

SCALE
NTS


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- WIRING NOTES**
1. MAINTAIN CORRECT POLARITY ON TERMINAL CONNECTIONS.
 2. ALWAYS CUT CONDUCTORS AND SECURE UNDER TERMINALS. NEVER LOOP WIRES UNDER TERMINALS.
 3. ANY WIRE SPLICES TO BE MADE BY LISTED AND AHJ APPROVED METHODS.

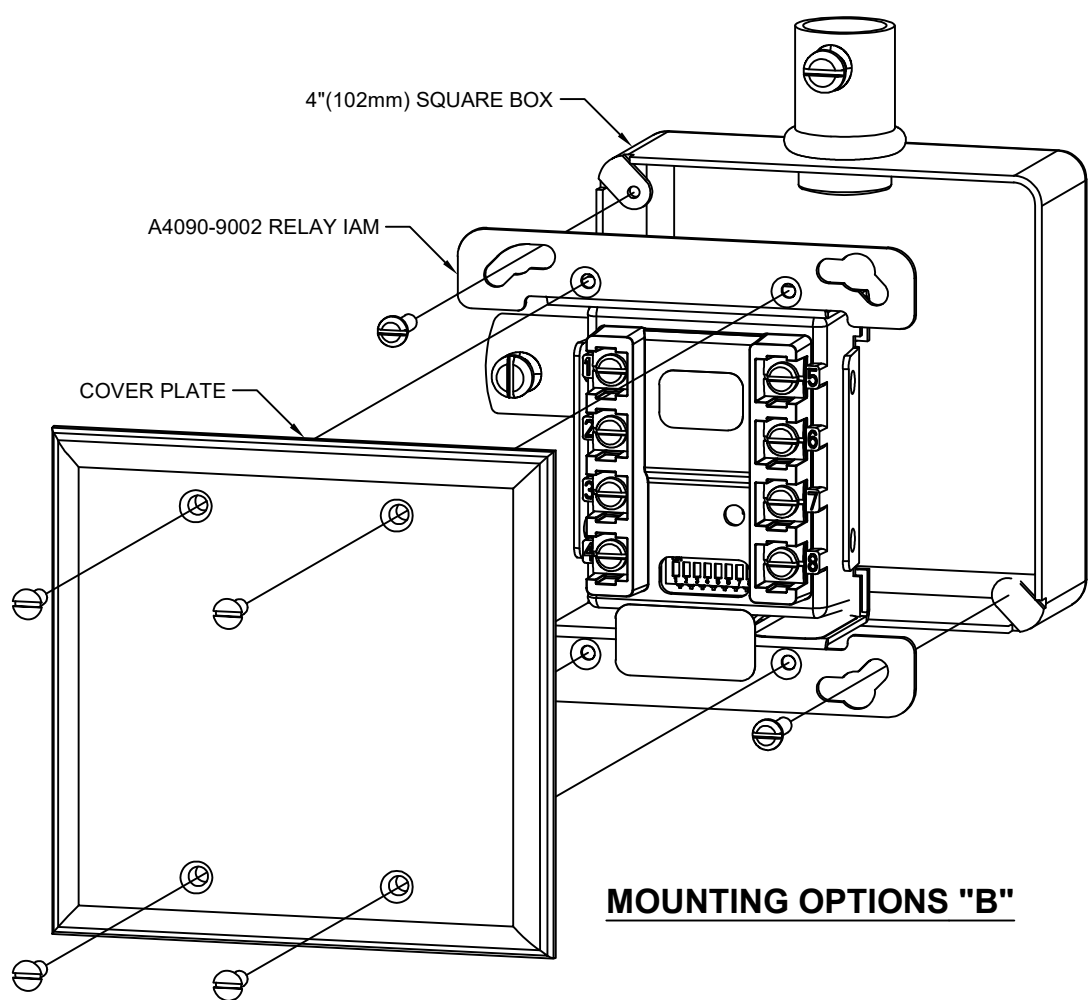MOUNTING OPTIONS


OPTION	DESCRIPTION	NOTE
A	SINGLE GANG BOX, 2-1/2" DEEP WITH SINGLE GANG COVER PLATE	BY OTHERS
B	SINGLE GANG BOX, 2-1/2" DEEP WITH AUTOCALL A4090-9810 IAM MOUNTING BRACKET AND AUTOCALL A4090-9808 TRIM PLATE FOR SEMI-FLUSH MOUNTED BOX	BOX BY OTHERS PLATES ORDERED SEPARATELY
C	SINGLE GANG BOX, 2-1/2" DEEP WITH AUTOCALL A4090-9810 IAM MOUNTING BRACKET AND AUTOCALL A4090-9807 TRIM PLATE FOR SURFACE MOUNTED BOX	BOX BY OTHERS PLATES ORDERED SEPARATELY



A4603-9101 REMOTE ANNUNCIATOR

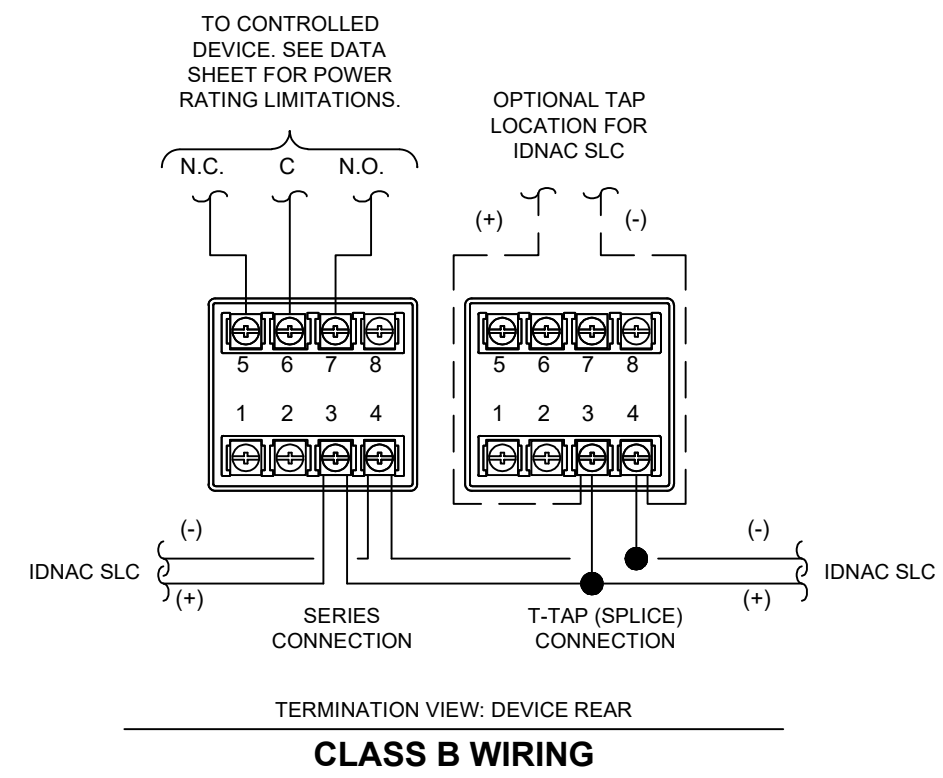SCALE
NTS


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- WIRING NOTES**
1. MAINTAIN CORRECT POLARITY ON TERMINAL CONNECTIONS.
 2. ALWAYS CUT CONDUCTORS AND SECURE UNDER TERMINALS. NEVER LOOP WIRES UNDER TERMINALS.
 3. ANY WIRE SPLICES TO BE MADE BY LISTED AND AHJ APPROVED METHODS.

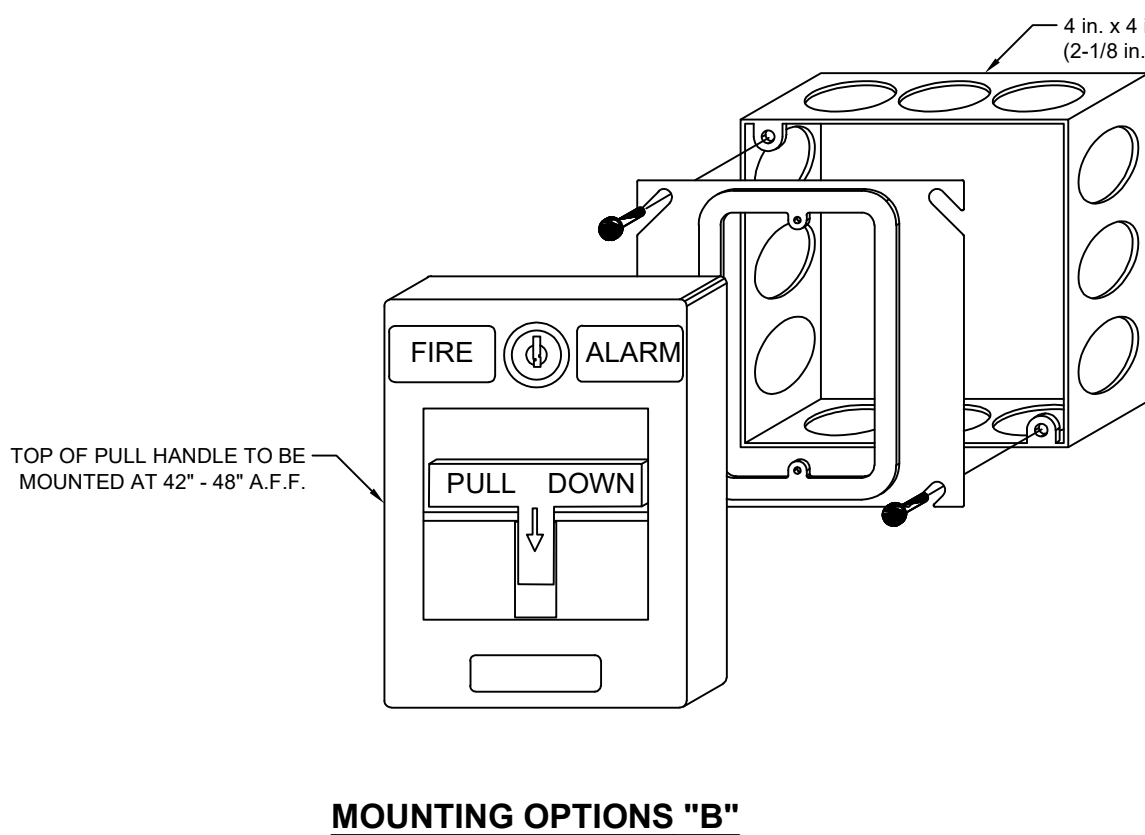MOUNTING OPTIONS


OPTION	DESCRIPTION	NOTE
A	SINGLE GANG BOX, 2-1/2" DEEP	BY OTHERS
B	4" SQUARE BOX, 2-1/2" DEEP (MIN) W/ SINGLE GANG COVER PLATE 3/4" EXTENSION	BY OTHERS
C	AUTOCALL A2975-9822 - 5H x 3-7/8"W x 2-3/16"D	ORDERED SEPARATELY
D	AUTOCALL A2975-9178 - 5-3/4"H x 3-7/8"W x 2-3/16"D	ORDERED SEPARATELY



A4090-9002 IDNET, SUPERVISED ADDRESSABLE MODULE (IAM)

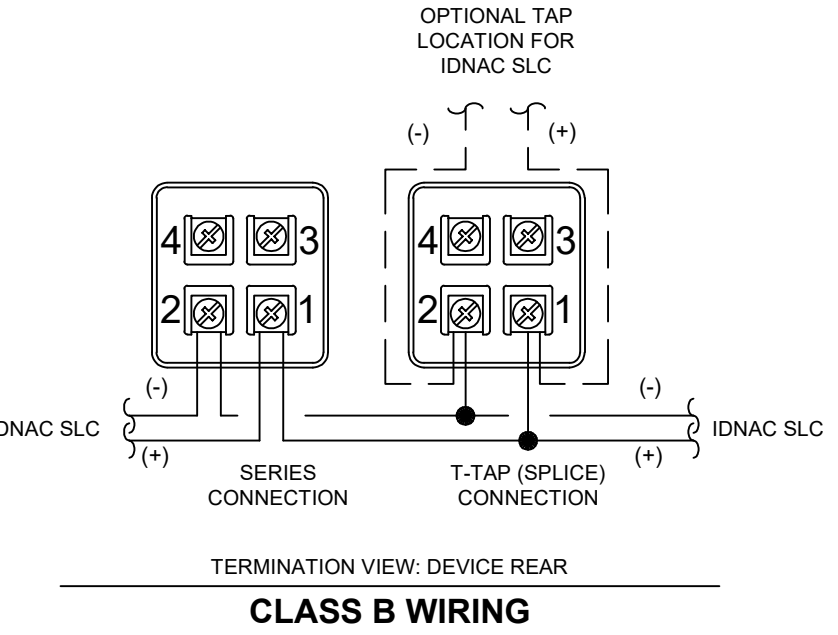SCALE
NTS


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- WIRING NOTES**
1. MAINTAIN CORRECT POLARITY ON TERMINAL CONNECTIONS.
 2. ALWAYS CUT CONDUCTORS AND SECURE UNDER TERMINALS. NEVER LOOP WIRES UNDER TERMINALS.
 3. ANY WIRE SPLICES TO BE MADE BY LISTED AND AHJ APPROVED METHODS.

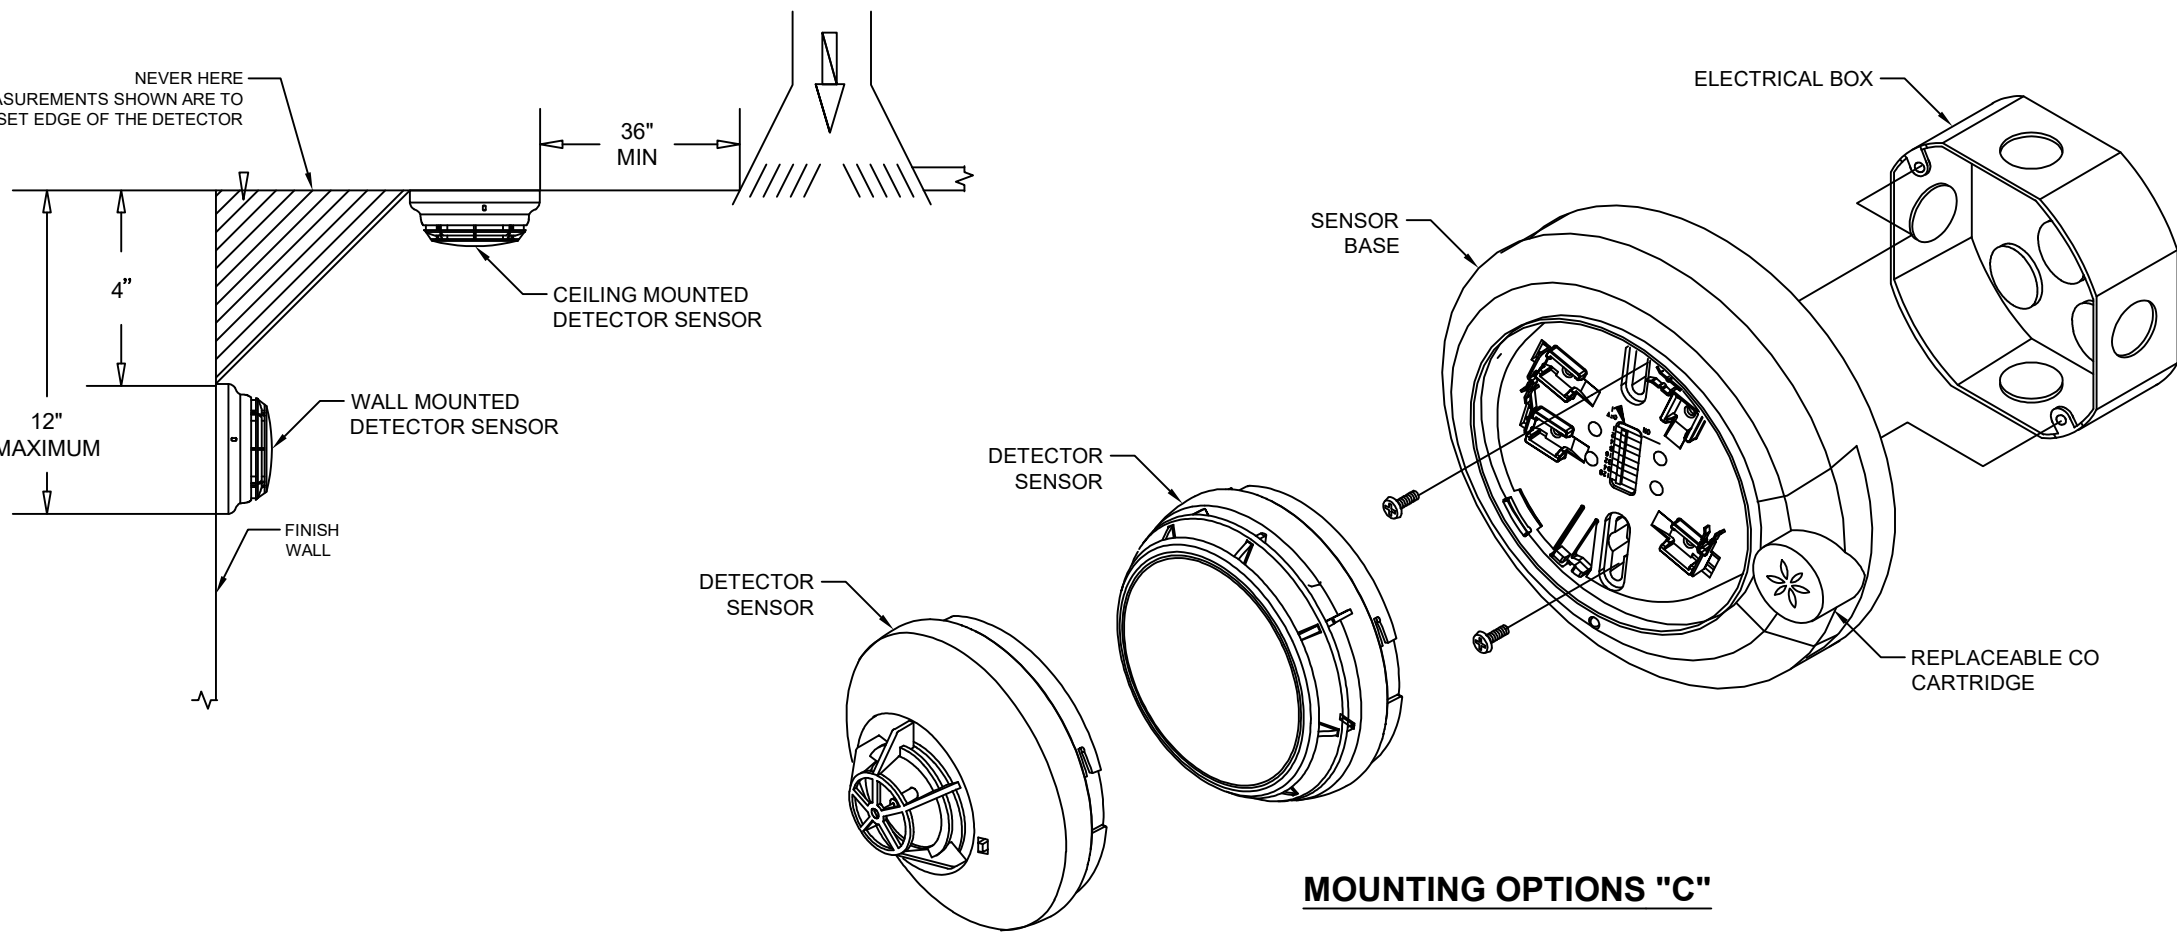MOUNTING OPTIONS

OPTION	DESCRIPTION	NOTE
A	SINGLE GANG BOX, 2-1/2" DEEP	BY OTHERS
B	4" SQUARE BOX, 1-1/2" DEEP (MIN) W/ SINGLE GANG COVER PLATE 3/4" EXTENSION	BY OTHERS
C	4" OCTAGONAL BOX, 1-1/2" DEEP, MINIMUM	BY OTHERS
D	4" SQUARE BOX, 1-1/2" DEEP (MIN) W/ AUTOCALL A4098-9863 ADAPTER KIT	BOX BY OTHERS, A4098-9863 ORDERED SEPARATELY



A4098-9770 CARBON MONOXIDE SENSOR BASE

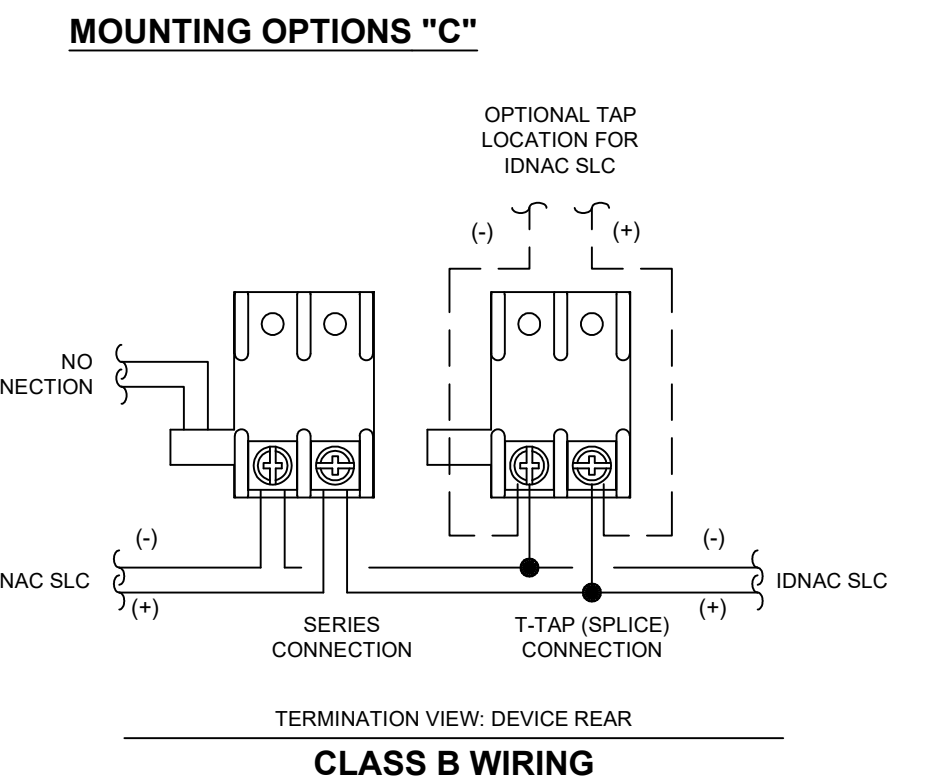SCALE
N.T.S.

7

A4099-9001 SINGLE ACTION IDNET ADDRESSABLE STATION

SCALE
NTS

5

PRODUCT INFORMATION


- FEATURES:**
- LISTED STANDARD 904
 - POWER AND COMMUNICATIONS ARE SUPPLIED BY THE TRULERTAL ADDRESSABLE SIGNALING LINE CIRCUIT (ALC)
 - OPERATION IS COMPATIBLE WITH TRULERTAL ADDRESSABLE CONTROLLERS AND ADDRES TRULERTAL POWER SUPPLIES
 - OPERATION MODE AND VISIBLE ADDRESS APPLIANCE BOTH ON OR VISIBLE APPLIANCE ONLY - WITH ACTION SELECTED BY THE CONNECTED TRULERTAL ADDRESSABLE CONTROLLER
 - AN ON-BOARD DC-DC REGULATOR PROVIDES PROPER APPLIANCE VOLTAGE AND PROVIDES SELF-TESTING OVERCURRENT PROTECTION
 - UP TO TWO TRULERTAL ADDRESSABLE ADAPTER MODULES CAN BE CONNECTED TO ONE TRULERTAL SLC

- SPECIFICATIONS:**
- WIRE CONNECTIONS: SCREW TERMINALS FOR #18 TO #12 AWG
 - DIMENSIONS: 4-1/16" H x 3-1/4" W x 2-3/16" D
 - TEMPERATURE RANGE: 32° F TO 120° F
 - HUMIDITY: USE TO 90% RH NON-CONDENSING AT 90°
 - SUPERVISION RESISTOR: 10K OHM, TWO REQUIRED, ONE LOCATED AT EACH END OF THE SLC

DESCRIPTION:

THE 4099 TRULERTAL ADAPTER IS A MODULE THAT ALLOWS CONVENTIONAL NOTIFICATION APPLIANCES TO BE OPERATED ON A TRULERTAL SLC (SIGNALLING LINE CIRCUIT). THE TRULERTAL ADAPTER CONNECTS TO AND IS POWERED BY THE TRULERTAL SLC. THE ADAPTER CAN ADAPT THE WIRING OF A NEW OR EXISTING INSTALLATION. THE ADAPTER CAN ADAPT THE ADDRESS AND THE NOTIFICATION APPLIANCE ON ONE OR TWO SLC OPERATION. THE TRULERTAL ADAPTER CAN ONLY BE OPERATED THROUGH A COMPLETE 4098-9863 TRULERTAL ADDRESSABLE CONTROLLER OF ADDRES 7200 THESE MODELS: 7200, 7201, 7202, UP TO TWO TRULERTAL ADAPTERS CAN BE USED ON ONE SLC.

- WIRING NOTES:**
1. THE TRULERTAL ADAPTER CAN ONLY BE OPERATED THROUGH A COMPLETE 4098-9863 TRULERTAL ADDRESSABLE CONTROLLER OF ADDRES 7200.
 2. ALL TRULERTAL SLC CIRCUITS ARE SUPERVISED AND POWER-LIMITED.
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A4905-9816 TrueAlert Adapter Module

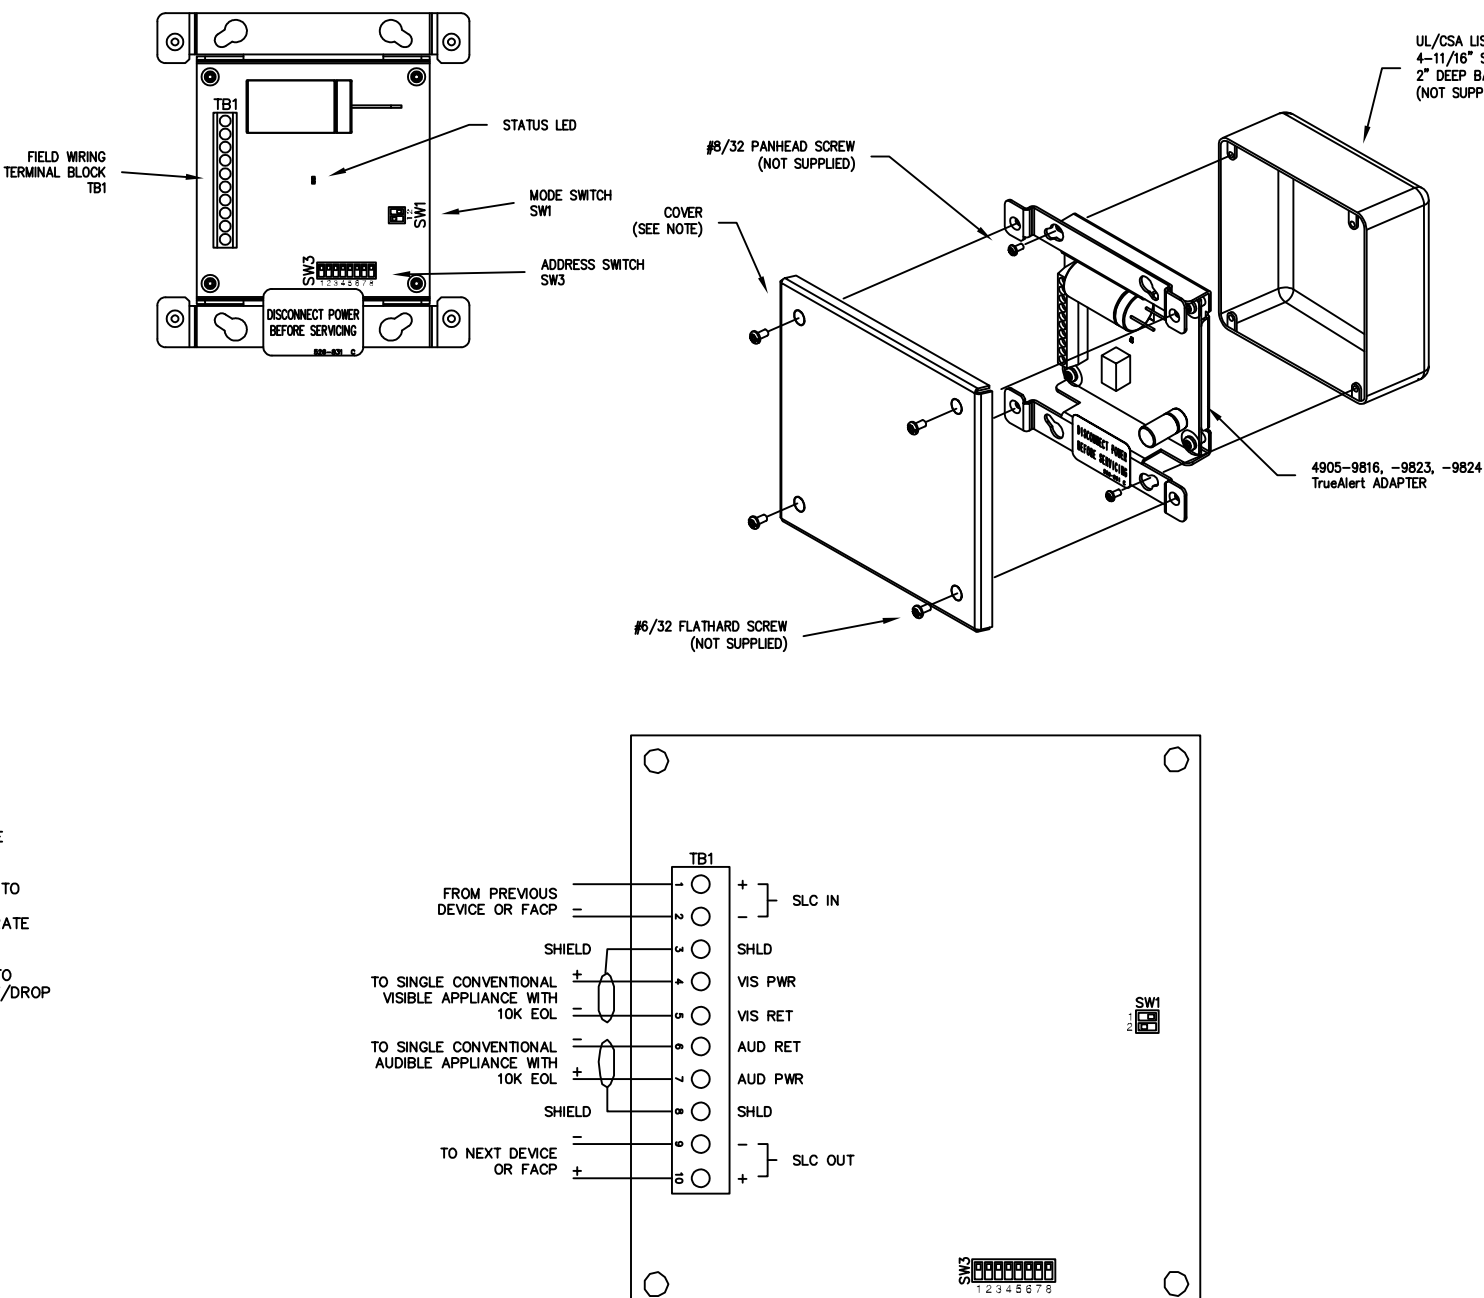
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A4090-9001 IDNET, SUPERVISED ADDRESSABLE MODULE (IAM)

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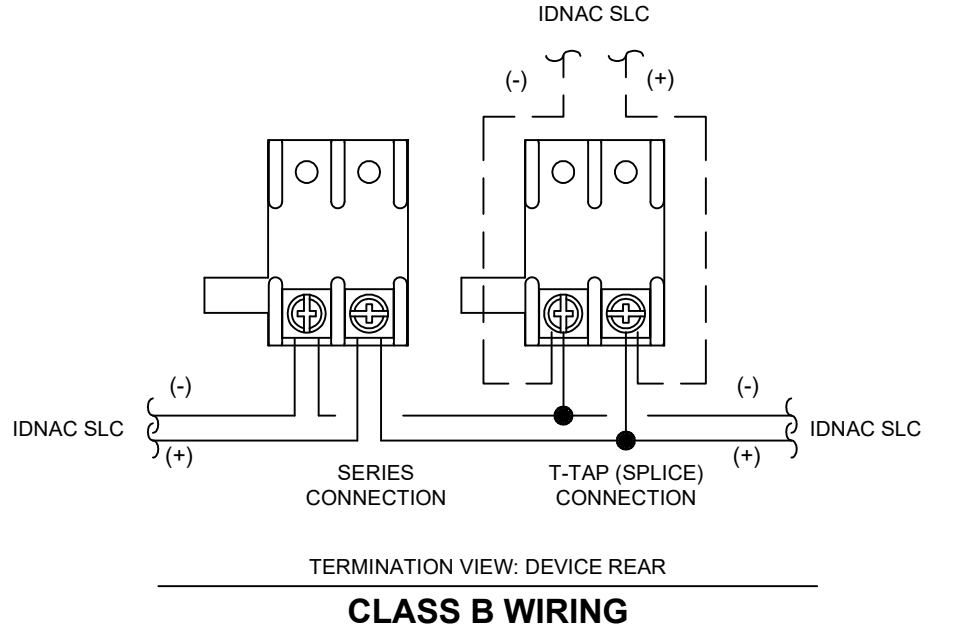
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- WIRING NOTES**
1. MAINTAIN CORRECT POLARITY ON TERMINAL CONNECTIONS.
 2. ALWAYS CUT CONDUCTORS AND SECURE UNDER TERMINALS. NEVER LOOP WIRES UNDER TERMINALS.
 3. ANY WIRE SPLICES TO BE MADE BY LISTED AND AHJ APPROVED METHODS.

MOUNTING OPTIONS


OPTION	DESCRIPTION	NOTE
A	SINGLE GANG BOX, 2-1/2" DEEP	BY OTHERS
B	4" SQUARE BOX, 1-1/2" DEEP (MIN) W/ SINGLE GANG COVER PLATE 3/4" EXTENSION	BY OTHERS
C	4" OCTAGONAL BOX, 1-1/2" DEEP, MINIMUM	BY OTHERS
D	4" SQUARE BOX, 1-1/2" DEEP (MIN) W/ AUTOCALL A4098-9832 ADAPTER KIT	BOX BY OTHER, A4098-9832 ORDERED SEPARATELY

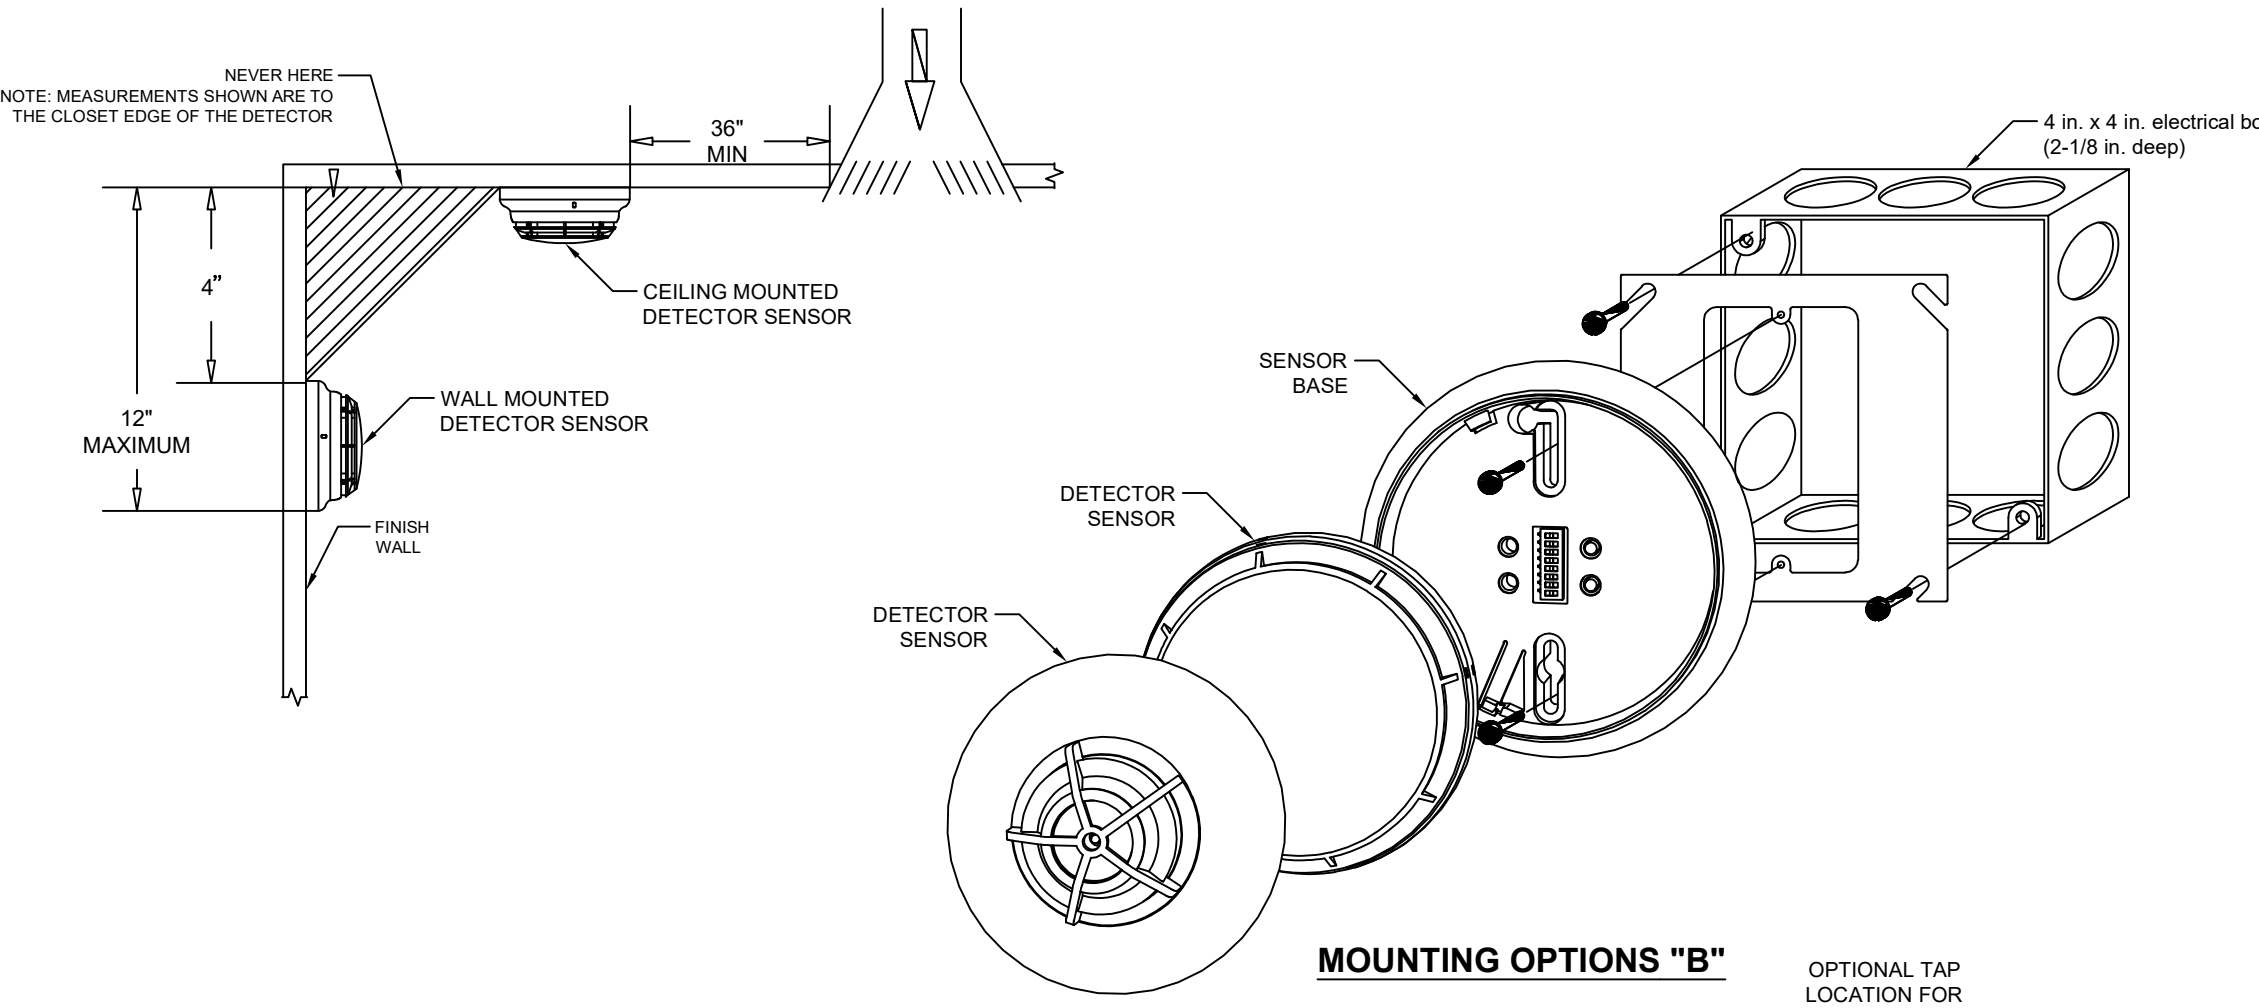

A4098-9792 STANDARD SENSOR BASE

SCALE
N.T.S.

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AUTOCALL IDNET RELAY IAM WITH MULTI-VOLTAGE RELAY
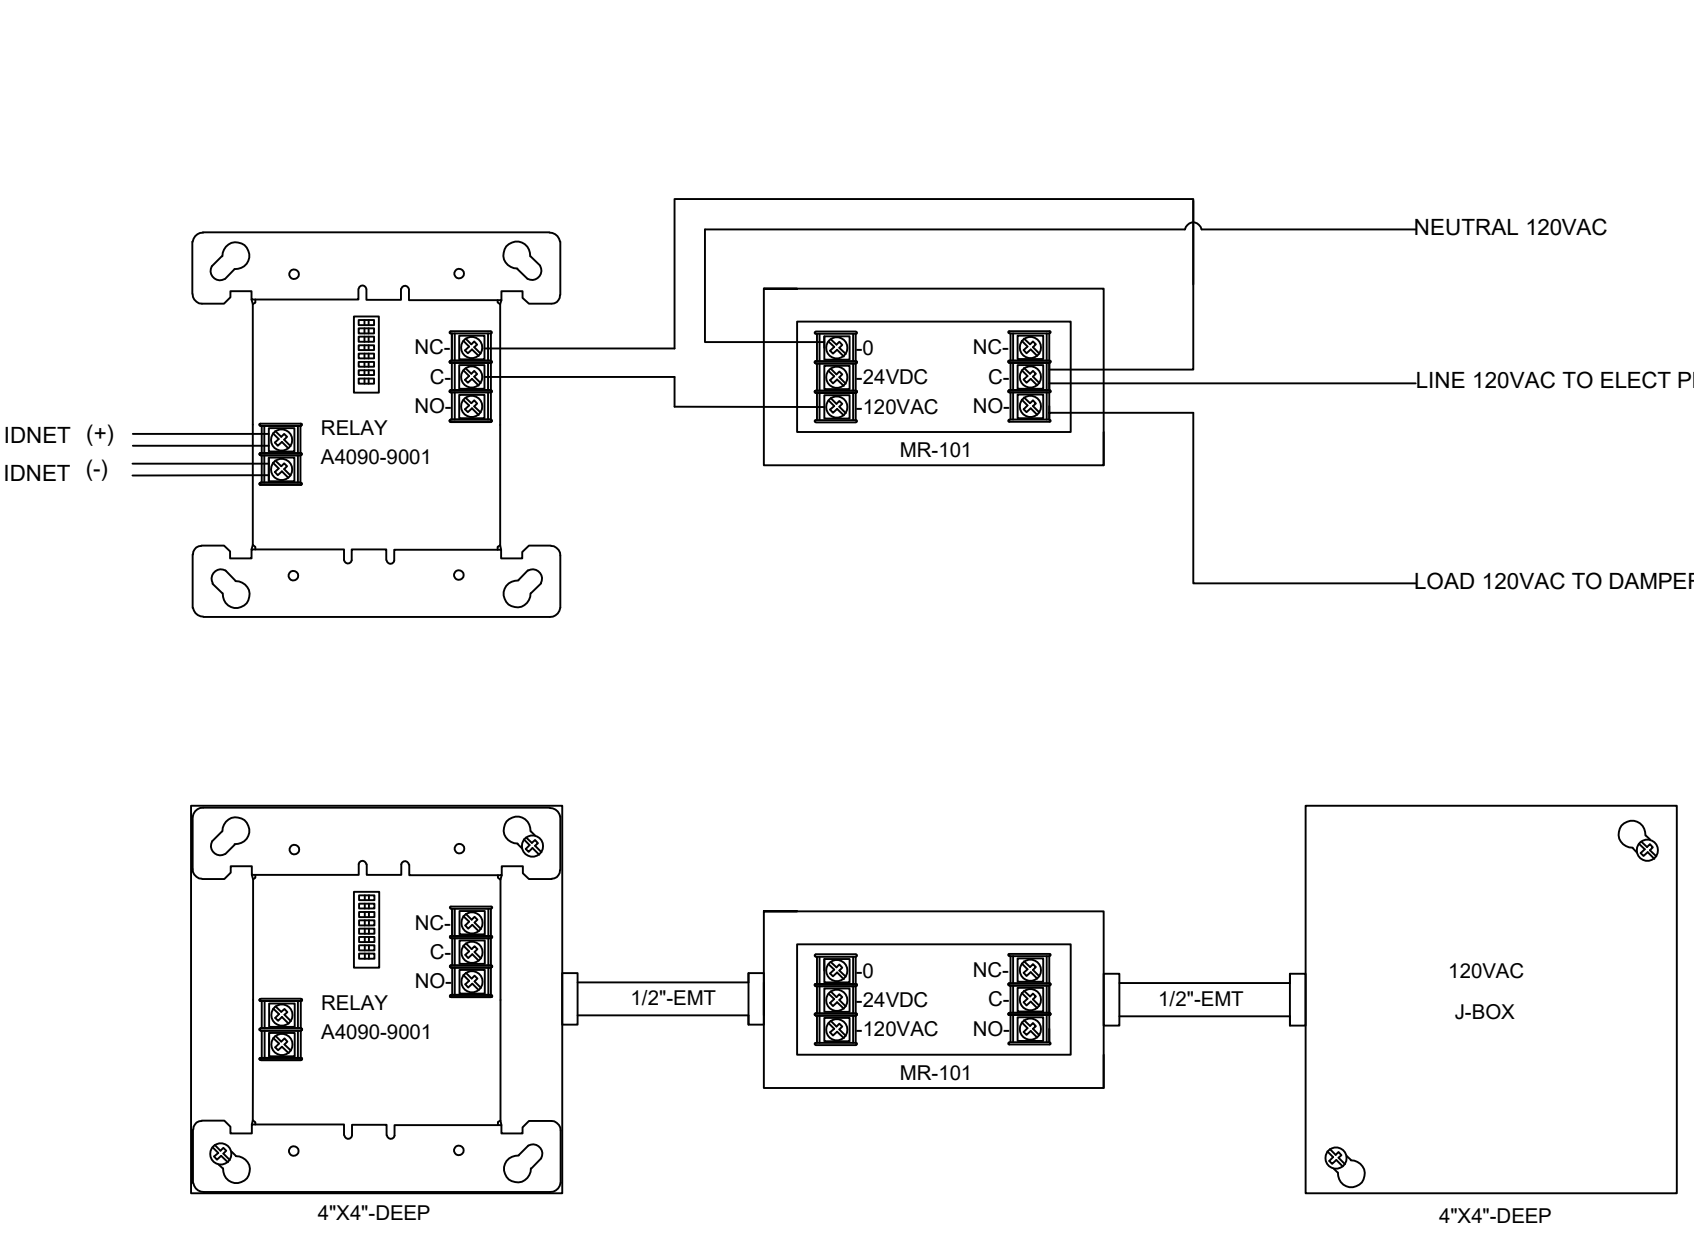
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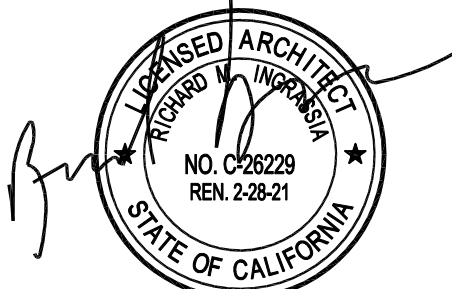
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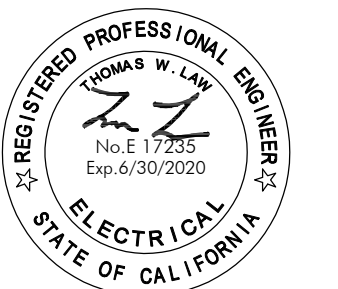
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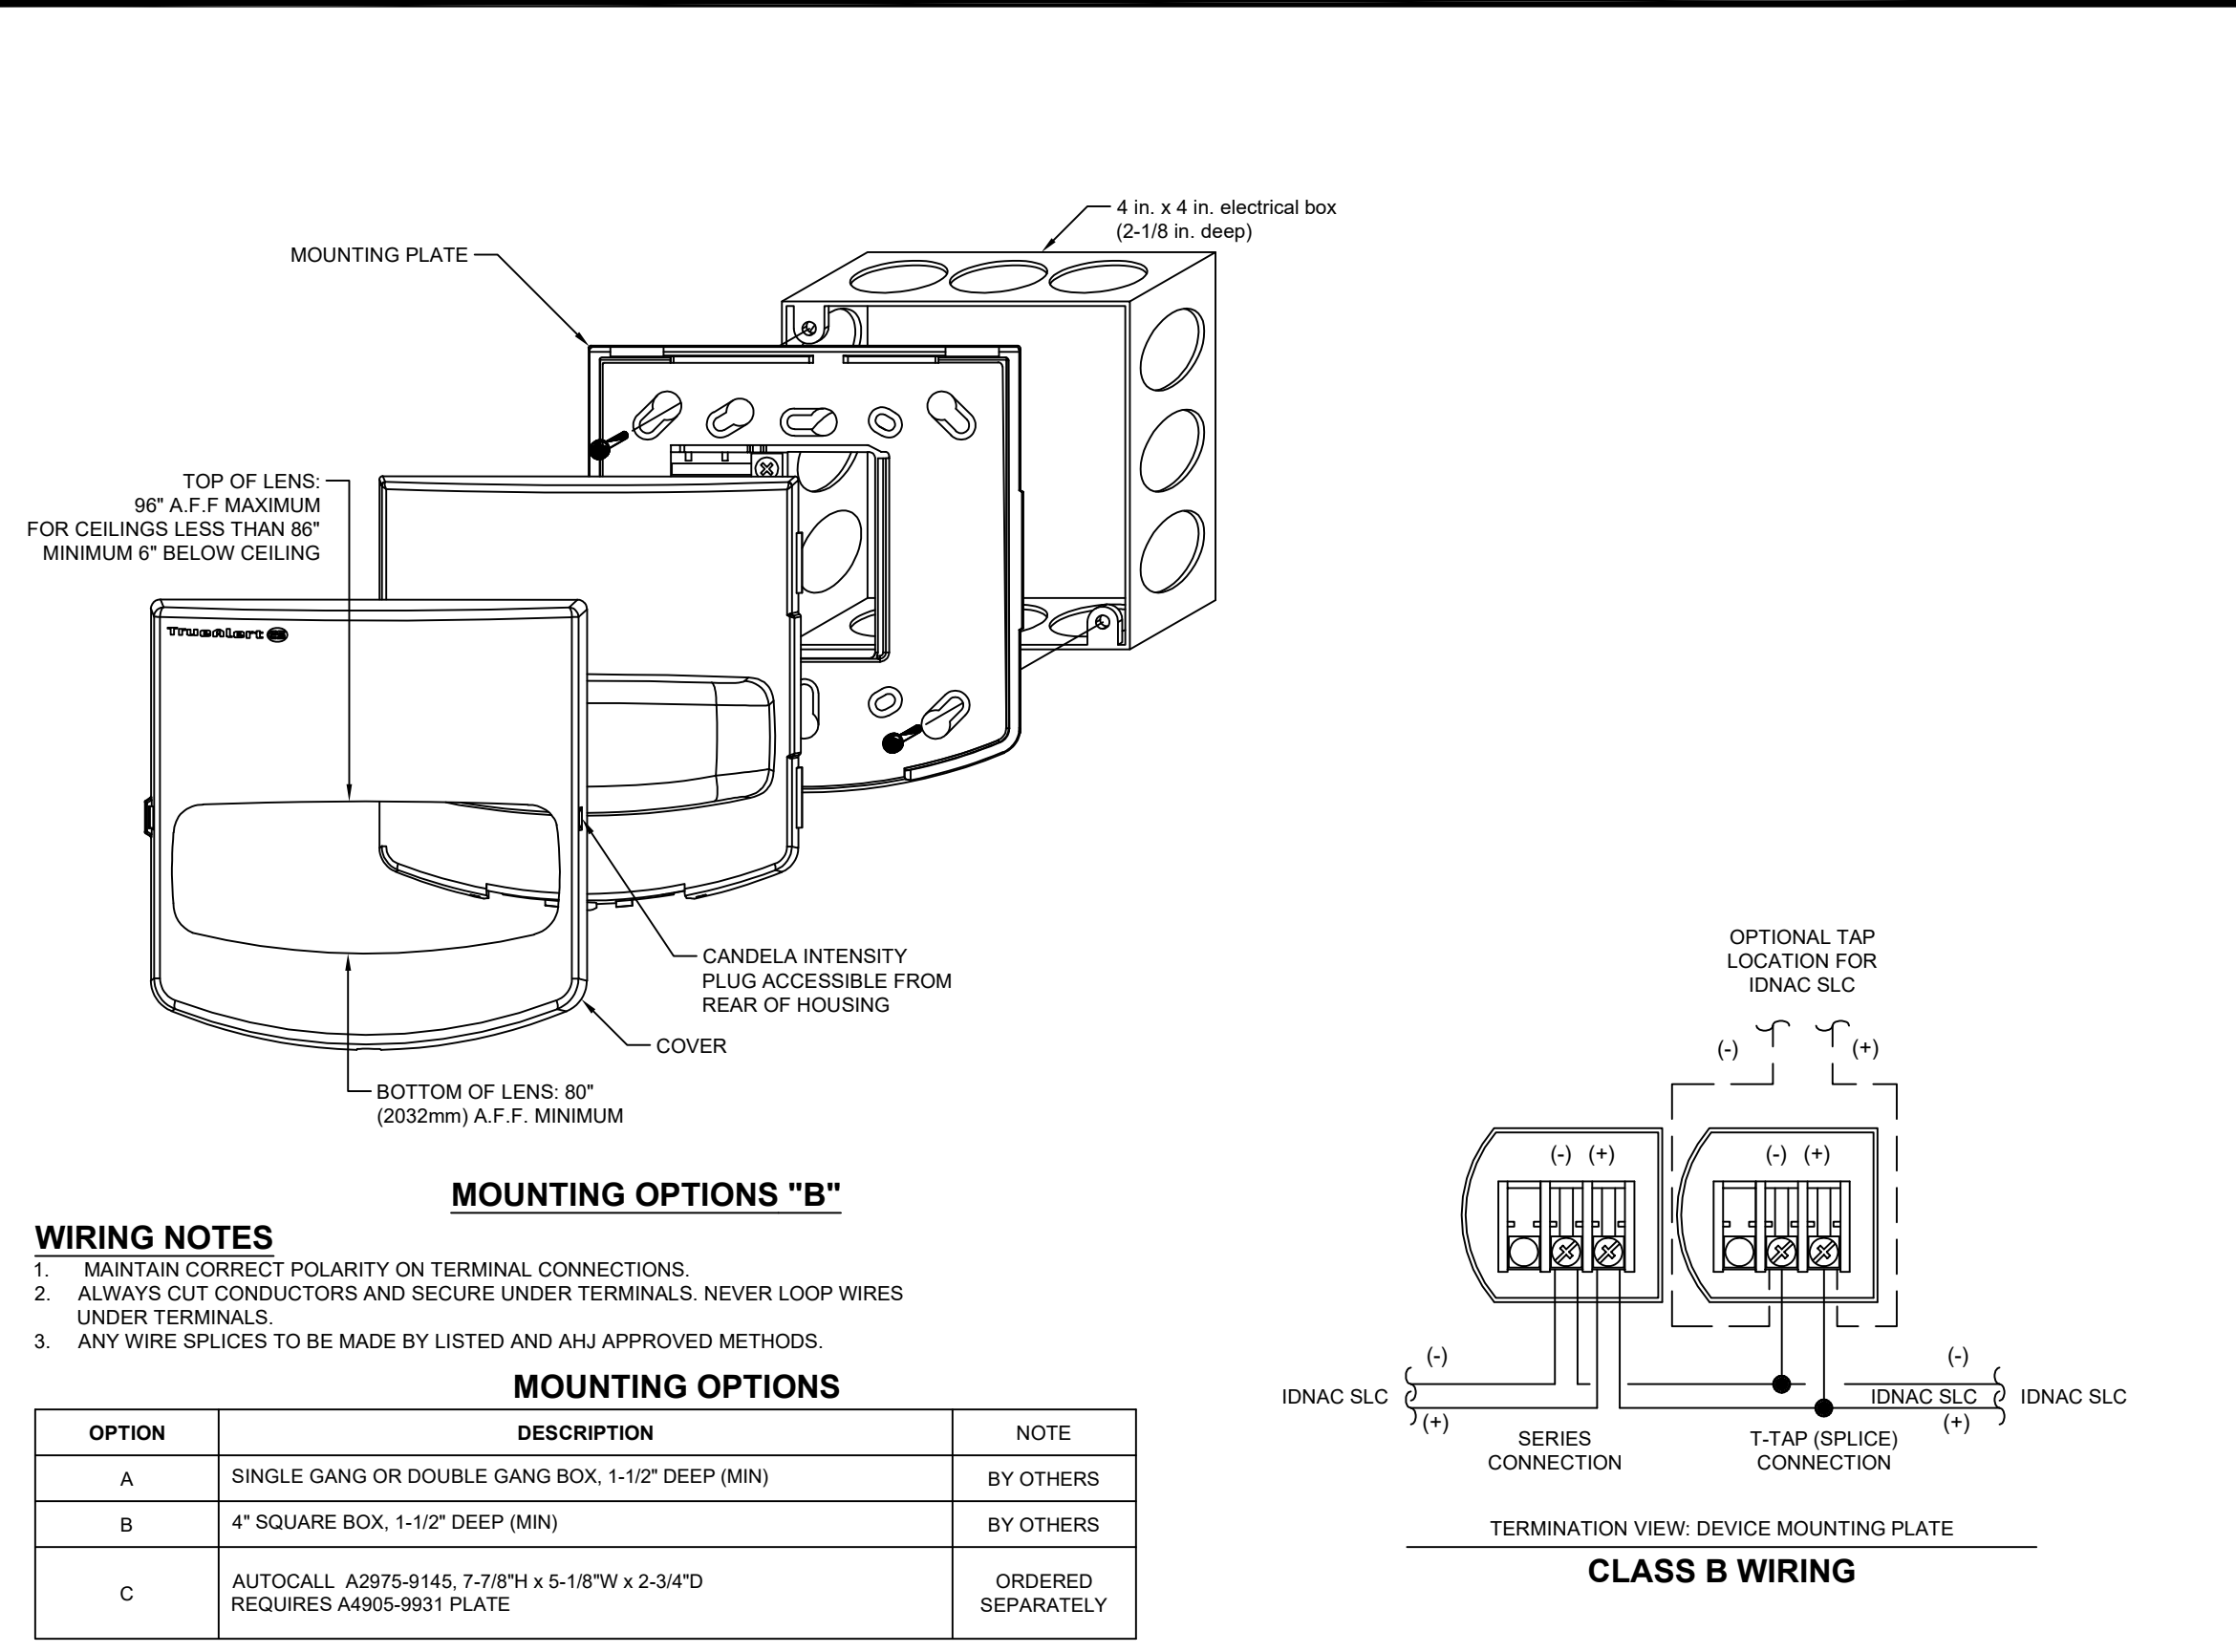
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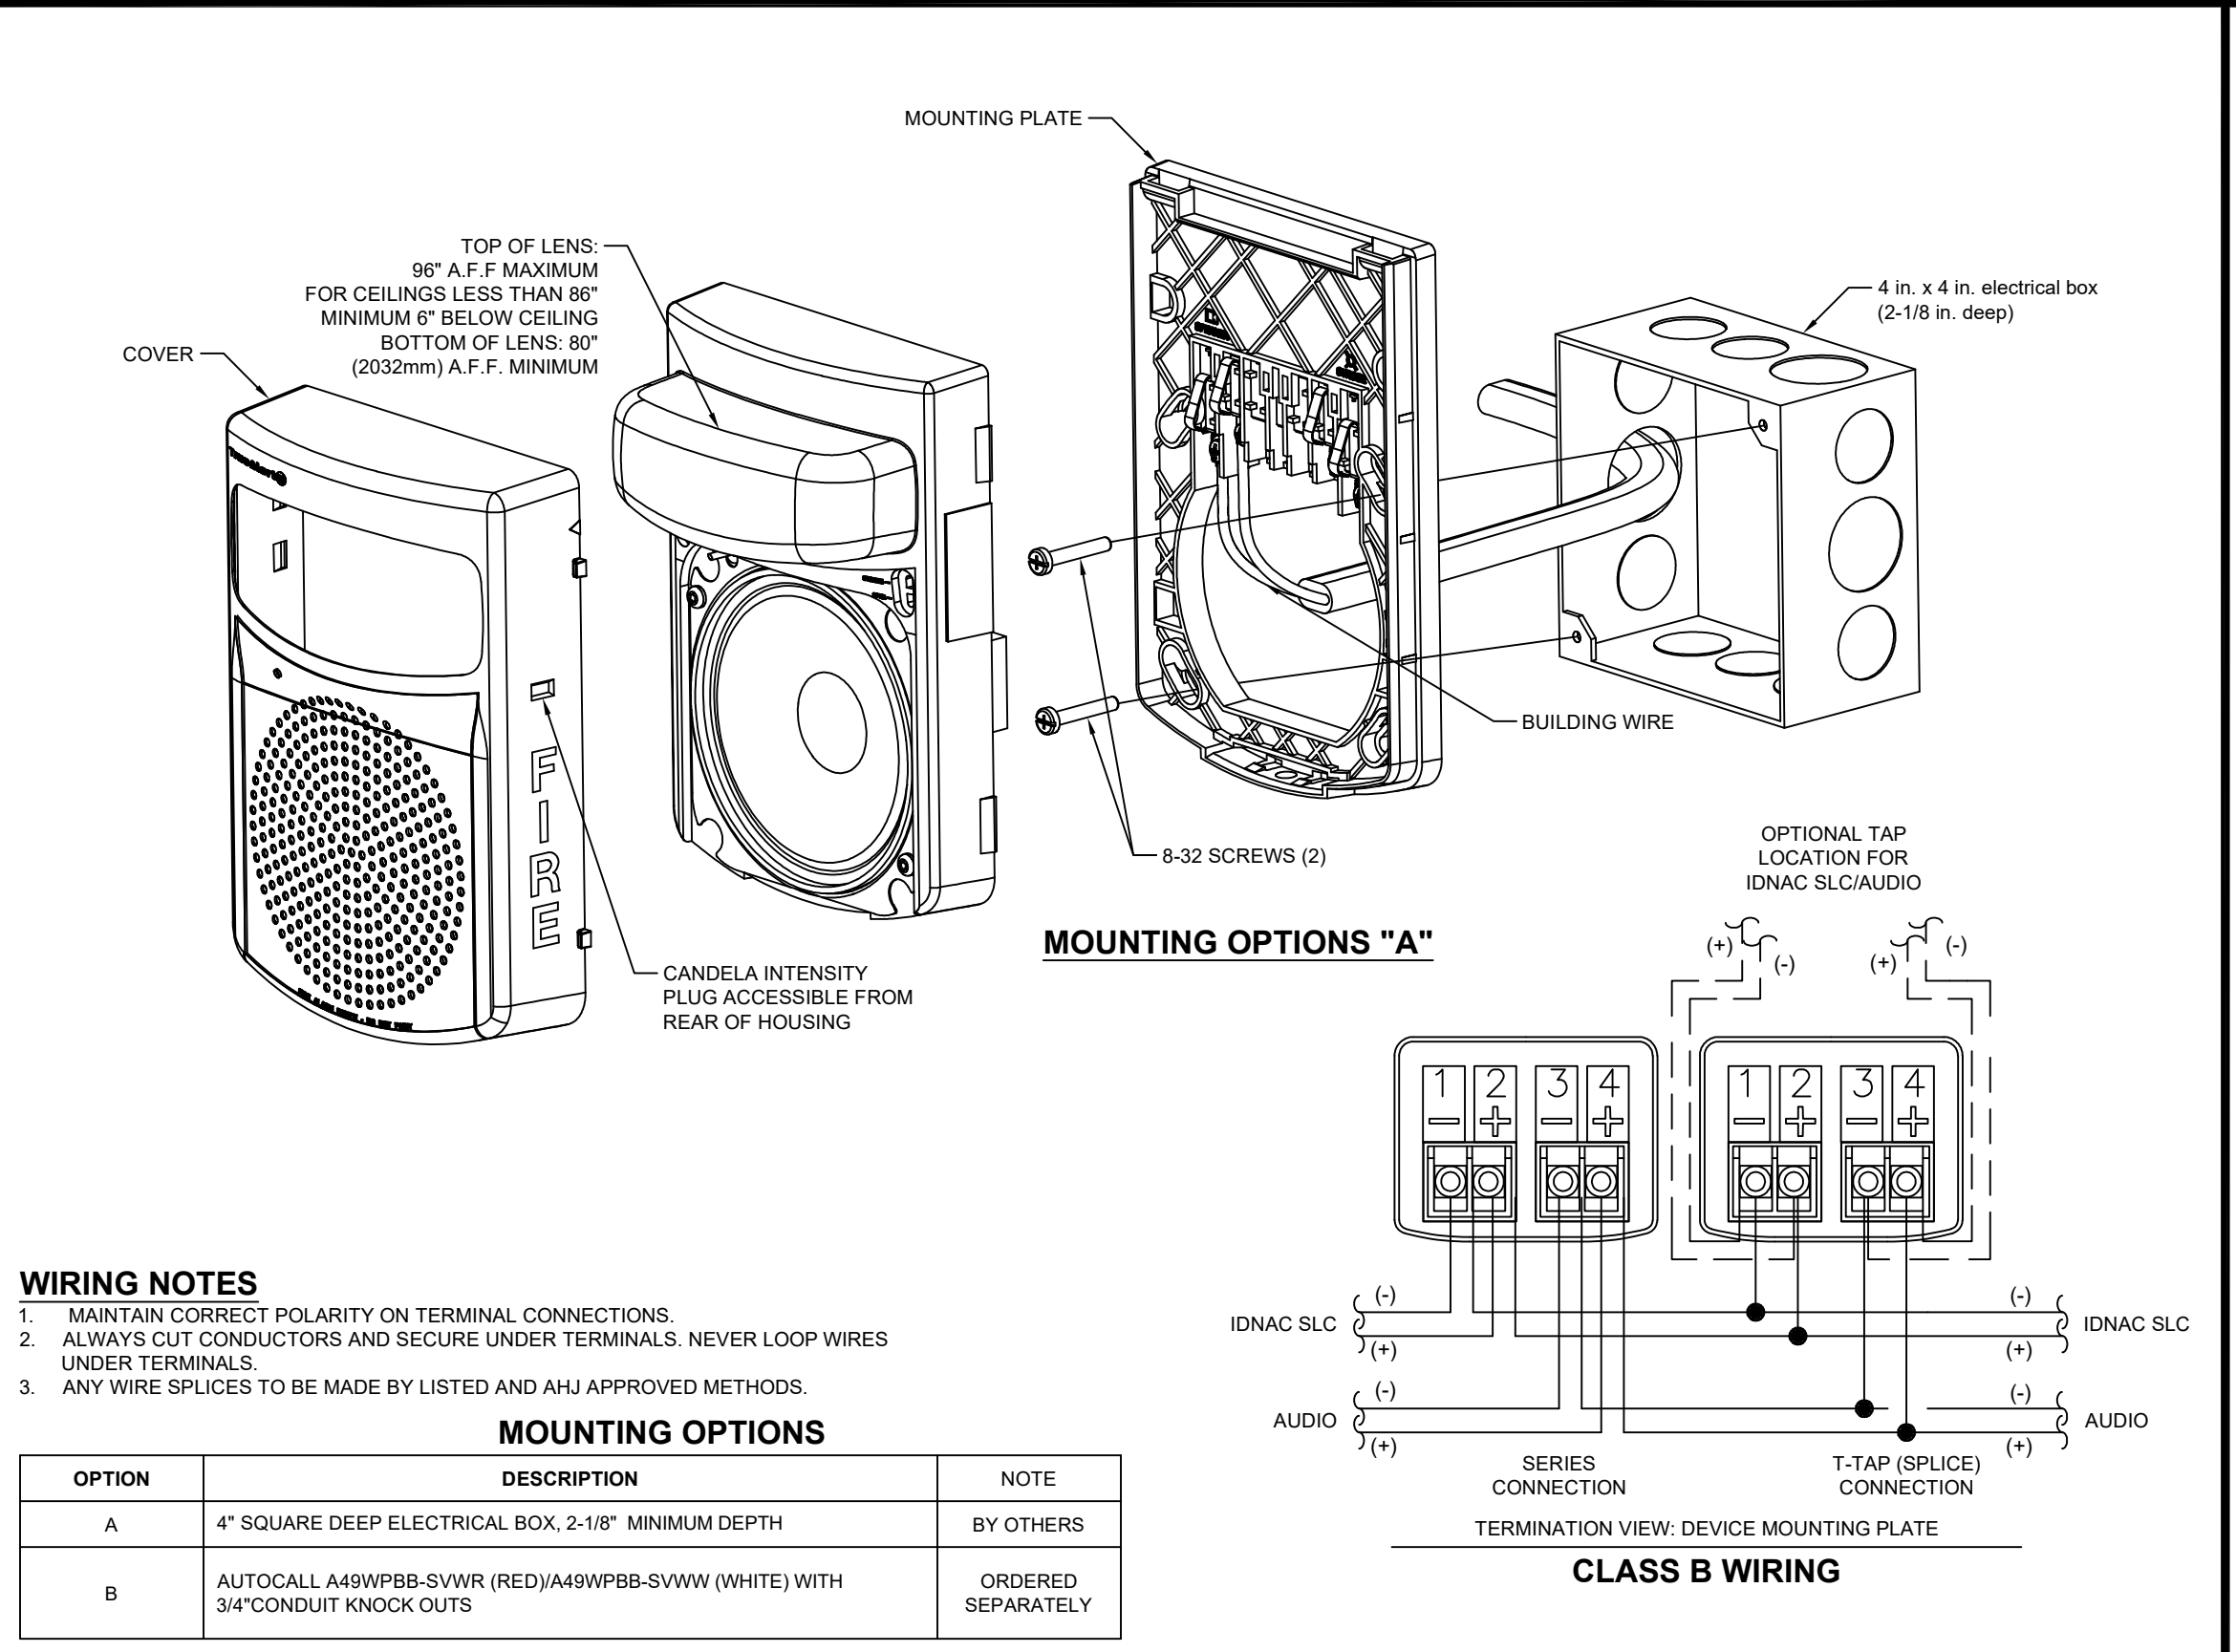
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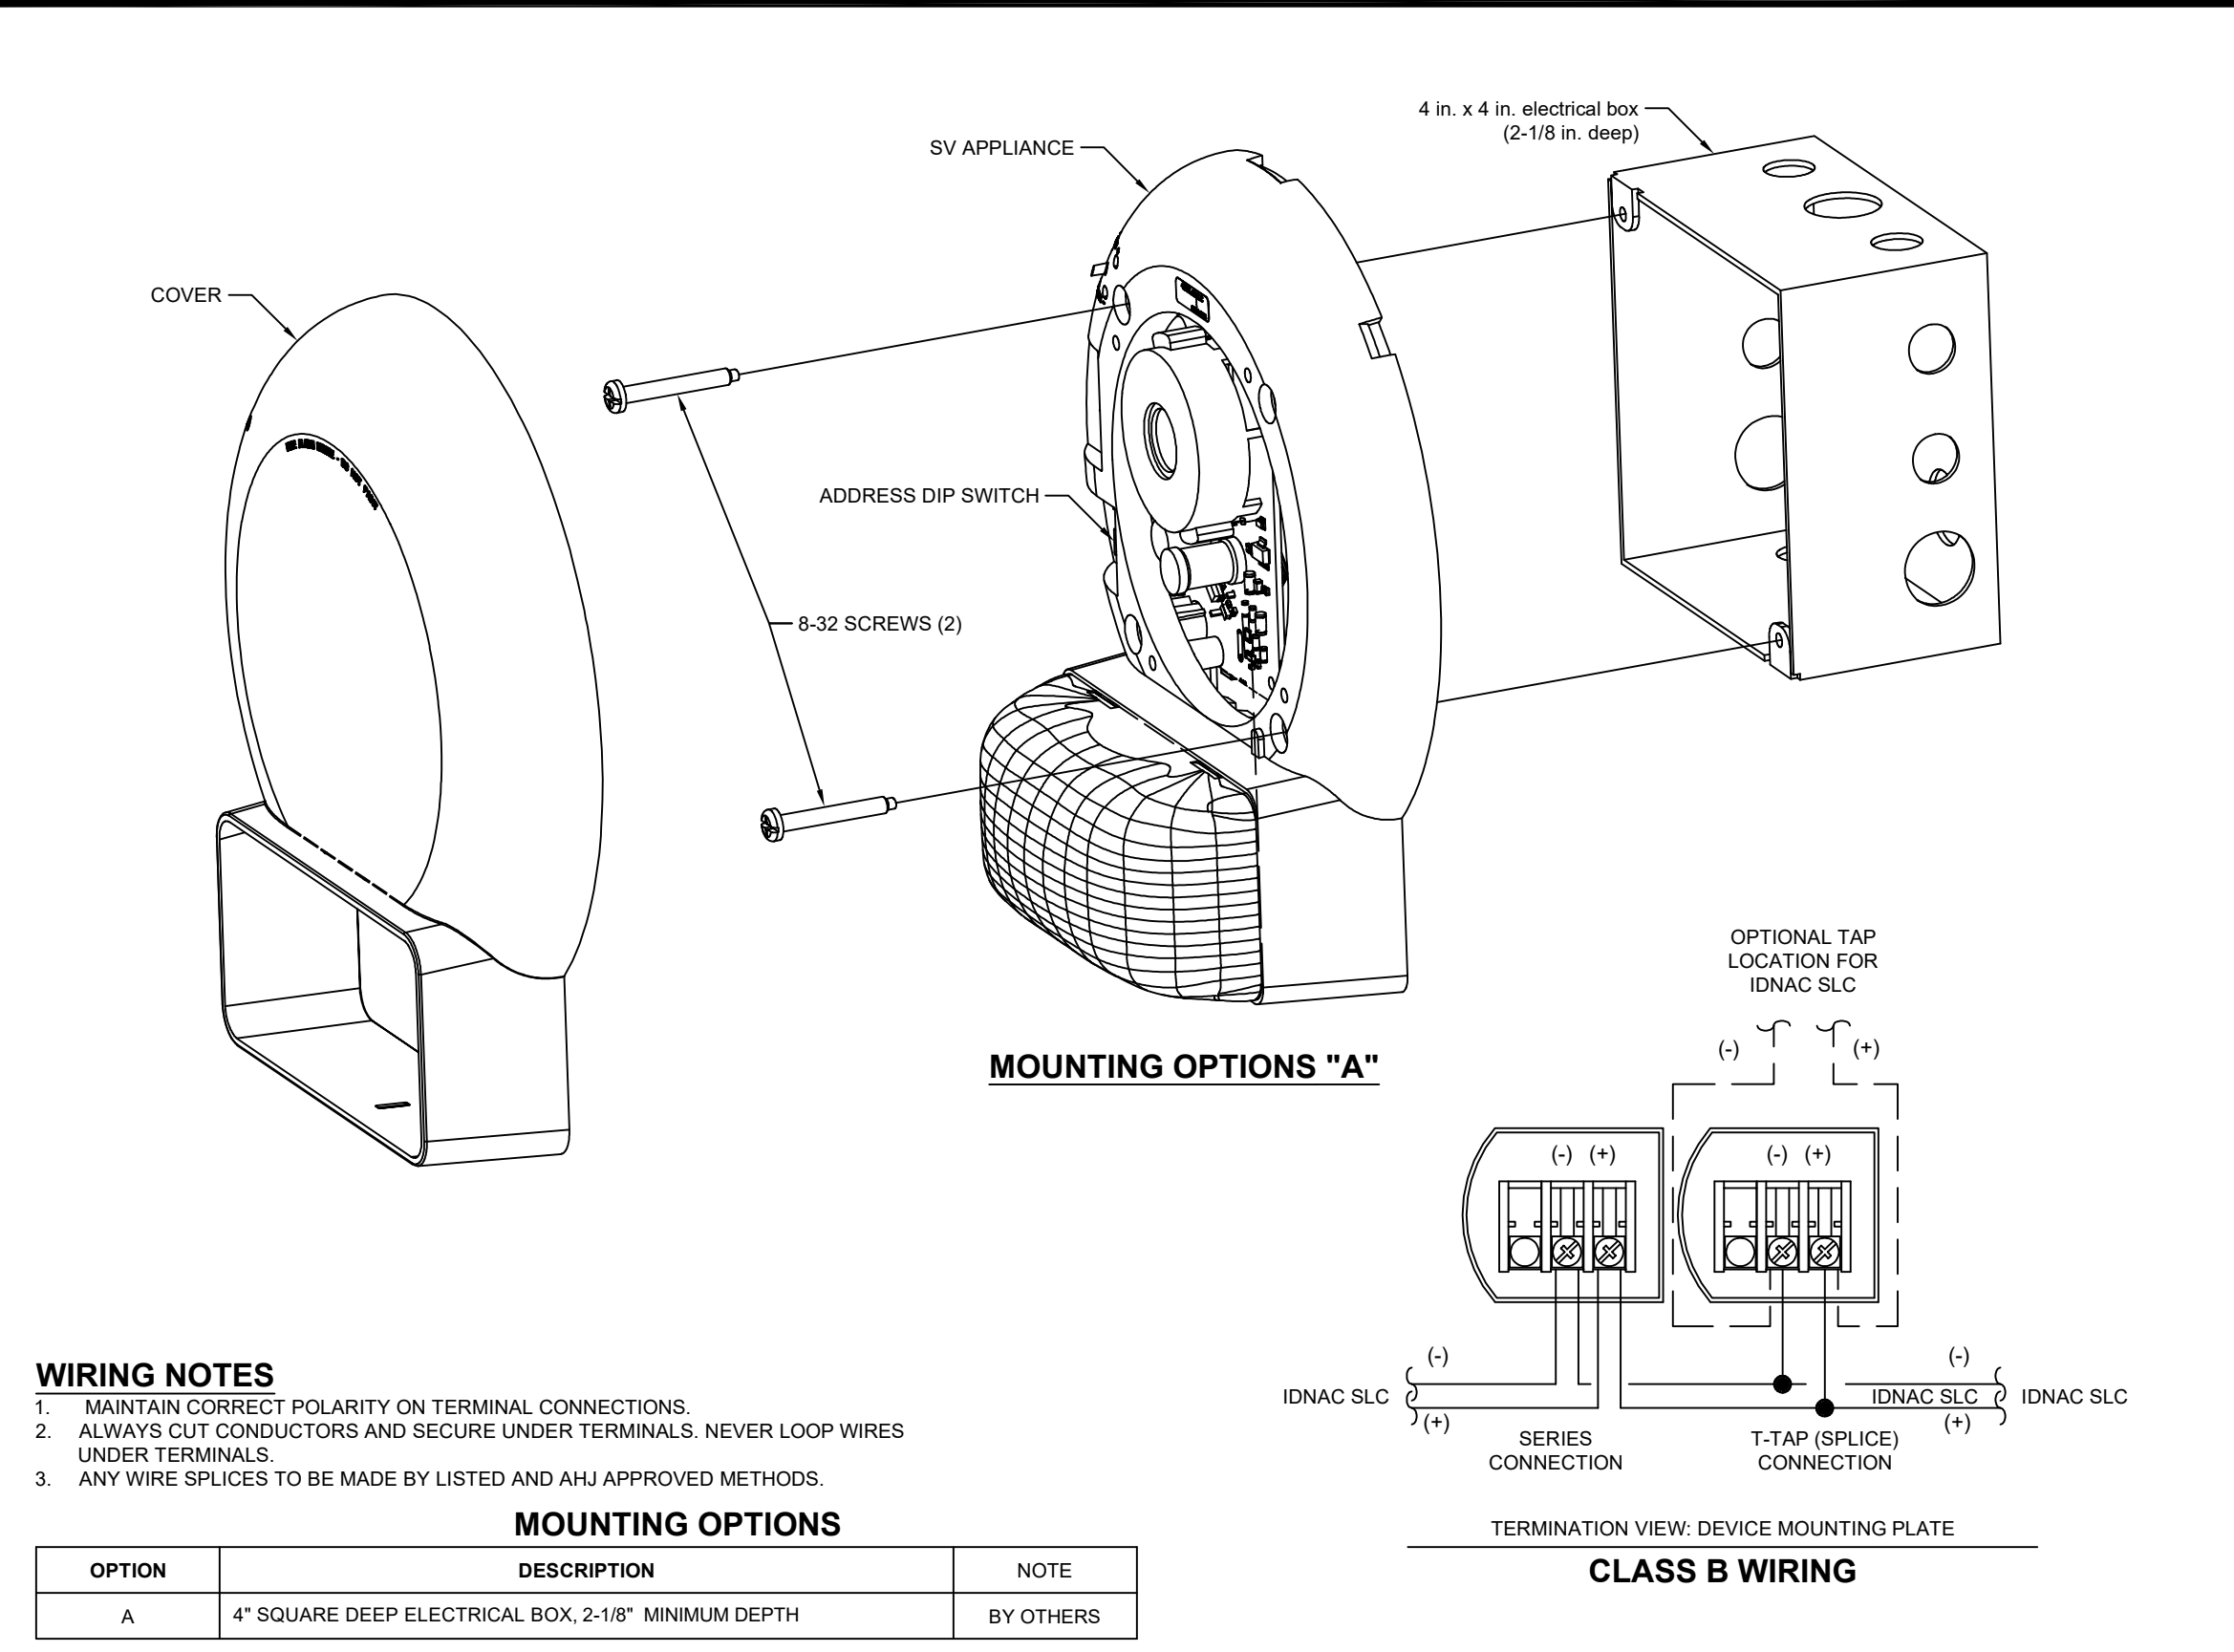
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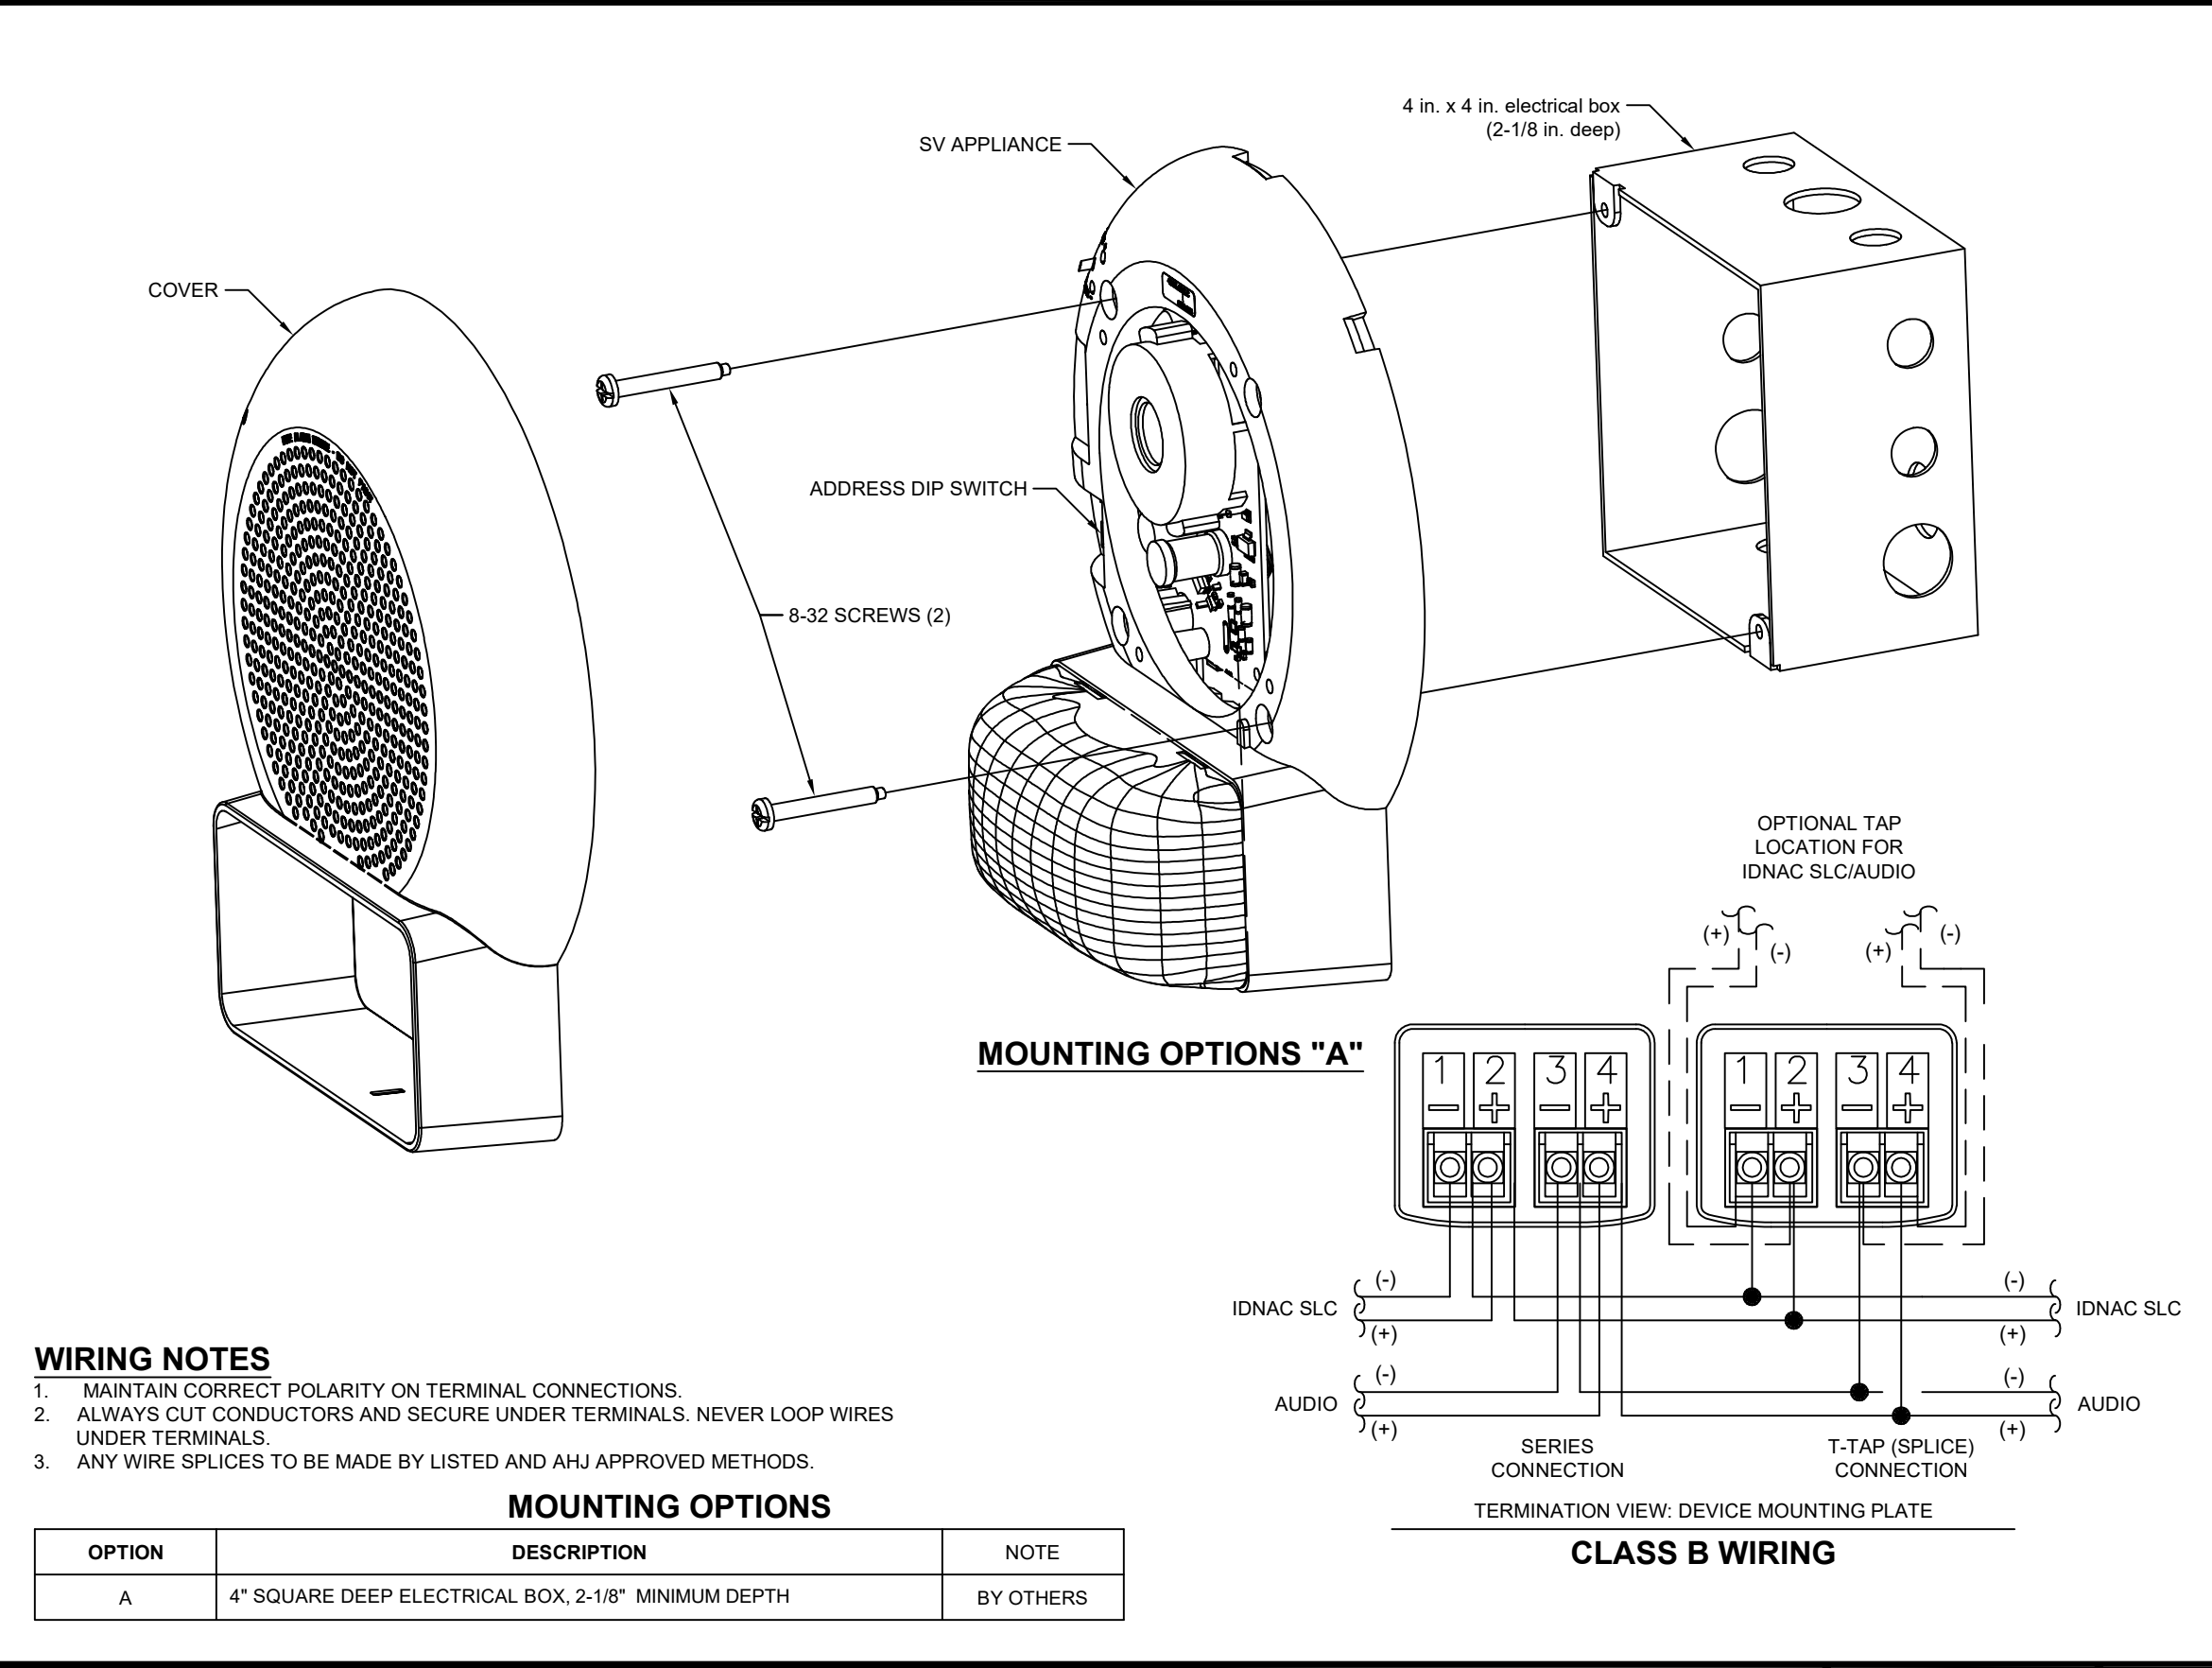
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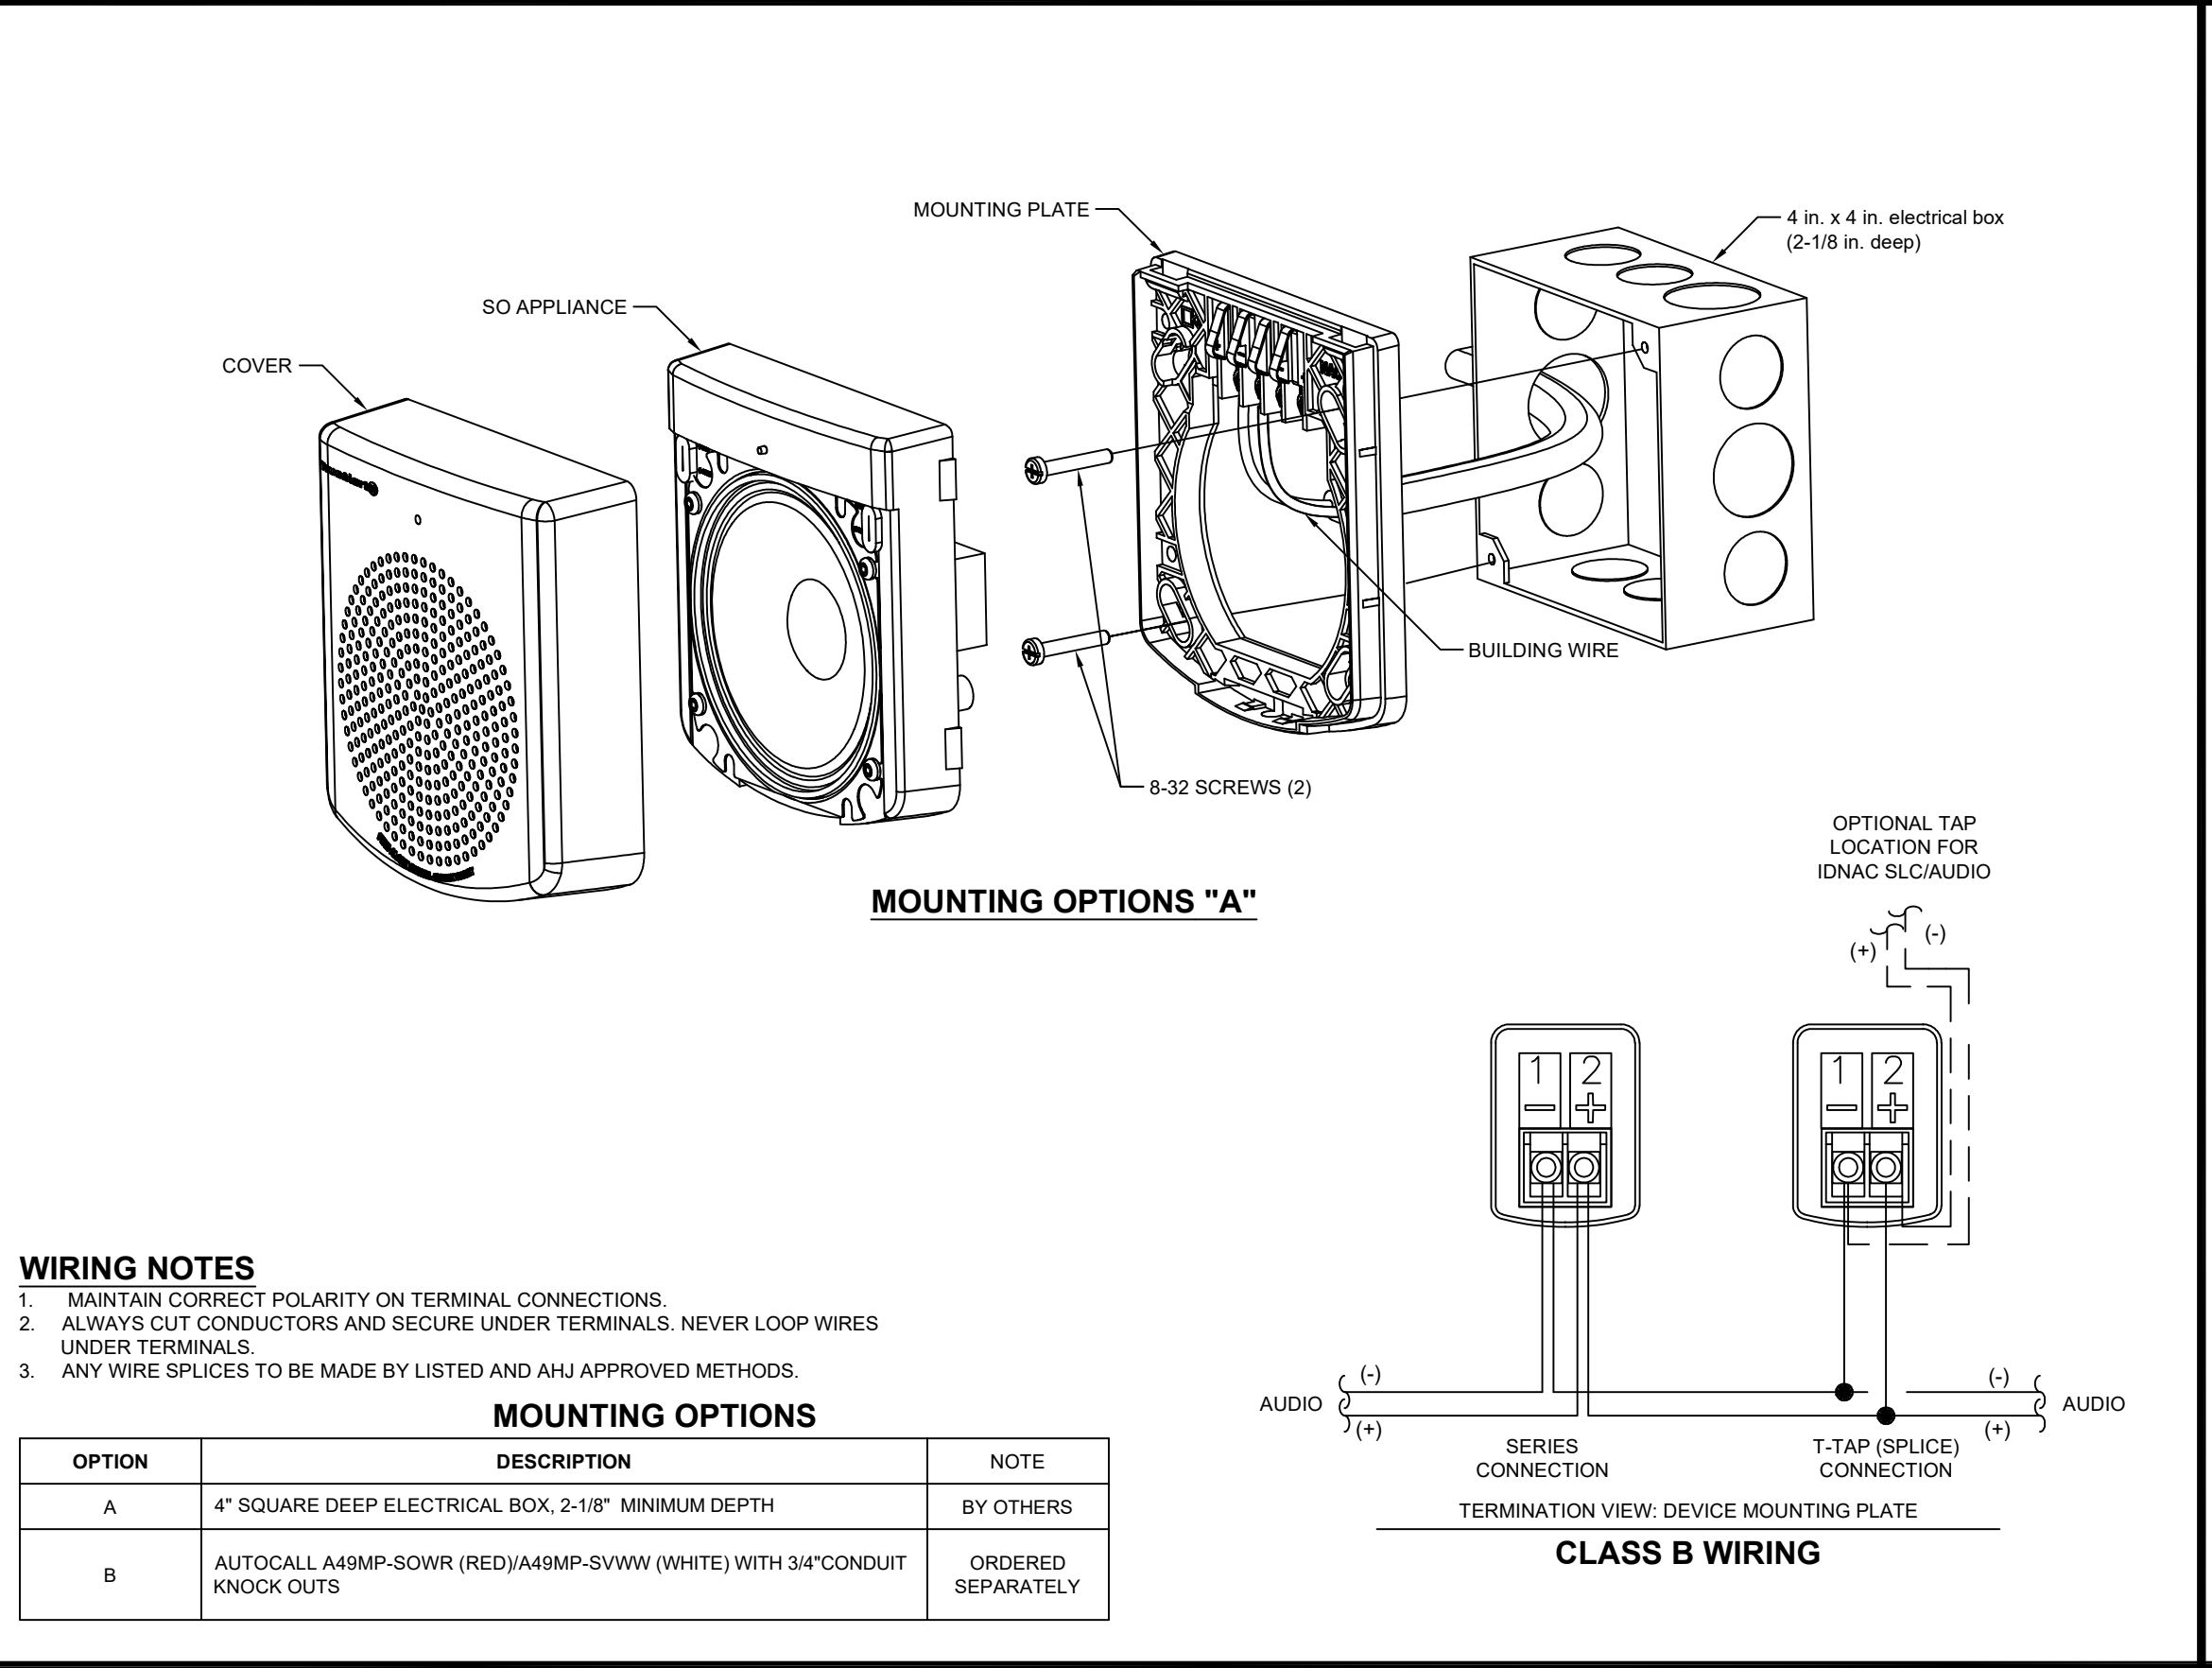
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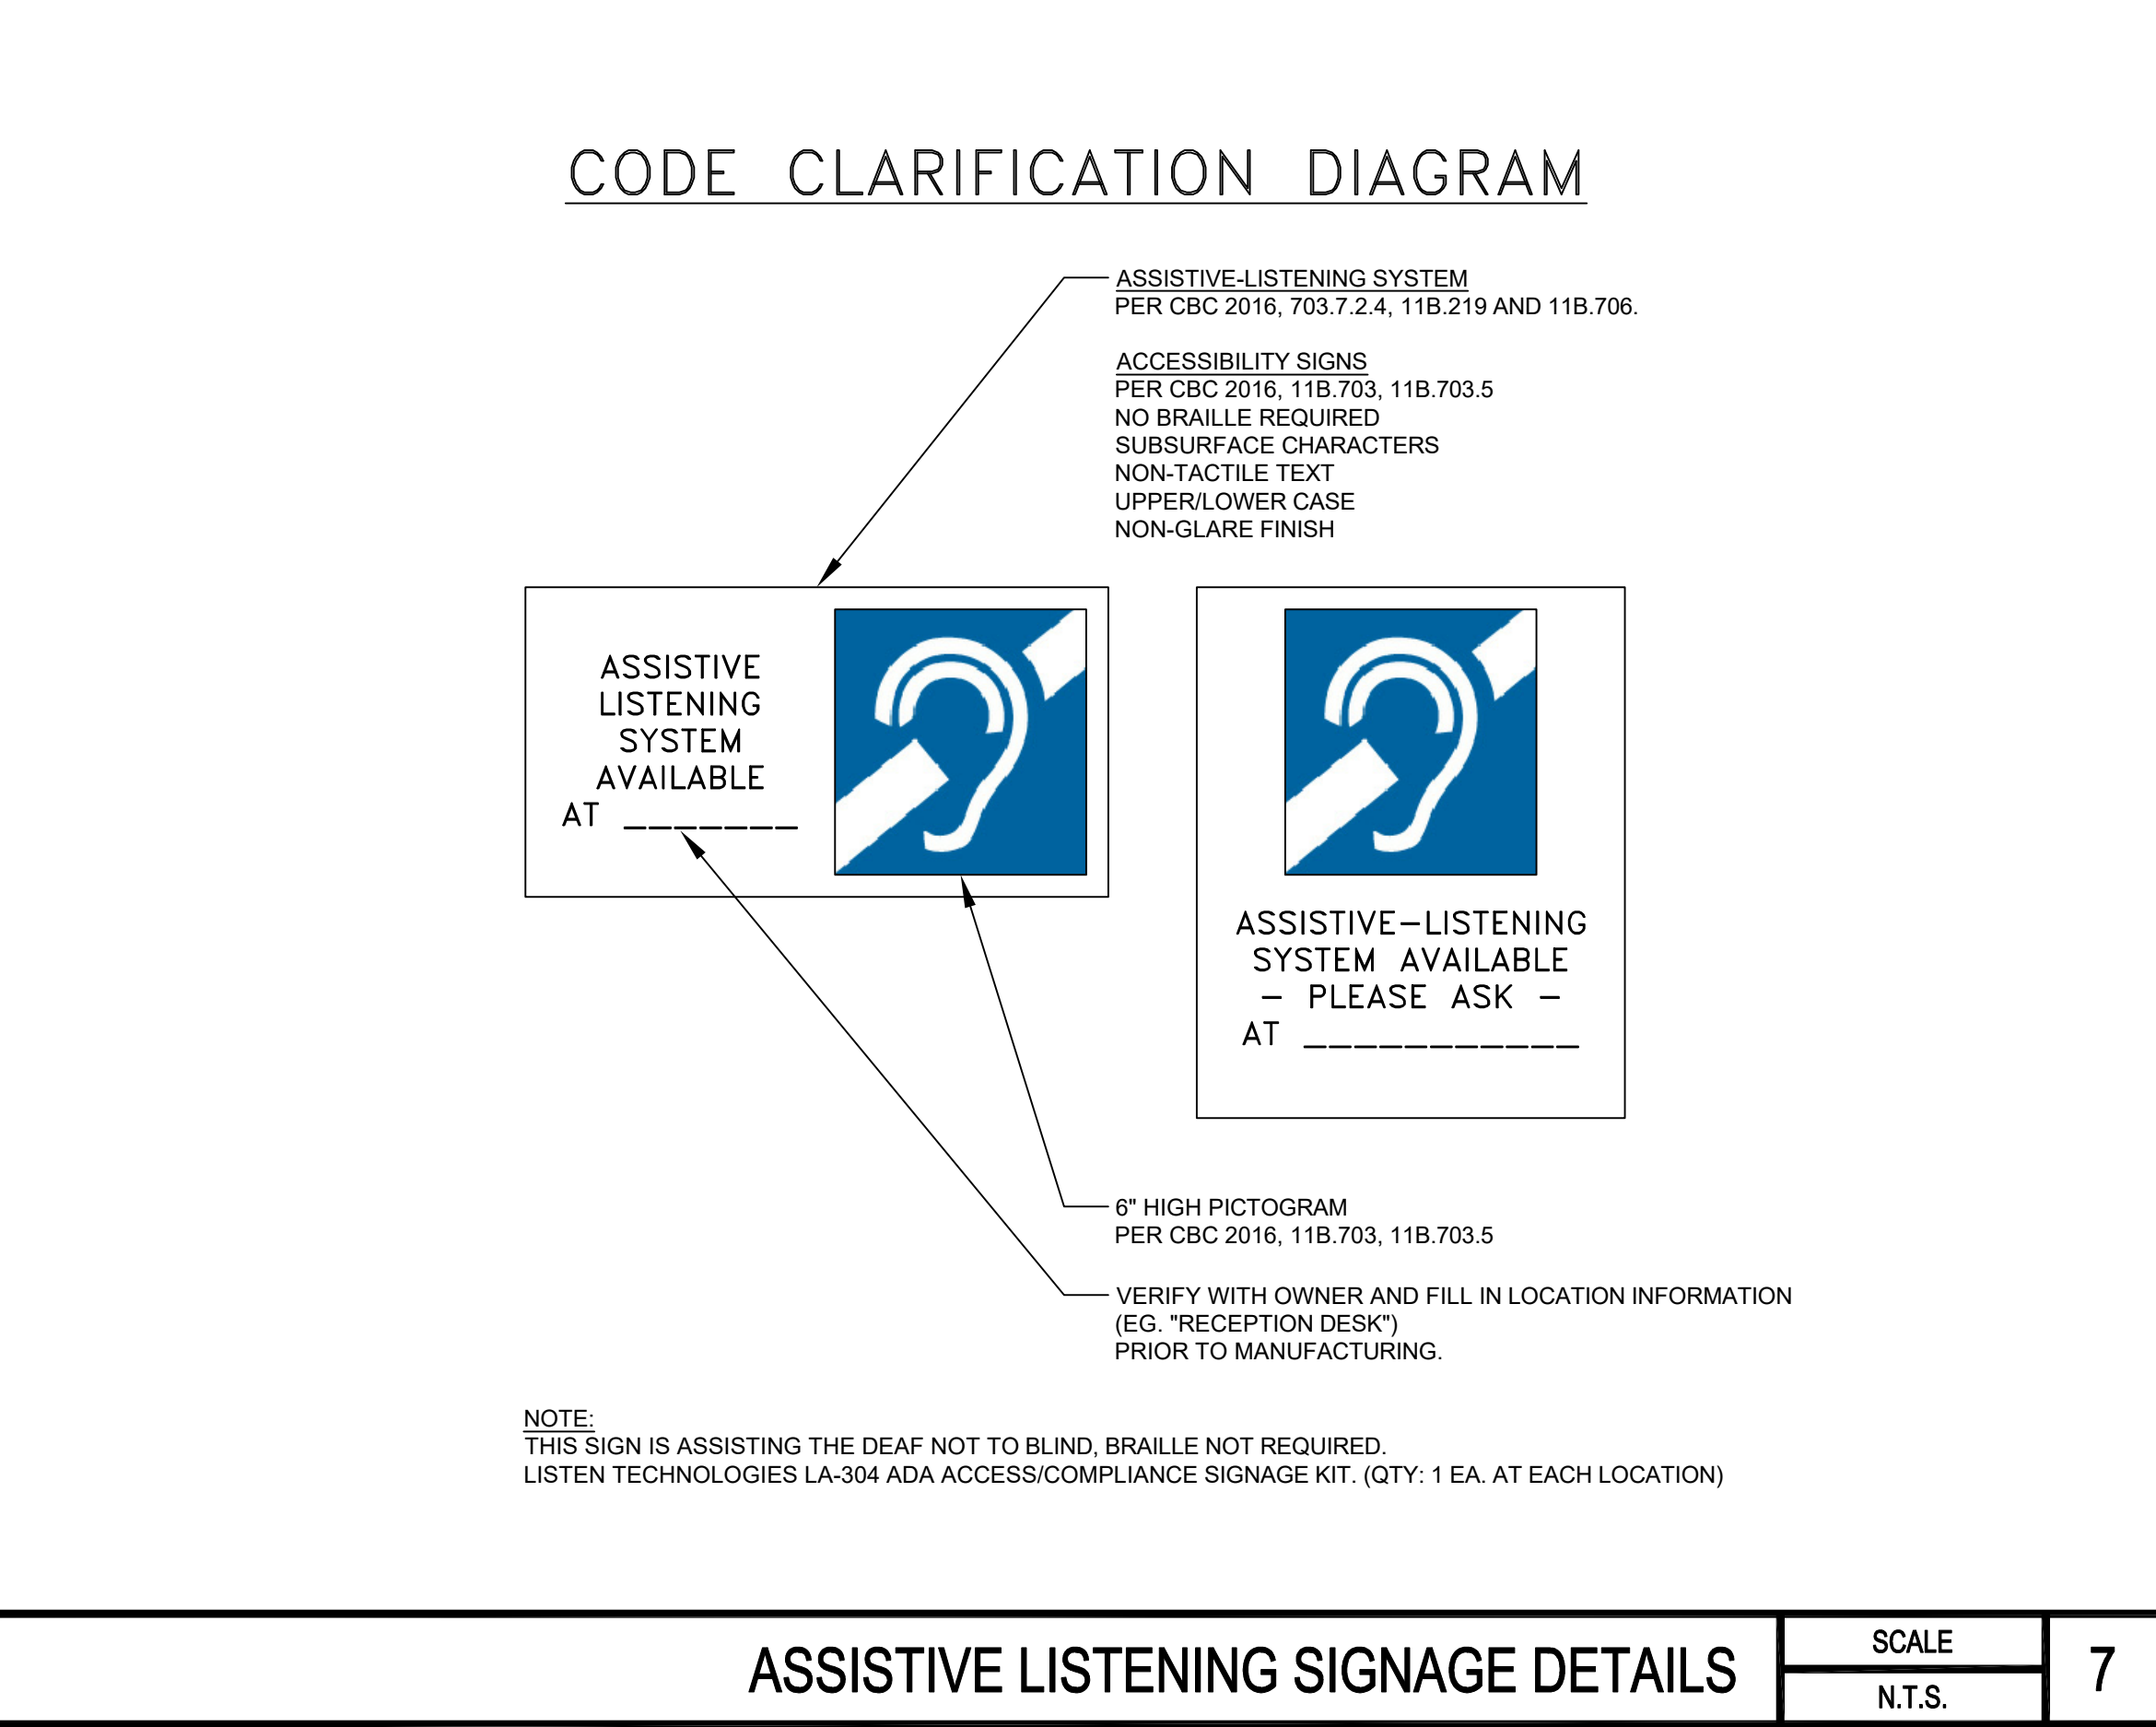
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FIRE ALARM CONTROL PANEL INSIDE SIGNAGE

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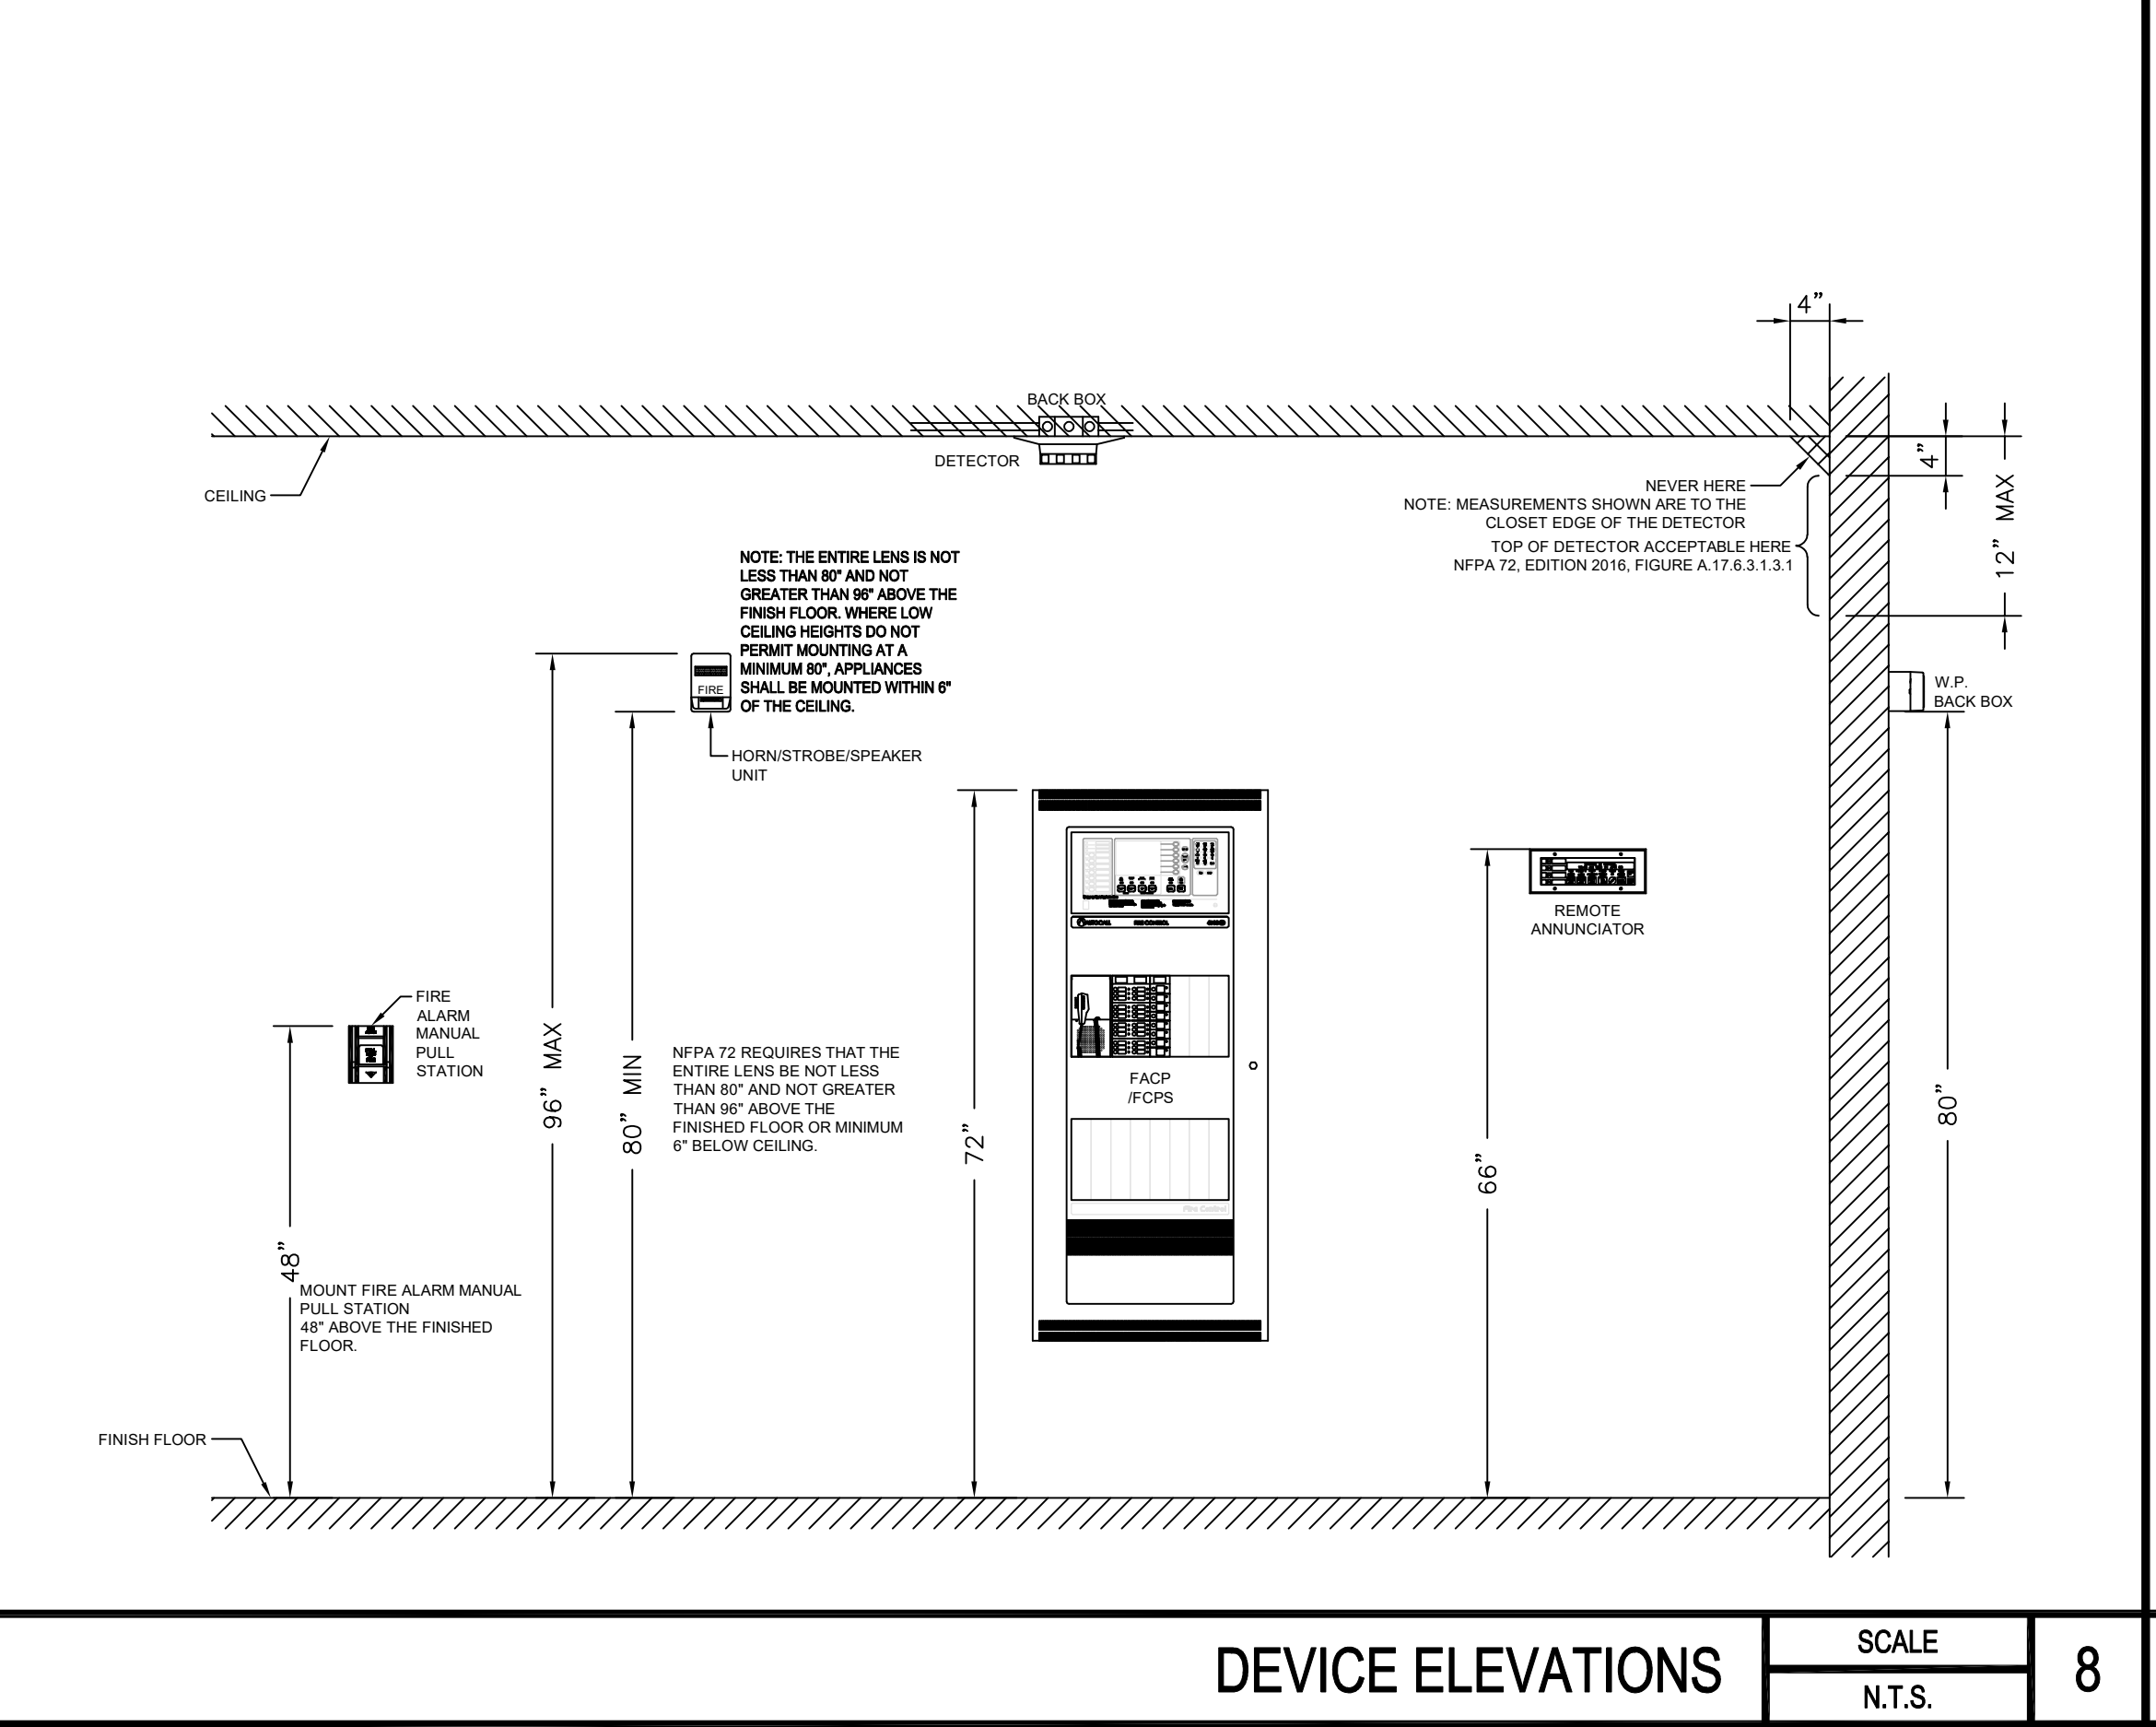
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ASSISTIVE LISTENING SIGNAGE DETAILS

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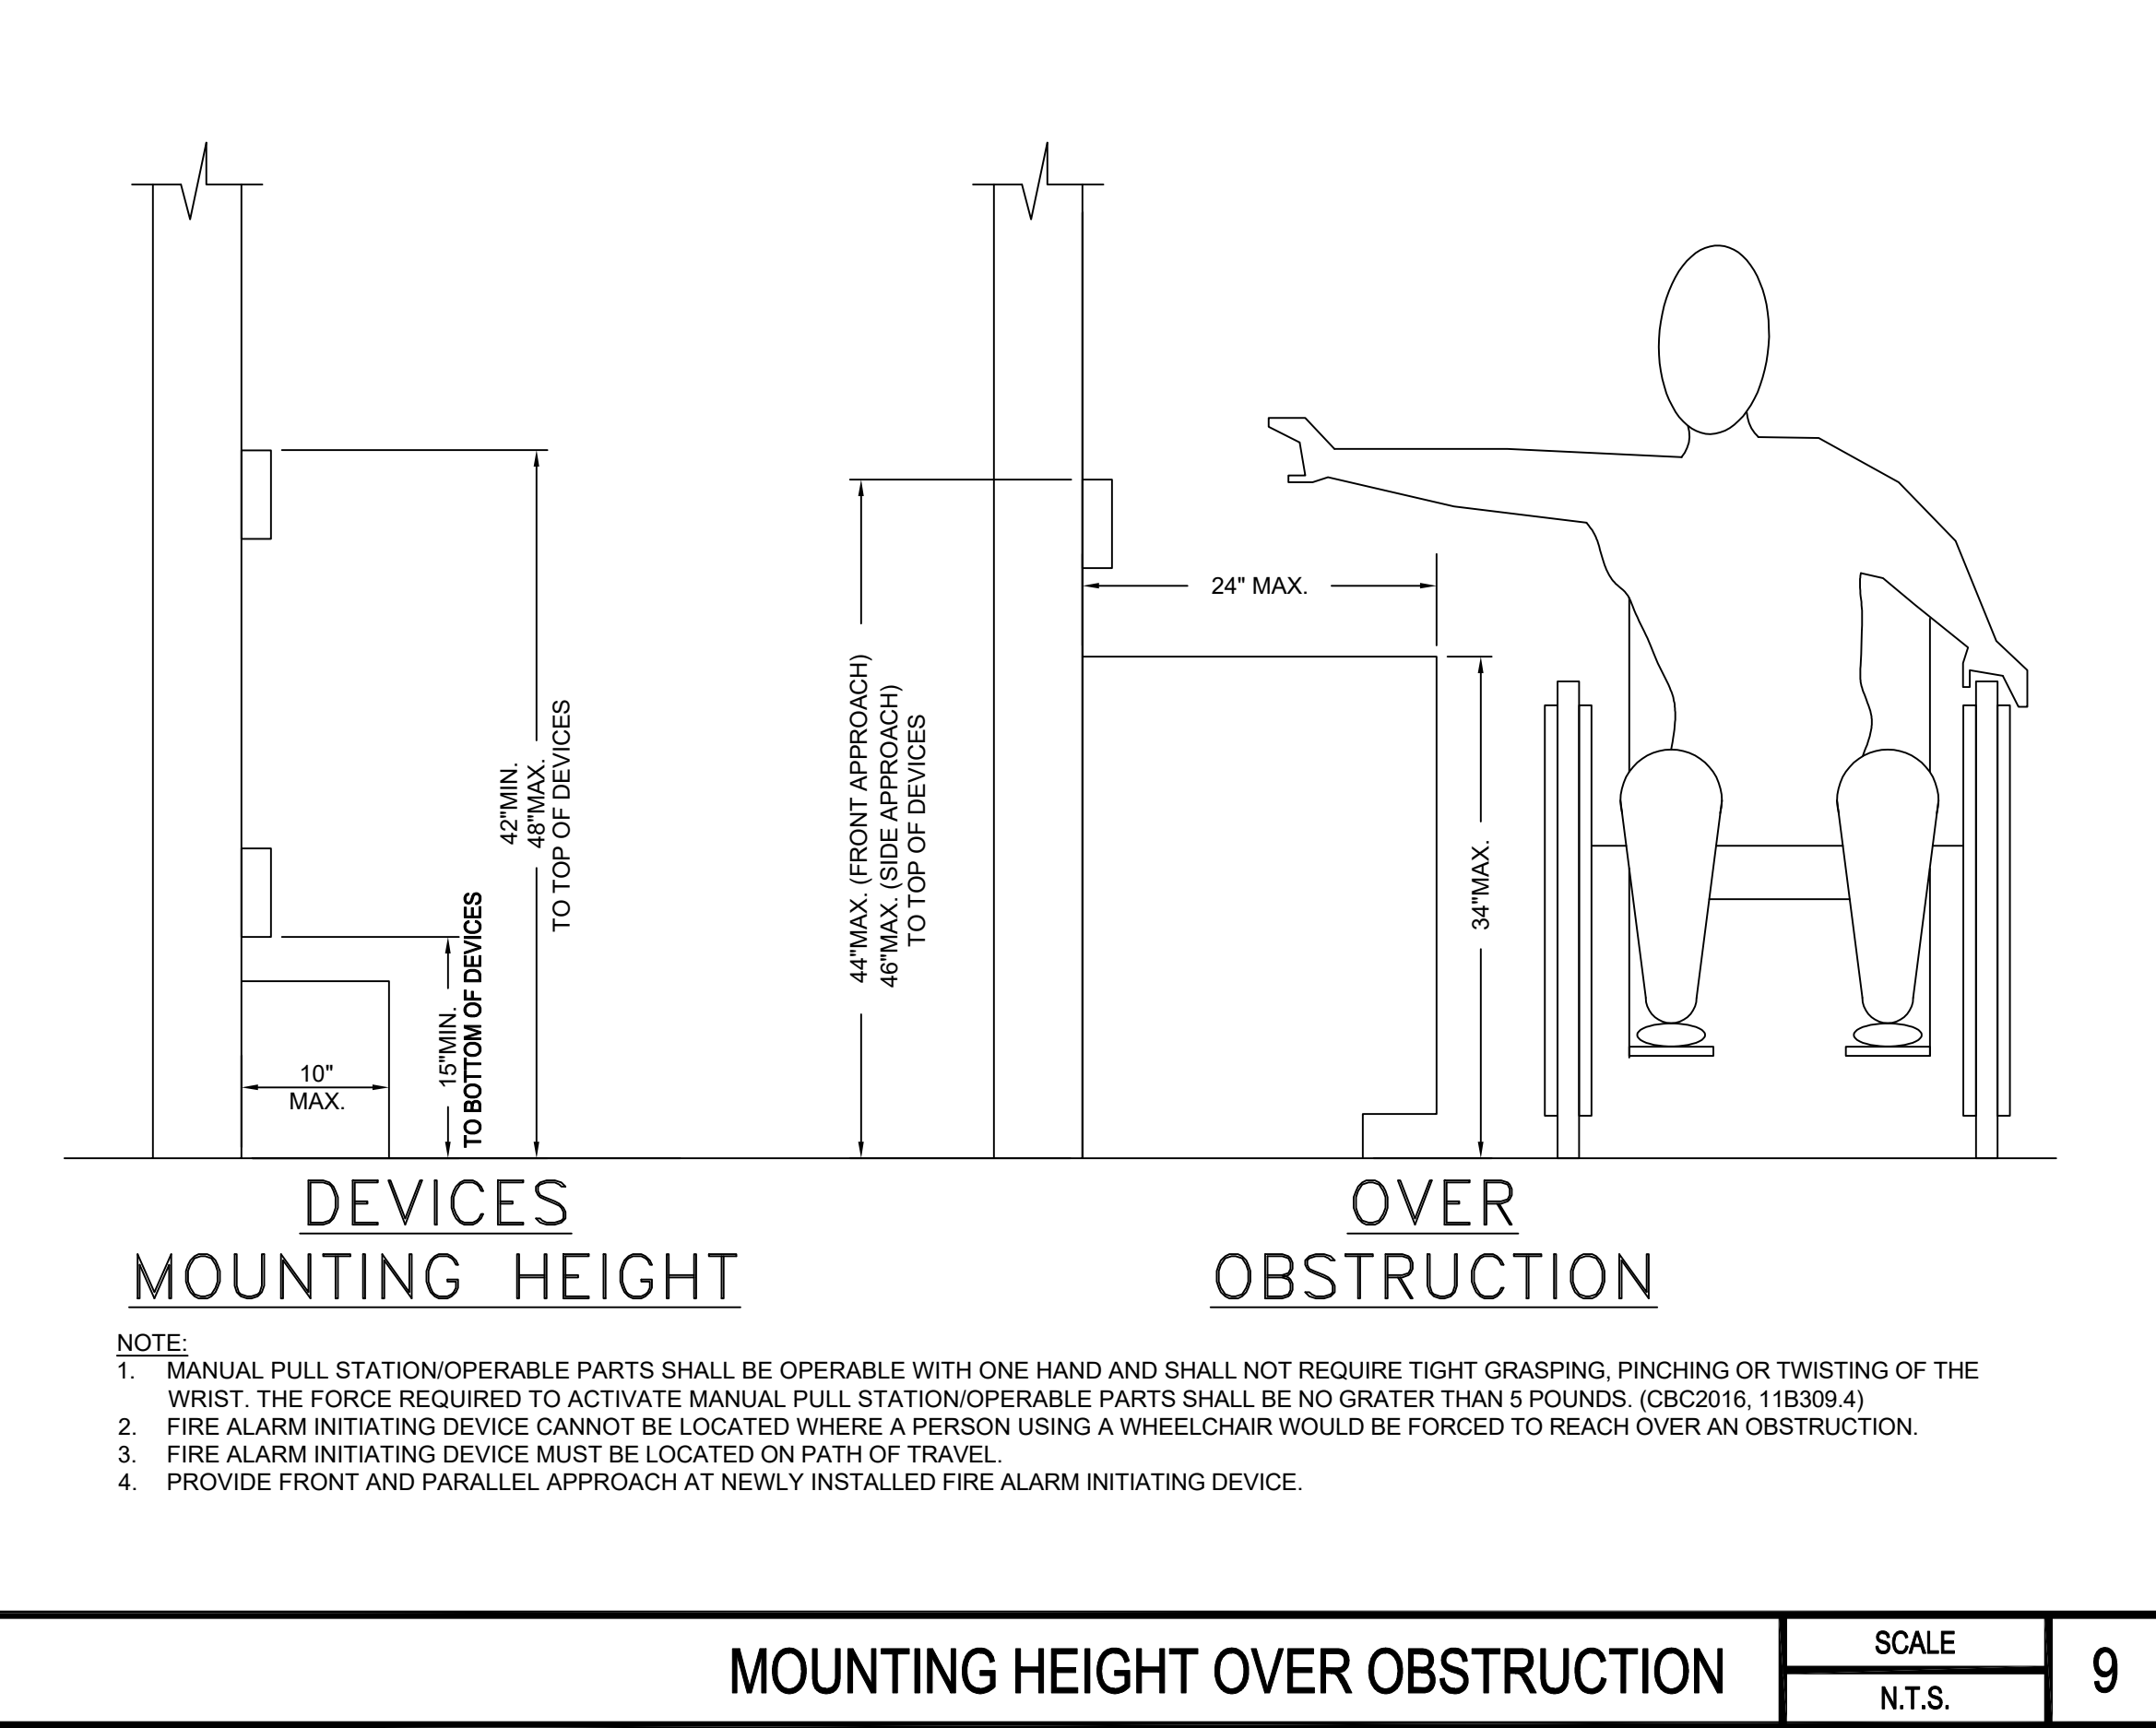
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DEVICE ELEVATIONS

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MOUNTING HEIGHT OVER OBSTRUCTION

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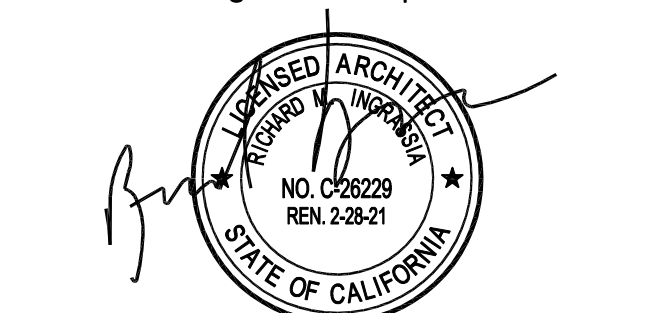
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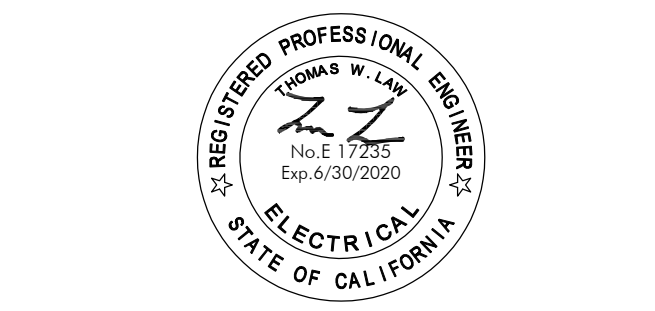
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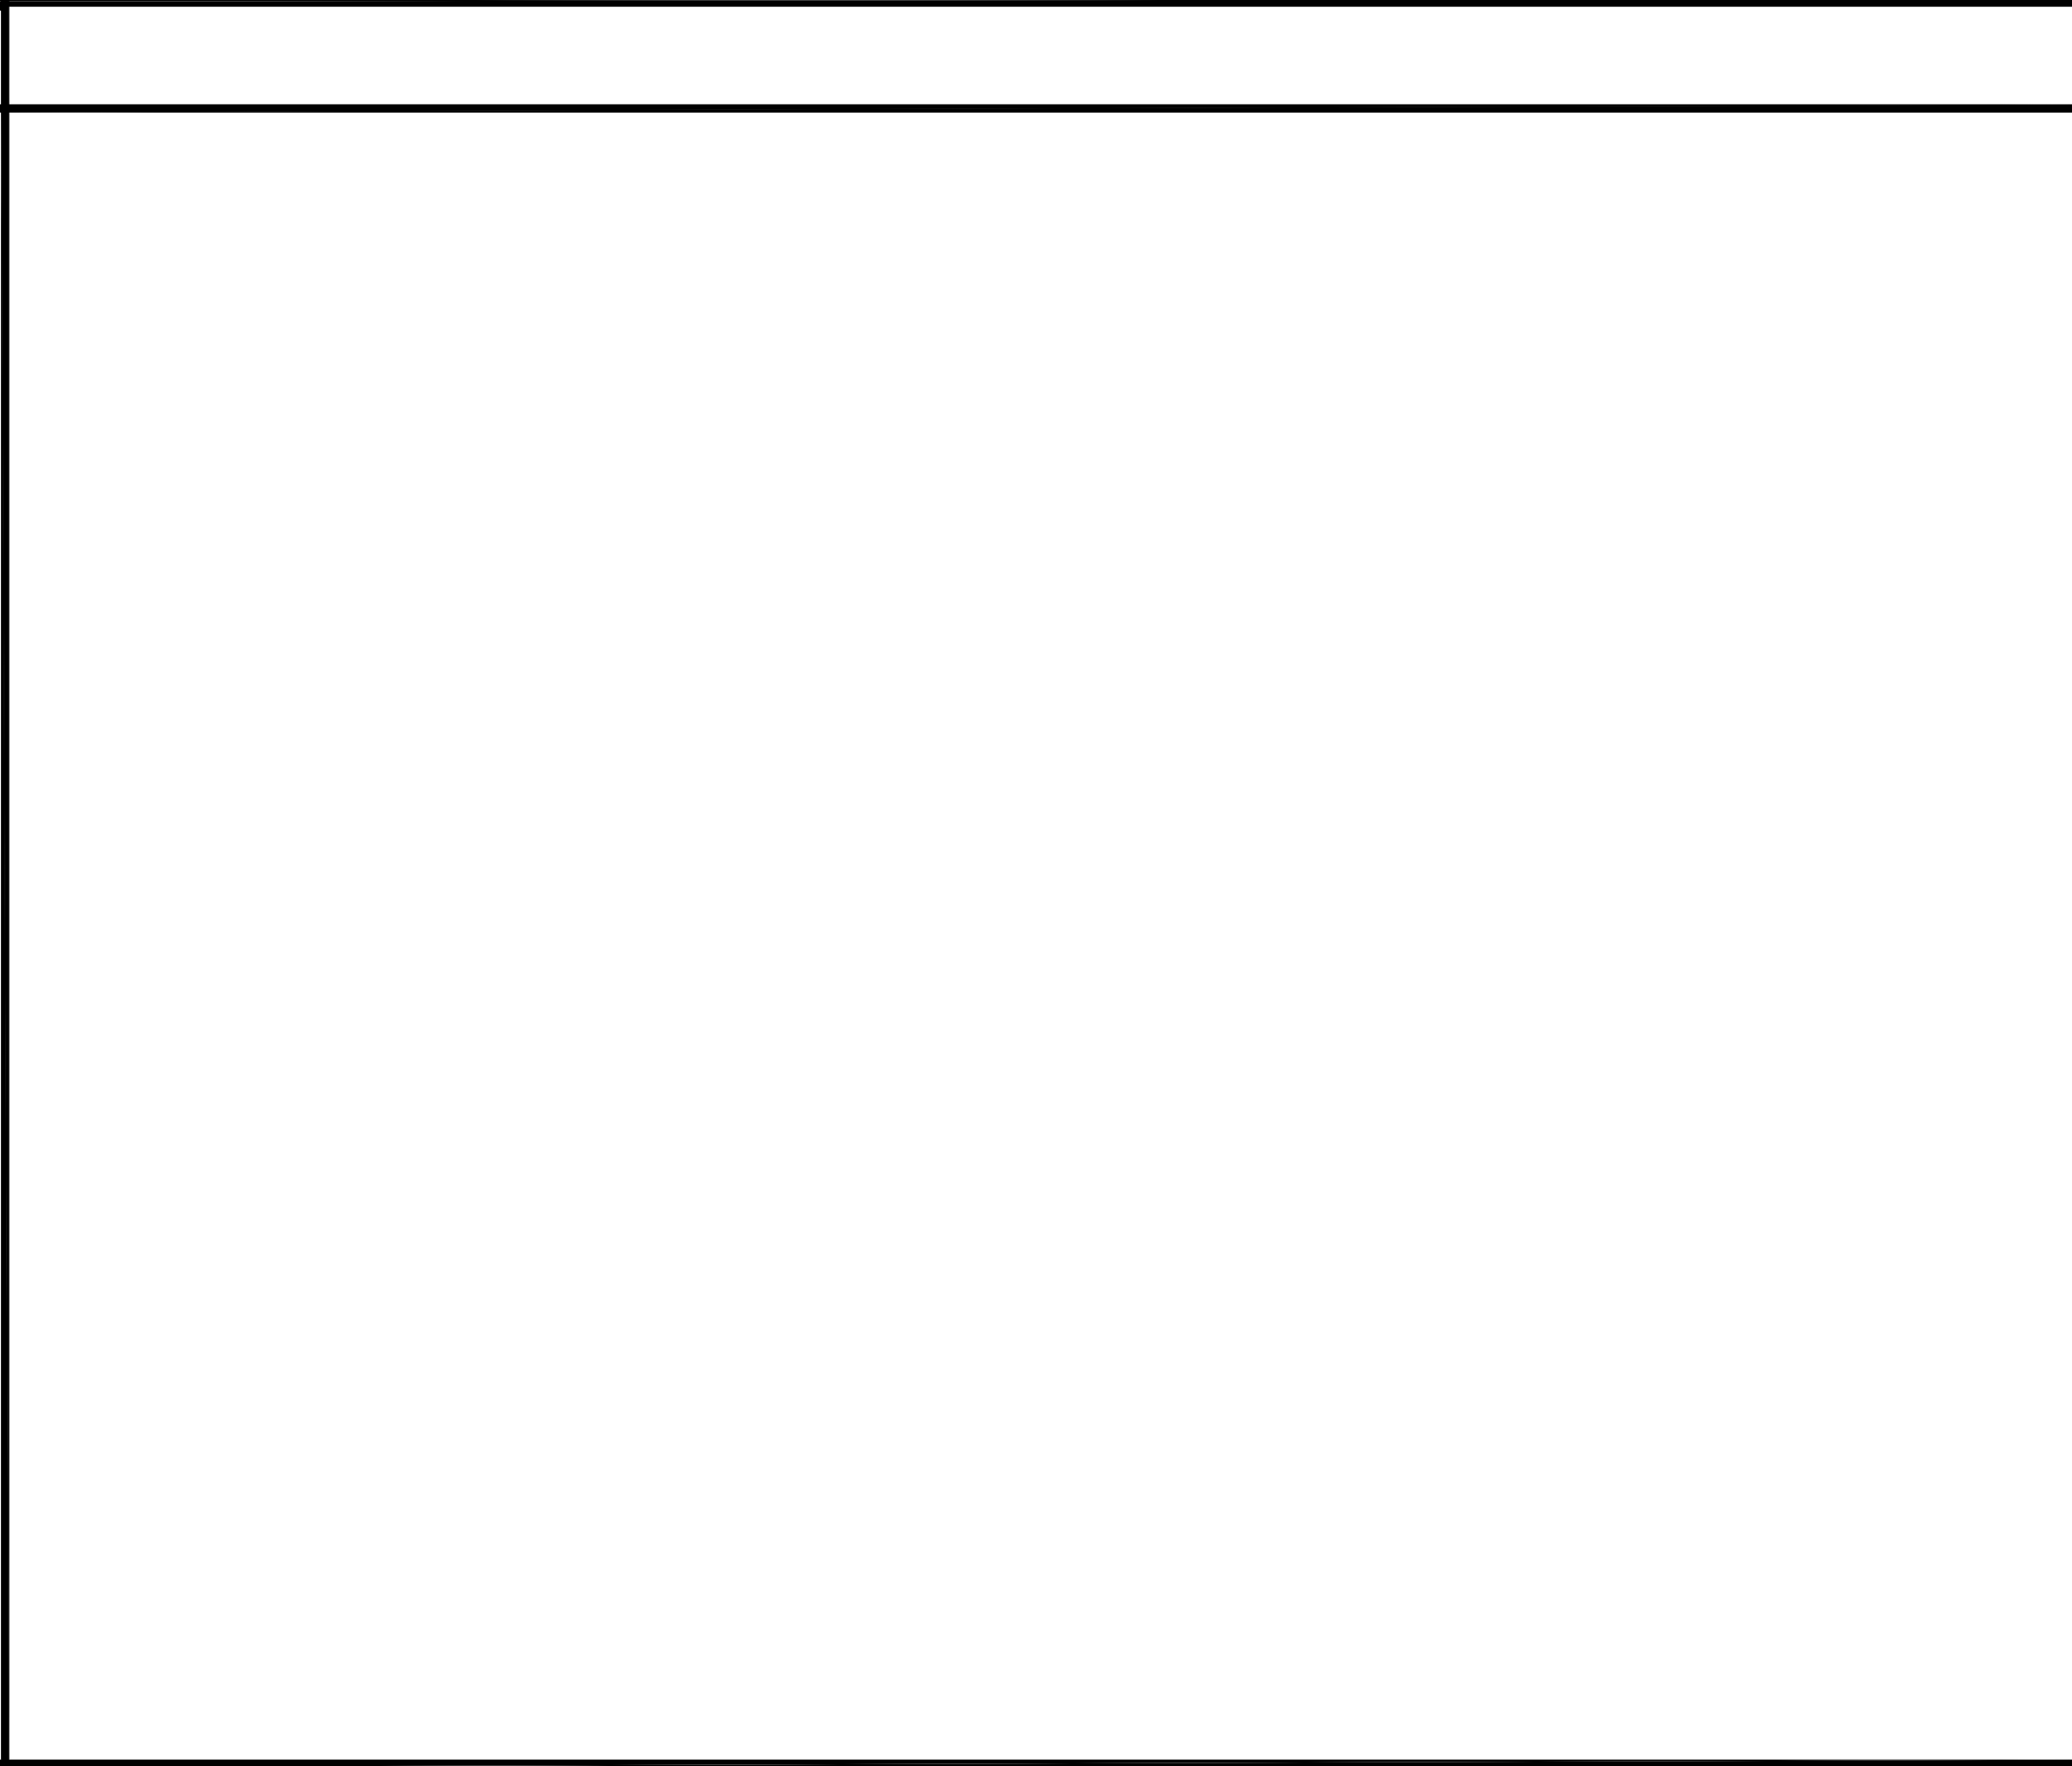
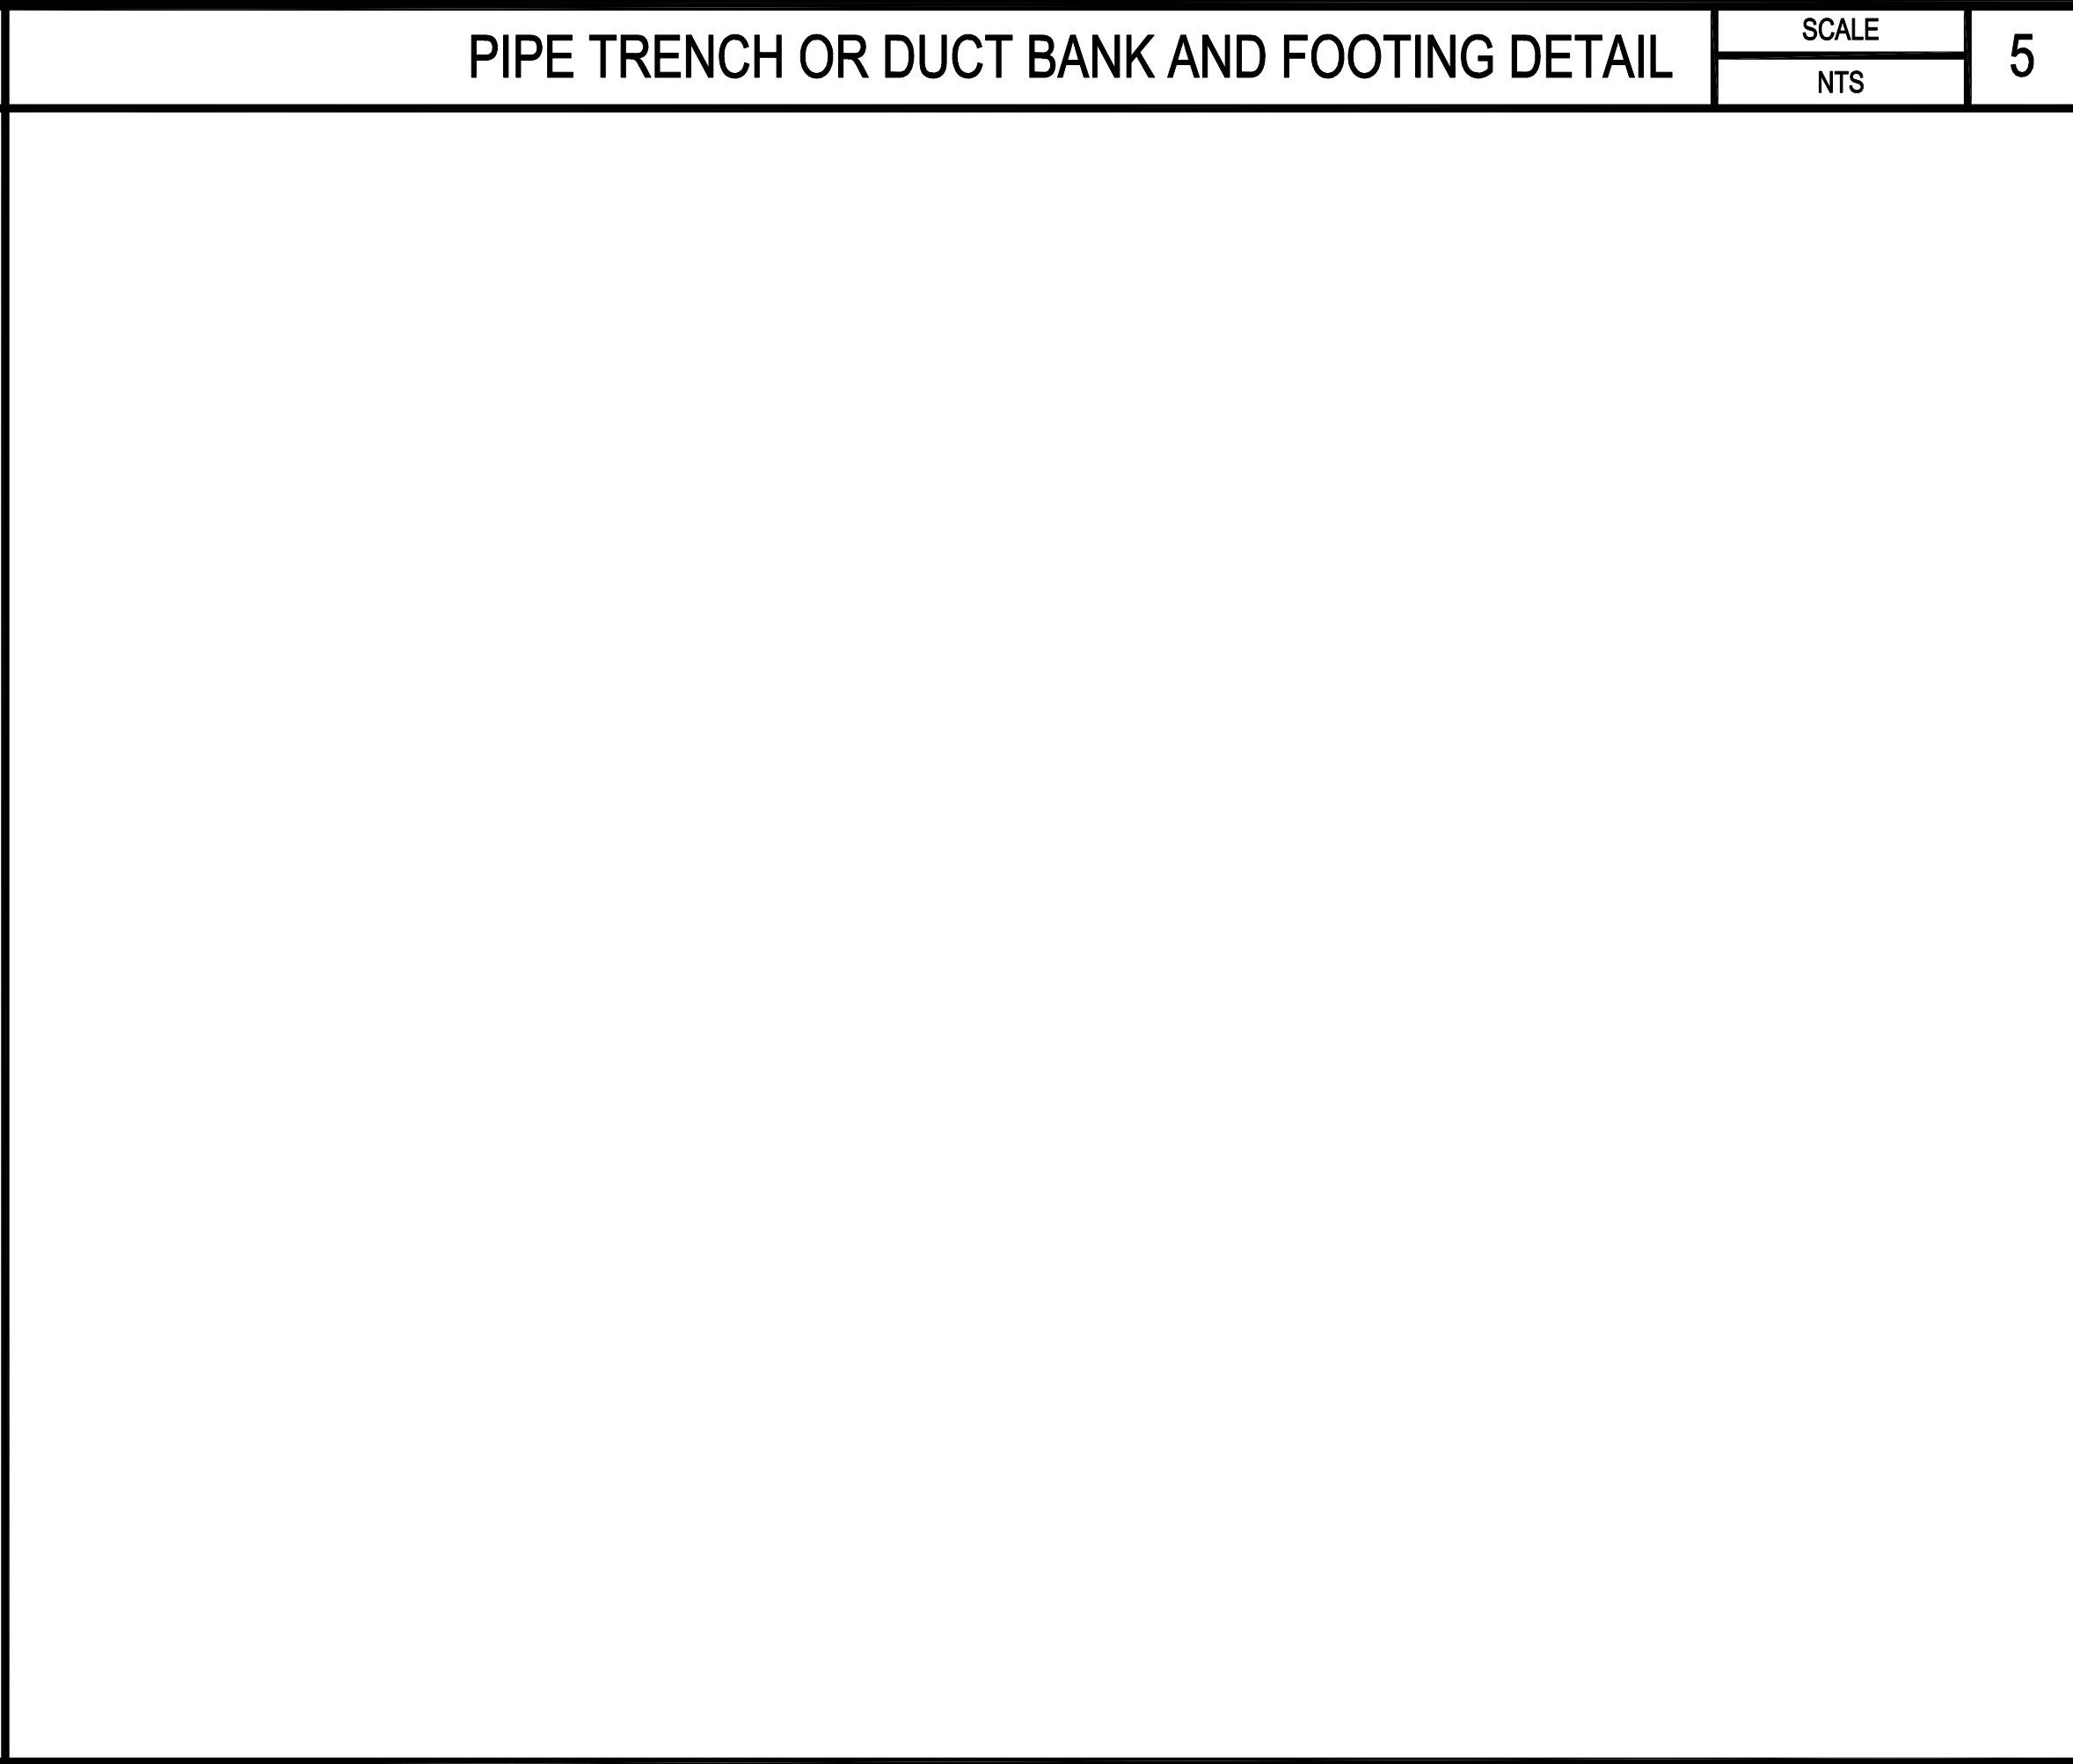
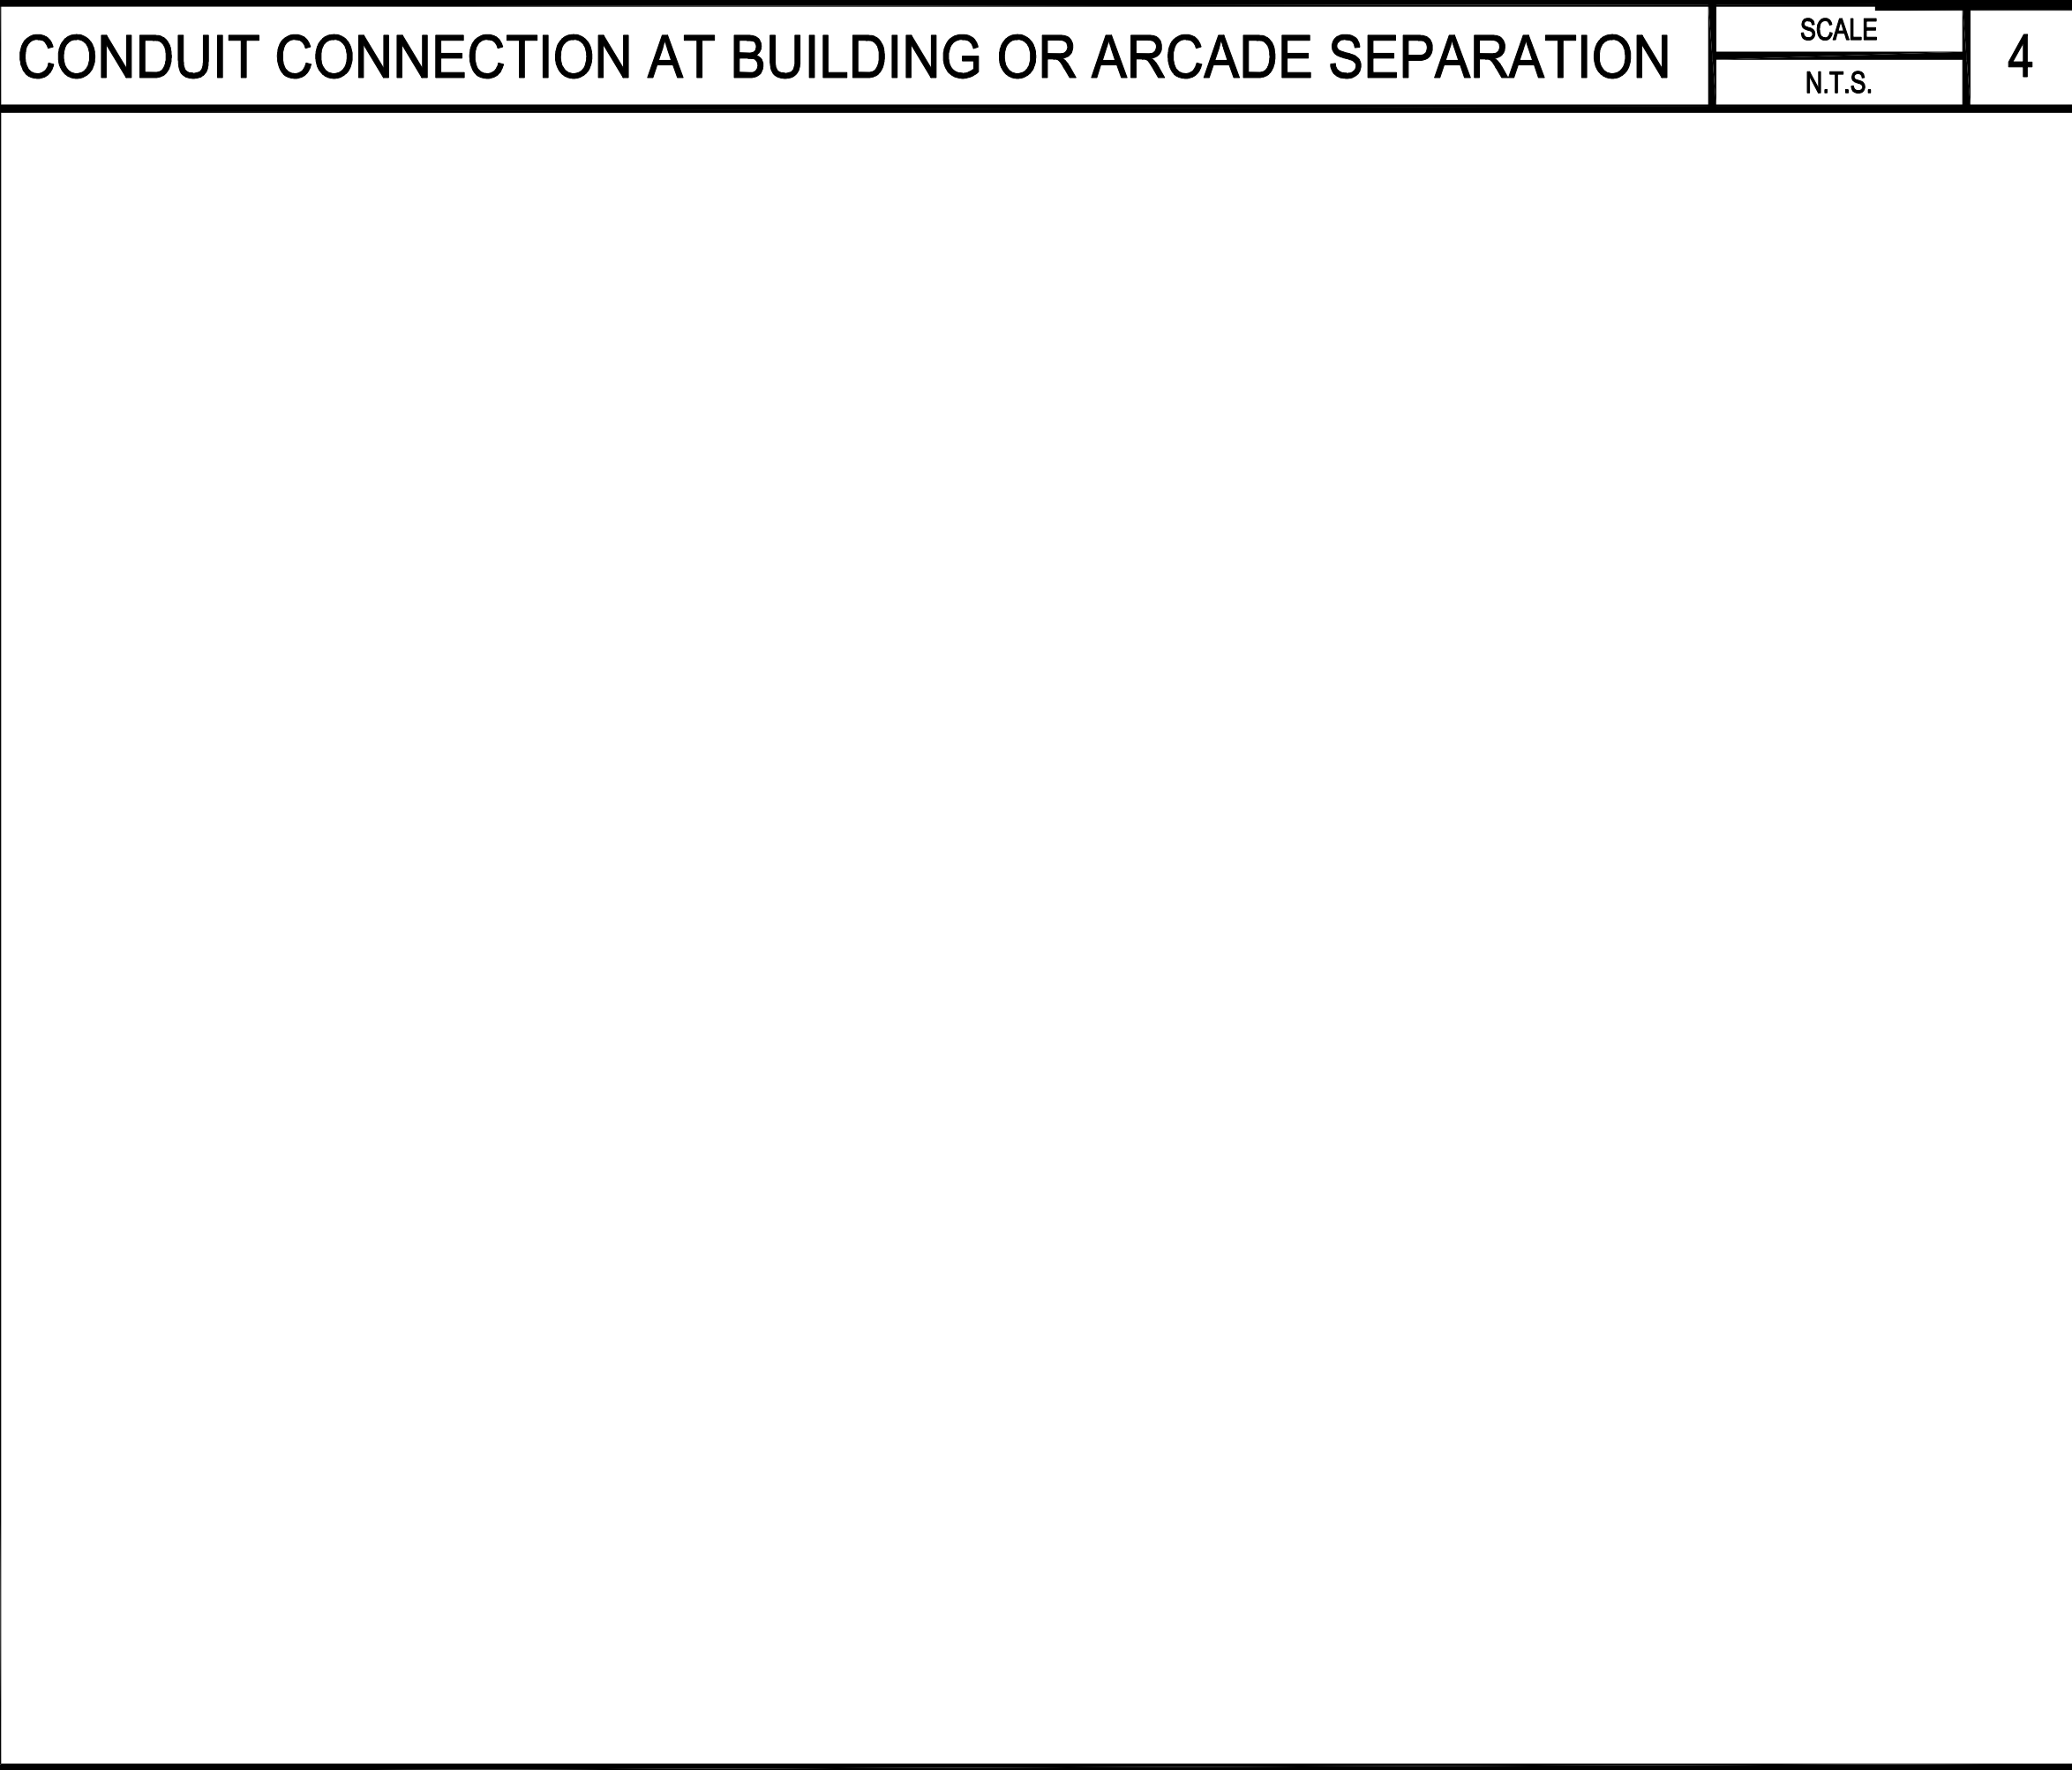
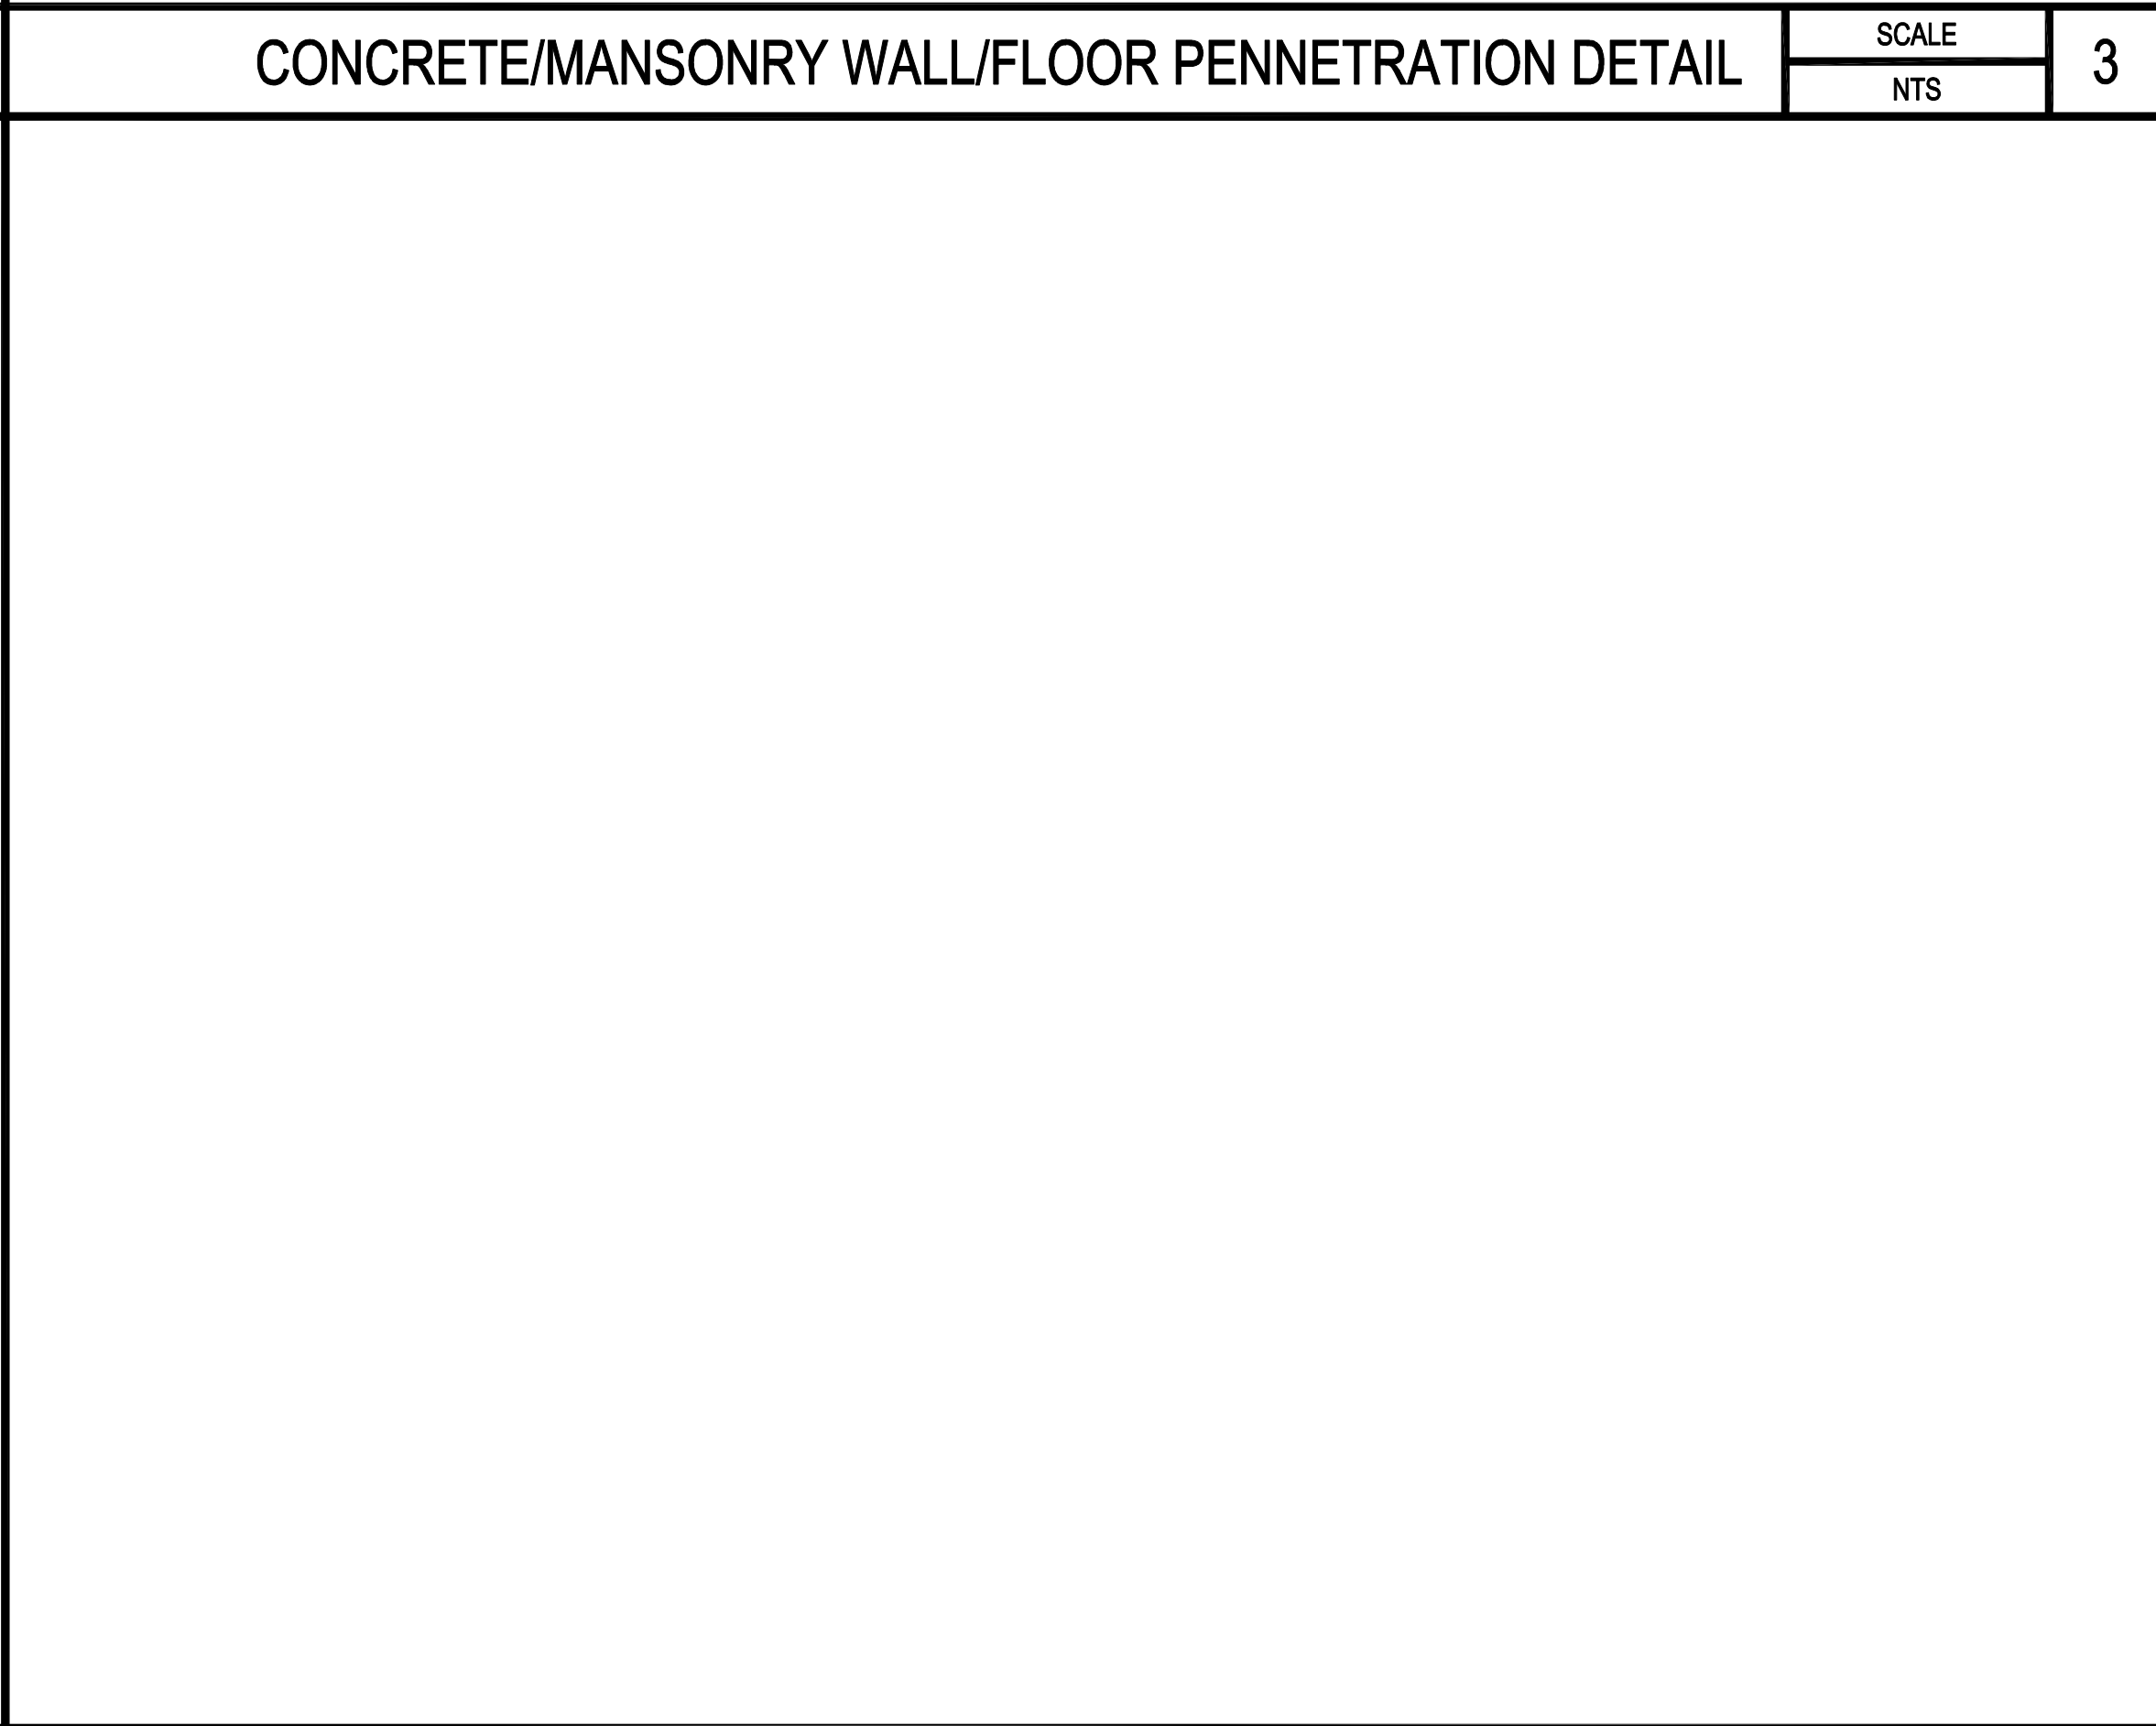
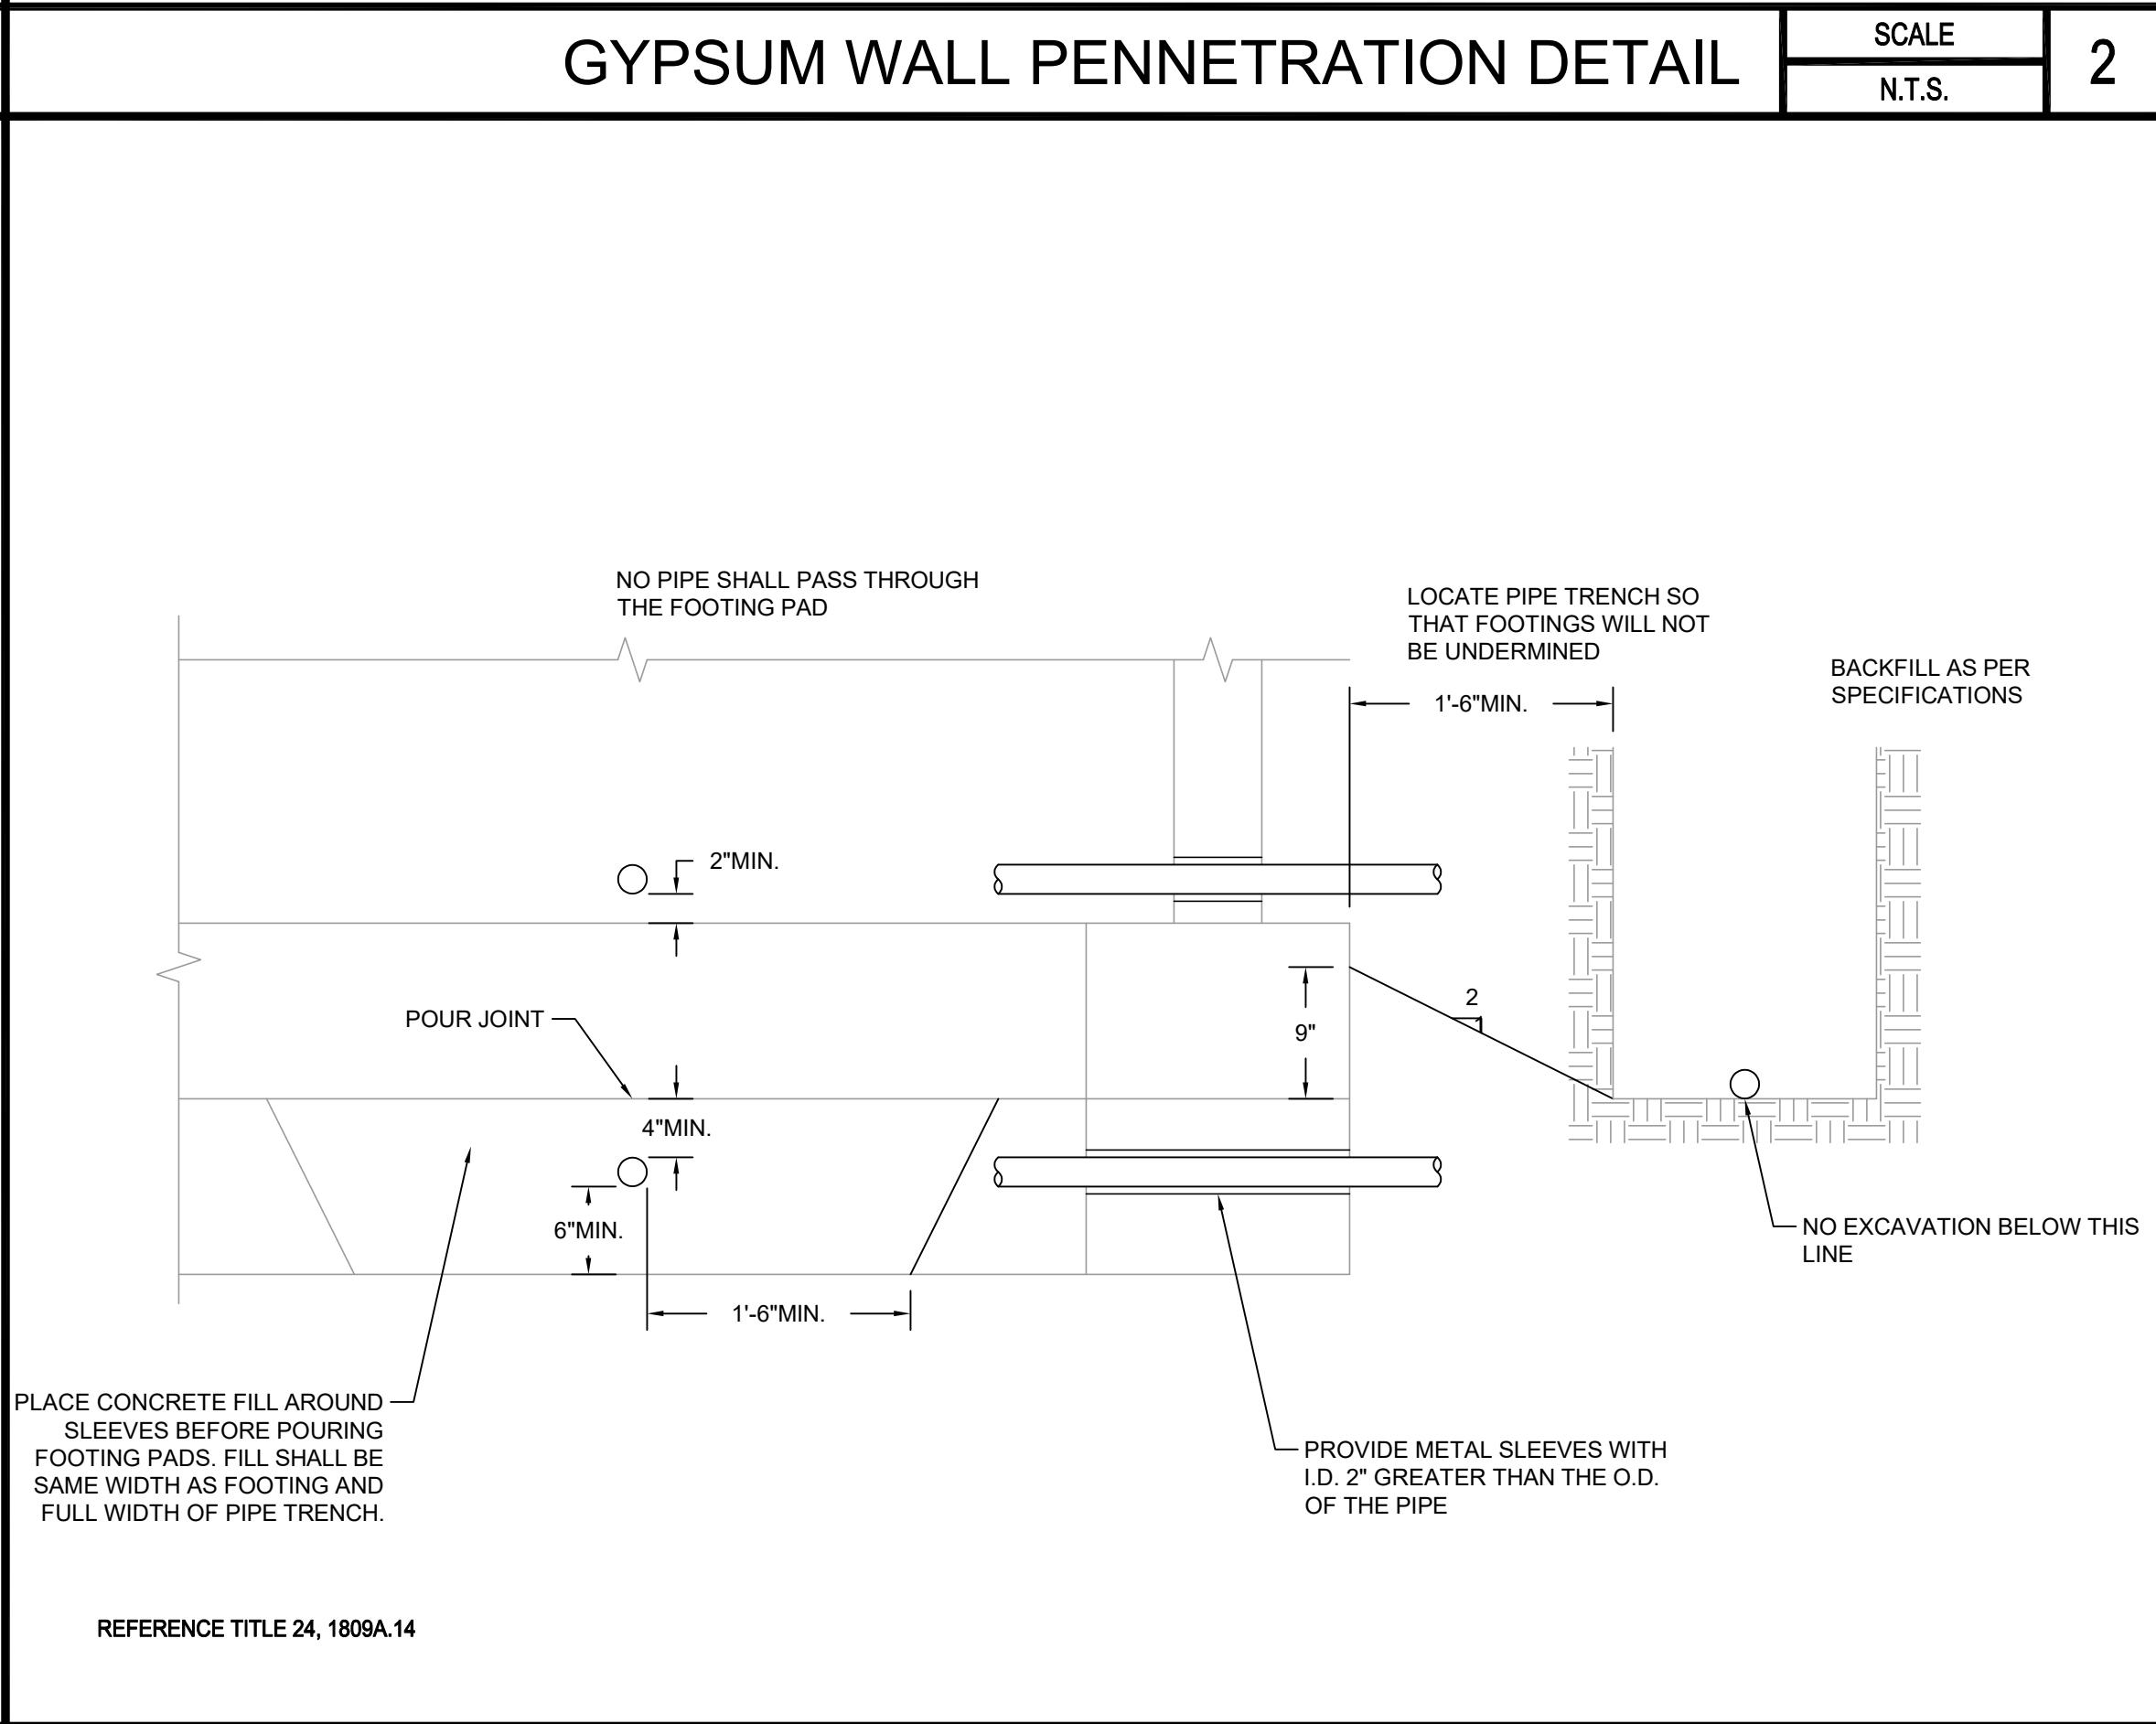
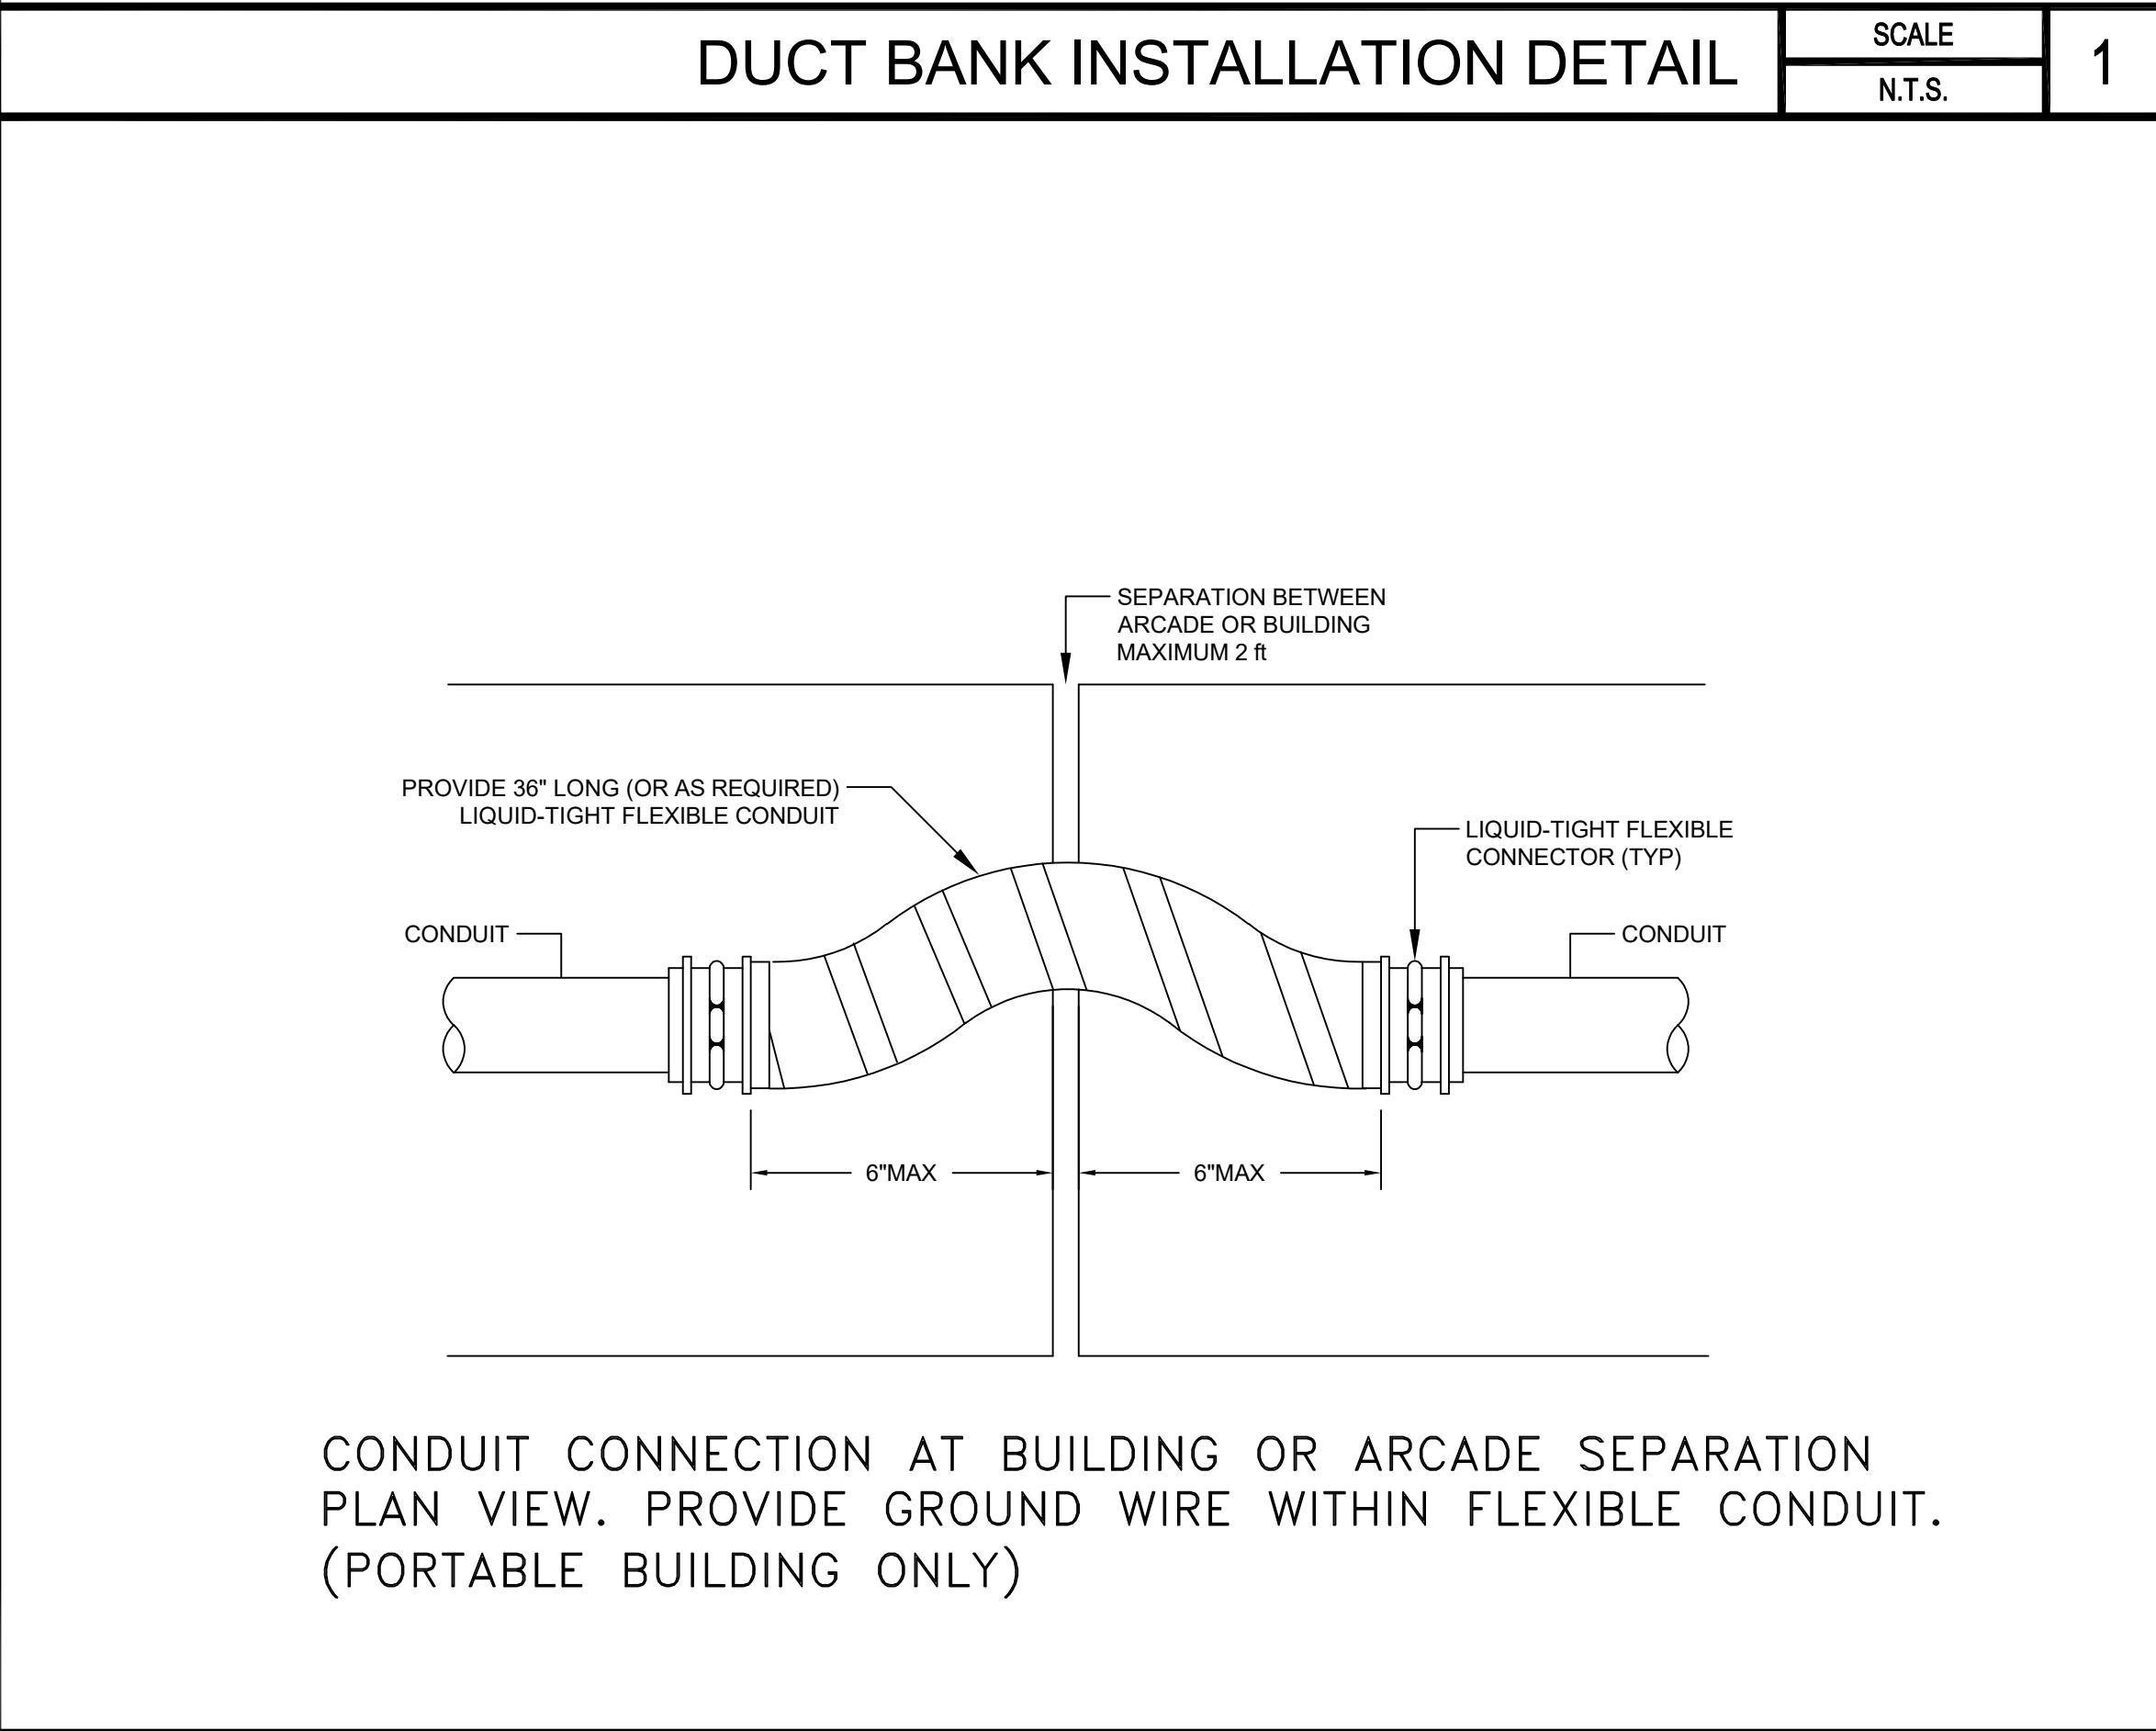
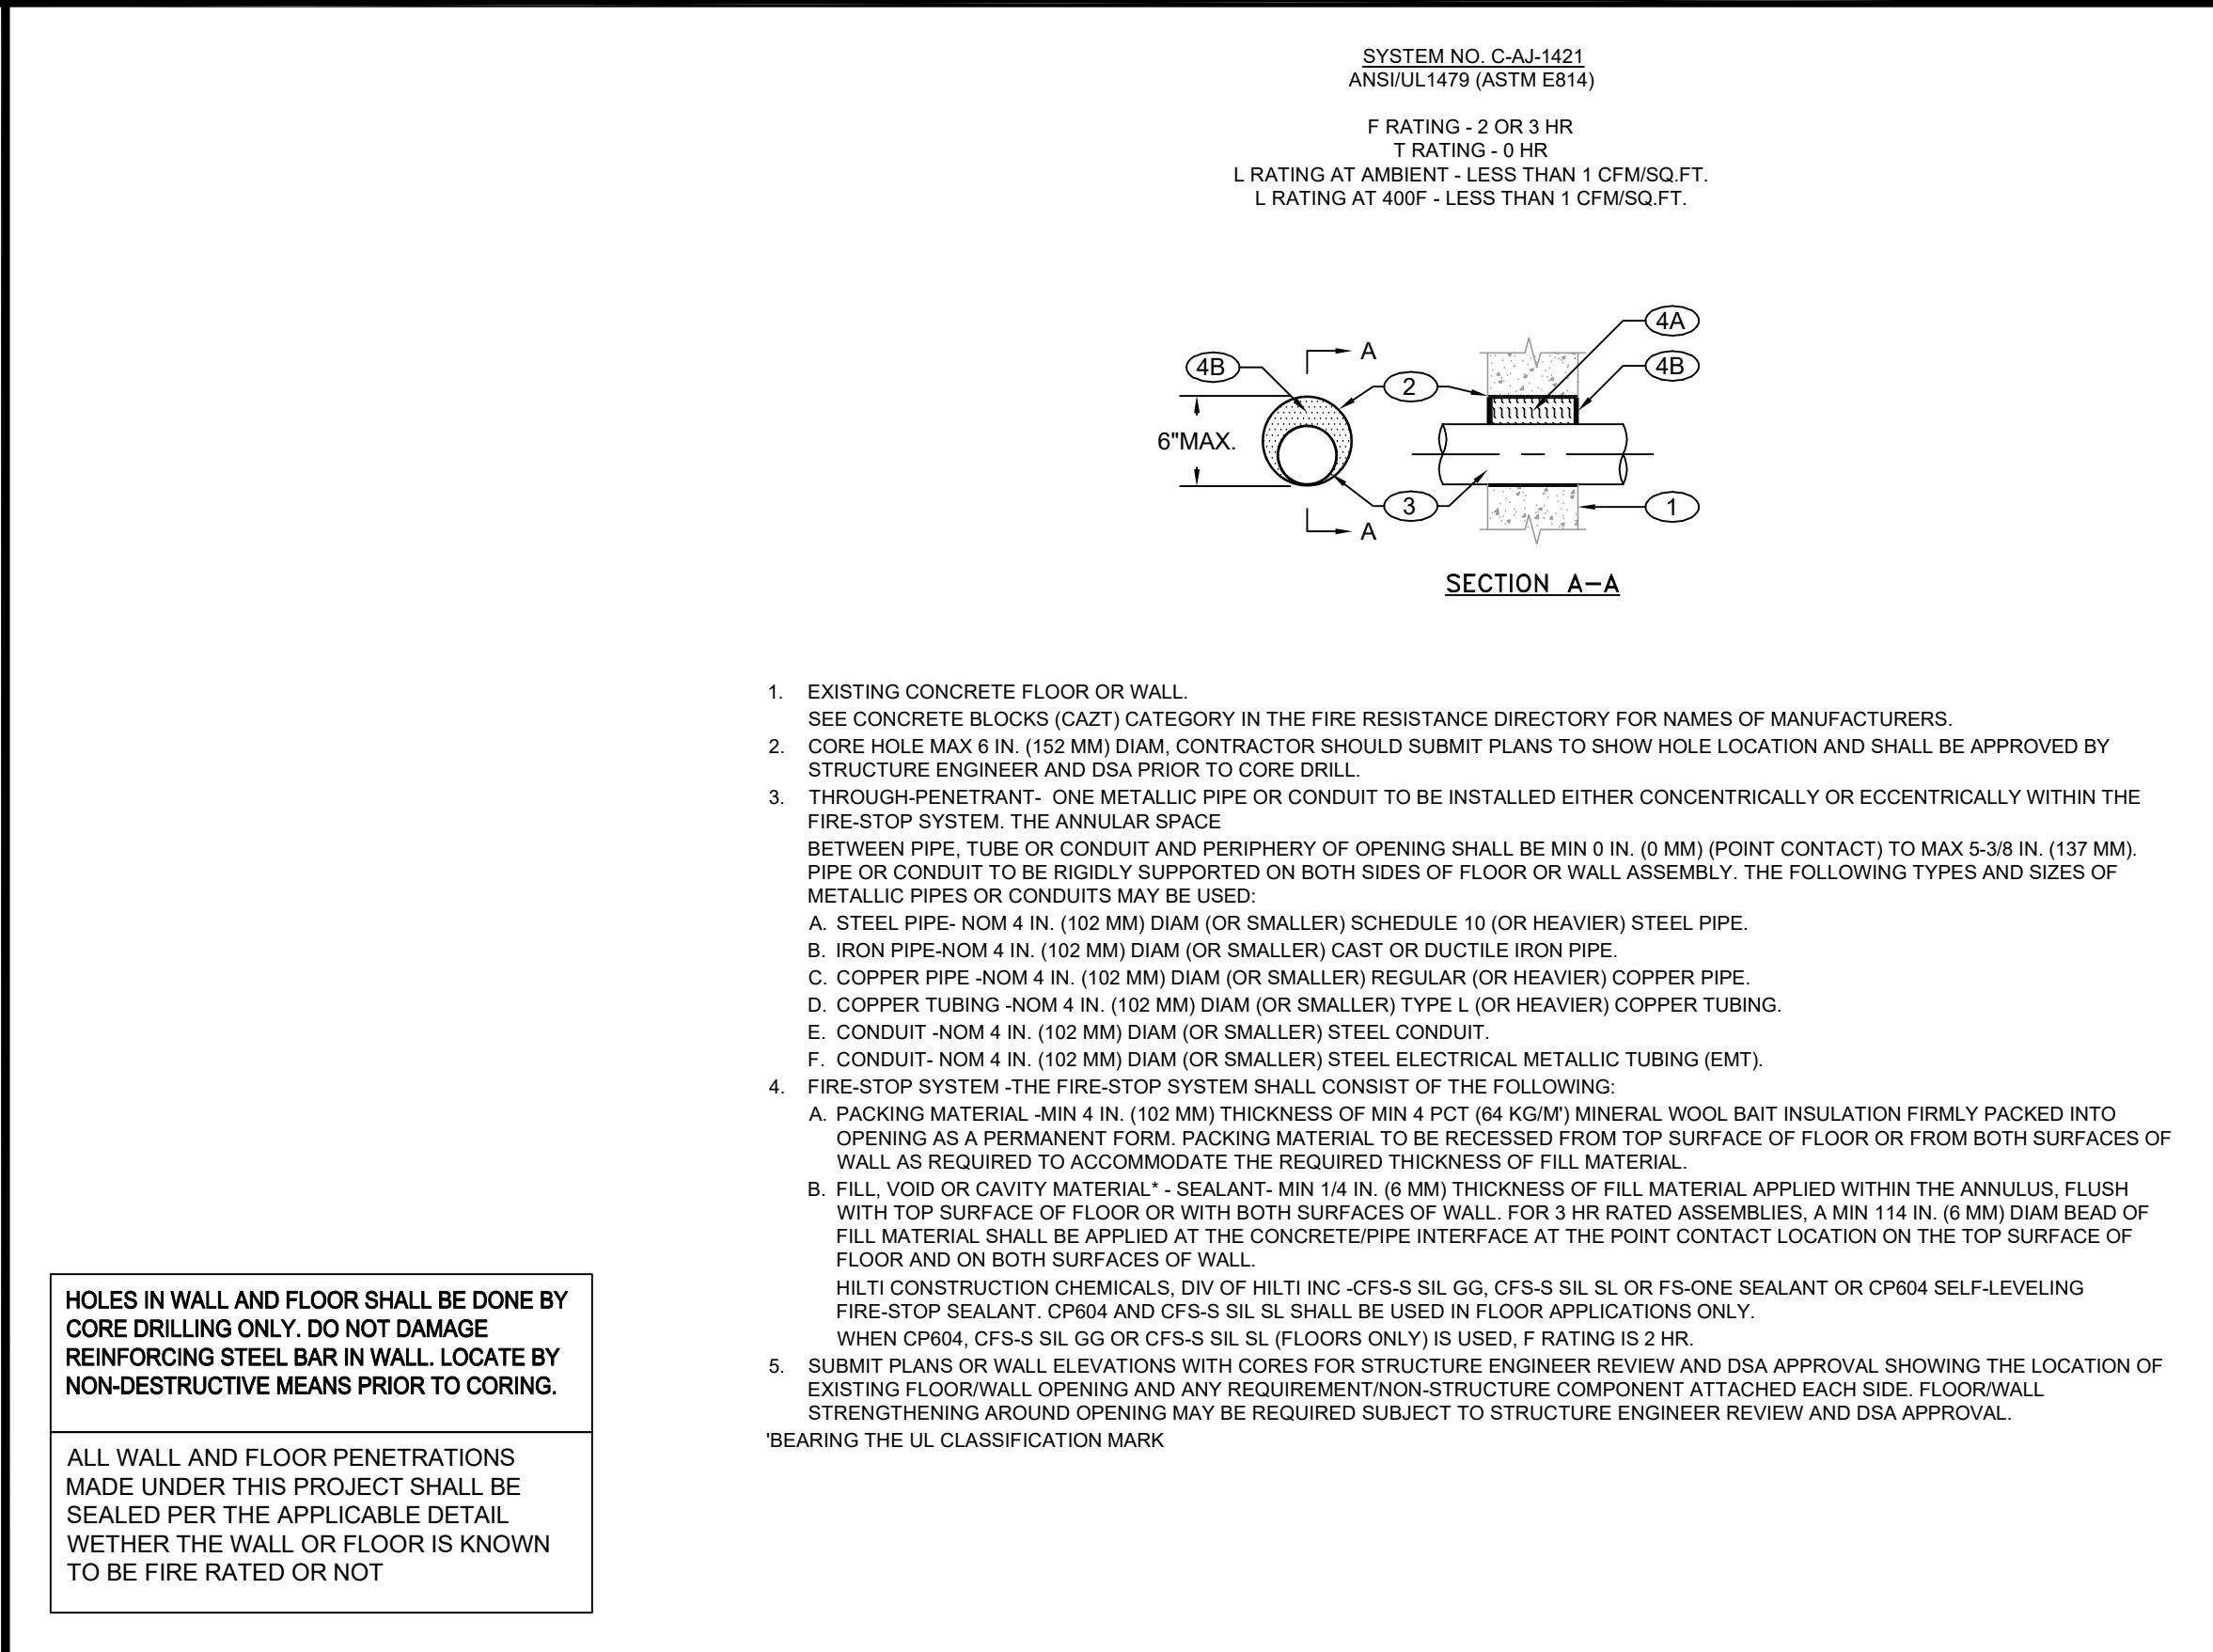
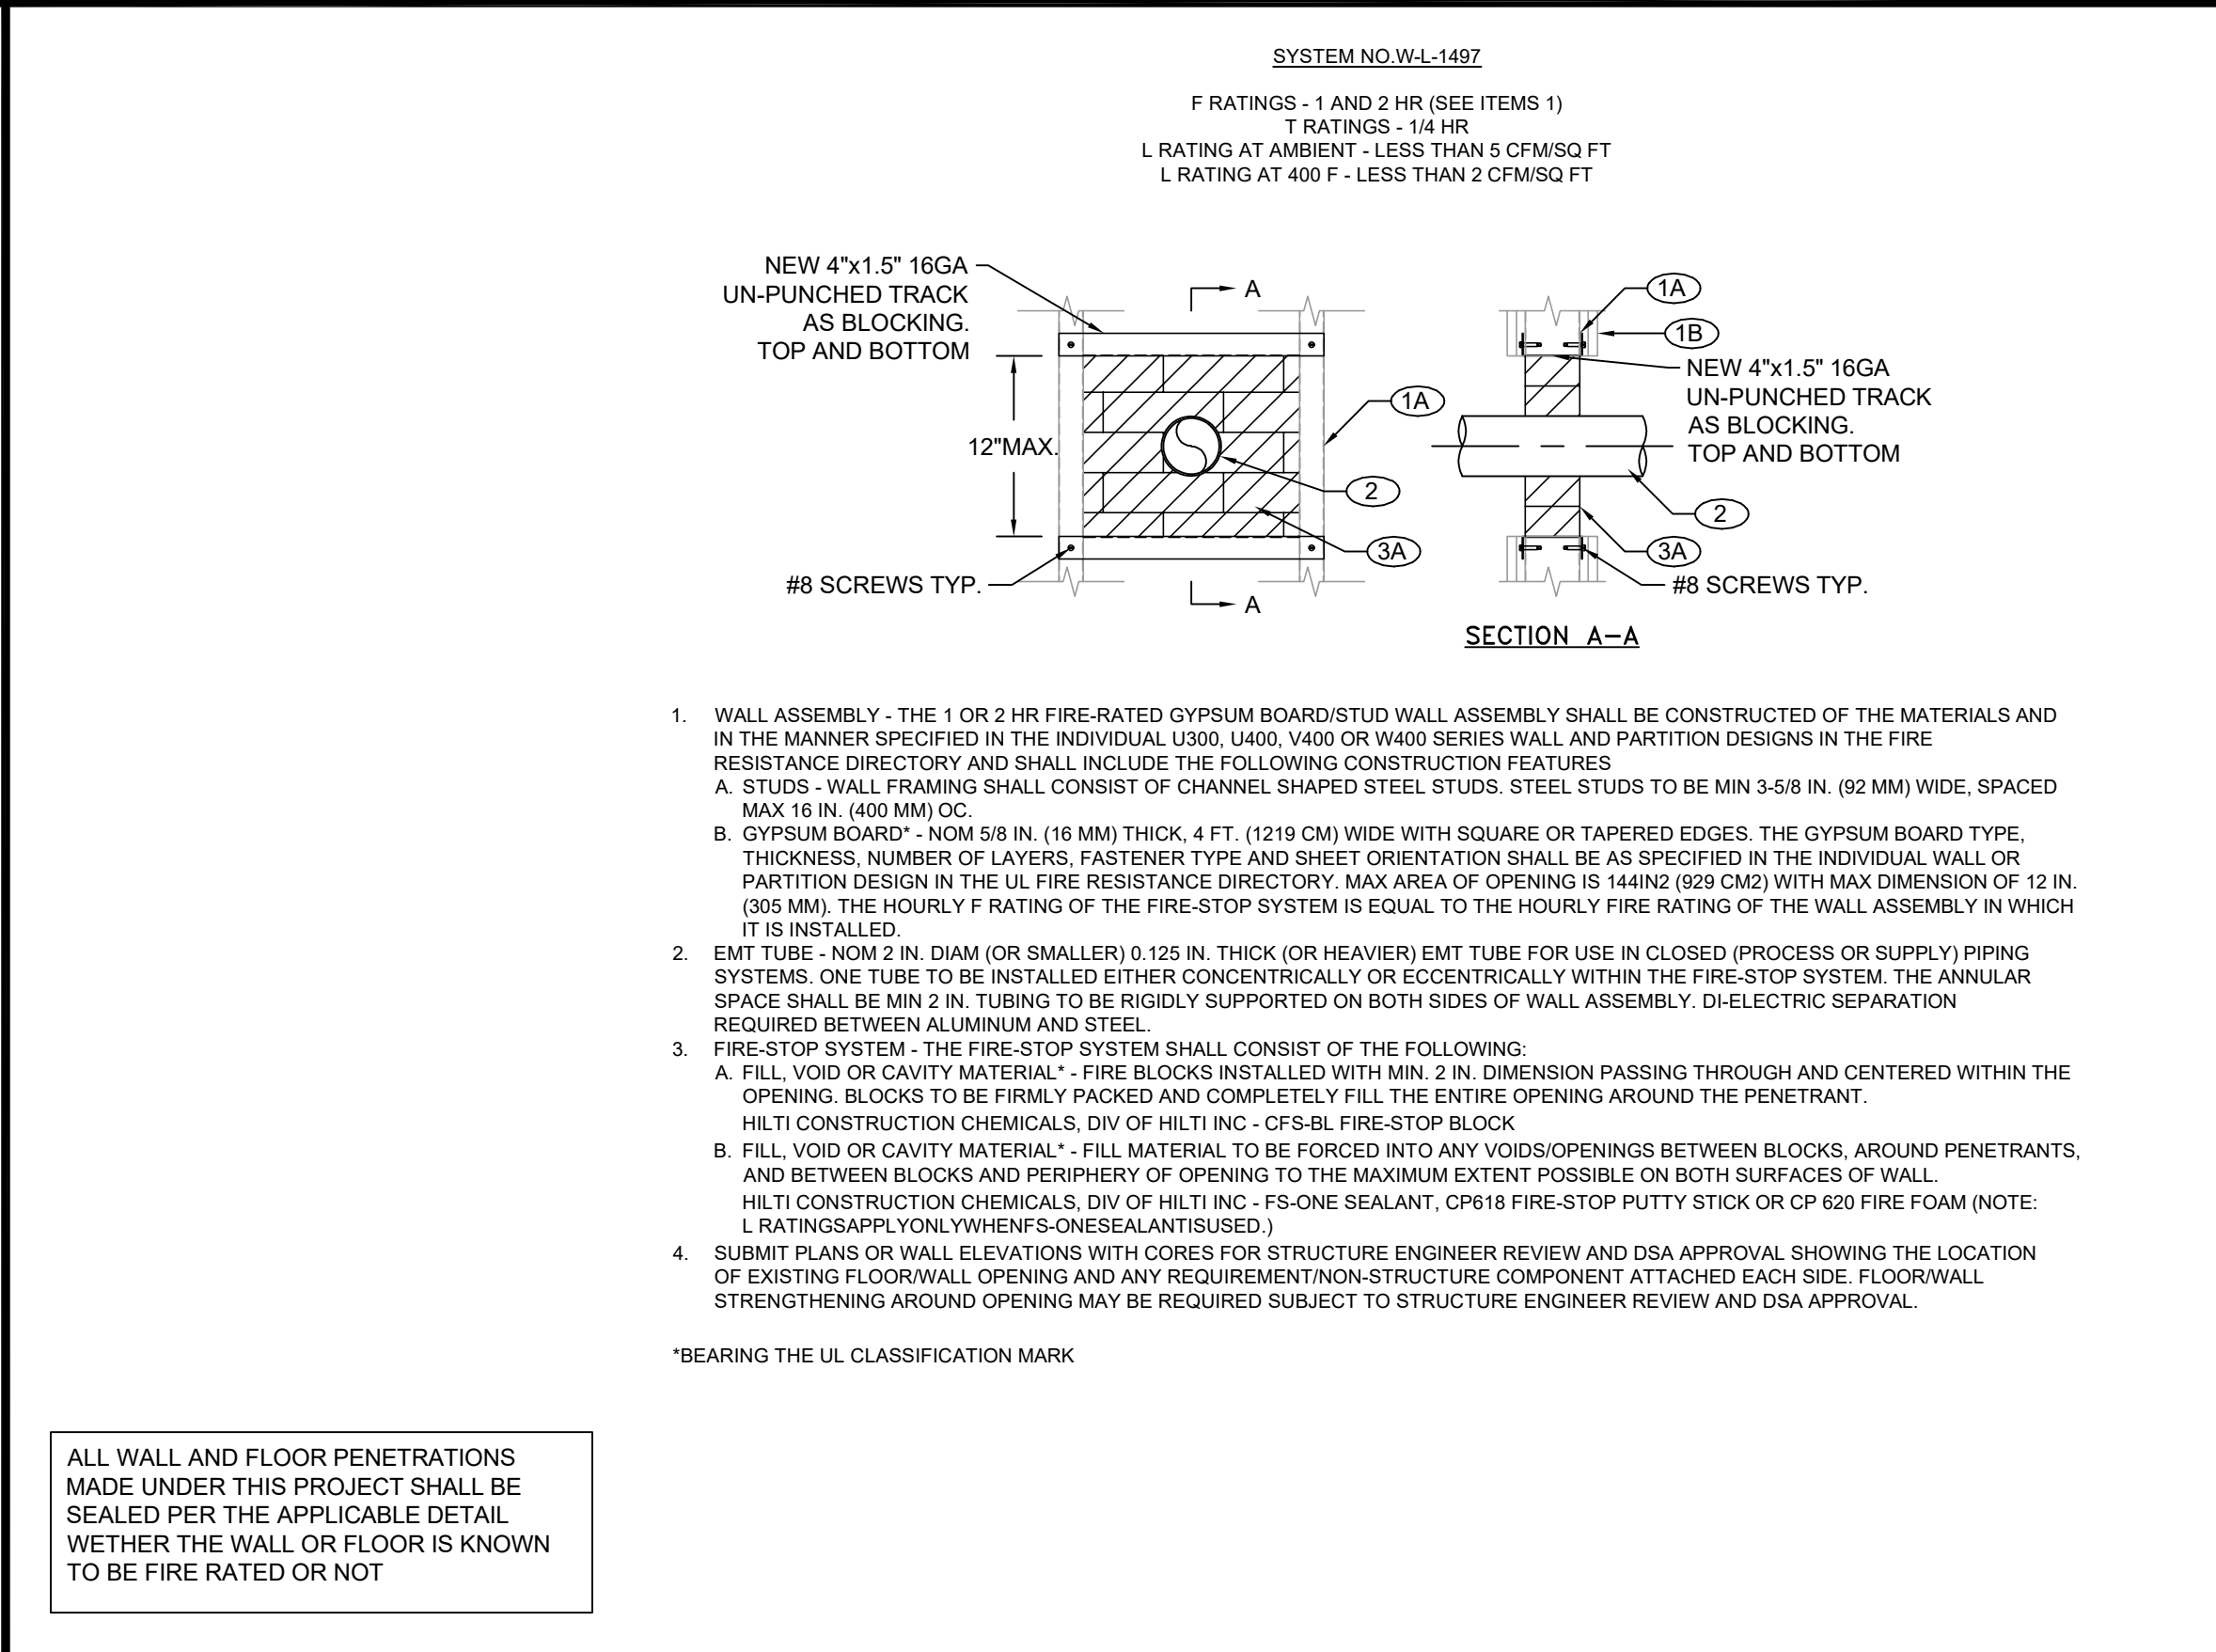
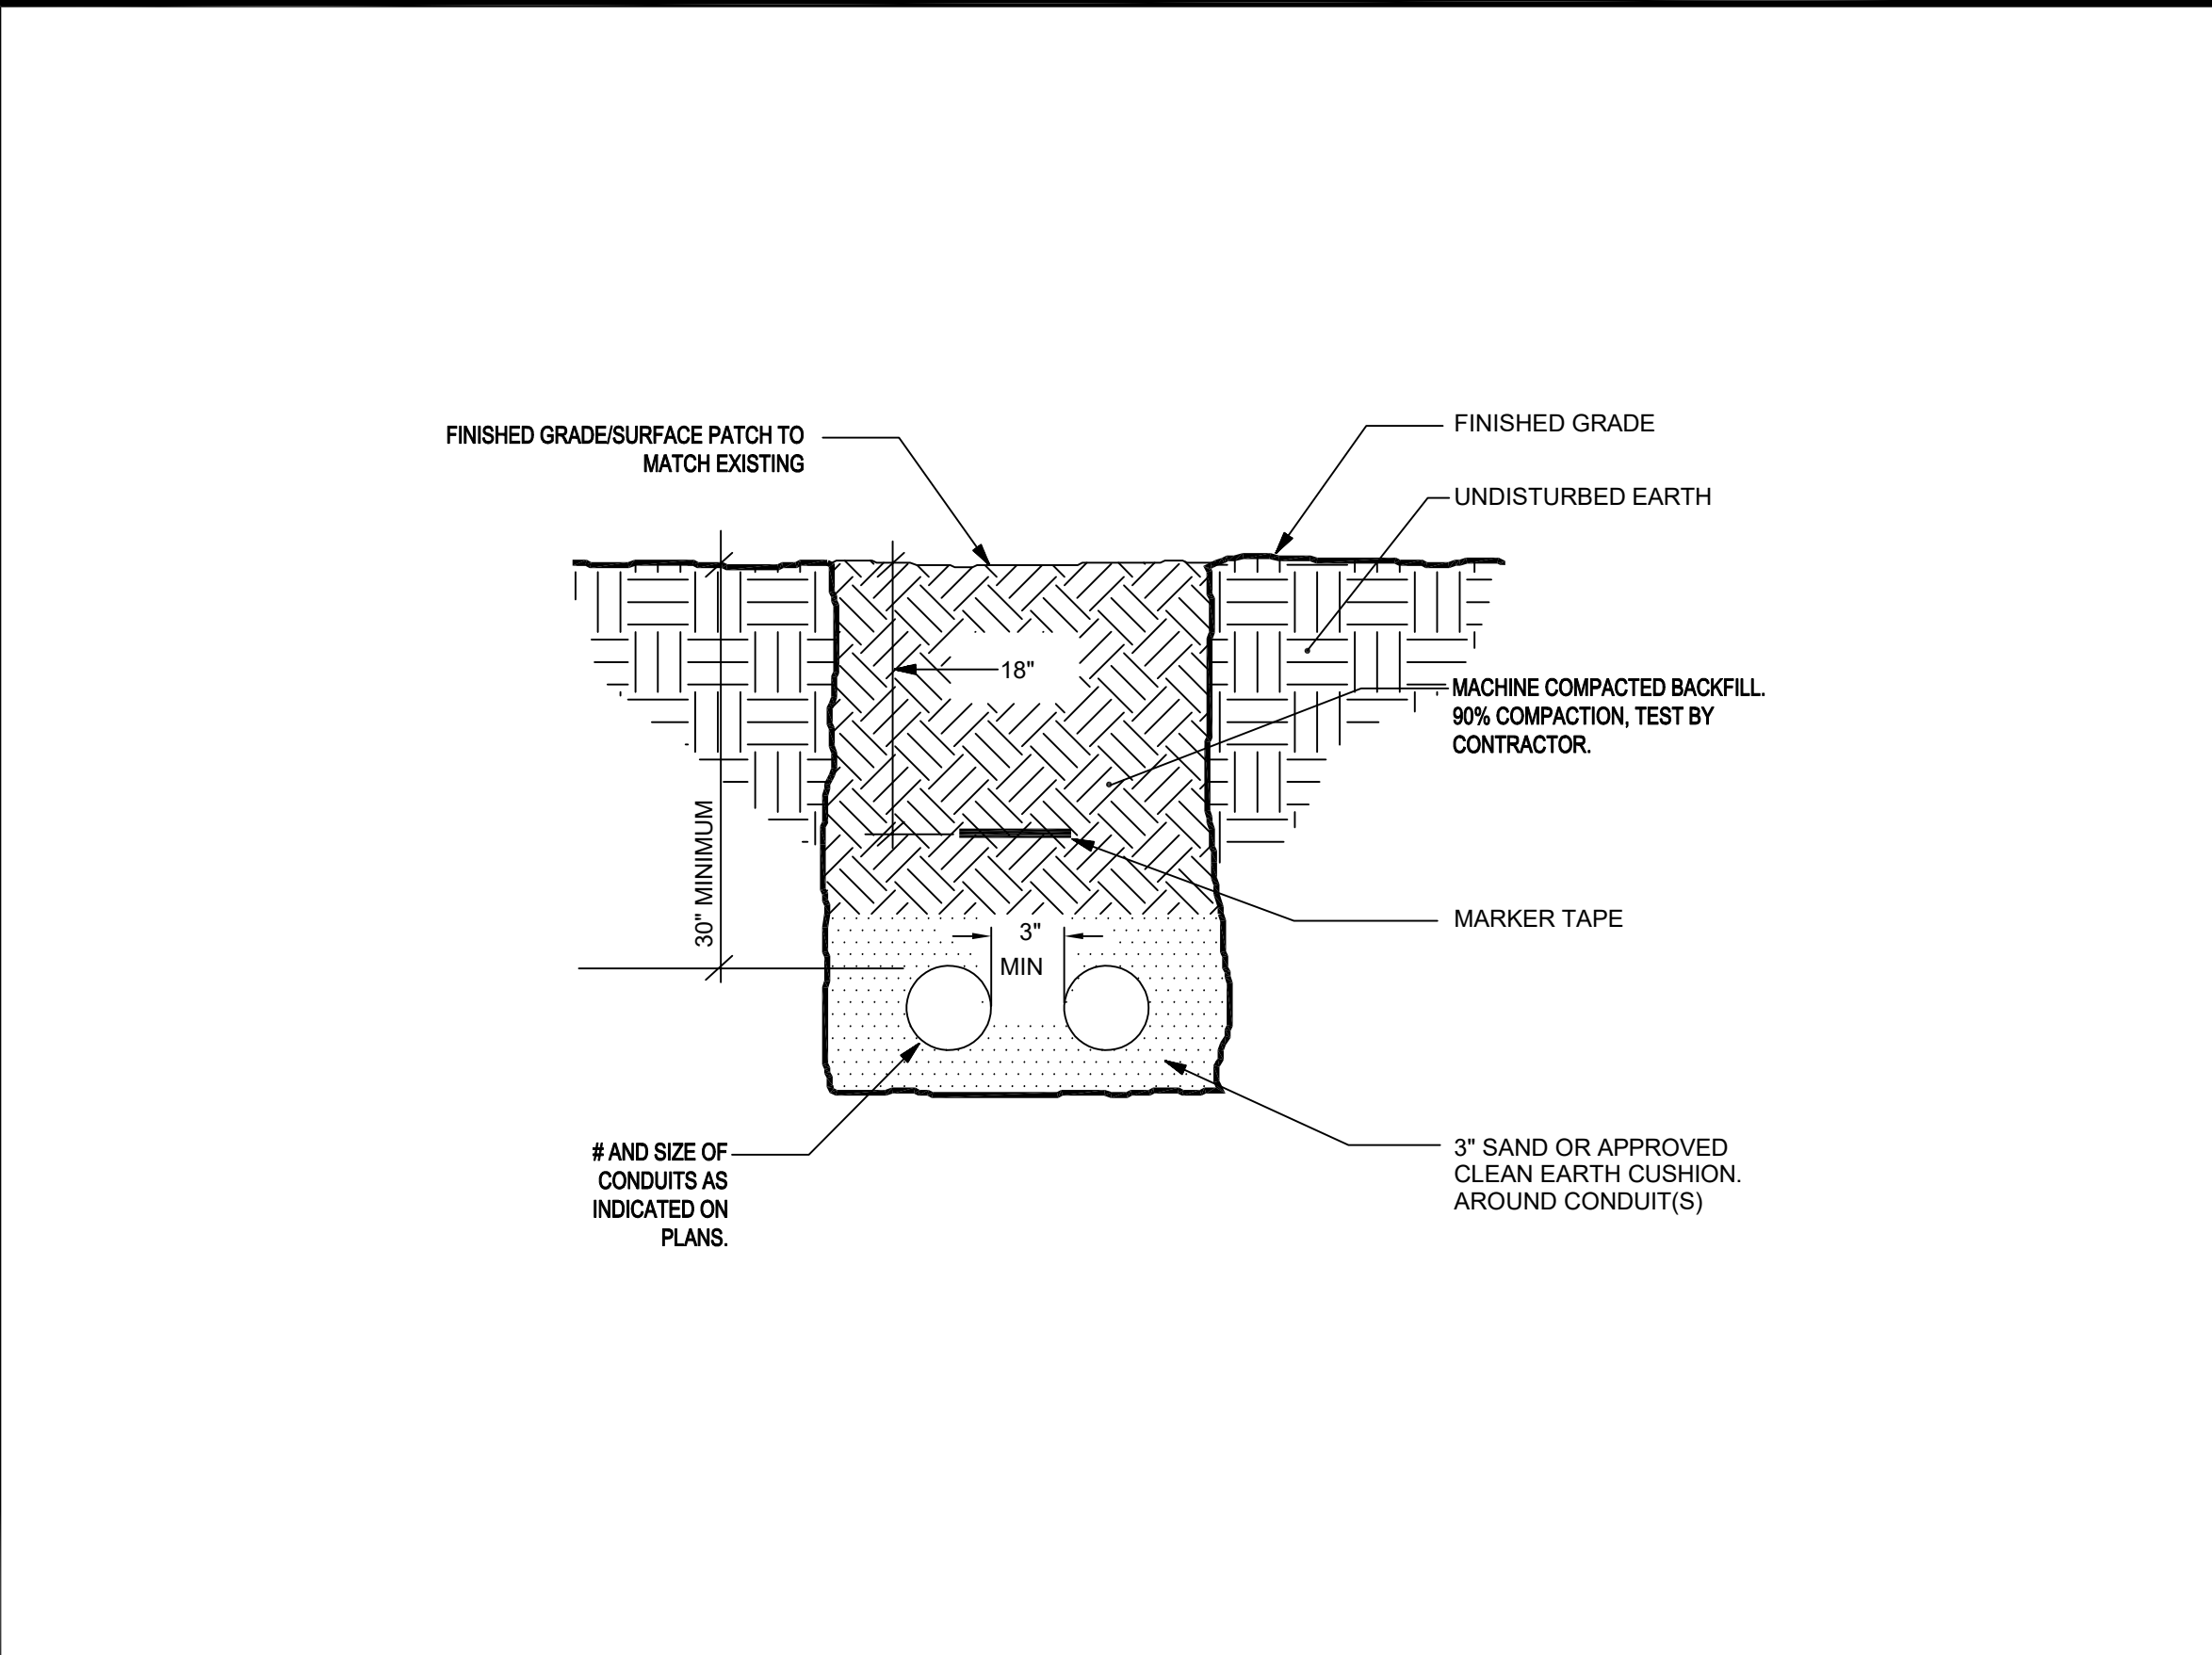
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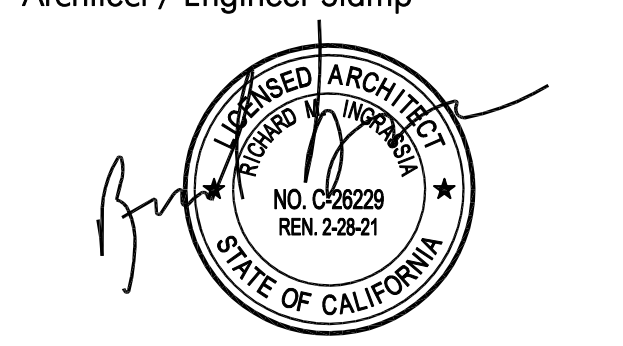
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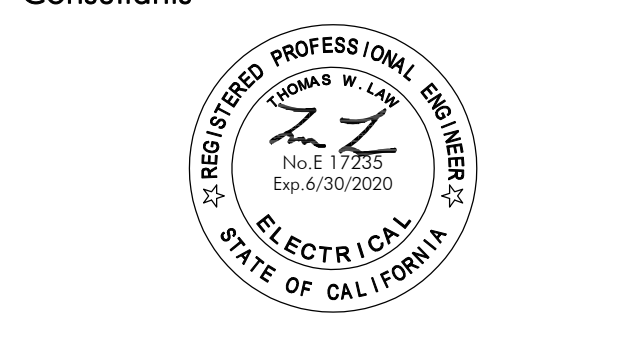
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